
BARNETT CENTER, LOCKER ROOM REMODEL

NORTHERN STATE UNIVERSITY
ABERDEEN, SOUTH DAKOTA
OSE# RO124--16X

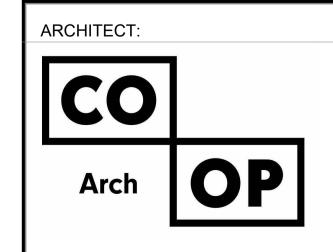



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Professional Design Phone: 605-941-3337 Engineers

48371 265th Street Brandon, SD 57005 (605)941-3337



OWNER:

1000 0 1 01

1200 S Jay Street Aberdeen, SD 57401 Phone: 605.626.3011

DRAWING SHEET INDEX:

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G000 CODE STANDARDS

G001 BUILDING SYSTEMS INFORMATION

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0-102 WRESTLING & BASEBALL DEMOLITION PLAN

ARCHITECTURAL

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A-103 TRACK & FIELD REFLECTED CEILING PLAN

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TRACK & FIELD - POWER & DATA PLAN

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400 TRACK & FIELD - LIGHTING & SPECIAL SYSTEMS PLAN


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00 ELECTRICAL SECTIONS - TRACK & FIELD

ELECTRICAL SECTIONS - BASEBALL & WRESTLING
ELECTRICAL RISER DIAGRAM & PANEL SCHEDULE

100% CONSTRUCTION DOCUMENTS

2/3/2025

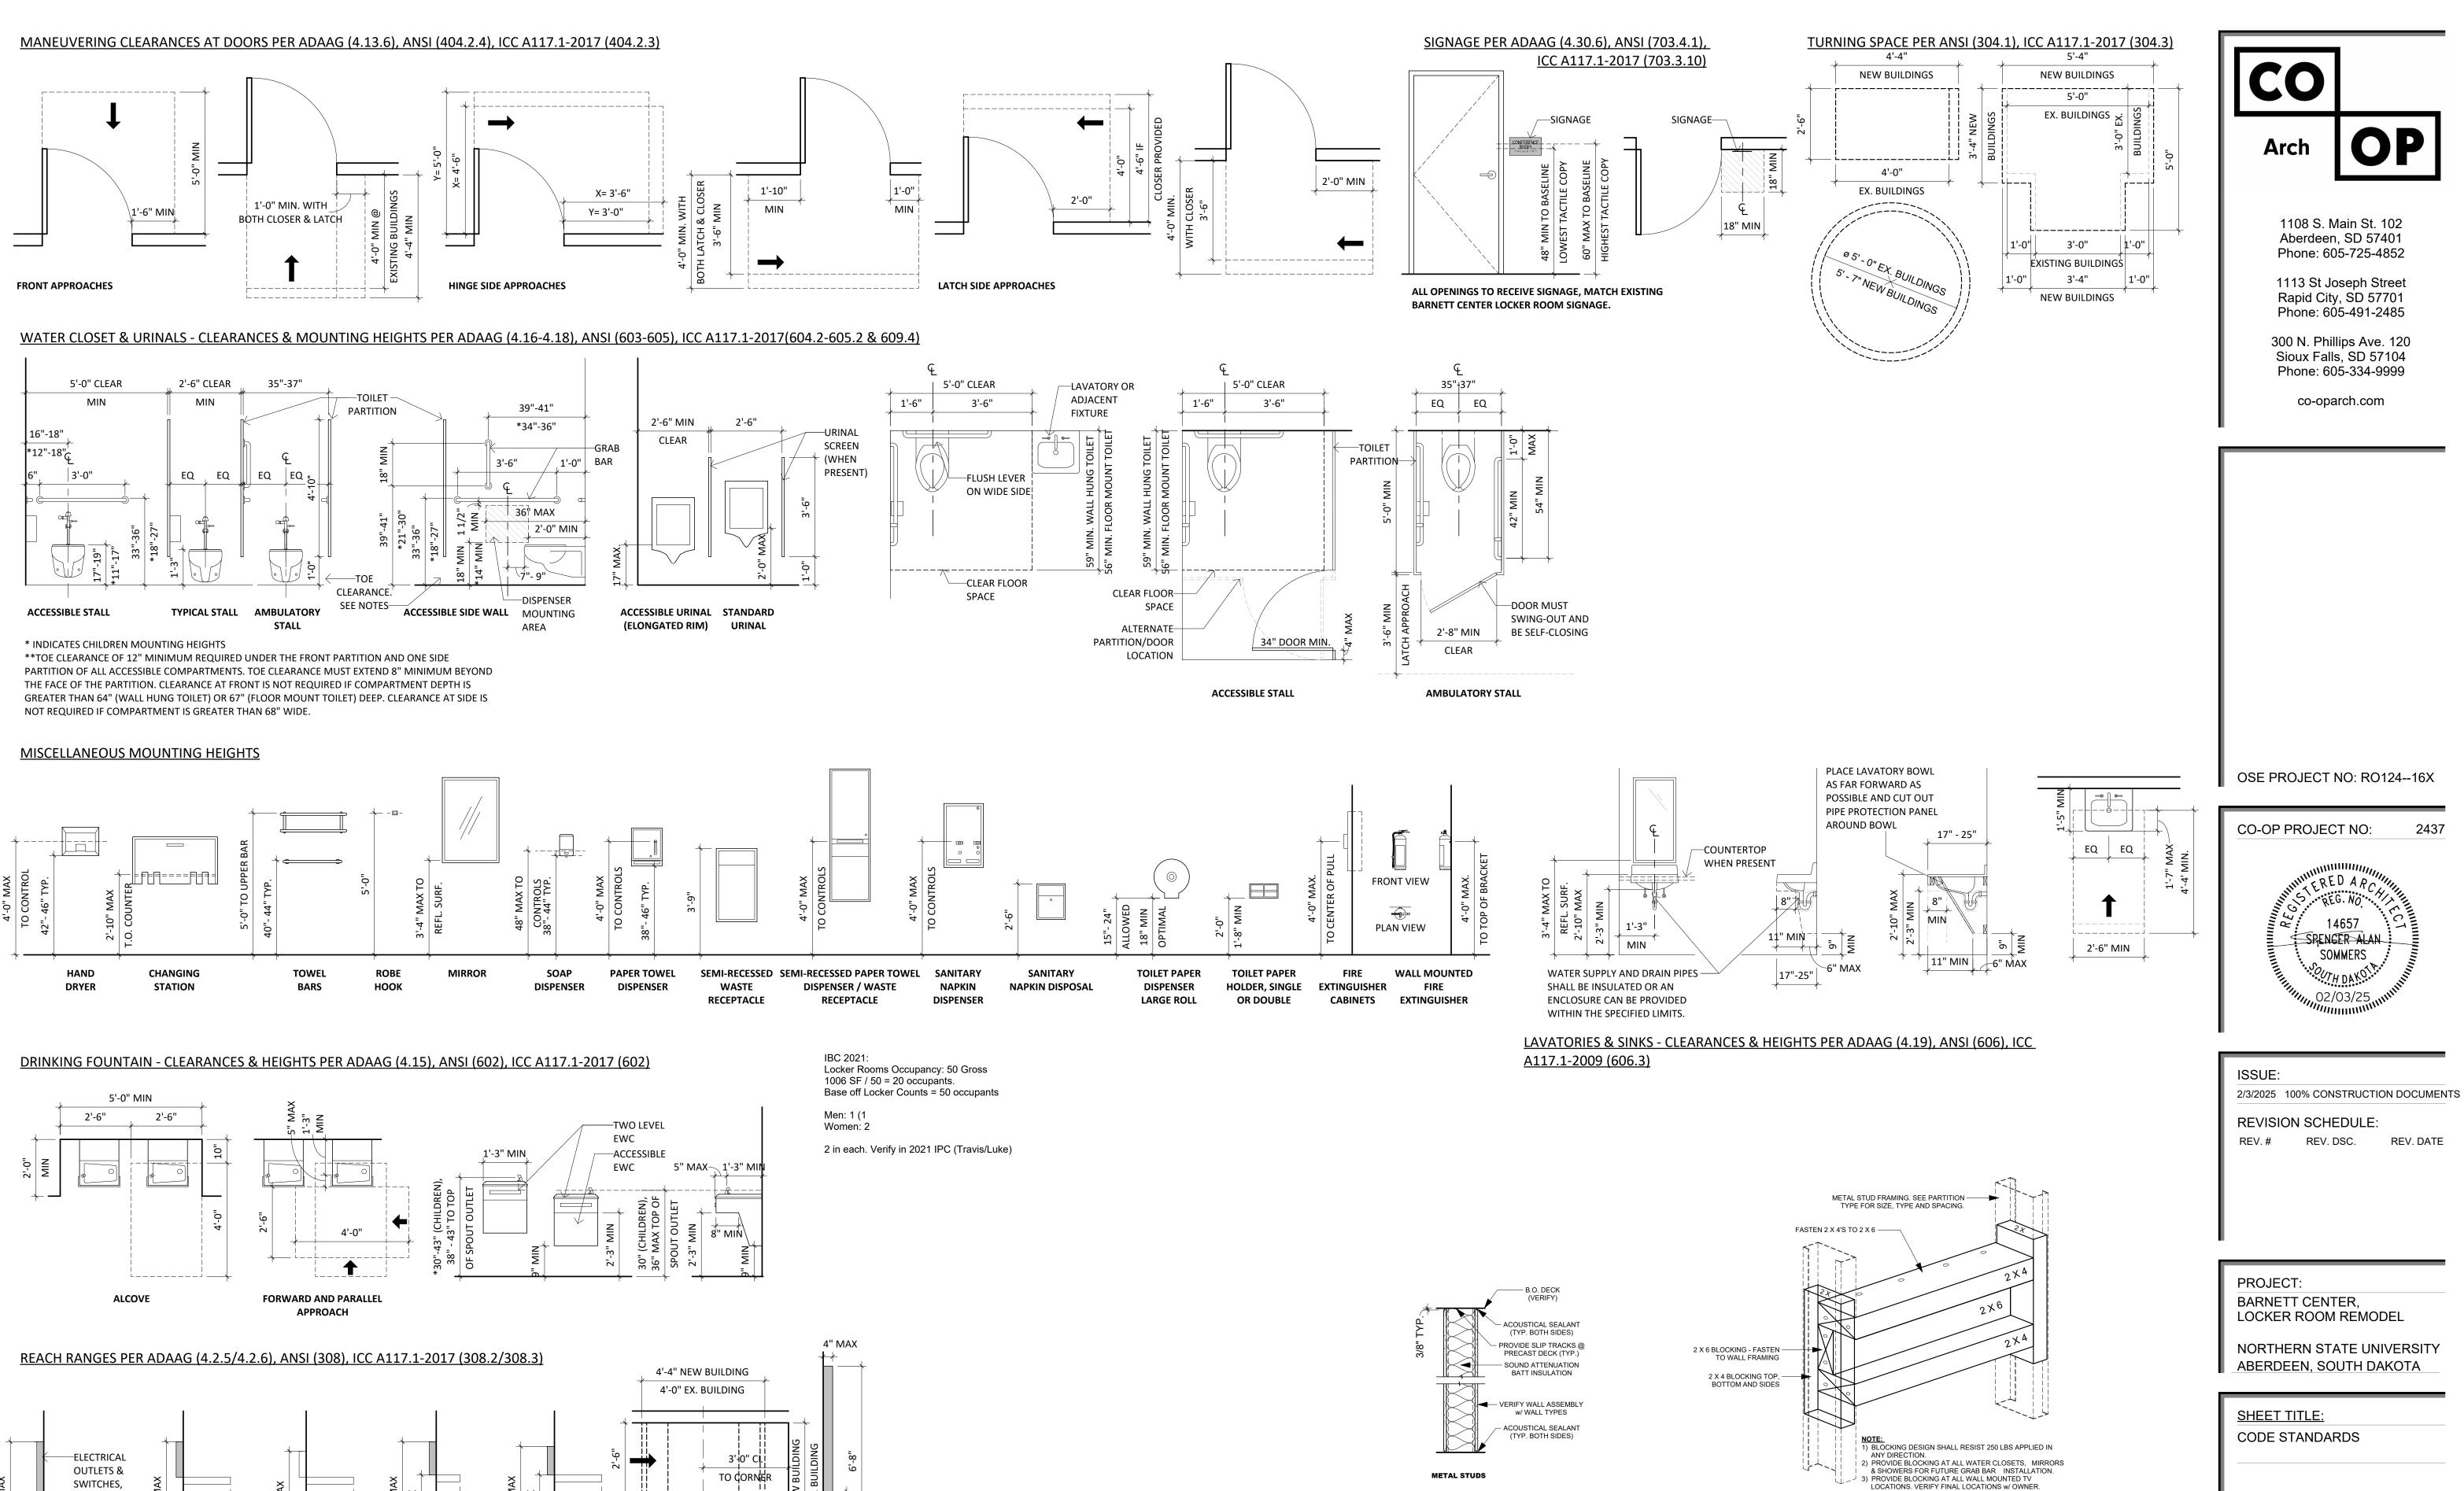

10"-24"

SIDE

OBSTRUCTED

OBSTRUCTED

2'-6"

FORWARD & SIDE

APPROACH

PROTRUDING

OBJECTS

.'-8" MAX

FORWARD

OBSTRUCTED

PHONE, TV, THERMOSTATS,

FORWARD & SIDE

UNOBSTRUCTED

20"-25"

OBSTRUCTED

4) ALL BLOCKING TO BE FIRE TREATED.

TYPICAL TOP & BOTTOM OF WALL PARTITION(S)


TYPICAL BLOCKING DETAIL

2437


REV. DATE

14657

SOMMERS

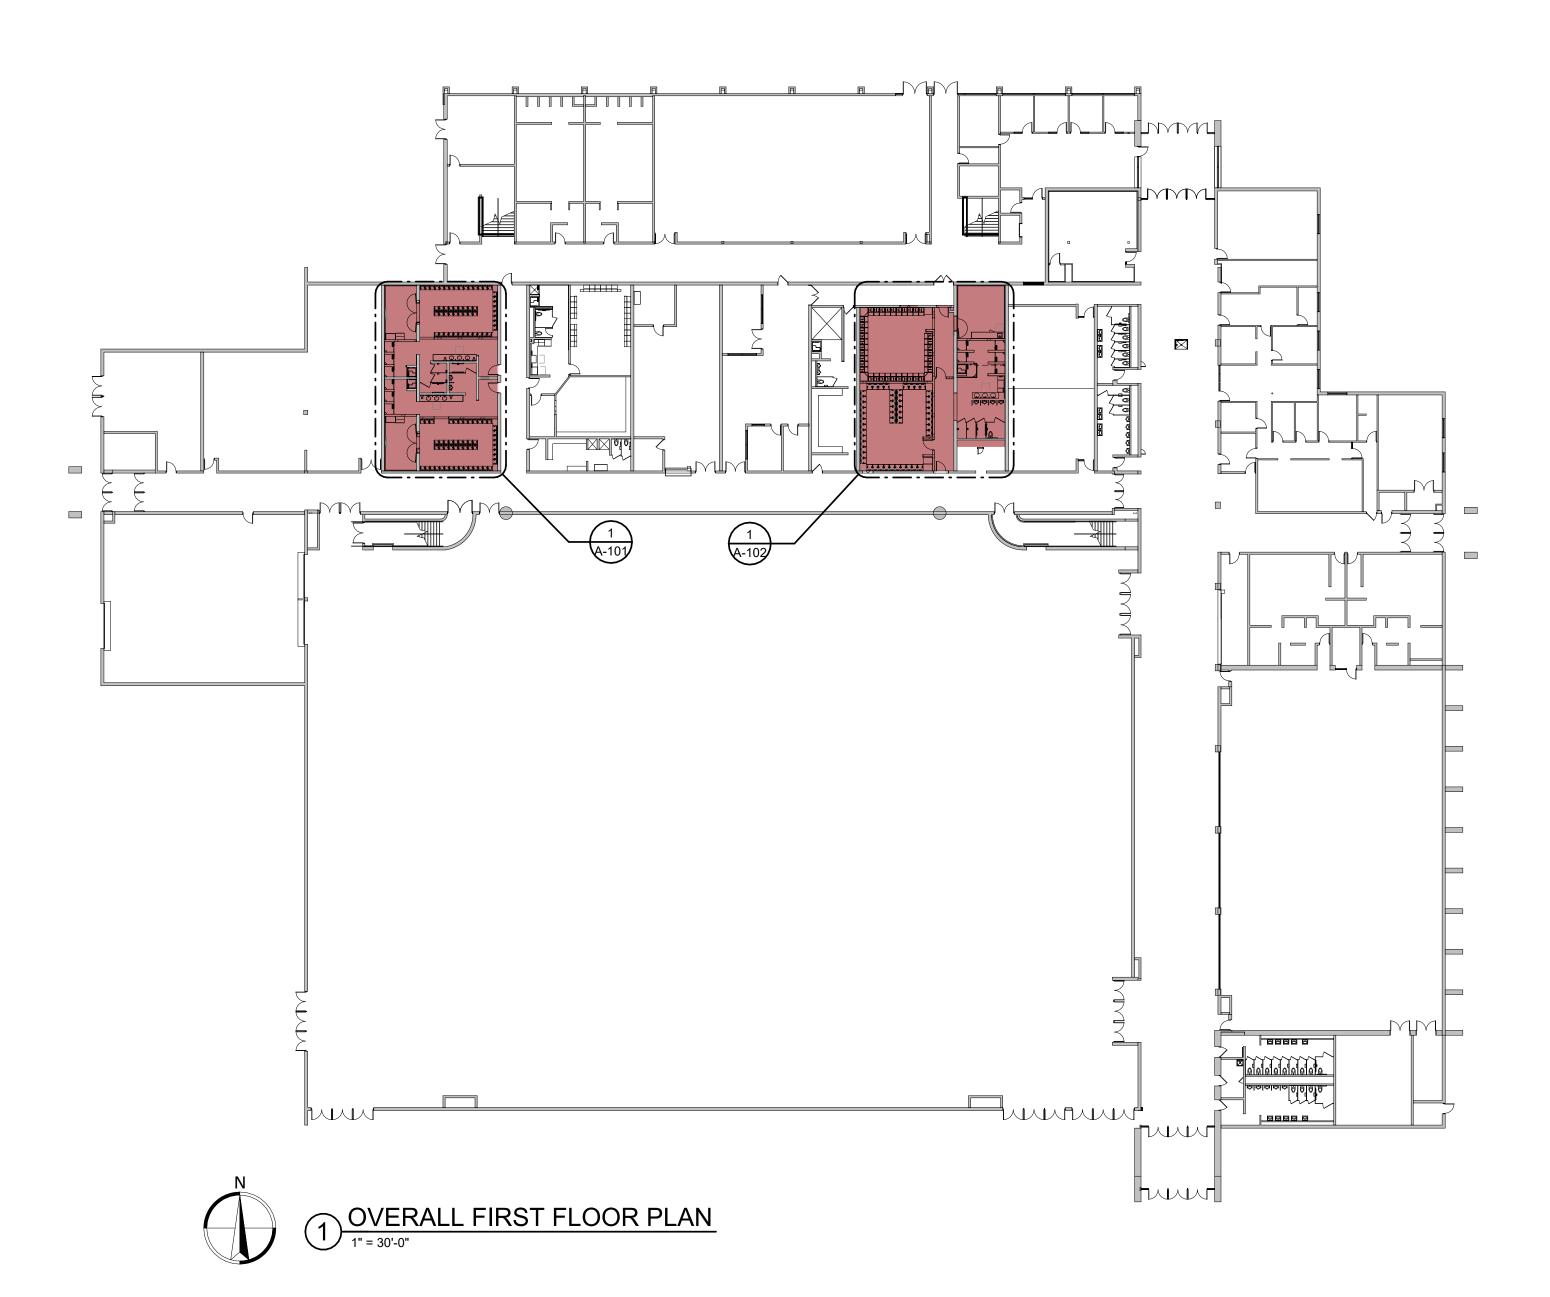

WALL TYPE 9 (DIVISION 9 - INTERIORS)

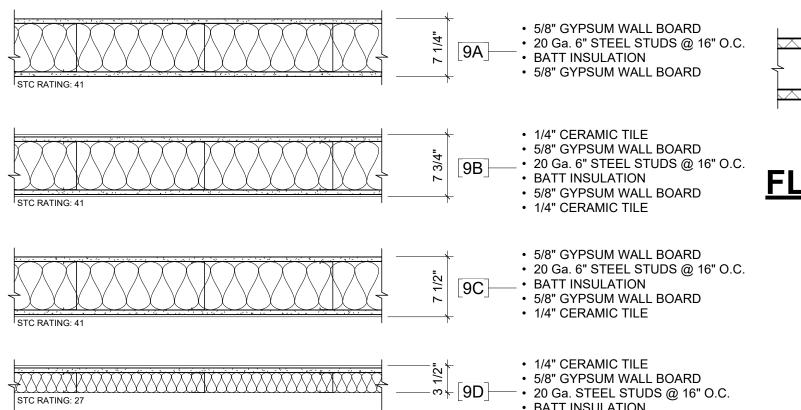


• 5/8 GYPSUM WALL BOARD
• 20 Ga. STEEL STUDS @ 16" O.C. BATT INSULATION

> 5/8" GYPSUM WALL BOARD 20 Ga. STEEL STUDS @ 16" O.C.

BATT INSULATION

WALL TYPE 4 (DIVISION 4 - MASONRY)

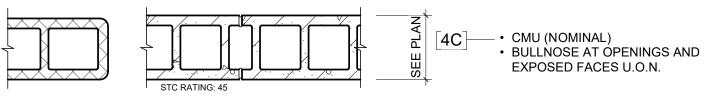

FLOOR TYPES

4 4 4 4 4 4 4 4 4 4 4 4 4 4 4 4 4 4 4 4	 4" CONCRETE SLAB-ON-GRADE 15 MIL. VAPOR BARRIER 6" ENGINEERED FILL REINFORCED w/ FIBERMESH DRILL & EPOXY #5 DOWELS @ 16" INTO EXISTING SLAB

2021 INTERNATIONAL BUILDING CODE									
PROJECT AREA	OCCUPANCY TYPE	TYPE OF CONST.	NUMBER OF STORIES	BUILDING SPRINKLER	PERIMETER W/ 20' YARD (F)	PERIMETER BUILDING (P)	ALLOWABLE AREA/FLOOR	ACTUAL AREA/FLOOR	COMMENTS
4,425	В	II-B	2	Y	NA	NA	NA	NA	NA

A A/C	ALD CONDITION	_		_	
A/C AB	AIR CONDITION ANCHOR BOLT	E FBO	FURNISHED BY OTHERS	Q QB	QUARRY TILE BASE
		FD FD	FLOOR DRAIN	QB QT	
ACPL	ACOUSTICAL PLASTER			QI	QUARRY TILE
ADJ	ADJUSTABLE	FDN	FOUNDATION	-	
	ABOVE FINISH FLOOR	FE	FIRE EXTINGUISHER	<u>R</u>	DECULENT DAGE
AHU	AIR HANDELING UNIT	FEC	FIRE EXTINGUISHER CABINET	RB	RESILIENT BASE
ALUM	ALTERNATE	FFE FF	FINISHED FLOOR ELEVATION	RD	ROOF DRAIN
	ALTERNATE		FINISHED FLOOR	REF	REFRIDGERATOR
ANC APC	ANCHOR ACOUSTICAL PANEL CEILING	FLR FRP	FLOOR FIBERGLASS REINFORCED PANEL	RM	ROOM
APC	ACOUSTICAL PANEL CEILING	FT	FOOT	RO RST	ROUGH OPENING RESILIENT STAIR TREAL
D		FTG	FOOTING	RT	RUBBER TILE
<u>В</u> ВС	BOTTOM OF CURB	FWC	FABRIC WALL COVERING	RVB	RUBBER VENTED BASE
BD	BOARD	1 440	I ADMIC WALL COVERING	KVD	ROBBER VENTED BASE
	BUILDING	G		e	
BLKG	BLOCKING	<u>G</u> GALV	GALVANIZED	<u>S</u> SB	SPLASH BLOCK
BN	BULLNOSE	GB	GRAB BAR	SC-#	SPECIAL COATING (COL
B.O.	BOTTOM OF	GC	GENERAL CONTRACTOR	SCONC	SEALED CONCRETE
	BOTTOM OF WALL	GLAZ	GLAZED BLOCK	SECT	SECTION
BRG	BEARING	GUAZ	GYPSUM WALL BOARD	SIM	SIMILAR
BRL	BRICK LEDGE	GWT	GLAZED WALL TILE	SQ	SQUARE
BURN	BURNISHED BLOCK	GTB	GLAZED WALL TILE BASE	SS	STAINLESS STEEL
501111	Bortimories Bedork	0.5	OLI ILLE VIIILE BI IOL	STD	STANDARD
С		<u>H</u>		STL	STEEL
<u>C</u> CG	CORNER GUARD	<u>н</u> НВ	HOSE BIB	SV	SHEET VINYL FLOORING
CJ	CONTROL JOINT	HC	HANDICAPPED	SYM	SYMETRICAL
CLG	CEILING	HLB	HORIZONTAL LOUVER BLINDS		
CMU	CONCRETE MASONRY UNIT	HM	HOLLOW METAL	I	
COL	COLUMN	HPC	HIGH PERFORMANCE COATING	T&G	TONGUE & GROOVE
COMP	COMPARTMENT	HT	HEIGHT	TB	TACKBOARD
	CONCRETE	HVAC	HEATING, VENTING & AIR CONDITIONING		TO BE DETERMINED
	CONSTRUCTION			TC	TOP OF CURB
	CONTINUOUS OR CONTINUE	<u>I</u>		TERR	TERRAZZO
	CONTRACTOR	ID	INSIDE DIAMETER	T.O.	TOP OF
CPT	CARPET	INSL	INSULATION	TOC	TOP OF CONCRETE
	COVE SHEET VINYL BASE	INT	INTERIOR	TOF	TOP OF FOOTING
CT	CERAMIC TILE			TOM	TOP OF MASONRY
CTB	CERAMIC TILE BASE	<u>J</u>		TOO	TOP OF OPENING
_		JBE	JOIST BEARING ELEVATION	TOP	TOP OF PRECAST
<u>D</u>	DOUBLE.	JST . <u>-</u>	JOIST	TOS	TOP OF STEEL
DBL	DOUBLE	JT	JOINT	TOW	TOP OF WALL
	DIAMETER			TPD	TOILET PAPER DISPENS
DIM	DIMENSION	<u>L</u>		TS	TALL STORAGE
DEMO	DEMOLITION	= LAM	LAMINATE	TVD	TELEVISION
DET	DETAIL	LAV	LAVATORY	TYP	TYPICAL
DF DR	DRINKING FOUNTAIN	_/ (v			
DR DS	DOOR DOWNSPOUT	<u>M</u>		<u>U</u> UNO	UNLESS NOTED OTHER
DW	DISH WASHER	MAX	MAXIMUM	UNU	UNLESS NOTED OTHER
DWG	DRAWING	MB	MARKER BOARD	<u>v</u>	
2440	DIVINITO	MECH	MECHANICAL	<u>▼</u> VCT	VINYL COMPOSITION TIL
<u>E</u>		MTL	METAL	VEND	VENDING MACHINE
EA	EACH	MIN	MINIMUM	VEND	VERTICAL
EIFS	EXTERIOR INSULATION FINISH SYSTEM	MO	MASONRY OPENING	VERI	VENT THRU ROOF
EJ	EXPANSION JOINT	MST	MOSAIC TILE	VIK	VINYL WALL BORDER
ELEV	ELEVATION	MTB	MOSAIC TILE BASE	VWC	VINYL WALL BONDER VINYL WALL COVERING
ELEC	ELECTRIC				THE TAX LE GOVERNING
EQ	EQUAL	<u>N</u>		<u>w</u>	
EQUIP	EQUIPMENT	NIC	NOT IN CONTRACT	W/	WITH
ES	EXPOSED STRUCTURE	NO	NUMBER	W/O	WITHOUT
EW	EACH WAY	NOM	NOMINAL	WB	WOOD BASE
EWC	ELECTRIC WATER COOLER	NTS	NOT TO SCALE	WC	WATER CLOSET
EXPO	EXPOSED			WD	WOOD
EXIST	EXISTING	<u>0</u>		WH	WATER HEATER
EXT	EXTERIOR	OC	ON CENTER	WOM	WALK OFF MAT
		OD	OUTSIDE DIAMETER	WT	WEIGHT
		OH	OVERHEAD		

	ARCHITECTURAL SYMBOLS LEGEND							
VIEW NAME 1/8" = 1'-0"	REFERENCED CALLOUT	1 A101	BUILDING SECTION SECTION / DRAWING SHEET					
VIEW NAME 1/8" = 1'-0"	PLAN VIEW CALLOUT	1 A101	WALL SECTION SECTION / DRAWING SHEET					
FLOOR LEVEL 100'-0"	ELEVATION NAME AND HEIGHT	1 A101 SIM	DETAIL OR PLAN CALL OUT VIEW NUMBER / DRAWING SHEET					
0	GRID SYMBOL	?	KEYNOTE TAG					
		⟨999A⟩	DOOR & FRAME TAG					
0	GRID SYMBOL	00>	WINDOW UNIT TAG					
ROOM 101	ROOM NAME, NUMBER, & SQUARE FOOTAGE	X	STOREFRONT & CURTAIN WALL TAG					
150 SF	SQUARETOUTAGE	Áì	ROOF TYPE TAG					
ROOM NAME 150 SF	ROOM NAME & SQUARE FOOTAGE	X	WALL TYPE TAG					
	INTERIOR ELEVATION REFERENCE	1i	FLOOR TYPE TAG					
1/A101 Ref	DETAIL NUMBER / DRAWING SHEET	1	REVISION NUMBER TAG					
1	EXTERIOR BUILDING ELEVATIONS	G.	CENTER LINE					
1 A101 1 2 2 Ref	ELEVATION / DRAWING SHEET	N	NORTH ARROW					




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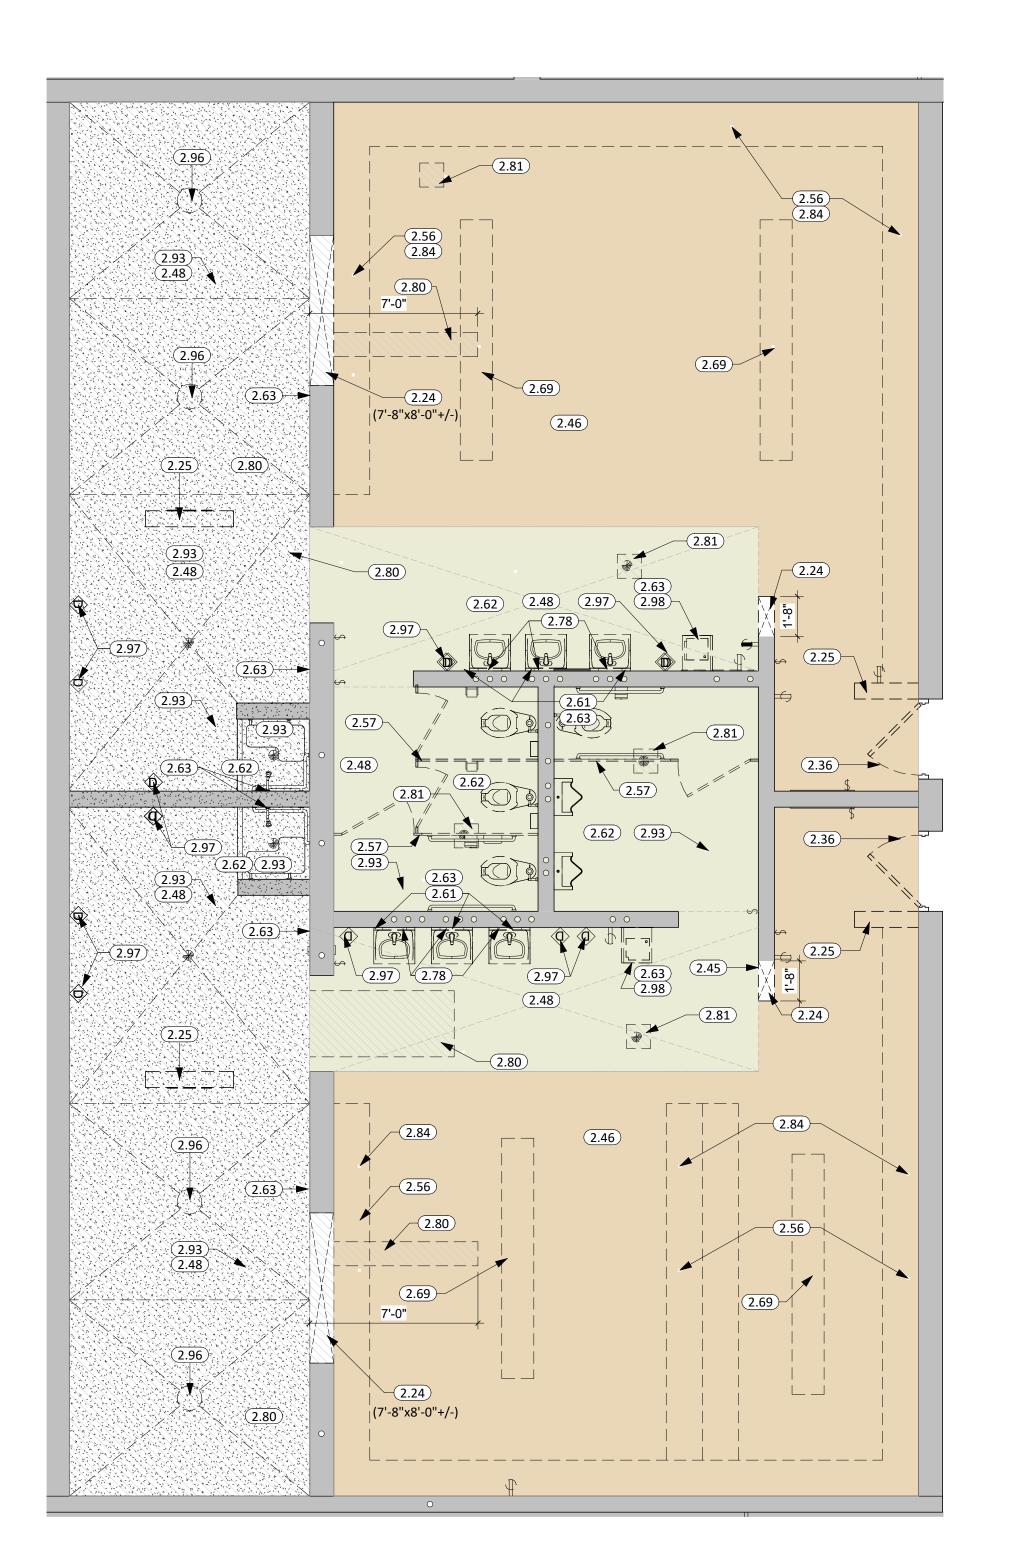
PROJECT: BARNETT CENTER,

NORTHERN STATE UNIVERSITY ABERDEEN, SOUTH DAKOTA

LOCKER ROOM REMODEL

SHEET TITLE: BUILDING SYSTEMS INFORMATION

G001

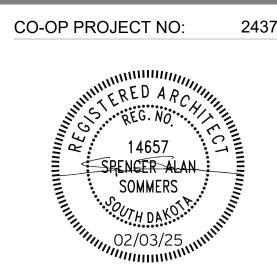

TRACK & FIELD

1 DEMOLITION PLAN



KEYNOTE SCHEDULE REMOVE AND DISPOSE OF PORTION OF MASONRY WALL. PATCH REMAINING WALL, FLOOR, JAMBS, AND/OR HEAD AS NEEDED FOR FINISHED PRODUCT. REMOVE AND DISPOSE OF MASONRY WALL. PATCH ADJACENT WALL AS NEEDED FOR FINISHED PRODUCT. REMOVE DOOR & H.M. FRAME. PATCH SILL, JAMBS, & HEAD AS NEEDED FOR FINISHED PRODUCT. REMOVE MARKER & TACK BOARDS REMOVE AND DISPOSE OF CARPET (INCLUDING ALL ADHESIVES) REMOVE AND DISPOSE OF CERAMIC/PORCELAIN/QUARRY TILE (INCLUDING ALL ADHESIVES/SETTING MATERIALS) REMOVE EXISTING METAL LOCKERS - CONSULT OWNER BEFORE DISPOSAL REMOVE AND REINSTALL EXISTING TOILET PARTITIONS AND TOILET ROOM ACCESSORIES AFTER PROPOSED TILE WORK IS COMPLETED. WALL CUTTING BY GC FOR CONDUITS SERVING LIGHT FIXTURES AND RECEPTACLES. EC TO COORDINATE WITH GC FOR SIZE, PLACEMENTS, AND EXTENT OF CUTTING AND PATCHING. SEE M.E.P. DRAWINGS AND PROJECT MANUAL FOR REMOVAL OF PLUMBING FIXTURES U.N.O. COORDINATE WITH M.E.P. FOR WALL CUTTING AND PATCHING FOR REPLACEMENT OF IN WALL COMPONENTS REMOVE LOCKER ROOM BENCH - CONSULT OWNER BEFORE DISPOSAL REMOVE AND SALVAGE ACCESSORIES HATCHED AREA INDICATES CUTTING FLOOR FOR NEW PLUMBING; SEE MEP FOR MORE INFORMATION AND ANY ADDITIONAL AREAS TO BE CUT/PATCHED. COORDINATE FINAL WIDTHS AND LENGTHS OF CUTTING AND PATCHING. FLOOR SHALL BE CUT CLEANLY SO THAT THERE IS A NEAT JOINT WHEN RECEIVING A NEW FLOOR SLAB HATCHED AREA INDICATES CUTTING FLOOR AS REQUIRED TO REMOVE EXISTING FLOOR DRAIN. SEE MEP FOR MORE INFORMATION AND ANY ADDITIONAL AREAS TO BE CUT/PATCHED. COORDINATE FINAL WIDTHS AND LENGTHS OF CUTTING AND PATCHING. FLOOR SHALL BE CUT CLEANLY SO THAT THERE IS A NEAT JOINT WHEN RECEIVING A NEW FLOOR SLAB. REMOVE AND DISPOSE OF EXISTING LOCKER BASE AS INDICATED REMOVE AND DISPOSE OF EXISTING LATH AND PLASTER CEILING REMOVE AND DISPOSE OF GANG SHOWER POST

REMOVE EXISTING ELECTRIC HAND DRYER

REMOVE EXISTING DRINKING FOUTAIN

DEMOLITION GENERAL NOTES

ALL CONTRACTORS SHALL VISIT THE SITE AND VERIFY ALL EXISTING CONDITIONS AND DIMENSIONS. NOTIFY THE ARCHITECT IMMEDIATELY OF ANY DISCREPANCIES, INCLUDING ANY NECESSARY DEMOLITION.

2. THE OWNER'S OPERATIONS WILL CONTINUED DURING DEMOLITION. DEMOLITION CONTRACTOR SHALL NOT INTERFERE WITH THESE OPERATIONS IN ANY WAY WITHOUT THE OWNER'S EXPRESSED CONSENT.

3. PROVIDE TEMPORARY BARRICADES AND OTHER FORMS OF PROTECTION TO PROTECT OWNER'S PERSONNEL AND GENERAL PUBLIC FROM INJURY DUE TO SELECTIVE DEMOLITION WORK. PROVIDE BARRICADES AND TEMPORARY WALLS AS NEEDED FOR DUST & NOISE CONTROL.

4. PRIOR TO CUTTING EXISTING CONSTRUCTION, LOCATE AND IDENTIFY SERVICES TO REMAIN IN OPERATION, INCLUDING ALL FLOOR PREPERATION, UNDOCUMENTED CONDITIONS, UTILITY RISERS, ETC, AND ANY WALLS THAT CONTAIN LIFE SAFETY VERTICALS RISERS THAT MUST REMAIN IN OPERATION DURING THE DEMOLITION

5. PROVIDE SHORING, BRACING AND ANY OTHER MEANS REQUIRED TO PROTECT AND MAINTAIN THE SAFETY, INTEGRITY, AND STABILITY OF ALL EXISTING AND NEW CONSTRUCTION

CONSTRUCTION.

WHERE WATER CLOSETS, FLOOR SINKS OR OTHER EQUIPMENT AND RELATED PIPING ARE TO BE REMOVED, PATCH FLOOR SLAB W/CONCRETE AS REQUIRED TO MATCH

EXISTING CONDITIONS.
7. ALL CONCRETE FLOOR SLABS NOTED TO BE REMOVED SHALL BE SAWCUT TO

PROVIDE A NEAT JOINT.

8. ALL DEMOLITION SHALL COMPLY WITH APPLICABLE LOCAL CODES, STATE CODES AND ORDINANCES.

REFER TO PROJECT MANUAL FOR ADDITIONAL REQUIREMENTS.

10. REFER TO MECHANICAL, ELECTRICAL PLANS FOR ADDITIONAL INFORMATION RELEVANT TO DEMOLITION AND PATCHING.

11. CONTRACTOR TO PROTECT EXISTING MATERIALS, SPACES WHICH ARE TO REMAIN OR TO BE REUSED. ALL SURFACES DAMAGED BY DEMOLITION, SHALL BE REPAIRED FOR APPLICATION OF NEW FINISHES OR TO MATCH EXISTING

APPLICATION OF NEW FINISHES OR TO MATCH EXISTING.

12. OWNER TO HAVE ALL AREAS AFFECTED BY INTERIOR REMODEL CLEANED OUT PRIOR TO START OF CONSTRUCTION IN AFFECTED AREAS.

13. DEMOLITION SHALL INCLUDE ALL ITEMS KEYNOTED ON DEMOLITION SHEETS, BUT NOT LIMITED TO THESE ITEMS. ALL CONTRACTORS ARE RESPONSIBLE FOR ALL DEMOLITION NECESSARY TO ALLOW FOR COMPLETION OF THE WORK AS DESCRIBED IN THE CONSTRUCTION DOCUMENTS. DEMOLITION OF WALLS INCLUDE ALL ITEMS ATTACHED TO THE WALL. REMOVE ALL MECHANICAL, ELECTRICAL, PLUMBING, AND ARCHITECTURAL ITEMS AS REQUIRED TO FACILITATE NEW CONSTRUCTION, U.O.N. TO BE SALVAGED.

14. ON FLOOR PLANS, DASHED LINES INDICATE WALLS OR PORTIONS OF WALLS TO BE

DEMOLISHED. ALL SHADED WALLS REPRESENT EXISTING WALLS TO REMAIN.

15. DEMOLITION DRAWINGS HAVE BEEN DEVELOPED FROM EXISTING DRAWINGS AND SITE VERIFICATIONS THAT MAY NOT REFLECT ACTUAL FIELD CONDITIONS. CONTRACTOR TO FIELD VERIFY ALL DIMENSIONS AND COORDINATE SCOPE WITH EACH DISCIPLINE. CONTACT ARCHITECT IMMEDIATELY WITH ANY DISCREPANCIES.

16. REFER TO FINISH SCHEDULE FOR ADDITIONAL FINISH WORK REQUIRED IN OTHER AREAS THAT ARE NT DOCUMENTED TO RECEIVE DEMOLITION/REMOVAL WORK

INDICATED ON THE DEMOLITION PLANS.
7. CUT, CLEAN, AND PATCH ALL EXISTING WALLS AND CEILINGS AFFECTED BY DEMOLITION AND AS REQUIRED FOR NEW OR RELOCATED PLUMBING, HVAC OR ELECTRICAL. RESTORE WALL/CEILING SURFACE TO MATCH EXISTING CONDITIONS.

MATERIAL REMOVAL LEGEND

2.80/ 2.81 APPROX. 615 SF OF EXISTING CONCRETE FLOOR & FLOOR FINISH TO REMOVE. CONTRACTOR TO FIELD VERIFY

APPROX. 1,000 SF OF EXISTING CARPET TO REMOVE. CONTRACTOR TO FIELD VERIFY

2.48 APPROX. 408 SF OF EXISTING CERAMIC FLOOR TILE TO REMOVE. CONTRACTOR TO FIELD VERIFY

93 APPROX. 580 SF OF EXISTING PLASTER CEILING & FRAMING TO REMOVE. CONTRACTOR TO FIELD VERIFY

DEMOLITION LEGEND

EXISTING TO REMAIN

EXISTING WALLS/OBJECTS TO BE REMOVED (WALLS ARE CMU UNLESS OTHERWISE NOTED.

1108 S. Main St. 102

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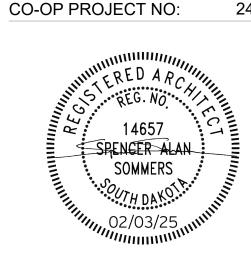
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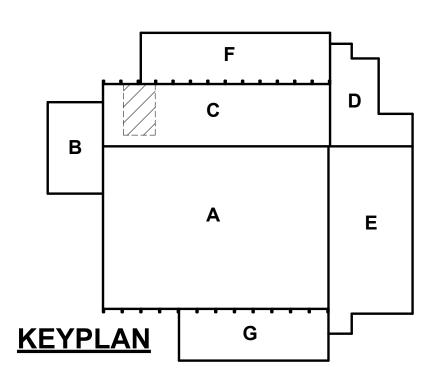
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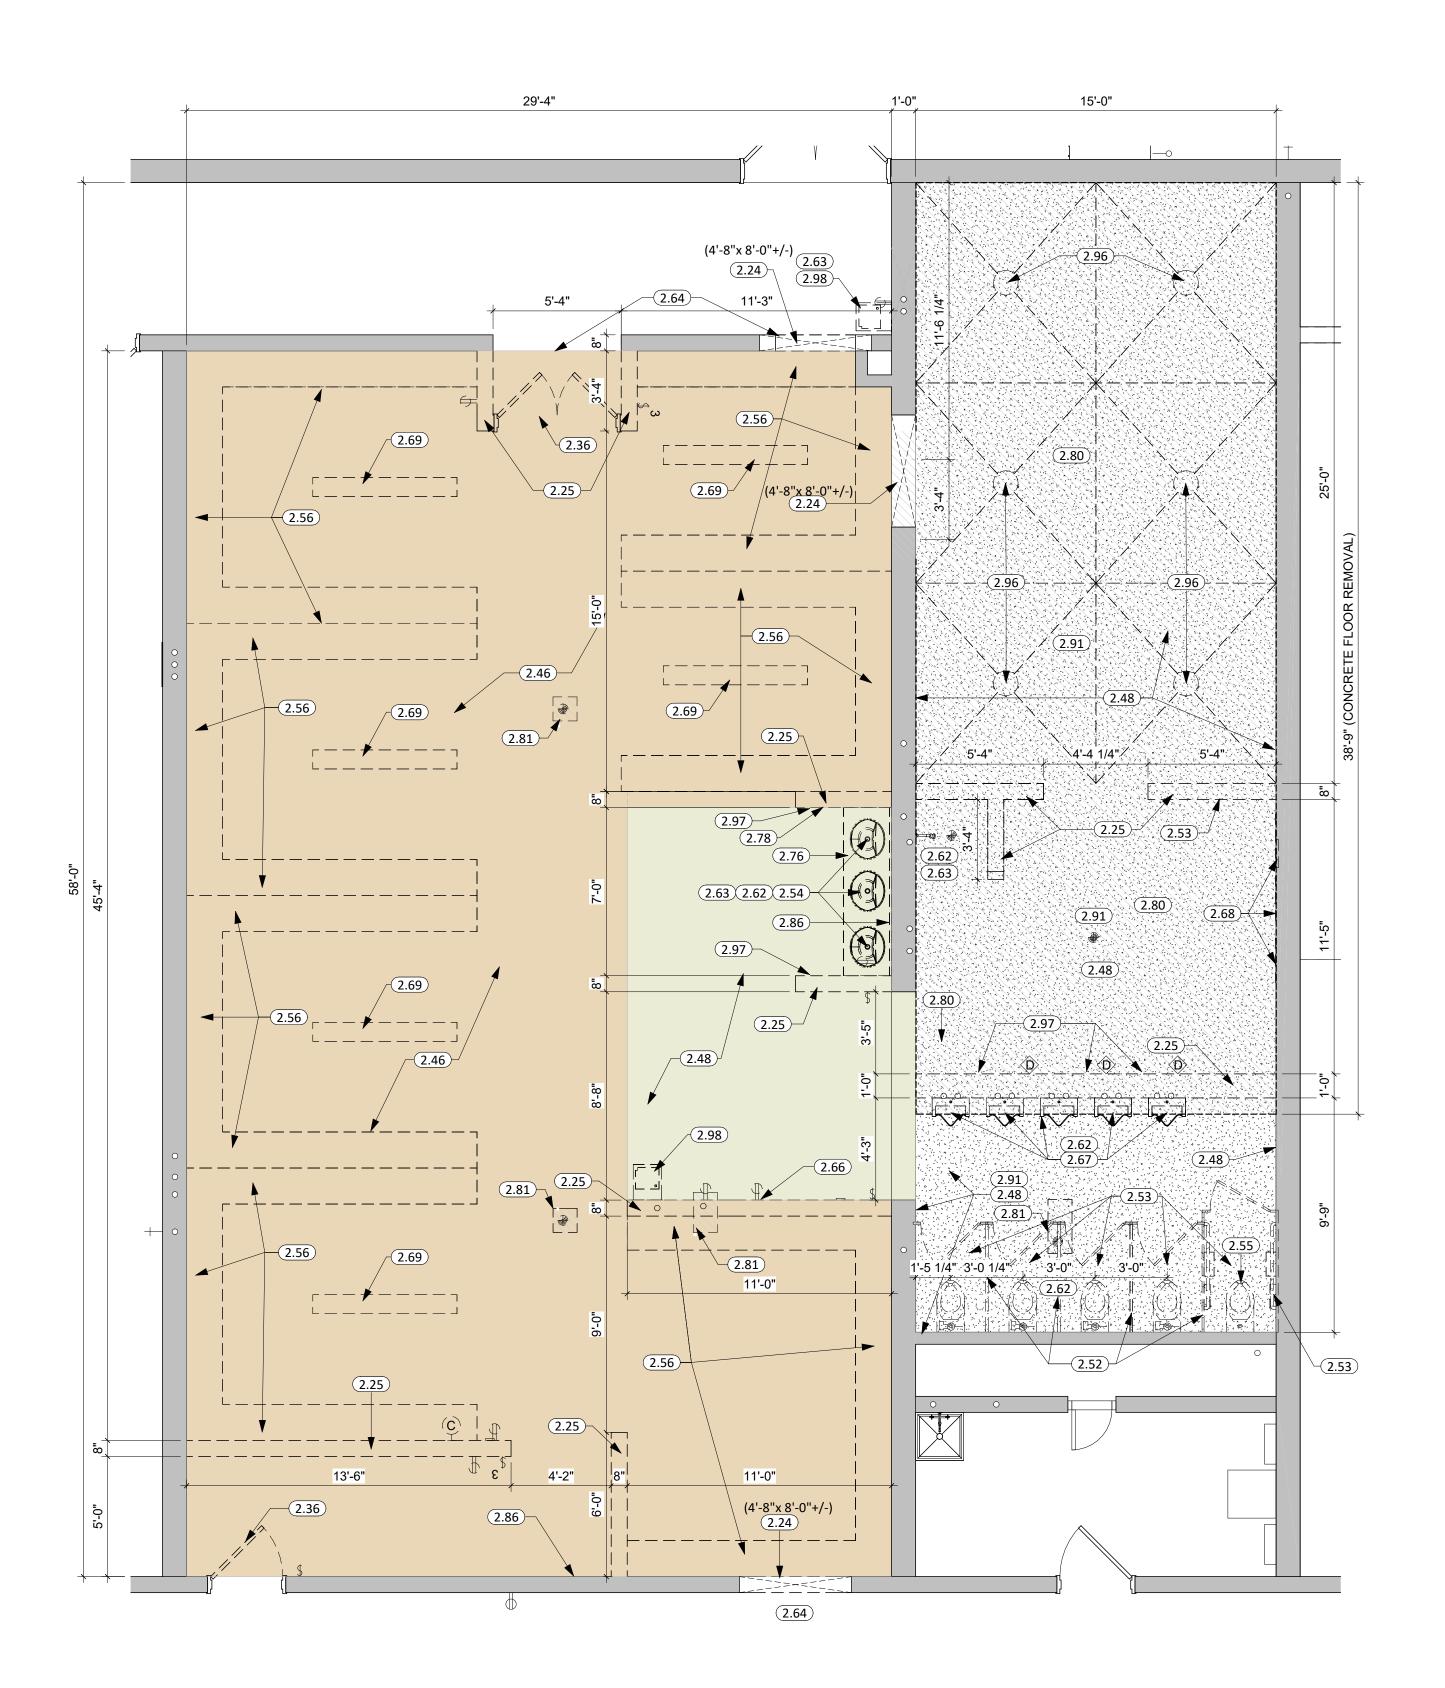
PROJECT:
BARNETT CENTER,
LOCKER ROOM REMODEL

NORTHERN STATE UNIVERSITY ABERDEEN, SOUTH DAKOTA

SHEET TITLE:

TRACK & FIELD DEMOLITION PLAN

D-101



WRESTLING & BASEBALL 1 DEMOLITION PLAN



KEYNOTE SCHEDULE REMOVE AND DISPOSE OF PORTION OF MASONRY WALL. PATCH REMAINING WALL, FLOOR, JAMBS, AND/OR HEAD AS NEEDED FOR FINISHED PRODUCT. REMOVE AND DISPOSE OF MASONRY WALL, PATCH ADJACENT WALL AS NEEDED FOR FINISHED PRODUCT. REMOVE DOOR & H.M. FRAME. PATCH SILL, JAMBS, & HEAD AS NEEDED FOR FINISHED PRODUCT. REMOVE AND DISPOSE OF CARPET (INCLUDING ALL ADHESIVES) REMOVE AND DISPOSE OF CERAMIC/PORCELAIN/QUARRY TILE (INCLUDING ALL ADHESIVES/SETTING MATERIALS) REMOVE TOILET PARTITION REMOVE AND SALVAGE TOILET ACCESSORIES REMOVE AND DISPOSE OF SINK REMOVE AND DISPOSE OF WATER CLOSET REMOVE EXISTING METAL LOCKERS - CONSULT OWNER BEFORE DISPOSAL SEE M.E.P. DRAWINGS AND PROJECT MANUAL FOR REMOVAL OF PLUMBING FIXTURES U.N.O. COORDINATE WITH M.E.P. FOR WALL CUTTING AND PATCHING FOR REPLACEMENT OF IN WALL COMPONENTS MODIFY EXISTING ACT AS NEEDED FOR NEW CONSTRUCTION. REMOVE & REINSTALL TILES WHERE NEEDED TO PREVENT DAMAGE DURING CONSTRUCTION. SALVAGE UNUSED TILE TO REPLACE ANY TILES DAMAGED FROM CONSTRUCTION. REMOVE ALL MARKERBOARDS AND TACKBOARDS, PATCH EXISTING WALL AS REQUIRED TO MATCH EXISTING. REMOVE & RELOCATE URINAL AS NOTED IN MEP DRAWINGS REMOVE EXISTING ACCESS PANELS & PATCH OPENING TO MATCH SURROUNDING REMOVE LOCKER ROOM BENCH - CONSULT OWNER BEFORE DISPOSAL REMOVE AND DISPOSE OF COUNTERTOP REMOVE AND SALVAGE ACCESSORIES HATCHED AREA INDICATES CUTTING FLOOR FOR NEW PLUMBING; SEE MEP FOR MORE INFORMATION AND ANY ADDITIONAL AREAS TO BE CUT/PATCHED. COORDINATE FINAL WIDTHS AND LENGTHS OF CUTTING AND PATCHING. FLOOR SHALL BE CUT CLEANLY SO THAT THERE IS A NEAT JOINT WHEN RECEIVING A NEW FLOOR SLAB HATCHED AREA INDICATES CUTTING FLOOR AS REQUIRED TO REMOVE EXISTING FLOOR DRAIN. SEE MEP FOR MORE INFORMATION AND ANY ADDITIONAL AREAS TO BE CUT/PATCHED. COORDINATE FINAL WIDTHS AND LENGTHS OF CUTTING AND PATCHING. FLOOR SHALL BE CUT CLEANLY SO THAT THERE IS A NEAT JOINT WHEN RECEIVING A NEW FLOOR SLAB.

REMOVE AND DISPOSE OF EXISTING MIRROR.

REMOVE AND DISPOSE OF GANG SHOWER POST REMOVE EXISTING ELECTRIC HAND DRYER

REMOVE EXISTING DRINKING FOUTAIN

COMPLETION OF WORK.

REMOVE EXG. CEILING TO ALLOW FOR MECHANICAL WORK. PATCH UPON

DEMOLITION GENERAL NOTES

ALL CONTRACTORS SHALL VISIT THE SITE AND VERIFY ALL EXISTING CONDITIONS AND DIMENSIONS. NOTIFY THE ARCHITECT IMMEDIATELY OF ANY DISCREPANCIES. INCLUDING ANY NECESSARY DEMOLITION.

THE OWNER'S OPERATIONS WILL CONTINUED DURING DEMOLITION. DEMOLITION CONTRACTOR SHALL NOT INTERFERE WITH THESE OPERATIONS IN ANY WAY WITHOUT THE OWNER'S EXPRESSED CONSENT.

PROVIDE TEMPORARY BARRICADES AND OTHER FORMS OF PROTECTION TO PROTECT OWNER'S PERSONNEL AND GENERAL PUBLIC FROM INJURY DUE TO SELECTIVE DEMOLITION WORK. PROVIDE BARRICADES AND TEMPORARY WALLS AS NEEDED FOR DUST & NOISE CONTROL.

PRIOR TO CUTTING EXISTING CONSTRUCTION, LOCATE AND IDENTIFY SERVICES TO REMAIN IN OPERATION, INCLUDING ALL FLOOR PREPERATION, UNDOCUMENTED CONDITIONS, UTILITY RISERS, ETC, AND ANY WALLS THAT CONTAIN LIFE SAFETY VERTICALS RISERS THAT MUST REMAIN IN OPERATION DURING THE DEMOLITION

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WHERE WATER CLOSETS, FLOOR SINKS OR OTHER EQUIPMENT AND RELATED PIPING ARE TO BE REMOVED, PATCH FLOOR SLAB W/CONCRETE AS REQUIRED TO MATCH

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REFER TO MECHANICAL, ELECTRICAL PLANS FOR ADDITIONAL INFORMATION RELEVANT TO DEMOLITION AND PATCHING. CONTRACTOR TO PROTECT EXISTING MATERIALS, SPACES WHICH ARE TO REMAIN OR

TO BE REUSED. ALL SURFACES DAMAGED BY DEMOLITION, SHALL BE REPAIRED FOR APPLICATION OF NEW FINISHES OR TO MATCH EXISTING. OWNER TO HAVE ALL AREAS AFFECTED BY INTERIOR REMODEL CLEANED OUT PRIOR

TO START OF CONSTRUCTION IN AFFECTED AREAS. . DEMOLITION SHALL INCLUDE ALL ITEMS KEYNOTED ON DEMOLITION SHEETS, BUT NOT LIMITED TO THESE ITEMS. ALL CONTRACTORS ARE RESPONSIBLE FOR ALL DEMOLITION NECESSARY TO ALLOW FOR COMPLETION OF THE WORK AS DESCRIBED IN THE CONSTRUCTION DOCUMENTS. DEMOLITION OF WALLS INCLUDE ALL ITEMS ATTACHED TO THE WALL. REMOVE ALL MECHANICAL, ELECTRICAL, PLUMBING, AND ARCHITECTURAL ITEMS AS REQUIRED TO FACILITATE NEW CONSTRUCTION, U.O.N. TO BE SALVAGED.

. ON FLOOR PLANS, DASHED LINES INDICATE WALLS OR PORTIONS OF WALLS TO BE

DEMOLISHED. ALL SHADED WALLS REPRESENT EXISTING WALLS TO REMAIN. DEMOLITION DRAWINGS HAVE BEEN DEVELOPED FROM EXISTING DRAWINGS AND SITE VERIFICATIONS THAT MAY NOT REFLECT ACTUAL FIELD CONDITIONS. CONTRACTOR TO FIELD VERIFY ALL DIMENSIONS AND COORDINATE SCOPE WITH EACH DISCIPLINE. CONTACT ARCHITECT IMMEDIATELY WITH ANY DISCREPANCIES.

REFER TO FINISH SCHEDULE FOR ADDITIONAL FINISH WORK REQUIRED IN OTHER AREAS THAT ARE NT DOCUMENTED TO RECEIVE DEMOLITION/REMOVAL WORK INDICATED ON THE DEMOLITION PLANS.

CUT, CLEAN, AND PATCH ALL EXISTING WALLS AND CEILINGS AFFECTED BY DEMOLITION AND AS REQUIRED FOR NEW OR RELOCATED PLUMBING, HVAC OR ELECTRICAL. RESTORE WALL/CEILING SURFACE TO MATCH EXISTING CONDITIONS.

MATERIAL REMOVAL LEGEND

APPROX. 592 SF OF EXISTING CONCRETE FLOOR & FLOOR FINISH TO REMOVE. CONTRACTOR TO FIELD VERIFY 2.81 APPROX. 1,314 SF OF EXISTING CARPET TO REMOVE. CONTRACTOR TO FIELD VERIFY

APPROX. 180 SF OF EXISTING CERAMIC FLOOR TILE TO REMOVE. 2.48 CONTRACTOR TO FIELD VERIFY

APPROX. 718 SF OF EXISTING PLASTER CEILING & FRAMING TO REMOVE. CONTRACTOR TO FIELD VERIFY

DEMOLITION LEGEND

EXISTING TO REMAIN

EXISTING WALLS/OBJECTS TO BE REMOVED (WALLS ARE CMU UNLESS OTHERWISE NOTED.

1108 S. Main St. 102

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Rapid City, SD 57701

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Sioux Falls, SD 57104

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OSE PROJECT NO: RO124--16X




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PROJECT: BARNETT CENTER, LOCKER ROOM REMODEL


NORTHERN STATE UNIVERSITY ABERDEEN, SOUTH DAKOTA

SHEET TITLE:

WRESTLING & BASEBALL DEMOLITION PLAN

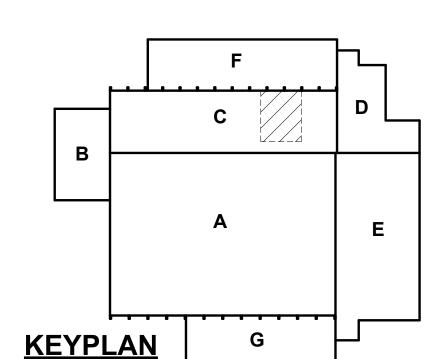D-102



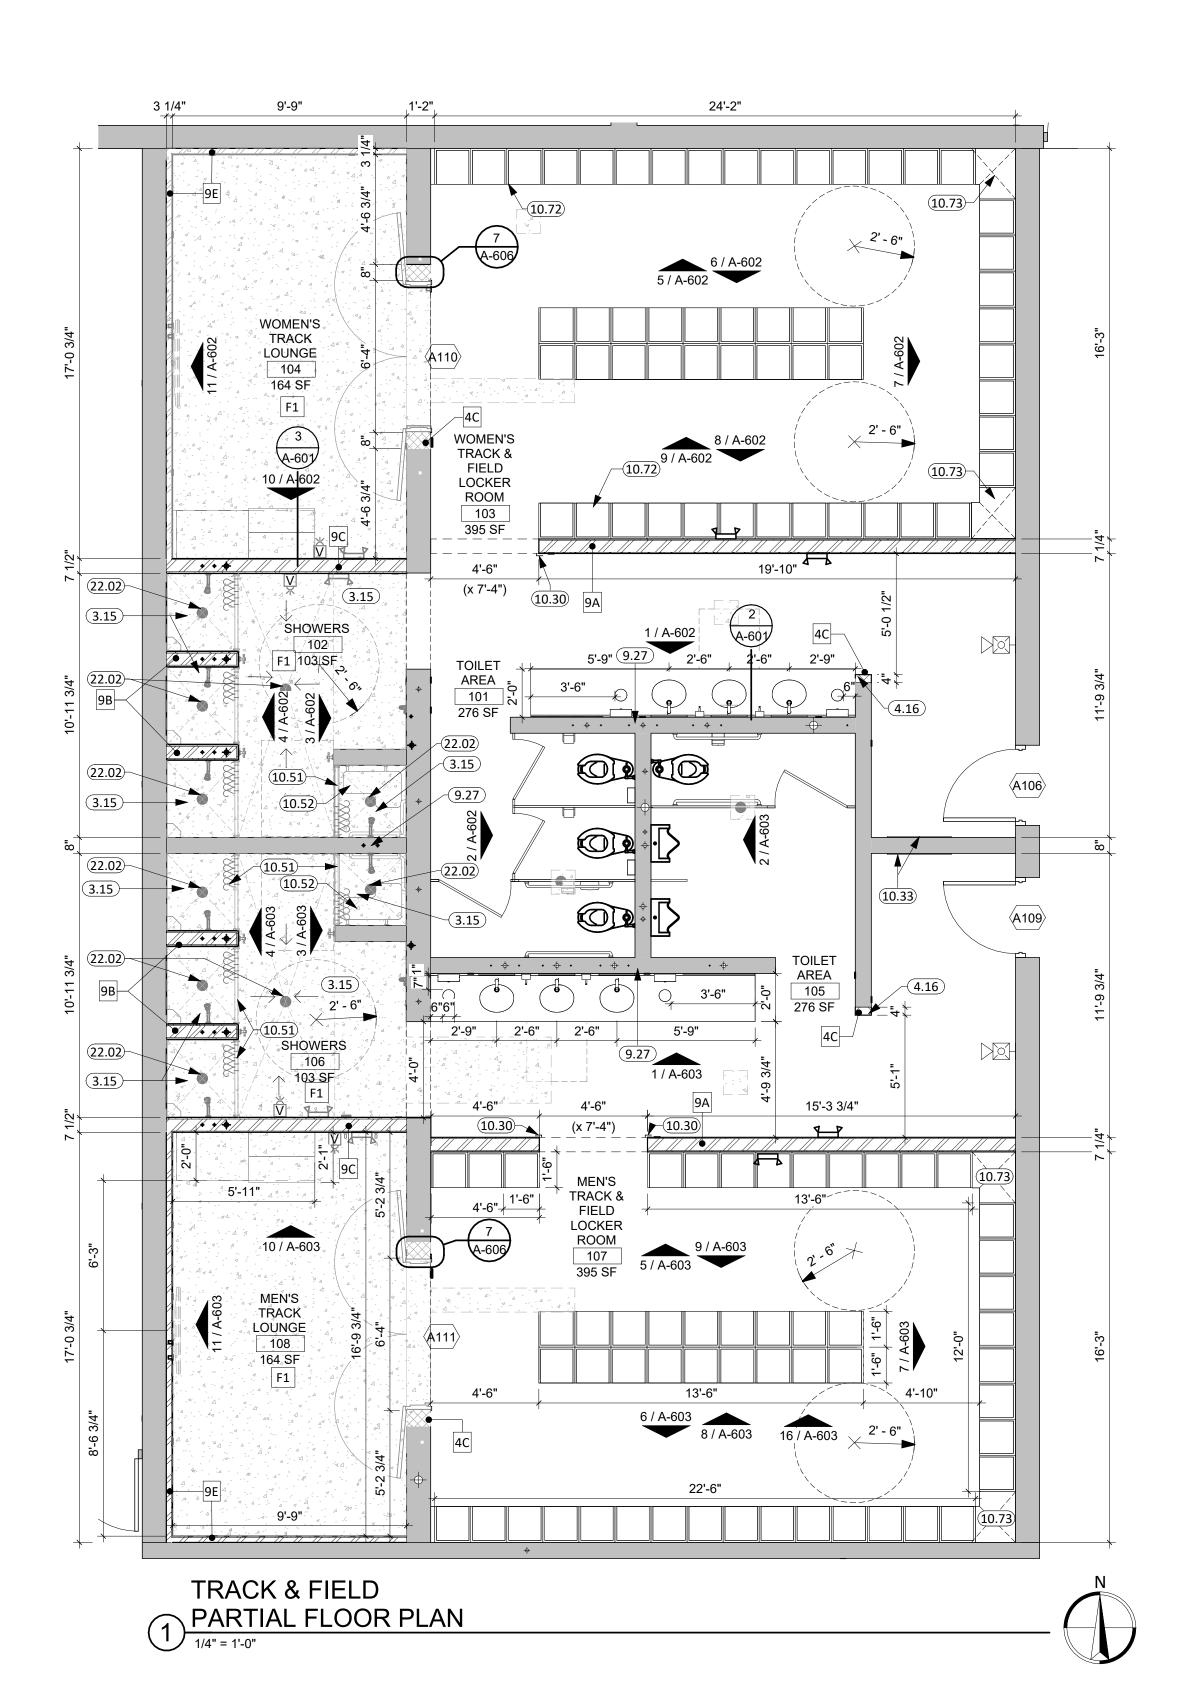

- SEE SHEET G000 FOR REQUIRED ADA CLEARANCES & MOUNTING HEIGHTS.
 SEE DRAWING SHEET A601 FOR ROOM FINISH SCHEDULE.
- 3. SEE MECHANICAL, AND ELECTRICAL FOR ADDITIONAL INFORMATION AND COORDINATION.
- 4. ALL WALLS EXTEND TO DECK UNLESS OTHERWISE NOTED ON WALL TYPES. STUD
- WALLS TO UTILIZE SLIP TRACKS WHEN ATTACHING TO PRECAST DECK.

 5. ALL DIMENSIONS ARE FROM FACE CMU/GWB TO FACE OF CMU/GWB U.N.O.
- ALL DIMENSIONS ARE FROM FACE CMO/GWB TO FACE OF CMO/GWB U.N.O.
 INTERIOR WALL FINISHES ARE FULL HEIGHT, U.N.O.
 COORDINATE ALL CHASE SIZES AND LOCATIONS W/ MECHANICAL. PROVIDE CHASES
- AT ALL EXPOSED MECHANICAL & ELECTRICAL WITH ADJACENT WALL MATERIAL AS REQUIRED.

 8. SEE FLOOR PLAN(S) AND INTERIOR ELEVATIONS FOR CASEWORK INFORMATION.
- FIELD VERIFY DIMENSIONS OF CASEWORK OPENINGS.

 PROVIDE COUNTERTOP SUPPORTS AT OPEN SPACES AT MINIMUM OF 32" ON CENTER.
- AND MAXIMUM OF 36" ON CENTER.

 10. COORDINATE PENETRATIONS AT COUNTERTOPS W/MECHANICAL AND ELECTRICAL.
- 11. MILLWORK SUPPLIER SHALL PROVIDE FILLER PANELS AND SCRIBE STRIPS AS
- NEEDED FOR COMPLETE INSTALLATION.

 12. PROVIDE FINISHED END ALL PANELS AT EXPOSED MILLWORK SURFACES.

 13. CAULK PERIMETER OF TOILETS, URINALS, SINKS AND COUNTERTOPS AS REQUIRED.
- 14. COORDINATE INSTALLATION OF OWNER PROVIDED EQUIPMENT WITH NEW CONSTRUCTION.

5. USE SCHLUTER DITRA UNDERLAYMENT UNDER ALL FLOOR TILE.

CORNERS AT ALL CMU OPENINGS.

- PROVIDE WATER-RESISTANT GYPSUM BOARD PANELS AT ALL BATHROOM WALLS, CEILINGS. AND ANY WALLS EXPOSED TO MOISTURE.
- 17. PREP ALL EXISTING WALLS AS REQUIRED FOR PROPER ADHESION OF NEW WALL
- 1 ILE.

 18. PATCH RESILIENT WALL BASE AS REQUIRED AT ALL INFILLED OPENINGS AT
- ALL LOCATIONS. MATCH EXISTING.


 19. CONTRACTOR TO VERIFY ALL EXISTING CONDITIONS, ELEVATIONS, AND DIMENSIONS.

 20. CUT, CLEAN, & PATCH ALL EXISTING WALLS AND CEILINGS AFFECTED BY DEMOLITION
- AND AS REQUIRED FOR NEW OR RELOCATED PLUMBING, HVAC OR ELECTRICAL.
 RESTORE WALL/CEILING SURFACE TO MATCH EXISTING CONDITIONS. (TYP)
- 21. ALL WORK SHALL BE IN ACCORDANCE WITH OSHA CODES AND STANDARDS.

 NOTHING INDICATED ON THESE DRAWINGS SHALL RELIEVE THE CONTRACTOR FROM
- COMPLYING WITH ANY APPROPRIATE SAFETY REGULATIONS.

 22. DRILL/EPOXY HORIZONTAL REINFORCEMENT 6" INTO EXISTING WALL AT ALL LOCATIONS WHERE NEW CMU WALL RUNS INTO EXISTING CMU. PROVIDE BULLNOSE

KEYNOTE SCHEDULE						
3.15	SLOPE NEW CONCRETE FLOOR SLAB TO DRAIN (1/4" PER FOOT) U.O.N.					
4.16	CMU BULLNOSE CORNER UNIT					
9.27	CUT, CLEAN, AND PATCH ALL EXISTING WALLS AND CEILINGS AFFECTED BY DEMOLITION AND AS REQUIRED FOR NEW OR RELOCATED PLUMBING, HVAC OR ELECTRICAL. RESTORE WALL/CEILING SURFACE TO MATCH EXISTING CONDITIONS.					
10.30	CORNER GUARDS					
10.33	EXISTING WALL MIRROR TO REMAIN					
10.51	SHOWER ROD, CURTAIN, & HOOKS					
10.52	SHOWER SEAT W/GRAB BARS - ADA					
10.72	ATHLETIC LOCKERS (SEE PROJECT MANUAL)					
10.73	CORNER & FILLER PANELS TO MATCH NEARBY ATHLETIC LOCKERS (SIDES & TOP)					
22.02	FLOOR DRAIN (SEE PLUMBING)					

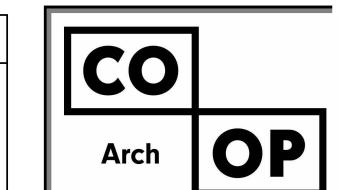


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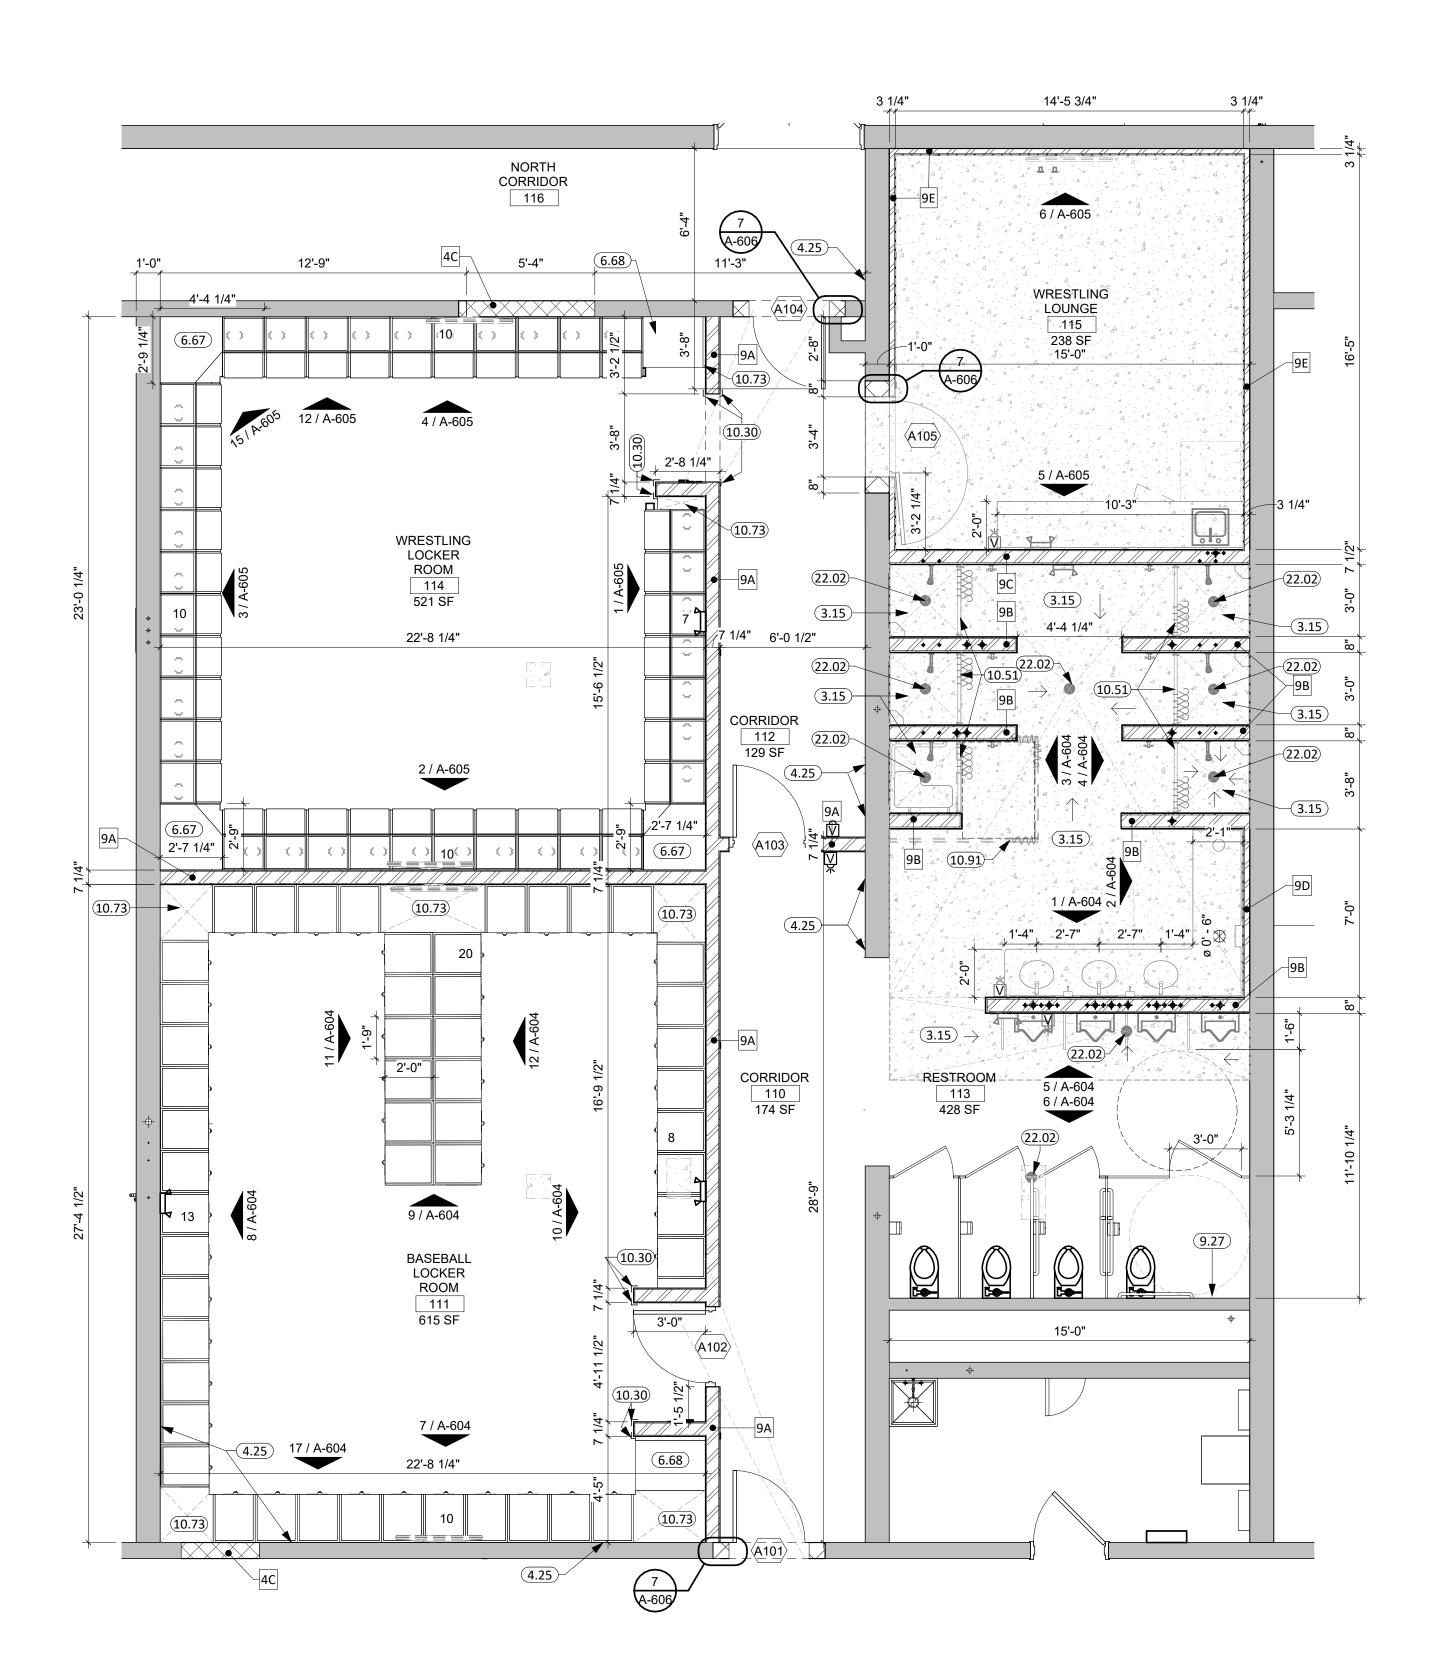
F C D E

PROJECT:
BARNETT CENTER,
LOCKER ROOM REMODEL

NORTHERN STATE UNIVERSITY ABERDEEN, SOUTH DAKOTA

SHEET TITLE:

TRACK & FIELD FLOOR PLAN

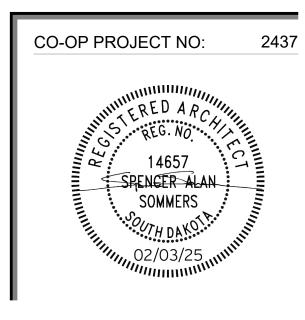

WRESTLING & BASEBALL PARTIAL FLOOR PLAN

1/4" = 1'-0"



GENERAL NOTES

- SEE SHEET G000 FOR REQUIRED ADA CLEARANCES & MOUNTING HEIGHTS. SEE DRAWING SHEET **A601** FOR ROOM FINISH SCHEDULE.
- SEE MECHANICAL, AND ELECTRICAL FOR ADDITIONAL INFORMATION AND
- COORDINATION. ALL WALLS EXTEND TO DECK UNLESS OTHERWISE NOTED ON WALL TYPES. STUD
- WALLS TO UTILIZE SLIP TRACKS WHEN ATTACHING TO PRECAST DECK. ALL DIMENSIONS ARE FROM FACE CMU/GWB TO FACE OF CMU/GWB U.N.O.
- INTERIOR WALL FINISHES ARE FULL HEIGHT, U.N.O.
- COORDINATE ALL CHASE SIZES AND LOCATIONS W/ MECHANICAL. PROVIDE CHASES AT ALL EXPOSED MECHANICAL & ELECTRICAL WITH ADJACENT WALL MATERIAL AS REQUIRED.
- SEE FLOOR PLAN(S) AND INTERIOR ELEVATIONS FOR CASEWORK INFORMATION. FIELD VERIFY DIMENSIONS OF CASEWORK OPENINGS.
- PROVIDE COUNTERTOP SUPPORTS AT OPEN SPACES AT MINIMUM OF 32" ON CENTER AND MAXIMUM OF 36" ON CENTER.
- 10. COORDINATE PENETRATIONS AT COUNTERTOPS W/MECHANICAL AND ELECTRICAL. 1. MILLWORK SUPPLIER SHALL PROVIDE FILLER PANELS AND SCRIBE STRIPS AS
- NEEDED FOR COMPLETE INSTALLATION.
- 2. PROVIDE FINISHED END ALL PANELS AT EXPOSED MILLWORK SURFACES. 13. CAULK PERIMETER OF TOILETS, URINALS, SINKS AND COUNTERTOPS AS REQUIRED.
- 14. COORDINATE INSTALLATION OF OWNER PROVIDED EQUIPMENT WITH NEW CONSTRUCTION.
- 5. USE SCHLUTER DITRA UNDERLAYMENT UNDER ALL FLOOR TILE. 16. PROVIDE WATER-RESISTANT GYPSUM BOARD PANELS AT ALL BATHROOM WALLS,

CORNERS AT ALL CMU OPENINGS.

- CEILINGS. AND ANY WALLS EXPOSED TO MOISTURE. 7. PREP ALL EXISTING WALLS AS REQUIRED FOR PROPER ADHESION OF NEW WALL
- 8. PATCH RESILIENT WALL BASE AS REQUIRED AT ALL INFILLED OPENINGS AT
- ALL LOCATIONS. MATCH EXISTING. 9. CONTRACTOR TO VERIFY ALL EXISTING CONDITIONS, ELEVATIONS, AND DIMENSIONS. 0. CUT, CLEAN, & PATCH ALL EXISTING WALLS AND CEILINGS AFFECTED BY DEMOLITION AND AS REQUIRED FOR NEW OR RELOCATED PLUMBING, HVAC OR ELECTRICAL.
- RESTORE WALL/CEILING SURFACE TO MATCH EXISTING CONDITIONS. (TYP) ALL WORK SHALL BE IN ACCORDANCE WITH OSHA CODES AND STANDARDS.
- NOTHING INDICATED ON THESE DRAWINGS SHALL RELIEVE THE CONTRACTOR FROM COMPLYING WITH ANY APPROPRIATE SAFETY REGULATIONS.
- 2. DRILL/EPOXY HORIZONTAL REINFORCEMENT 6" INTO EXISTING WALL AT ALL LOCATIONS WHERE NEW CMU WALL RUNS INTO EXISTING CMU. PROVIDE BULLNOSE

	KEYNOTE SCHEDULE
3.15	SLOPE NEW CONCRETE FLOOR SLAB TO DRAIN (1/4" PER FOOT) U.O.N.
4.25	PATCH EXISTING CMU WALL TO MATCH SURROUNDING AREA WHERE WALLS, FIXTURES, OR M.E.P. COMPONENTS HAVE BEEN REMOVED (TYP)
6.67	CUSTOM WOOD CORNER SHELVING TO MATCH SURROUNDING ATHLETIC LOCKERS
6.68	CUSTOM WOOD SHELVING TO MATCH SURROUNDING ATHLETIC LOCKERS
9.27	CUT, CLEAN, AND PATCH ALL EXISTING WALLS AND CEILINGS AFFECTED BY DEMOLITION AND AS REQUIRED FOR NEW OR RELOCATED PLUMBING, HVAC OR ELECTRICAL. RESTORE WALL/CEILING SURFACE TO MATCH EXISTING CONDITIONS.
10.30	CORNER GUARDS

CORNER GUARDS SHOWER ROD, CURTAIN, & HOOKS

10.51 10.73 CORNER & FILLER PANELS TO MATCH NEARBY ATHLETIC LOCKERS (SIDES & TOP) 10.91 CEILING MOUNTED CUBICLE CURTAIN, TRACK, & HOOKS

FLOOR DRAIN (SEE PLUMBING)

OSE PROJECT NO: RO124--16X

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Rapid City, SD 57701


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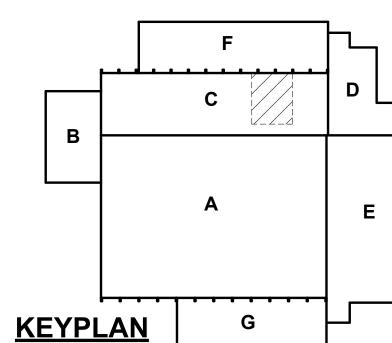
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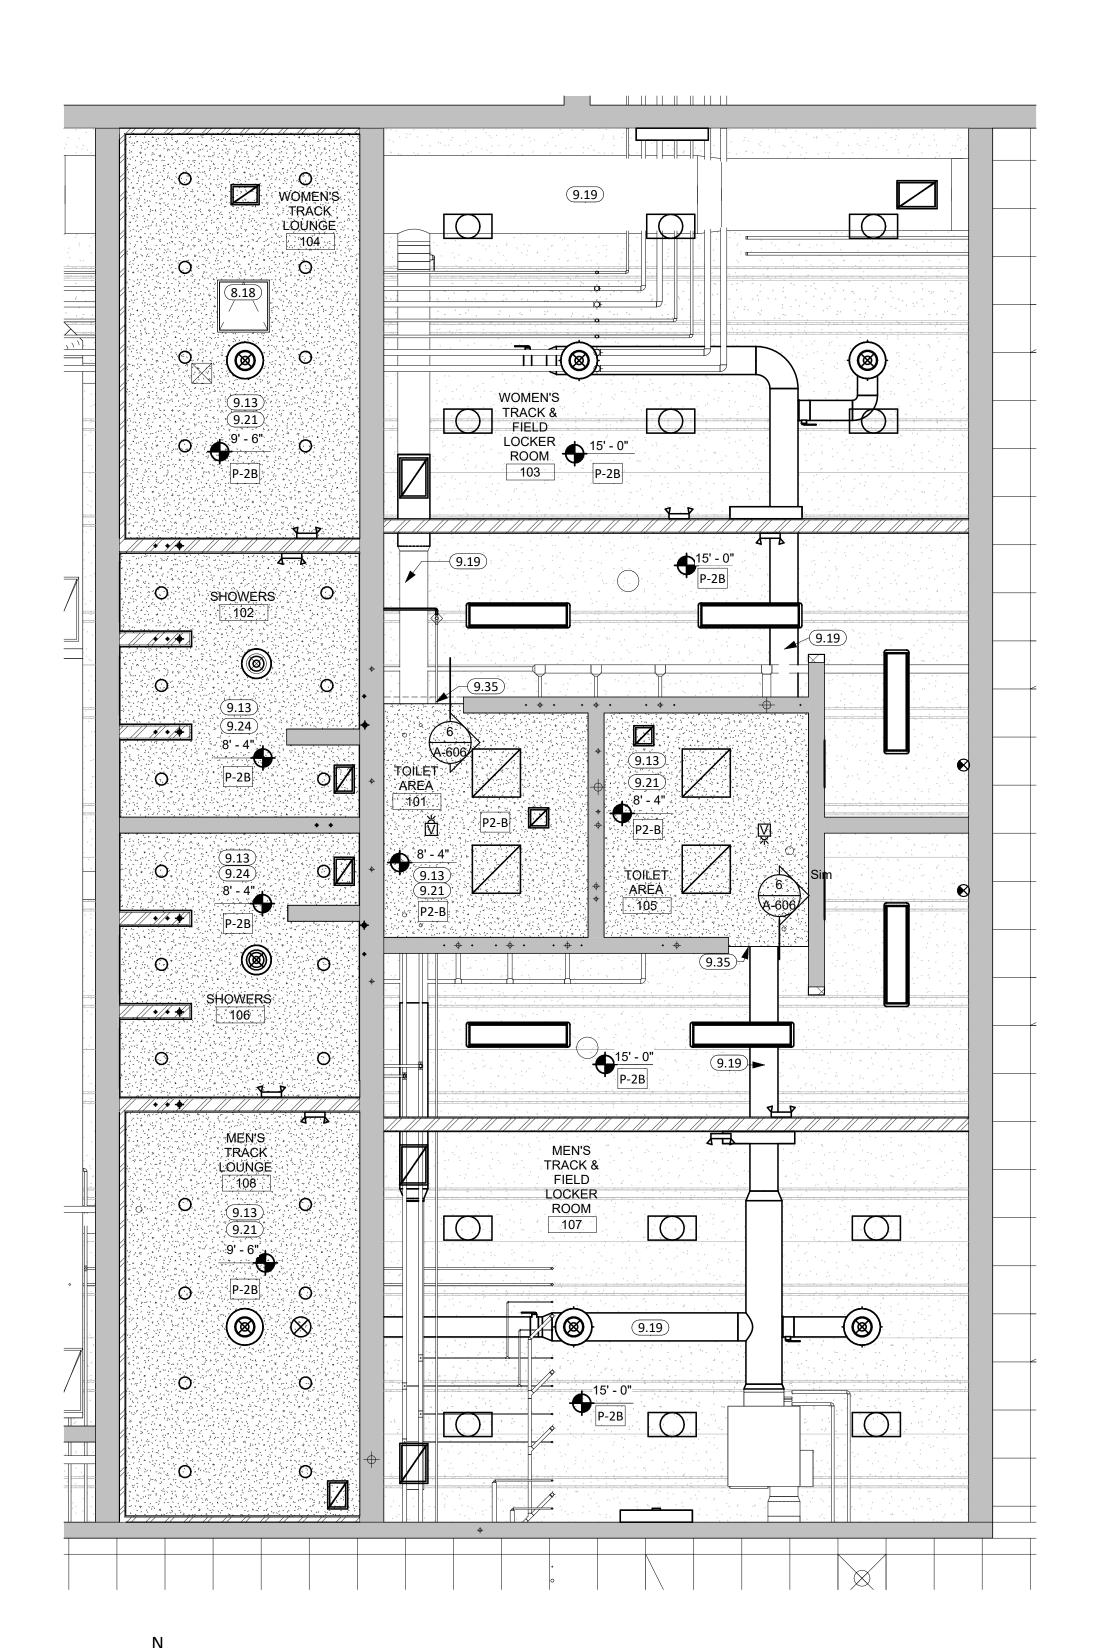
BARNETT CENTER, LOCKER ROOM REMODEL NORTHERN STATE UNIVERSITY ABERDEEN, SOUTH DAKOTA

SHEET TITLE:

PROJECT:

WRESTLING & BASEBALL FLOOR PLAN



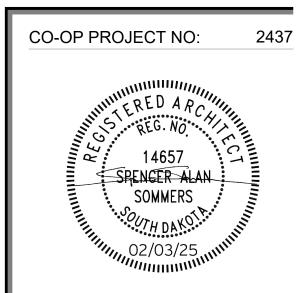

TRACK & FIELD -REFLECTED CEILING PLAN


1/4" = 1'-0"

GENERAL NOTES

- SEE SHEET **G000** FOR REQUIRED ADA CLEARANCES & MOUNTING HEIGHTS. SEE DRAWING SHEET <u>A601</u> FOR ROOM FINISH SCHEDULE.
- SEE MECHANICAL, AND ELECTRICAL FOR ADDITIONAL INFORMATION AND COORDINATION.
- ALL WALLS EXTEND TO DECK UNLESS OTHERWISE NOTED ON WALL TYPES. STUD
 - WALLS TO UTILIZE SLIP TRACKS WHEN ATTACHING TO PRECAST DECK. ALL DIMENSIONS ARE FROM FACE CMU/GWB TO FACE OF CMU/GWB U.N.O.
- INTERIOR WALL FINISHES ARE FULL HEIGHT, U.N.O. COORDINATE ALL CHASE SIZES AND LOCATIONS W/ MECHANICAL. PROVIDE CHASES AT ALL EXPOSED MECHANICAL & ELECTRICAL WITH ADJACENT WALL MATERIAL AS
- SEE FLOOR PLAN(S) AND INTERIOR ELEVATIONS FOR CASEWORK INFORMATION. FIELD VERIFY DIMENSIONS OF CASEWORK OPENINGS.
- PROVIDE COUNTERTOP SUPPORTS AT OPEN SPACES AT MINIMUM OF 32" ON CENTER AND MAXIMUM OF 36" ON CENTER.
- 0. COORDINATE PENETRATIONS AT COUNTERTOPS W/MECHANICAL AND ELECTRICAL. 1. MILLWORK SUPPLIER SHALL PROVIDE FILLER PANELS AND SCRIBE STRIPS AS
- NEEDED FOR COMPLETE INSTALLATION. 12. PROVIDE FINISHED END ALL PANELS AT EXPOSED MILLWORK SURFACES.
- 13. CAULK PERIMETER OF TOILETS, URINALS, SINKS AND COUNTERTOPS AS REQUIRED. 14. COORDINATE INSTALLATION OF OWNER PROVIDED EQUIPMENT WITH NEW
- CONSTRUCTION. 15. USE SCHLUTER DITRA UNDERLAYMENT UNDER ALL FLOOR TILE.
- 16. PROVIDE WATER-RESISTANT GYPSUM BOARD PANELS AT ALL BATHROOM WALLS, CEILINGS. AND ANY WALLS EXPOSED TO MOISTURE.
- 17. PREP ALL EXISTING WALLS AS REQUIRED FOR PROPER ADHESION OF NEW WALL
- 18. PATCH RESILIENT WALL BASE AS REQUIRED AT ALL INFILLED OPENINGS AT ALL LOCATIONS. MATCH EXISTING.
- CONTRACTOR TO VERIFY ALL EXISTING CONDITIONS, ELEVATIONS, AND DIMENSIONS. 20. CUT, CLEAN, & PATCH ALL EXISTING WALLS AND CEILINGS AFFECTED BY DEMOLITION AND AS REQUIRED FOR NEW OR RELOCATED PLUMBING, HVAC OR ELECTRICAL.
- RESTORE WALL/CEILING SURFACE TO MATCH EXISTING CONDITIONS. (TYP) 1. ALL WORK SHALL BE IN ACCORDANCE WITH OSHA CODES AND STANDARDS. NOTHING INDICATED ON THESE DRAWINGS SHALL RELIEVE THE CONTRACTOR FROM
- COMPLYING WITH ANY APPROPRIATE SAFETY REGULATIONS. 22. DRILL/EPOXY HORIZONTAL REINFORCEMENT 6" INTO EXISTING WALL AT ALL LOCATIONS WHERE NEW CMU WALL RUNS INTO EXISTING CMU. PROVIDE BULLNOSE

CORNERS AT ALL CMU OPENINGS.

	KEYNOTE SCHEDULE
8.18	24"x24" LOCKABLE CEILING ACCESS PANEL - COLOR T.B.D. COORIDINATE INSTALLATION LOCATION WITH MEP.
9.13	1 1/2" CARRYING CHANNEL
9.19	EXISTING EXPOSED STRUCTURE PAINTED WITH P-2A
9.21	5/8" GYPSUM BOARD
9.24	5/8" MOISTURE RESISTANT GYPSUM BOARD
9.35	LINE OF GYPSUM WALLBOARD SOFFIT ABOVE

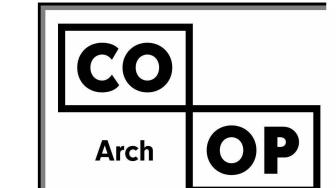


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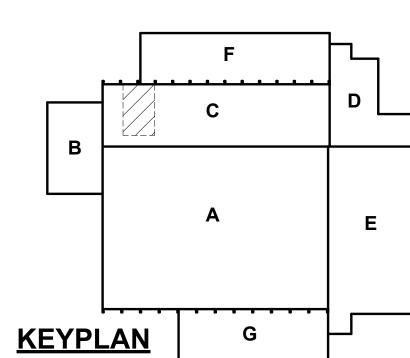
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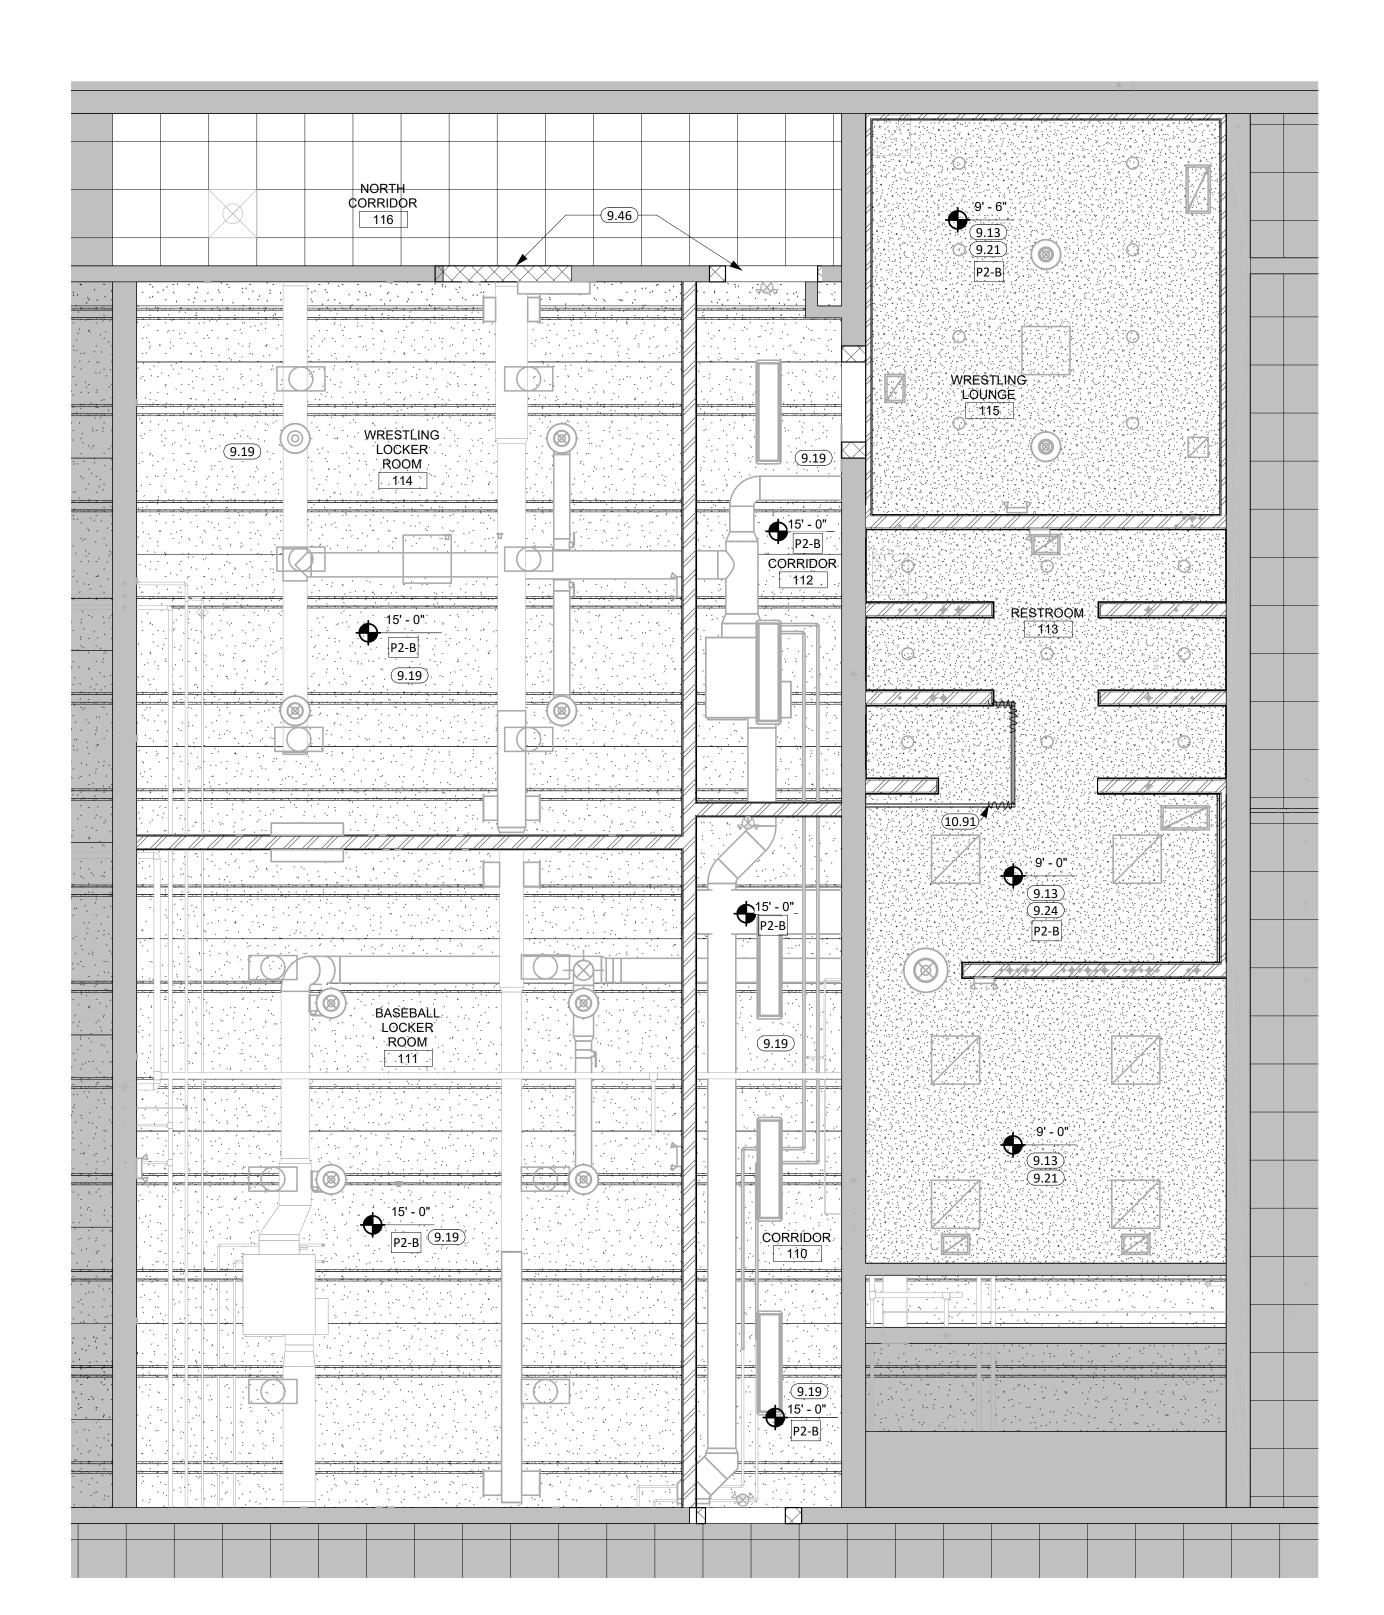


PROJECT: BARNETT CENTER, LOCKER ROOM REMODEL

NORTHERN STATE UNIVERSITY ABERDEEN, SOUTH DAKOTA

SHEET TITLE:

TRACK & FIELD REFLECTED CEILING PLAN

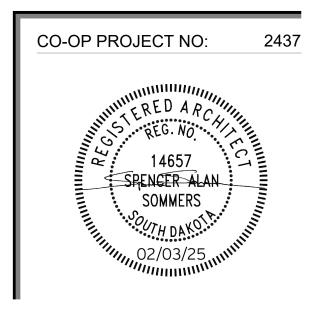

WRESTLING & BASEBALL REFLECTED CEILING PLAN

1/4" = 1'-0"



GENERAL NOTES

- 1. SEE SHEET **G000** FOR REQUIRED ADA CLEARANCES & MOUNTING HEIGHTS.
- SEE DRAWING SHEET <u>A601</u> FOR ROOM FINISH SCHEDULE.
 SEE MECHANICAL, AND ELECTRICAL FOR ADDITIONAL INFORMATION AND COORDINATION.
- 4. ALL WALLS EXTEND TO DECK UNLESS OTHERWISE NOTED ON WALL TYPES. STUD WALLS TO UTILIZE SLIP TRACKS WHEN ATTACHING TO PRECAST DECK.
- WALLS TO UTILIZE SLIP TRACKS WHEN ATTACHING TO PRECAST DECK.


 5. ALL DIMENSIONS ARE FROM FACE CMU/GWB TO FACE OF CMU/GWB U.N.O.
- INTERIOR WALL FINISHES ARE FULL HEIGHT, U.N.O.
 COORDINATE ALL CHASE SIZES AND LOCATIONS W/ MECHANICAL. PROVIDE CHASES AT ALL EXPOSED MECHANICAL & ELECTRICAL WITH ADJACENT WALL MATERIAL AS
- 8. SEE FLOOR PLAN(S) AND INTERIOR ELEVATIONS FOR CASEWORK INFORMATION. FIELD VERIFY DIMENSIONS OF CASEWORK OPENINGS.
- 9. PROVIDE COUNTERTOP SUPPORTS AT OPEN SPACES AT MINIMUM OF 32" ON CENTER AND MAXIMUM OF 36" ON CENTER.
- 10. COORDINATE PENETRATIONS AT COUNTERTOPS W/MECHANICAL AND ELECTRICAL.11. MILLWORK SUPPLIER SHALL PROVIDE FILLER PANELS AND SCRIBE STRIPS AS
- NEEDED FOR COMPLETE INSTALLATION.

 12. PROVIDE FINISHED END ALL PANELS AT EXPOSED MILLWORK SURFACES.
- 13. CAULK PERIMETER OF TOILETS, URINALS, SINKS AND COUNTERTOPS AS REQUIRED.
 14. COORDINATE INSTALLATION OF OWNER PROVIDED EQUIPMENT WITH NEW
- CONSTRUCTION.
- 15. USE SCHLUTER DITRA UNDERLAYMENT UNDER ALL FLOOR TILE.16. PROVIDE WATER-RESISTANT GYPSUM BOARD PANELS AT ALL BATHROOM WALLS,
- CEILINGS. AND ANY WALLS EXPOSED TO MOISTURE.

 17. PREP ALL EXISTING WALLS AS REQUIRED FOR PROPER ADHESION OF NEW WALL
- 18. PATCH RESILIENT WALL BASE AS REQUIRED AT ALL INFILLED OPENINGS AT ALL LOCATIONS. MATCH EXISTING.
- CONTRACTOR TO VERIFY ALL EXISTING CONDITIONS, ELEVATIONS, AND DIMENSIONS.
 CUT, CLEAN, & PATCH ALL EXISTING WALLS AND CEILINGS AFFECTED BY DEMOLITION AND AS REQUIRED FOR NEW OR RELOCATED PLUMBING, HVAC OR ELECTRICAL. RESTORE WALL/CEILING SURFACE TO MATCH EXISTING CONDITIONS. (TYP)
- 21. ALL WORK SHALL BE IN ACCORDANCE WITH OSHA CODES AND STANDARDS.

 NOTHING INDICATED ON THESE DRAWINGS SHALL RELIEVE THE CONTRACTOR FROM COMPLYING WITH ANY APPROPRIATE SAFETY REGULATIONS.
- 22. DRILL/EPOXY HORIZONTAL REINFORCEMENT 6" INTO EXISTING WALL AT ALL LOCATIONS WHERE NEW CMU WALL RUNS INTO EXISTING CMU. PROVIDE BULLNOSE CORNERS AT ALL CMU OPENINGS.

	KEYNOTE SCHEDULE							
9.13	1 1/2" CARRYING CHANNEL							
9.19	EXISTING EXPOSED STRUCTURE PAINTED WITH P-2A							
9.21	5/8" GYPSUM BOARD							
9.24	5/8" MOISTURE RESISTANT GYPSUM BOARD							
9.46	MODIFY EXISTING ACT AS NEEDED FOR NEW CONSTRUCTION. REMOVE & REINSTALL TILES WHERE NEEDED TO PREVENT DAMAGE DURING CONSTRUCTION. SALVAGE UNUSED TILES TO REPLACE ANY TILES DAMAGED FROM CONSTRUCTION.							
10.91	CEILING MOUNTED CUBICLE CURTAIN, TRACK, & HOOKS							

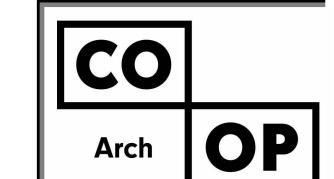


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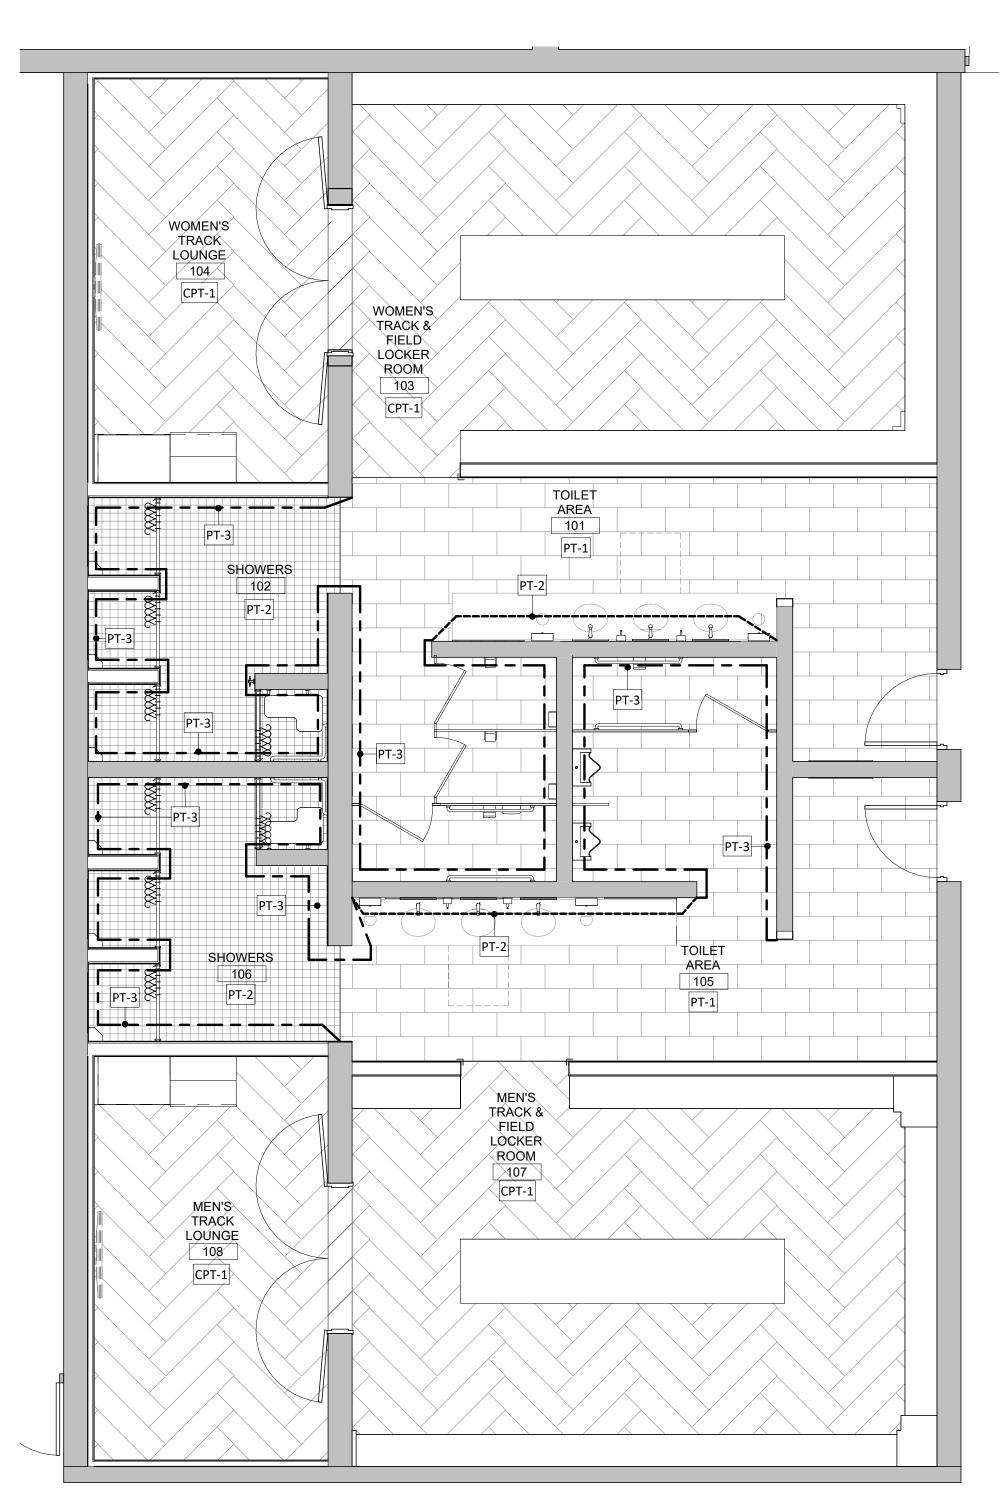
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PROJECT:
BARNETT CENTER,
LOCKER ROOM REMODEL

NORTHERN STATE UNIVERSITY ABERDEEN, SOUTH DAKOTA

SHEET TITLE:

WRESTLING & BASEBALL REFLECTED CEILING PLAN

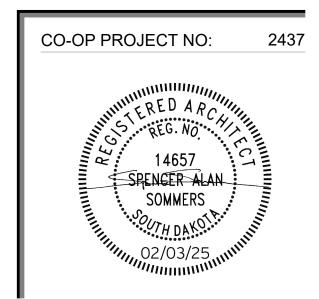

TRACK & FIELD

PARTIAL FINISH FLOOR PLAN



GENERAL NOTES


- SEE SHEET G000 FOR REQUIRED ADA CLEARANCES & MOUNTING HEIGHTS.
 SEE DRAWING SHEET A601 FOR ROOM FINISH SCHEDULE.
- 3. SEE MECHANICAL, AND ELECTRICAL FOR ADDITIONAL INFORMATION AND COORDINATION.
- ALL WALLS EXTEND TO DECK UNLESS OTHERWISE NOTED ON WALL TYPES. STUD WALLS TO UTILIZE SLIP TRACKS WHEN ATTACHING TO PRECAST DECK.
- 5. ALL DIMENSIONS ARE FROM FACE CMU/GWB TO FACE OF CMU/GWB U.N.O.6. INTERIOR WALL FINISHES ARE FULL HEIGHT, U.N.O.
- 7. COORDINATE ALL CHASE SIZES AND LOCATIONS W/ MECHANICAL. PROVIDE CHASES AT ALL EXPOSED MECHANICAL & ELECTRICAL WITH ADJACENT WALL MATERIAL AS REQUIRED.
 - 8. SEE FLOOR PLAN(S) AND INTERIOR ELEVATIONS FOR CASEWORK INFORMATION. FIELD VERIFY DIMENSIONS OF CASEWORK OPENINGS.
- 9. PROVIDE COUNTERTOP SUPPORTS AT OPEN SPACES AT MINIMUM OF 32" ON CENTER AND MAXIMUM OF 36" ON CENTER.
- COORDINATE PENETRATIONS AT COUNTERTOPS W/MECHANICAL AND ELECTRICAL.
 MILLWORK SUPPLIER SHALL PROVIDE FILLER PANELS AND SCRIBE STRIPS AS NEEDED FOR COMPLETE INSTALLATION.
- PROVIDE FINISHED END ALL PANELS AT EXPOSED MILLWORK SURFACES.
 CAULK PERIMETER OF TOILETS, URINALS, SINKS AND COUNTERTOPS AS REQUIRED.
- 14. COORDINATE INSTALLATION OF OWNER PROVIDED EQUIPMENT WITH NEW CONSTRUCTION.15. USE SCHLUTER DITRA UNDERLAYMENT UNDER ALL FLOOR TILE.
- 16. PROVIDE WATER-RESISTANT GYPSUM BOARD PANELS AT ALL BATHROOM WALLS, CEILINGS. AND ANY WALLS EXPOSED TO MOISTURE.
- 17. PREP ALL EXISTING WALLS AS REQUIRED FOR PROPER ADHESION OF NEW WALL TILE.
- 18. PATCH RESILIENT WALL BASE AS REQUIRED AT ALL INFILLED OPENINGS AT ALL LOCATIONS. MATCH EXISTING.

ALL WORK SHALL BE IN ACCORDANCE WITH OSHA CODES AND STANDARDS.

- CONTRACTOR TO VERIFY ALL EXISTING CONDITIONS, ELEVATIONS, AND DIMENSIONS.
 CUT, CLEAN, & PATCH ALL EXISTING WALLS AND CEILINGS AFFECTED BY DEMOLITION AND AS REQUIRED FOR NEW OR RELOCATED PLUMBING, HVAC OR ELECTRICAL. RESTORE WALL/CEILING SURFACE TO MATCH EXISTING CONDITIONS. (TYP)
- NOTHING INDICATED ON THESE DRAWINGS SHALL RELIEVE THE CONTRACTOR FROM COMPLYING WITH ANY APPROPRIATE SAFETY REGULATIONS.

 22. DRILL/EPOXY HORIZONTAL REINFORCEMENT 6" INTO EXISTING WALL AT ALL
- LOCATIONS WHERE NEW CMU WALL RUNS INTO EXISTING CMU. PROVIDE BULLNOSE CORNERS AT ALL CMU OPENINGS.

KEYNOTE SCHEDULE

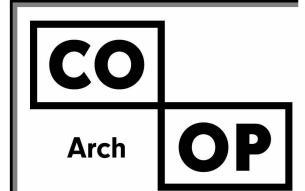


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OSE PROJECT NO: RO124--16X



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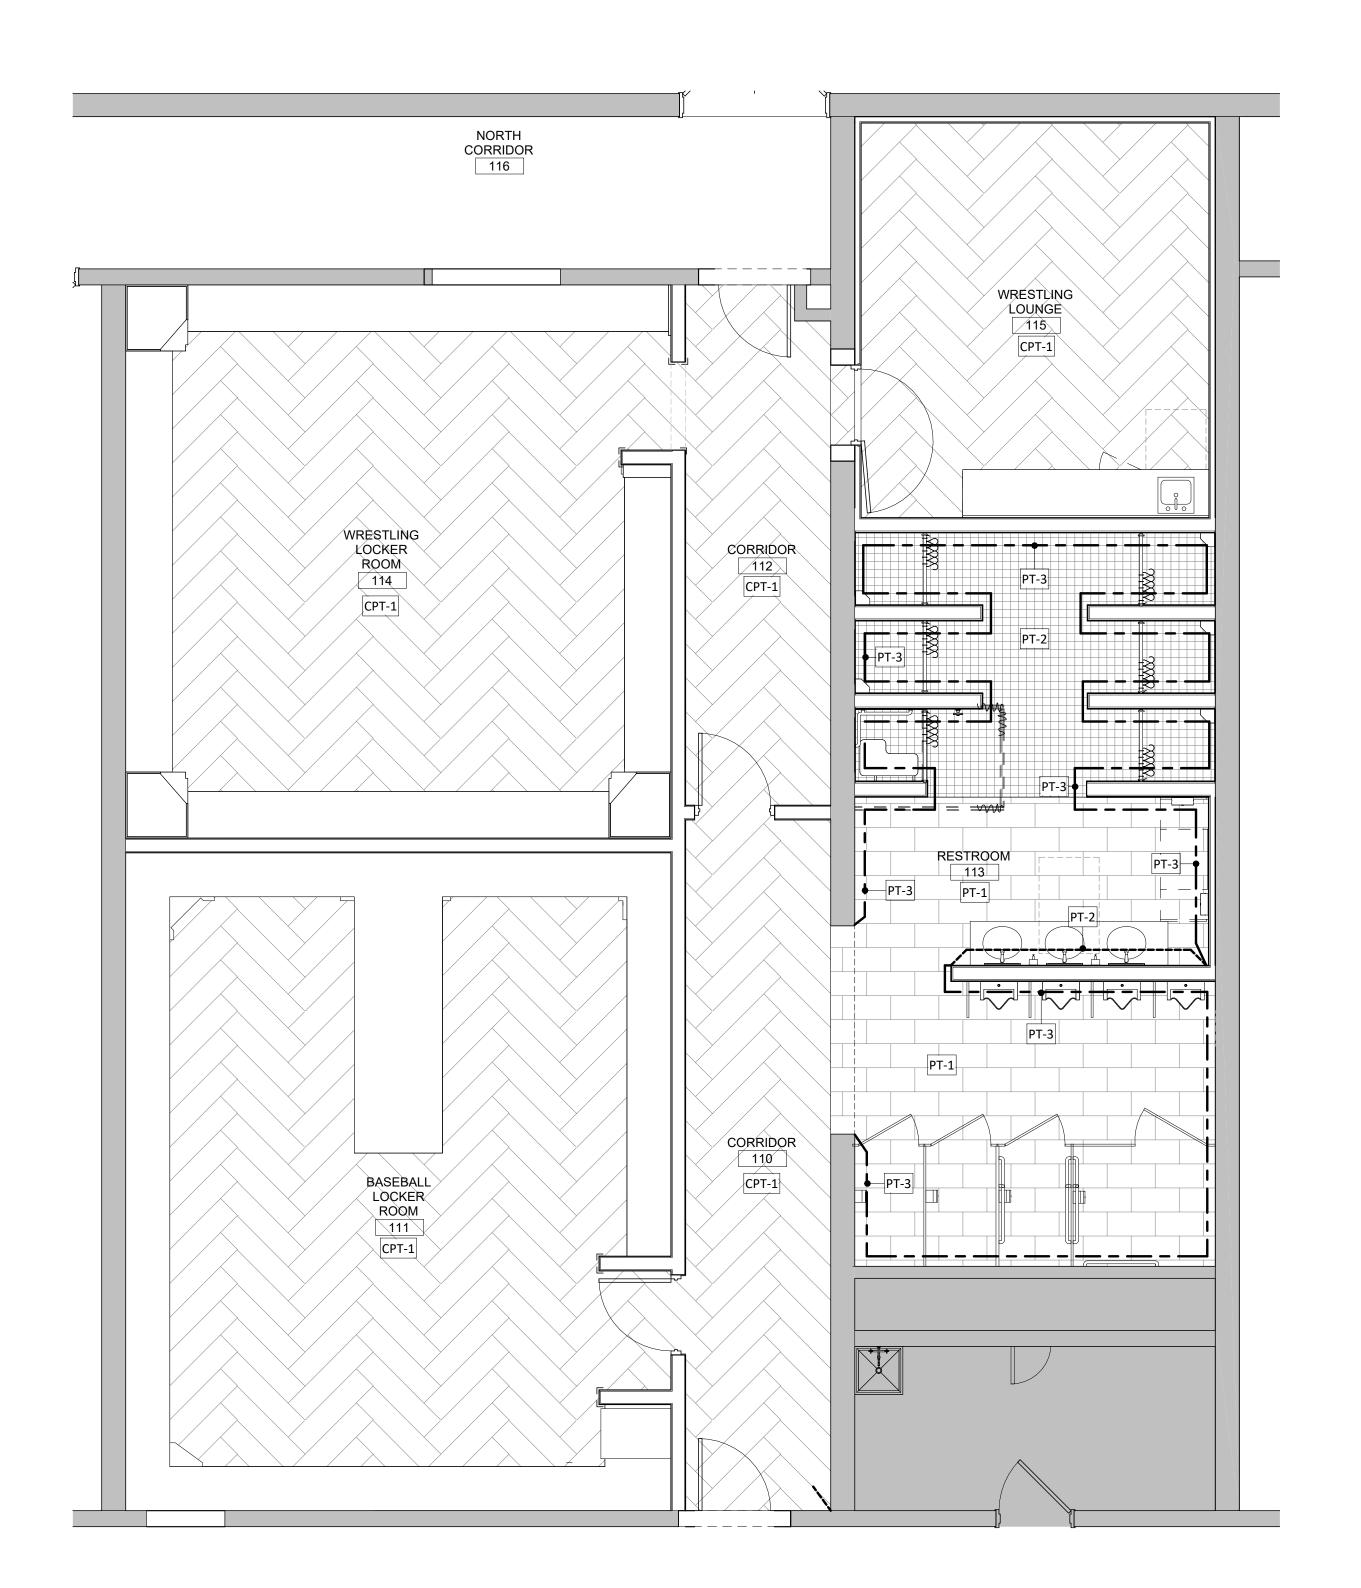
PROJECT:
BARNETT CENTER,
LOCKER ROOM REMODEL

NORTHERN STATE UNIVERSITY

ABERDEEN, SOUTH DAKOTA

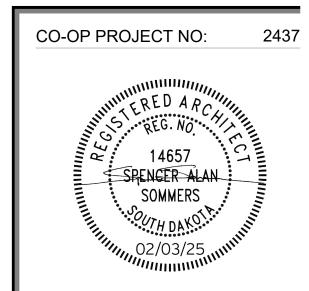SHEET TITLE:

TRACK & FIELD FLOOR FINISH




WRESTLING & BASEBALL PARTIAL FLOOR FINISH PLAN



GENERAL NOTES

- SEE SHEET **G000** FOR REQUIRED ADA CLEARANCES & MOUNTING HEIGHTS.
- SEE DRAWING SHEET <u>A601</u> FOR ROOM FINISH SCHEDULE. SEE MECHANICAL, AND ELECTRICAL FOR ADDITIONAL INFORMATION AND COORDINATION.
- ALL WALLS EXTEND TO DECK UNLESS OTHERWISE NOTED ON WALL TYPES. STUD
- WALLS TO UTILIZE SLIP TRACKS WHEN ATTACHING TO PRECAST DECK. ALL DIMENSIONS ARE FROM FACE CMU/GWB TO FACE OF CMU/GWB U.N.O.
- INTERIOR WALL FINISHES ARE FULL HEIGHT, U.N.O. COORDINATE ALL CHASE SIZES AND LOCATIONS W/ MECHANICAL. PROVIDE CHASES AT ALL EXPOSED MECHANICAL & ELECTRICAL WITH ADJACENT WALL MATERIAL AS
- SEE FLOOR PLAN(S) AND INTERIOR ELEVATIONS FOR CASEWORK INFORMATION. FIELD VERIFY DIMENSIONS OF CASEWORK OPENINGS.
- PROVIDE COUNTERTOP SUPPORTS AT OPEN SPACES AT MINIMUM OF 32" ON CENTER AND MAXIMUM OF 36" ON CENTER.
- 0. COORDINATE PENETRATIONS AT COUNTERTOPS W/MECHANICAL AND ELECTRICAL. 1. MILLWORK SUPPLIER SHALL PROVIDE FILLER PANELS AND SCRIBE STRIPS AS
- NEEDED FOR COMPLETE INSTALLATION. 12. PROVIDE FINISHED END ALL PANELS AT EXPOSED MILLWORK SURFACES.
- 13. CAULK PERIMETER OF TOILETS, URINALS, SINKS AND COUNTERTOPS AS REQUIRED. 14. COORDINATE INSTALLATION OF OWNER PROVIDED EQUIPMENT WITH NEW
- CONSTRUCTION.
- 15. USE SCHLUTER DITRA UNDERLAYMENT UNDER ALL FLOOR TILE. 16. PROVIDE WATER-RESISTANT GYPSUM BOARD PANELS AT ALL BATHROOM WALLS,
- CEILINGS. AND ANY WALLS EXPOSED TO MOISTURE. 17. PREP ALL EXISTING WALLS AS REQUIRED FOR PROPER ADHESION OF NEW WALL
- 18. PATCH RESILIENT WALL BASE AS REQUIRED AT ALL INFILLED OPENINGS AT ALL LOCATIONS. MATCH EXISTING.
- 19. CONTRACTOR TO VERIFY ALL EXISTING CONDITIONS, ELEVATIONS, AND DIMENSIONS. 20. CUT, CLEAN, & PATCH ALL EXISTING WALLS AND CEILINGS AFFECTED BY DEMOLITION AND AS REQUIRED FOR NEW OR RELOCATED PLUMBING, HVAC OR ELECTRICAL. RESTORE WALL/CEILING SURFACE TO MATCH EXISTING CONDITIONS. (TYP)
- 1. ALL WORK SHALL BE IN ACCORDANCE WITH OSHA CODES AND STANDARDS. NOTHING INDICATED ON THESE DRAWINGS SHALL RELIEVE THE CONTRACTOR FROM
- COMPLYING WITH ANY APPROPRIATE SAFETY REGULATIONS. 22. DRILL/EPOXY HORIZONTAL REINFORCEMENT 6" INTO EXISTING WALL AT ALL LOCATIONS WHERE NEW CMU WALL RUNS INTO EXISTING CMU. PROVIDE BULLNOSE CORNERS AT ALL CMU OPENINGS.

KEYNOTE SCHEDULE

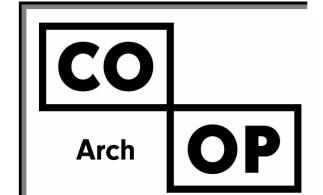


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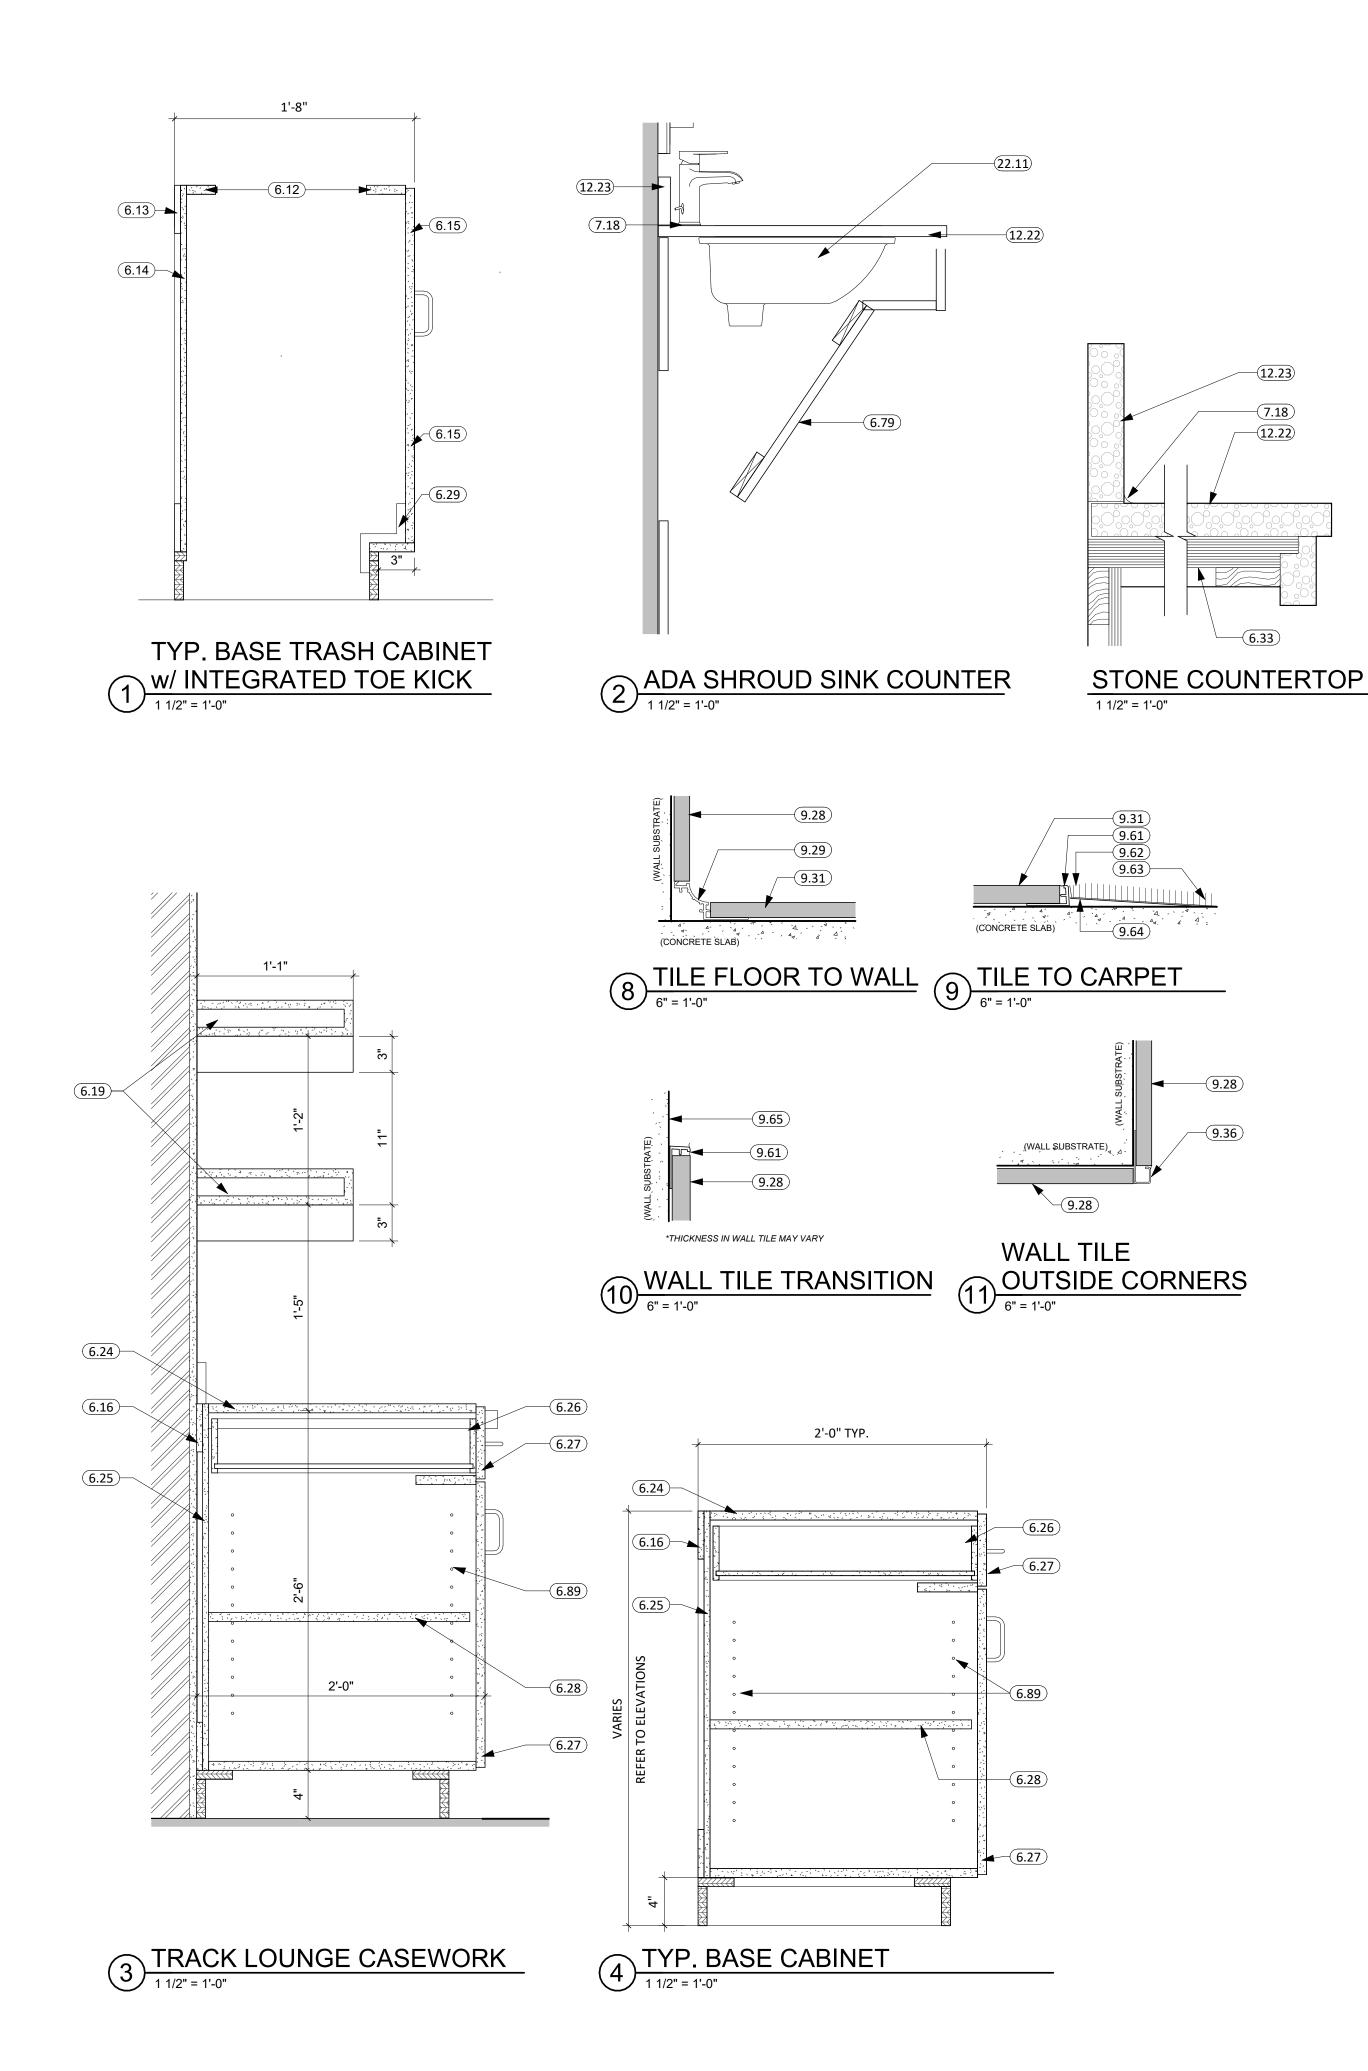
PROJECT:

BARNETT CENTER, LOCKER ROOM REMODEL

NORTHERN STATE UNIVERSITY ABERDEEN, SOUTH DAKOTA

SHEET TITLE:

WRESTLING & BASEBALL FLOOR FINISH PLAN

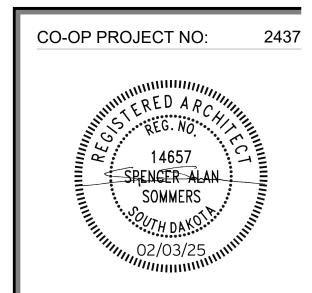


	KEYNOTE SCHEDULE
6.12	HEAVY TIMBER FRAMING
6.13	SOLID T&G WOOD DECKING
6.14	HEAVY DUTY CONCEALED FLOATING SHELF BRACKET
6.15	3/4" MELAMINE WITH PLASTIC LAMINATE FINISH
6.16	MELAMINE HANGER
6.19	FLOATING BOX SHELF WITH HIDDEN BRACKET, SPACING AS REQ'D (A&M HARDWARE)
6.24	3/4" MELAMINE TOP
6.25	1/2" MELAMINE BACK
6.26	MELAMINE DRAWER BOX WITH FULLY ENCLOSED BOTTOM
6.27	3/4" PARTICLE BOARD W/ PLASTIC LAMINATE EXTERIOR/INTERIOR
6.28	3/4" MELAMINE ADJUSTABLE SHELF
6.29	INTEGRATED TOE KICK BRACKET
6.33	3/4" PLYWOOD
6.79	REMOVABLE PLASTIC LAMINATE PLUMBING SHROUD
6.89	ADJUSTABLE SHELVING & BRACKETS
7.18	SEALANT AROUND PERIMETER
9.28	WALL TILE OR TILE BASE (SEE FINISH SCHEDULE)
9.29	SCHLUTER 'DILEX-AHK' (OR APPROVED EQUAL)
9.31	PORCELAIN TILE
9.36	SCHLUTER 'QUADEC' (OR APPROVED EQUAL)
9.61	SCHLUTER 'SCHIENE' (OR APPROVED EQUAL)
9.62	SCULPT CARPET EDGE
9.63	SCHEDULED CARPET (SEE FINISH SCHEDULE)
9.64	FLOAT FLOOR AS REQ'D FOR MAX TRANSITION HEIGHT OF 1/4"
9.65	PAINT AS DIRECTED IN FINISH SCHEDULE
12.22	SOLID SURFACE, QUARTZ, GRANITE, MARBLE, OR OTHER STONE COUNTERTOP ON THIN-SET BED
12.23	4" BACKSPLASH OF COUNTERTOP MATERIAL
22.11	LAVATORY

- . ALL WALLS EXTEND TO DECK UNLESS OTHERWISE NOTED ON WALL TYPES. . ALL DIMENSIONS ARE FROM FACE OF GWB TO FACE OF GWB U.N.O.
- INTERIOR WALL FINISHES ARE FULL HEIGHT, U.N.O. RESTROOM WALLS ARE SOUND INSULATED AND EXTEND TO THE DECK.
- SEE MECHANICAL FOR ALL FLOOR DRAIN SIZES AND LOCATIONS U.N.O. SET FLOOR DRAINS MINIMUM ¾" BELOW FINISHED FLOOR. PROVIDE EVEN SLOPE FROM WALL TO DRAIN W/ A MAXIMUM SLOPE OF 1/4" PER FOOT.
- VERIFY DRYWALL CONTROL JOINT LOCATIONS w/ ARCHITECT ON SITE PRIOR TO INSTALLATION. THIS INCLUDES, BUT IS NOT LIMITED TO, CONTROL JOINTS AT 30'-0" O.C. MAX. IN LONG WALL EXPANSES. CONTROL JOINTS AT DOOR JAMBS EXTENDING FROM DOOR HEAD TO CEILING. CONSIDERATION SHALL ALSO BE GIVEN TO LOCATING CONTROL JOINTS FROM FLOOR TO CEILING AT EITHER EDGE OF LARGE WINDOW
- SEE FLOOR PLAN FOR CASEWORK PLAN INFORMATION. FIELD VERIFY ALL CASEWORK OPENINGS. COORDINATE ALL CASEWORK DIMENSIONS WITH OWNER PROVIDED AND
- CONTRACTOR PROVIDED APPLIANCES/EQUIPMENT. COORDINATE DEVICE PENETRATIONS AT COUNTERTOPS W/ MECHANICAL & ELECTRICAL.
- PROVIDE COUNTERTOP SUPPORTS AT ALL OPEN SPACES AT MIN. OF 32" O.C. AND MAX. OF 48" O.C.
- 10. PROVIDE FINISHED END PANELS AT ALL EXPOSED MILLWORK SURFACES. 1. MILLWORK SUPPLIER SHALL PROVIDE FILLER PANELS & SCRIBE STRIPS AS NEEDED FOR COMPLETE INSTALLATION.
- 12. REVIEW ALL INTERIOR ELEVATION SHEETS FOR ACCESSORY AND EQUIPMENT INFORMATION.
- 13. PROVIDE 2x BLOCKING AT ALL GRAB BAR AND FUTURE GRAB BAR LOCATIONS. SEE CODE SHEETS FOR ADDITIONAL BLOCKING INFORMATION.
- 14. CAULK PERIMETER OF ALL TUB/SHOWER UNITS, TOILETS, URINALS, SINKS & COUNTERTOPS AS REQUIRED.
- 15. COORDINATE INSTALLATION OF OWNER PROVIDED EQUIPMENT WITH NEW CONSTRUCTION.
- 16. PROVIDE WATER-RESISTANT GYPSUM BOARD PANELS AT ALL BATHROOM WALLS AND ANY WALLS EXPOSED TO MOISTURE.
- 7. PROVIDE GLASS-MATTE FACED GYPSUM SHEATHING BEHIND TILE FINISHES AT ALL SHOWERS AND BATHTUBS.
- 18. REFER TO SHEET G001 FOR ALL ADA CODE STANDARDS. 19. GC TO CLEAN/PREP. AND PAINT ALL EXPOSED HVAC UNITS.

				FINISH LE	GEND				
		MANUFACTURER	REP CONTACT	STYLE	COLOR	SIZE	SPEC	INSTALL	NOTES
FLOORING (& IILING	Ġ							
CARPET	CPT- 1	J+J COMMERCIAL	DOMINICK HAMMER DOMINICK.HAMMER@JJFLOORING.COM	STORYLINE (3005)	DRAMA (7589)	12" X 48"	096813	HERRINGBONE	-
	PT-1	KATE-LO TILE	BRYCE BONET BRYCE@KATELOTILE.COM	CRAFT	QUILT	12" X 24"	093000	1/3 OFFSET	MAPEI GROUT COLOR: 107 IRON
CERAMIC & PORCELAIN	PT 2 KATE-LO TILE BRYCE BONET BRYCE@KATELOTILE.COM			CRAFT	QUILT BASKET WEAVE	2" X 2" MOSAIC	093000		MAPEI GROUT COLOR: 107 IRON
	PT-3	KATE-LO TILE	BRYCE BONET BRYCE@KATELOTILE.COM	CRAFT	COTTON	12" X 24"	093000	STACKED	MAPEI GROUT COLOR: 107 IRON
PAINT & WA	LL COV	/ERINGS							
	P-1	SHERWIN WILLIAMS	CHARLES J SCHONHARDT CHARLES.J.SCHONHARDT@SHERWIN.COM	PRE-CATALYZED WATERBASED EPOXY EG-SHEL (K45-2150 SERIES)	SNOWBOUND (SW7004)	-	099000	-	SHERWIN WILLIAMS COLOR - EGG SHELL FINIISH / P-1 BE PAINTED ON WALL AT 10'-0" AND BELOW - U.N.O.
PAINT	P-2A	SHERWIN WILLIAMS	CHARLES J SCHONHARDT CHARLES.J.SCHONHARDT@SHERWIN.COM	PRE-CATALYZED WATERBASED EPOXY EG-SHEL (K45-2150 SERIES)	TRICORN BLACK (SW6258)	-	099000	-	SHERWIN WILLIAMS COLOR - EGG SHELL FINIISH / P-2A BE PAINTED ON WALL AT 10'-0" AND ABOVE - U.N.O.
	P-2B	BENJAMIN MOORE		LATEX DRY FALL FLAT 395	TRICORN BLACK (SW6258)	-	099000	-	SHERWIN WILLIAMS COLOR - FLAT BLACK / P-2B TO PAI ALL EXPOSED DUCT WORK AND STRUCTURE AT 10'-0" A ABOVE / CLEAN ALL DUCT WORK PRIOR TO PAINTING
WALL BASE	, TRAN	SITIONS & MISC.	TRIMS						
VINYL COVE BASE	VB-1	VPI	GLORIA TOUTENHOOFD GMTOUTENHOOFD@VPICORP.COM	VINYL COVE BASE	GRAPHITE (35)	4" HIGH	096519	-	-
TILE BASE	TB-1	KATE-LO TILE	BRYCE BONET BRYCE@KATELOTILE.COM	CRAFT	QUILT	12" X 24"	093000	-	CUT 6" HIGH / ALIGN WITH WALL TILE
SCHLUTER		SCHLUTER SYSTEMS	KAYLA KEENAN KKEENAN@SCHLUTER.COM	ALL TRANSITIONS	ANODIZED ALUMINUM	-	093000	-	
MILLWORK									
LAMINATE	PL-1	FORMICA	JILL PELTIER JILL.PELTIER@WURTHBSC.COM	PLASTIC LAMINATE	RAW BIRCHPLY (8910)	-	061800	-	-
STONE & SOLID SURFACE	SS-1	FORMICA	JILL PELTIER JILL.PELTIER@WURTHBSC.COM	SOLID SURFACE	LUNA STORM (775)	-	123600	-	-
MISCELLAN	IEOUS								
PARTITIONS	TP-1	SCRANTON	MIKE BURKE MIKE.BURKE@AZEKCO.COM	HINYHINDERS	BLACK		102113.19	-	ORANGE PEEL FINISH
CORNER GAURDS	CG-1	INPRO	TODD THOMA - TTHOMA@INPROCORP.COM	HIGH IMPACT	BLACK	4'	102601	-	-

	ROOM FINISH SCHEDULE								
RM#	NAME	FLR FIN.	BASE FIN.	WALL FIN.	CLG FIN.	NOTES			
101	TOILET AREA	PT-1	TB-1	PT-3 / PT-2 / P-1 / P-2A	P-2B	SEE ELEVATIONS FOR PAINT LOCATIONS			
102	SHOWERS	PT-1	TB-1	PT-3	P-1				
103	WOMEN'S TRACK & FIELD LOCKER ROOM	CPT-1	VB-1	P-1 / P-2A	P-2B	SEE ELEVATIONS FOR PAINT LOCATIONS			
104	WOMEN'S TRACK LOUNGE	CPT-1	VB-1	P-1	P-1				
105	TOILET AREA	PT-1	TB-1	PT-3 / PT-2 / P-1 / P-2A	P-2B				
106	SHOWERS	PT-1	TB-1	PT-3	P-1				
107	MEN'S TRACK & FIELD LOCKER ROOM	CPT-1	VB-1	P-1 / P-2A	P-2B	SEE ELEVATIONS FOR PAINT LOCATIONS			
108	MEN'S TRACK LOUNGE	CPT-1	VB-1	P-1	P-1				
110	CORRIDOR	CPT-1	VB-1	P-1 / P-2A	P-2B	SEE ELEVATIONS FOR PAINT LOCATIONS			
111	BASEBALL LOCKER ROOM	CPT-1	VB-1	P-1 / P-2A	P-2B	SEE ELEVATIONS FOR PAINT LOCATIONS			
112	CORRIDOR	CPT-1	VB-1	P-1 / P-2A	P-2B	SEE ELEVATIONS FOR PAINT LOCATIONS			
113	RESTROOM	PT-1	TB-1	PT-3 / PT-2 / P-1	P-1				
114	WRESTLING LOCKER ROOM	CPT-1	VB-1	P-1 / P-2A	P-2B	SEE ELEVATIONS FOR PAINT LOCATIONS			
115	WRESTLING LOUNGE	CPT-1	VB-1	P-1	P-1				
116	NORTH CORRIDOR					MATCH EXISTING			

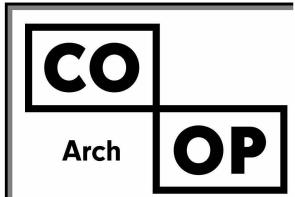

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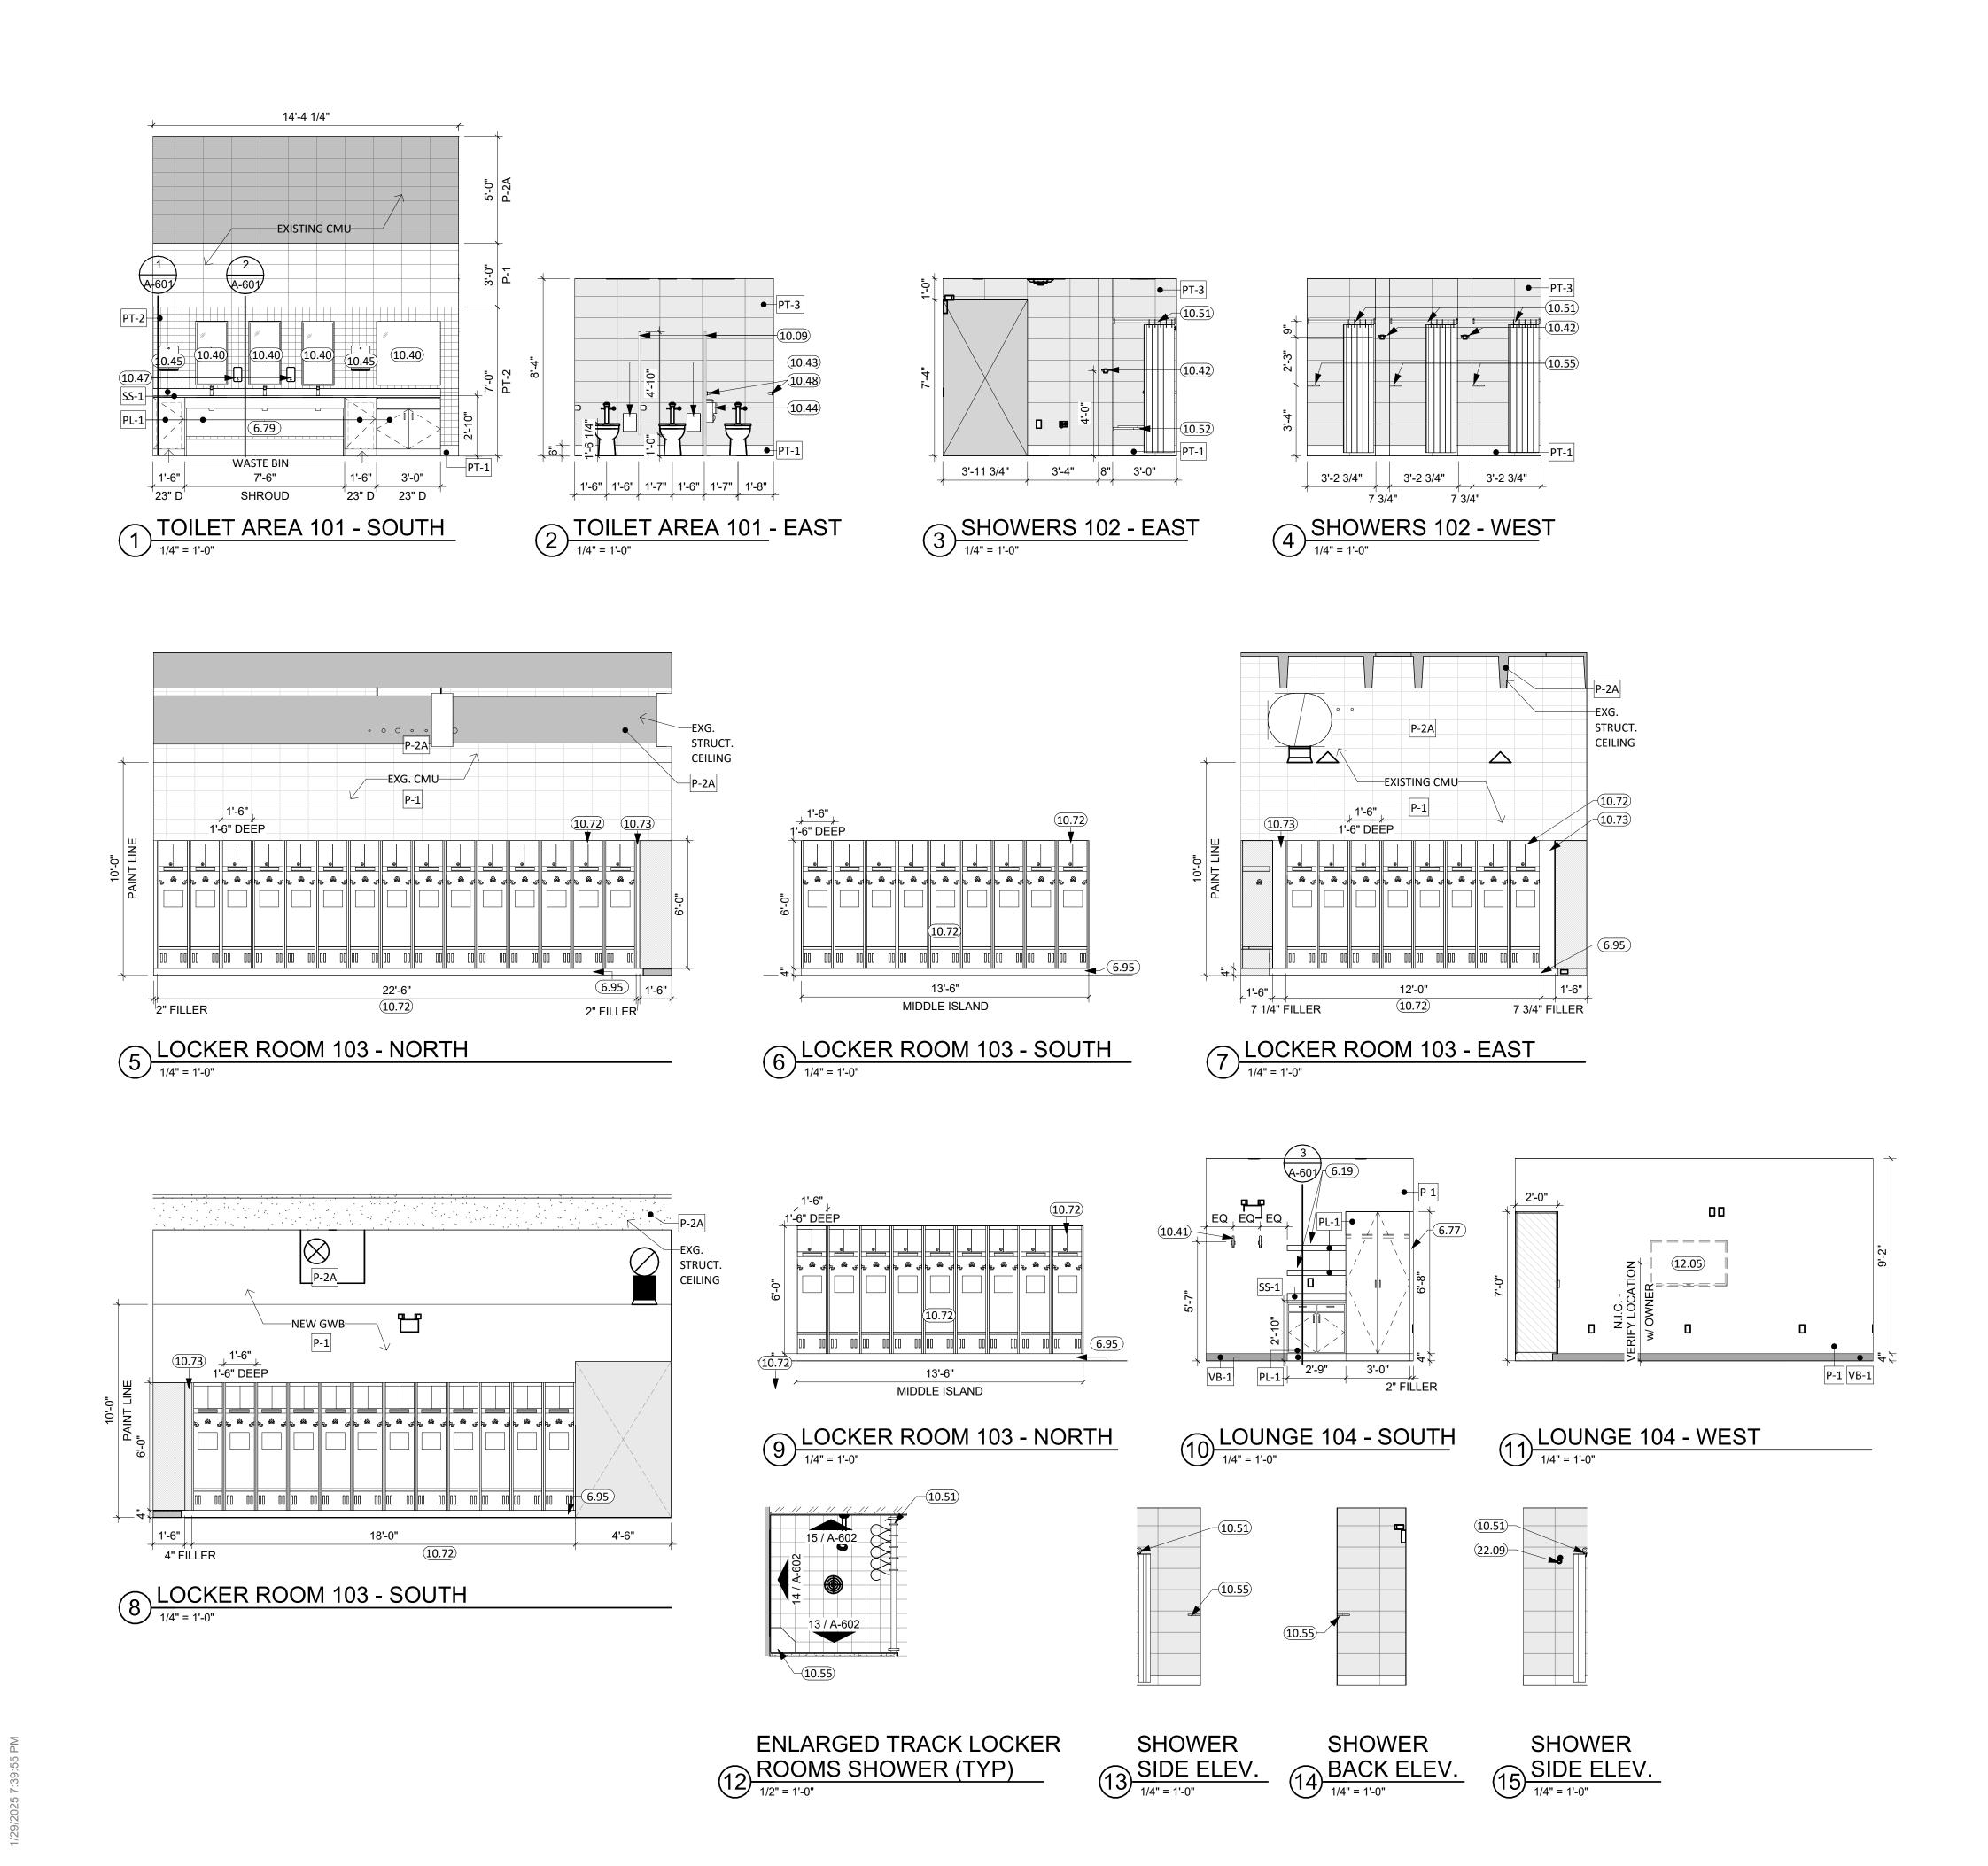
REV. # REV. DSC.

PROJECT: BARNETT CENTER, LOCKER ROOM REMODEL

NORTHERN STATE UNIVERSITY ABERDEEN, SOUTH DAKOTA

SHEET TITLE:

FINISH SCHEDULE & ROOM SCHEDULE



- ALL WALLS EXTEND TO DECK UNLESS OTHERWISE NOTED ON WALL TYPES. ALL DIMENSIONS ARE FROM FACE OF GWB TO FACE OF GWB U.N.O.
- INTERIOR WALL FINISHES ARE FULL HEIGHT, U.N.O.
- RESTROOM WALLS ARE SOUND INSULATED AND EXTEND TO THE DECK. SEE MECHANICAL FOR ALL FLOOR DRAIN SIZES AND LOCATIONS U.N.O. SET FLOOR DRAINS MINIMUM 3/4" BELOW FINISHED FLOOR. PROVIDE EVEN SLOPE FROM WALL
- TO DRAIN W/ A MAXIMUM SLOPE OF 1/4" PER FOOT. VERIFY DRYWALL CONTROL JOINT LOCATIONS w/ ARCHITECT ON SITE PRIOR TO INSTALLATION. THIS INCLUDES, BUT IS NOT LIMITED TO, CONTROL JOINTS AT 30'-0" O.C. MAX. IN LONG WALL EXPANSES. CONTROL JOINTS AT DOOR JAMBS EXTENDING FROM DOOR HEAD TO CEILING. CONSIDERATION SHALL ALSO BE GIVEN TO LOCATING CONTROL JOINTS FROM FLOOR TO CEILING AT EITHER EDGE OF LARGE WINDOW
- SEE FLOOR PLAN FOR CASEWORK PLAN INFORMATION. FIELD VERIFY ALL CASEWORK OPENINGS. COORDINATE ALL CASEWORK DIMENSIONS WITH OWNER PROVIDED AND
- CONTRACTOR PROVIDED APPLIANCES/EQUIPMENT. COORDINATE DEVICE PENETRATIONS AT COUNTERTOPS W/ MECHANICAL &
- ELECTRICAL. PROVIDE COUNTERTOP SUPPORTS AT ALL OPEN SPACES AT MIN. OF 32 "O.C. AND MAX. OF 48" O.C.
- 0. PROVIDE FINISHED END PANELS AT ALL EXPOSED MILLWORK SURFACES. 1. MILLWORK SUPPLIER SHALL PROVIDE FILLER PANELS & SCRIBE STRIPS AS NEEDED
- FOR COMPLETE INSTALLATION. 2. REVIEW ALL INTERIOR ELEVATION SHEETS FOR ACCESSORY AND EQUIPMENT
- INFORMATION. 3. PROVIDE 2x BLOCKING AT ALL GRAB BAR AND FUTURE GRAB BAR LOCATIONS. SEE
- CODE SHEETS FOR ADDITIONAL BLOCKING INFORMATION. 4. CAULK PERIMETER OF ALL TUB/SHOWER UNITS, TOILETS, URINALS, SINKS &
- COUNTERTOPS AS REQUIRED. 5. COORDINATE INSTALLATION OF OWNER PROVIDED EQUIPMENT WITH NEW
- CONSTRUCTION. 16. PROVIDE WATER-RESISTANT GYPSUM BOARD PANELS AT ALL BATHROOM WALLS
- AND ANY WALLS EXPOSED TO MOISTURE. 7. PROVIDE GLASS-MATTE FACED GYPSUM SHEATHING BEHIND TILE FINISHES AT ALL
- SHOWERS AND BATHTUBS. 18. REFER TO SHEET G001 FOR ALL ADA CODE STANDARDS.

19. GC TO CLEAN/PREP. AND PAINT ALL EXPOSED HVAC UNITS.

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	KEYNOTE SCHEDULE
6.19	FLOATING BOX SHELF WITH HIDDEN BRACKET, SPACING AS REQ'D (A&M HARDWARE)
6.77	FILLER STRIP
6.79	REMOVABLE PLASTIC LAMINATE PLUMBING SHROUD
6.95	2x WOOD FRAME w/ 1/2" PLYWOOD TOP (ALL GREEN TREATED) - COVER W/VB
10.09	REINSTALL EXISTING TOILET PARTITIONS AND TOILET ROOM ACCESSORIES AFTER PROPOSED TILE WORK IS COMPLETED.
10.40	MIRROR w/SS TRIM, BASIS OF DESIGN BOBRICK B-165
10.41	COAT HOOK
10.42	ROBE HOOK, BASIS OF DESIGN BOBRICK B-677
10.43	SANITARY NAPKIN DISPOSAL, (BASIS OF DESIGN BOBRICK B-254)-OP/CI
10.44	TOILET TISSUE DISPENSER, (BASIS OF DESIGN BOBRICK B-265) -OP/CI
10.45	PAPER TOWEL DISPENSER, (BASIS OF DESIGN BOBRICK B-262)-OWNER PROVIDED CONTRACTOR INSTALLED
10.47	SOAP DISPENSER, (BASIS OF DESIGN BOBRICK B-2111)-OWNER PROVIDED, CONTRACTOR INSTALLED
10.48	GRAB BAR
10.51	SHOWER ROD, CURTAIN, & HOOKS
10.52	SHOWER SEAT W/GRAB BARS - ADA
10.55	SCHLUTER SYSTEMS CORNER SHELF
10.72	ATHLETIC LOCKERS (SEE PROJECT MANUAL)
10.73	CORNER & FILLER PANELS TO MATCH NEARBY ATHLETIC LOCKERS (SIDES & TOP)
12.05	TELEVISION & MOUNTING HARDWARE BY OWNER - OUTLINE SHOWN FOR REFERENCE ONLY
22.09	SEE PLUMBING DRAWINGS AND PROJECT MANUAL FOR MORE INFORMATION

LOCKER FINISH/GENERAL NOTES (TRACK & FIELD)

- SINGLE TIER CUSTOM LOCKER 18"W x 18"D x 72"H 3/4" PRESSURE LAMINATE PANELS WITH 3MM EDGE BAND. GLUE AND DOWEL CONSTRUCTION. COLOR SELECTED FROM
- FOOT LOCKER MATERIAL TO BE SOLID COLOR CORE TO ALLOW FOR VENT HOLES TO BE DRILLED AND PROVIDE A FINISHED LOOK.
- LOCK BOX WITH 2-DIAL COMBINATION LOCK ON UPPER CUBBY NAME PLATE (2.25" x 8")
- FOOT LOCKER LIFT LID w/ CONCEALED HINGES & HASP LOCK, STORAGE BELOW 3 DOUBLE HOOKS (SATIN CHOME)
- LOGO GRAPHIC AT LOCKER BACK


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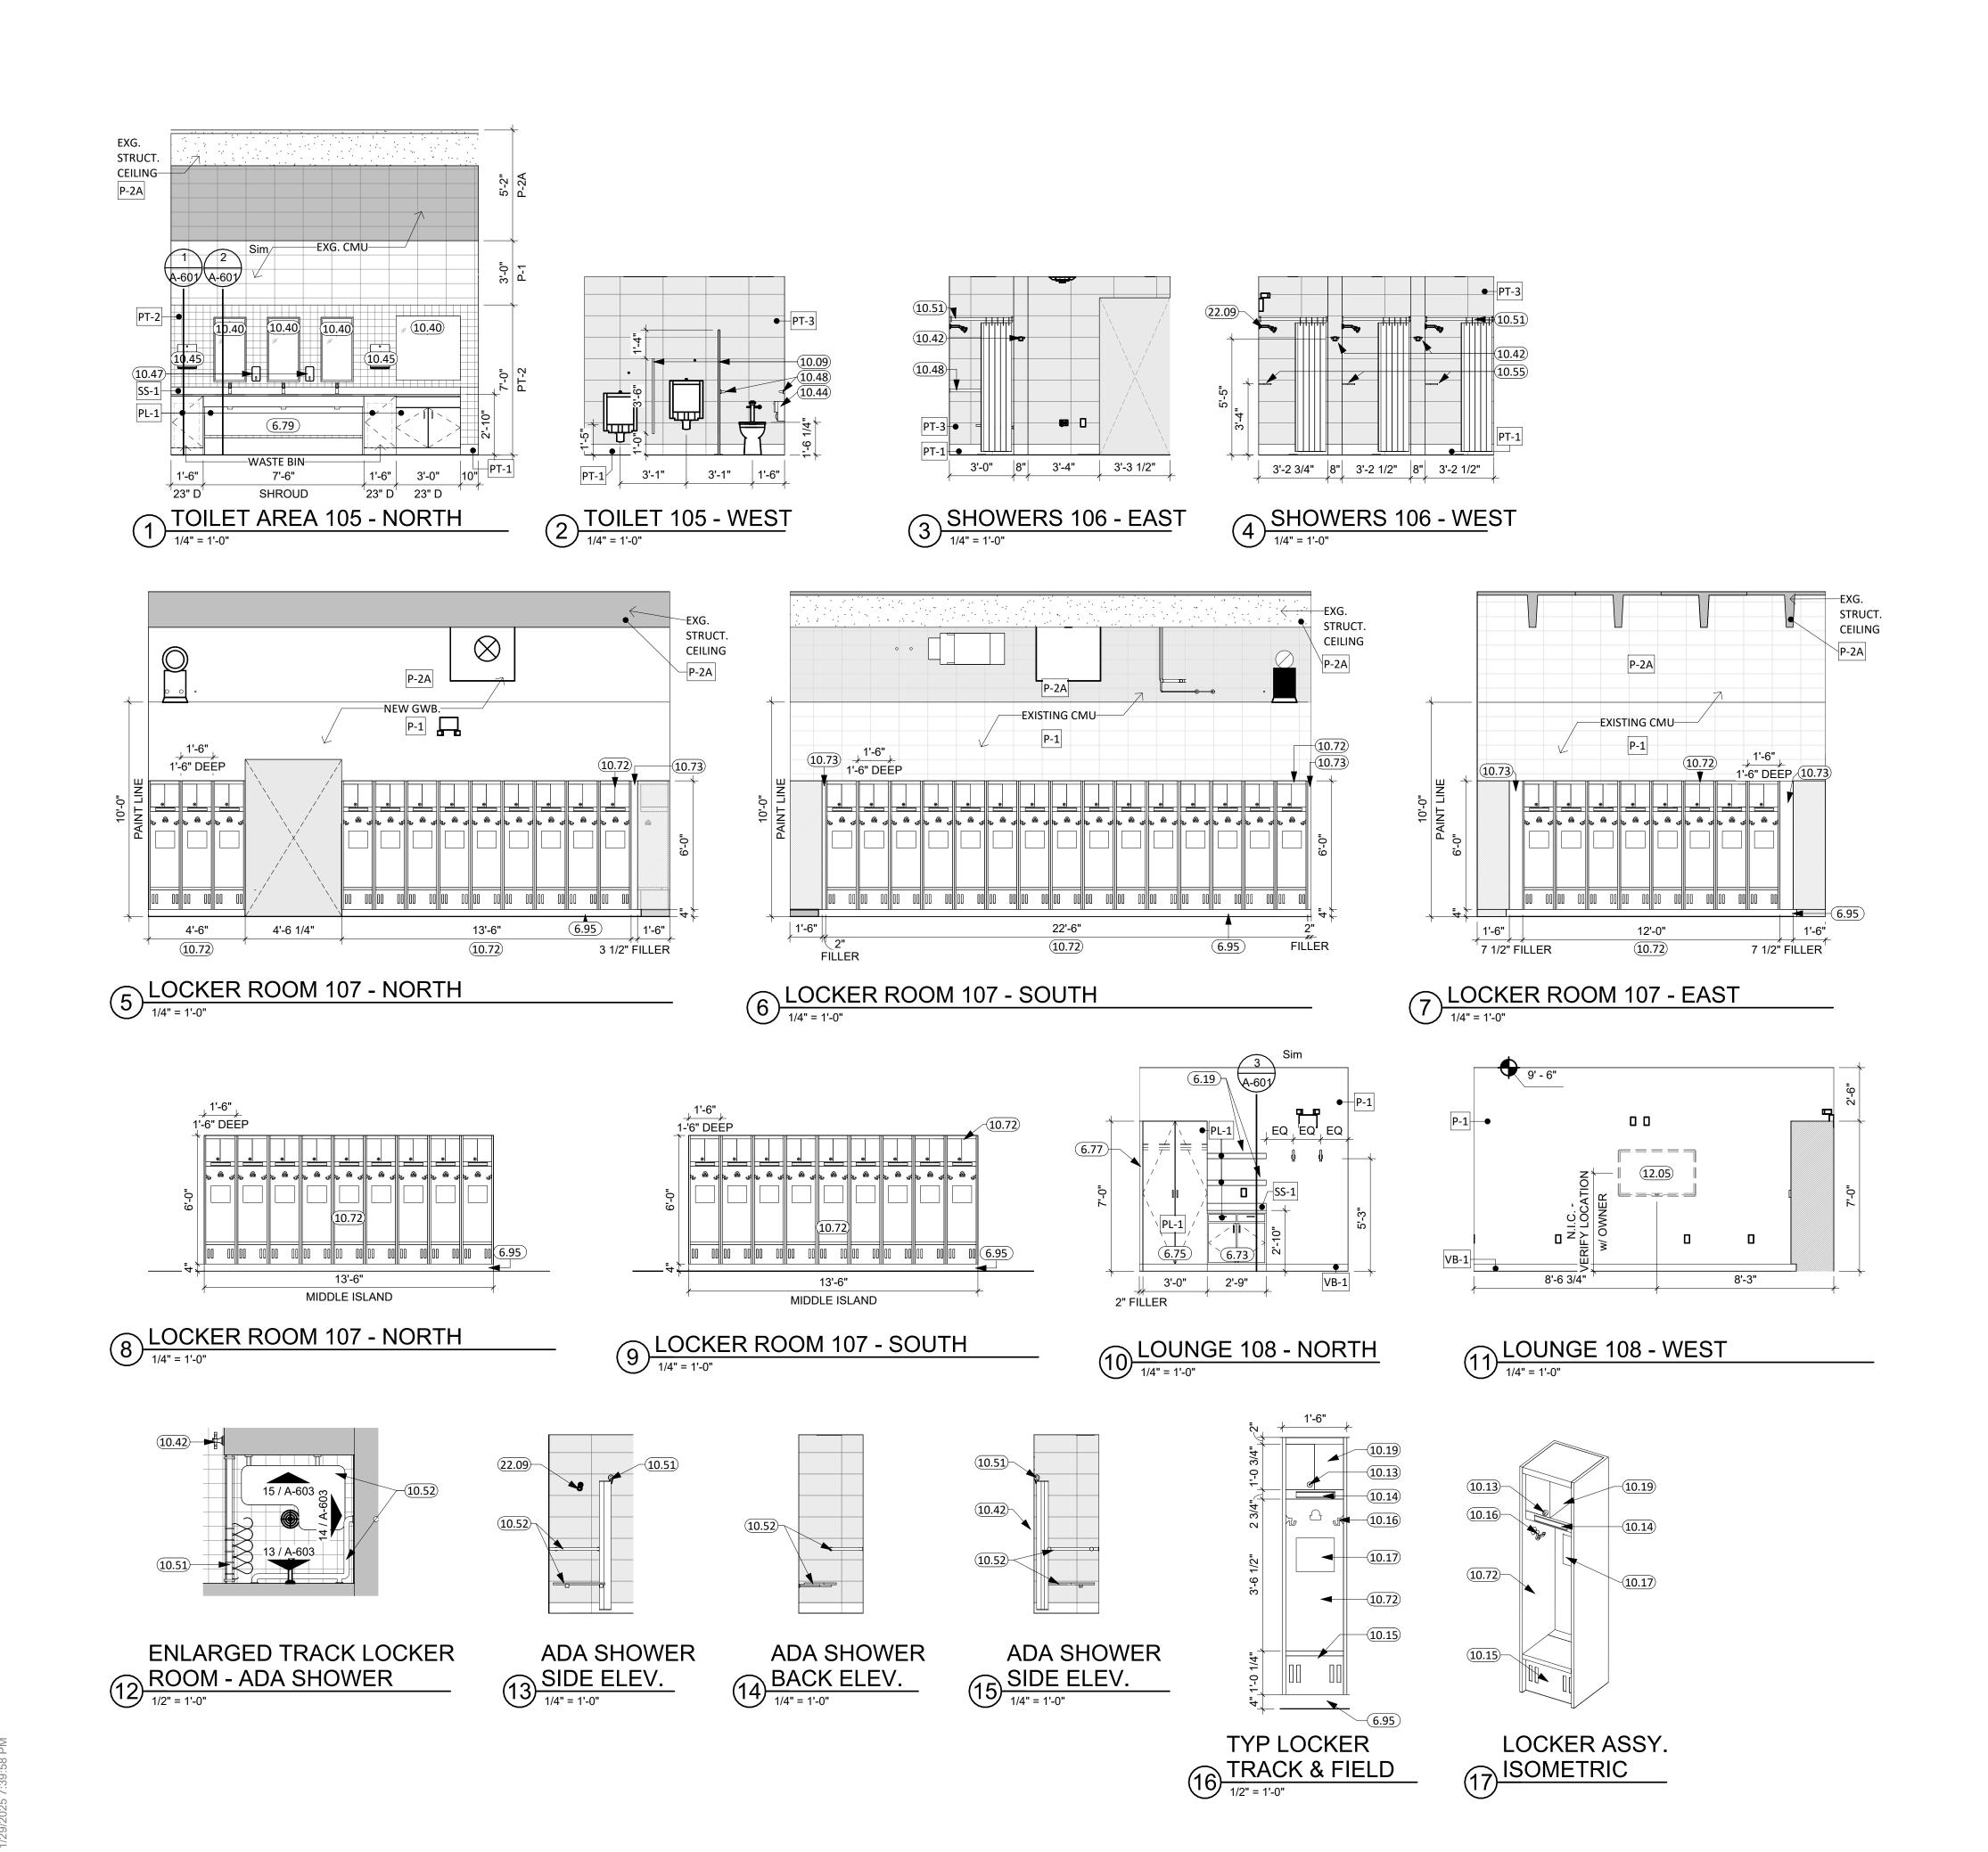
PROJECT: BARNETT CENTER,

NORTHERN STATE UNIVERSITY ABERDEEN, SOUTH DAKOTA

LOCKER ROOM REMODEL

SHEET TITLE: WOMEN'S TRACK & FIELD LOCKER ROOM INTERIOR

ELEVATIONS

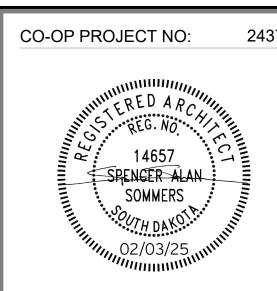

- ALL WALLS EXTEND TO DECK UNLESS OTHERWISE NOTED ON WALL TYPES. ALL DIMENSIONS ARE FROM FACE OF GWB TO FACE OF GWB U.N.O. INTERIOR WALL FINISHES ARE FULL HEIGHT, U.N.O.
- RESTROOM WALLS ARE SOUND INSULATED AND EXTEND TO THE DECK.
- SEE MECHANICAL FOR ALL FLOOR DRAIN SIZES AND LOCATIONS U.N.O. SET FLOOR DRAINS MINIMUM 3/4" BELOW FINISHED FLOOR. PROVIDE EVEN SLOPE FROM WALL TO DRAIN W/ A MAXIMUM SLOPE OF 1/4" PER FOOT.
- VERIFY DRYWALL CONTROL JOINT LOCATIONS w/ ARCHITECT ON SITE PRIOR TO INSTALLATION. THIS INCLUDES, BUT IS NOT LIMITED TO, CONTROL JOINTS AT 30'-0" O.C. MAX. IN LONG WALL EXPANSES. CONTROL JOINTS AT DOOR JAMBS EXTENDING FROM DOOR HEAD TO CEILING. CONSIDERATION SHALL ALSO BE GIVEN TO LOCATING CONTROL JOINTS FROM FLOOR TO CEILING AT EITHER EDGE OF LARGE WINDOW
- SEE FLOOR PLAN FOR CASEWORK PLAN INFORMATION. FIELD VERIFY ALL CASEWORK OPENINGS. COORDINATE ALL CASEWORK DIMENSIONS WITH OWNER PROVIDED AND CONTRACTOR PROVIDED APPLIANCES/EQUIPMENT.
- COORDINATE DEVICE PENETRATIONS AT COUNTERTOPS W/ MECHANICAL & ELECTRICAL.
- PROVIDE COUNTERTOP SUPPORTS AT ALL OPEN SPACES AT MIN. OF 32 "O.C. AND MAX. OF 48" O.C.
- 0. PROVIDE FINISHED END PANELS AT ALL EXPOSED MILLWORK SURFACES. 1. MILLWORK SUPPLIER SHALL PROVIDE FILLER PANELS & SCRIBE STRIPS AS NEEDED
- FOR COMPLETE INSTALLATION. 2. REVIEW ALL INTERIOR ELEVATION SHEETS FOR ACCESSORY AND EQUIPMENT
- INFORMATION. 3. PROVIDE 2x BLOCKING AT ALL GRAB BAR AND FUTURE GRAB BAR LOCATIONS. SEE
- CODE SHEETS FOR ADDITIONAL BLOCKING INFORMATION. 4. CAULK PERIMETER OF ALL TUB/SHOWER UNITS, TOILETS, URINALS, SINKS & COUNTERTOPS AS REQUIRED.
- 5. COORDINATE INSTALLATION OF OWNER PROVIDED EQUIPMENT WITH NEW
- CONSTRUCTION. 16. PROVIDE WATER-RESISTANT GYPSUM BOARD PANELS AT ALL BATHROOM WALLS
- AND ANY WALLS EXPOSED TO MOISTURE. 7. PROVIDE GLASS-MATTE FACED GYPSUM SHEATHING BEHIND TILE FINISHES AT ALL
- SHOWERS AND BATHTUBS. 18. REFER TO SHEET G001 FOR ALL ADA CODE STANDARDS.

19. GC TO CLEAN/PREP. AND PAINT ALL EXPOSED HVAC UNITS.

	KEYNOTE SCHEDULE								
6.19	FLOATING BOX SHELF WITH HIDDEN BRACKET, SPACING AS REQ'D (A&M HARDWARE)								
6.73	PLASTIC LAMINATE BASE CABINET								
6.75	PLASTIC LAMINATE TALL STORAGE CABINET								
6.77	FILLER STRIP								
6.79	REMOVABLE PLASTIC LAMINATE PLUMBING SHROUD								
6.95	2x WOOD FRAME w/ 1/2" PLYWOOD TOP (ALL GREEN TREATED) - COVER W/VB								
10.09	REINSTALL EXISTING TOILET PARTITIONS AND TOILET ROOM ACCESSORIES AFTER PROPOSED TILE WORK IS COMPLETED.								
10.13	LOCK BOX WITH 2-DIAL COMBINATION LOCK ON UPPER CUBBY								
10.14	NAME PLATE (2.25" x 8")								
10.15	VENTILATED FOOT LOCKER w/ LIFT LID								
10.16	3 DOUBLE HOOKS								
10.17	LOGO GRAPHIC AT LOCKER BACK								
10.19	OPEN CUBBY SHELF								
10.40	MIRROR w/SS TRIM, BASIS OF DESIGN BOBRICK B-165								
10.42	ROBE HOOK, BASIS OF DESIGN BOBRICK B-677								
10.44	TOILET TISSUE DISPENSER, (BASIS OF DESIGN BOBRICK B-265) -OP/CI								
10.45	PAPER TOWEL DISPENSER, (BASIS OF DESIGN BOBRICK B-262)-OWNER PROVIDED CONTRACTOR INSTALLED								
10.47	SOAP DISPENSER, (BASIS OF DESIGN BOBRICK B-2111)-OWNER PROVIDED,CONTRACTOR INSTALLED								
10.48	GRAB BAR								
10.51	SHOWER ROD, CURTAIN, & HOOKS								
10.52	SHOWER SEAT W/GRAB BARS - ADA								
10.55	SCHLUTER SYSTEMS CORNER SHELF								
10.72	ATHLETIC LOCKERS (SEE PROJECT MANUAL)								
10.73	CORNER & FILLER PANELS TO MATCH NEARBY ATHLETIC LOCKERS (SIDES & TOP)								
12.05	TELEVISION & MOUNTING HARDWARE BY OWNER - OUTLINE SHOWN FOR REFERENCE ONLY								
22.09	SEE PLUMBING DRAWINGS AND PROJECT MANUAL FOR MORE INFORMATION								

LOCKER FINISH/GENERAL NOTES (TRACK & FIELD)

- SINGLE TIER CUSTOM LOCKER 18"W x 18"D x 72"H 3/4" PRESSURE LAMINATE PANELS WITH 3MM EDGE BAND, GLUE AND DOWEL CONSTRUCTION, COLOR SELECTED FROM MFG STANDARDS.
- FOOT LOCKER MATERIAL TO BE SOLID COLOR CORE TO ALLOW FOR VENT HOLES TO BE DRILLED AND PROVIDE A FINISHED LOOK.
- LOCK BOX WITH 2-DIAL COMBINATION LOCK ON UPPER CUBBY
- NAME PLATE (2.25" x 8") FOOT LOCKER LIFT LID w/ CONCEALED HINGES & HASP LOCK, STORAGE BELOW
- 3 DOUBLE HOOKS (SATIN CHOME) LOGO GRAPHIC AT LOCKER BACK

PROJECT: BARNETT CENTER, LOCKER ROOM REMODEL


ISSUE:

NORTHERN STATE UNIVERSITY ABERDEEN, SOUTH DAKOTA

SHEET TITLE:

MEN'S TRACK & FIELD LOCKER ROOM INTERIOR ELEVATIONS

A-603

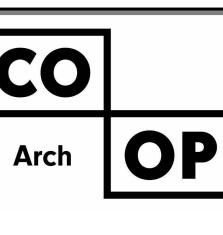

1108 S. Main St. 102 Aberdeen, SD 57401 Phone: 605-725-4852

1113 St Joseph Street Rapid City, SD 57701 Phone: 605-491-2485

300 N. Phillips Ave. 120 Sioux Falls, SD 57104 Phone: 605-334-9999

co-oparch.com

OSE PROJECT NO: RO124--16X

14657

SOMMERS

2/3/2025 100% CONSTRUCTION DOCUMENTS


REV. DSC.

REVISION SCHEDULE:

2437

REV. DATE

CO-OP PROJECT NO:

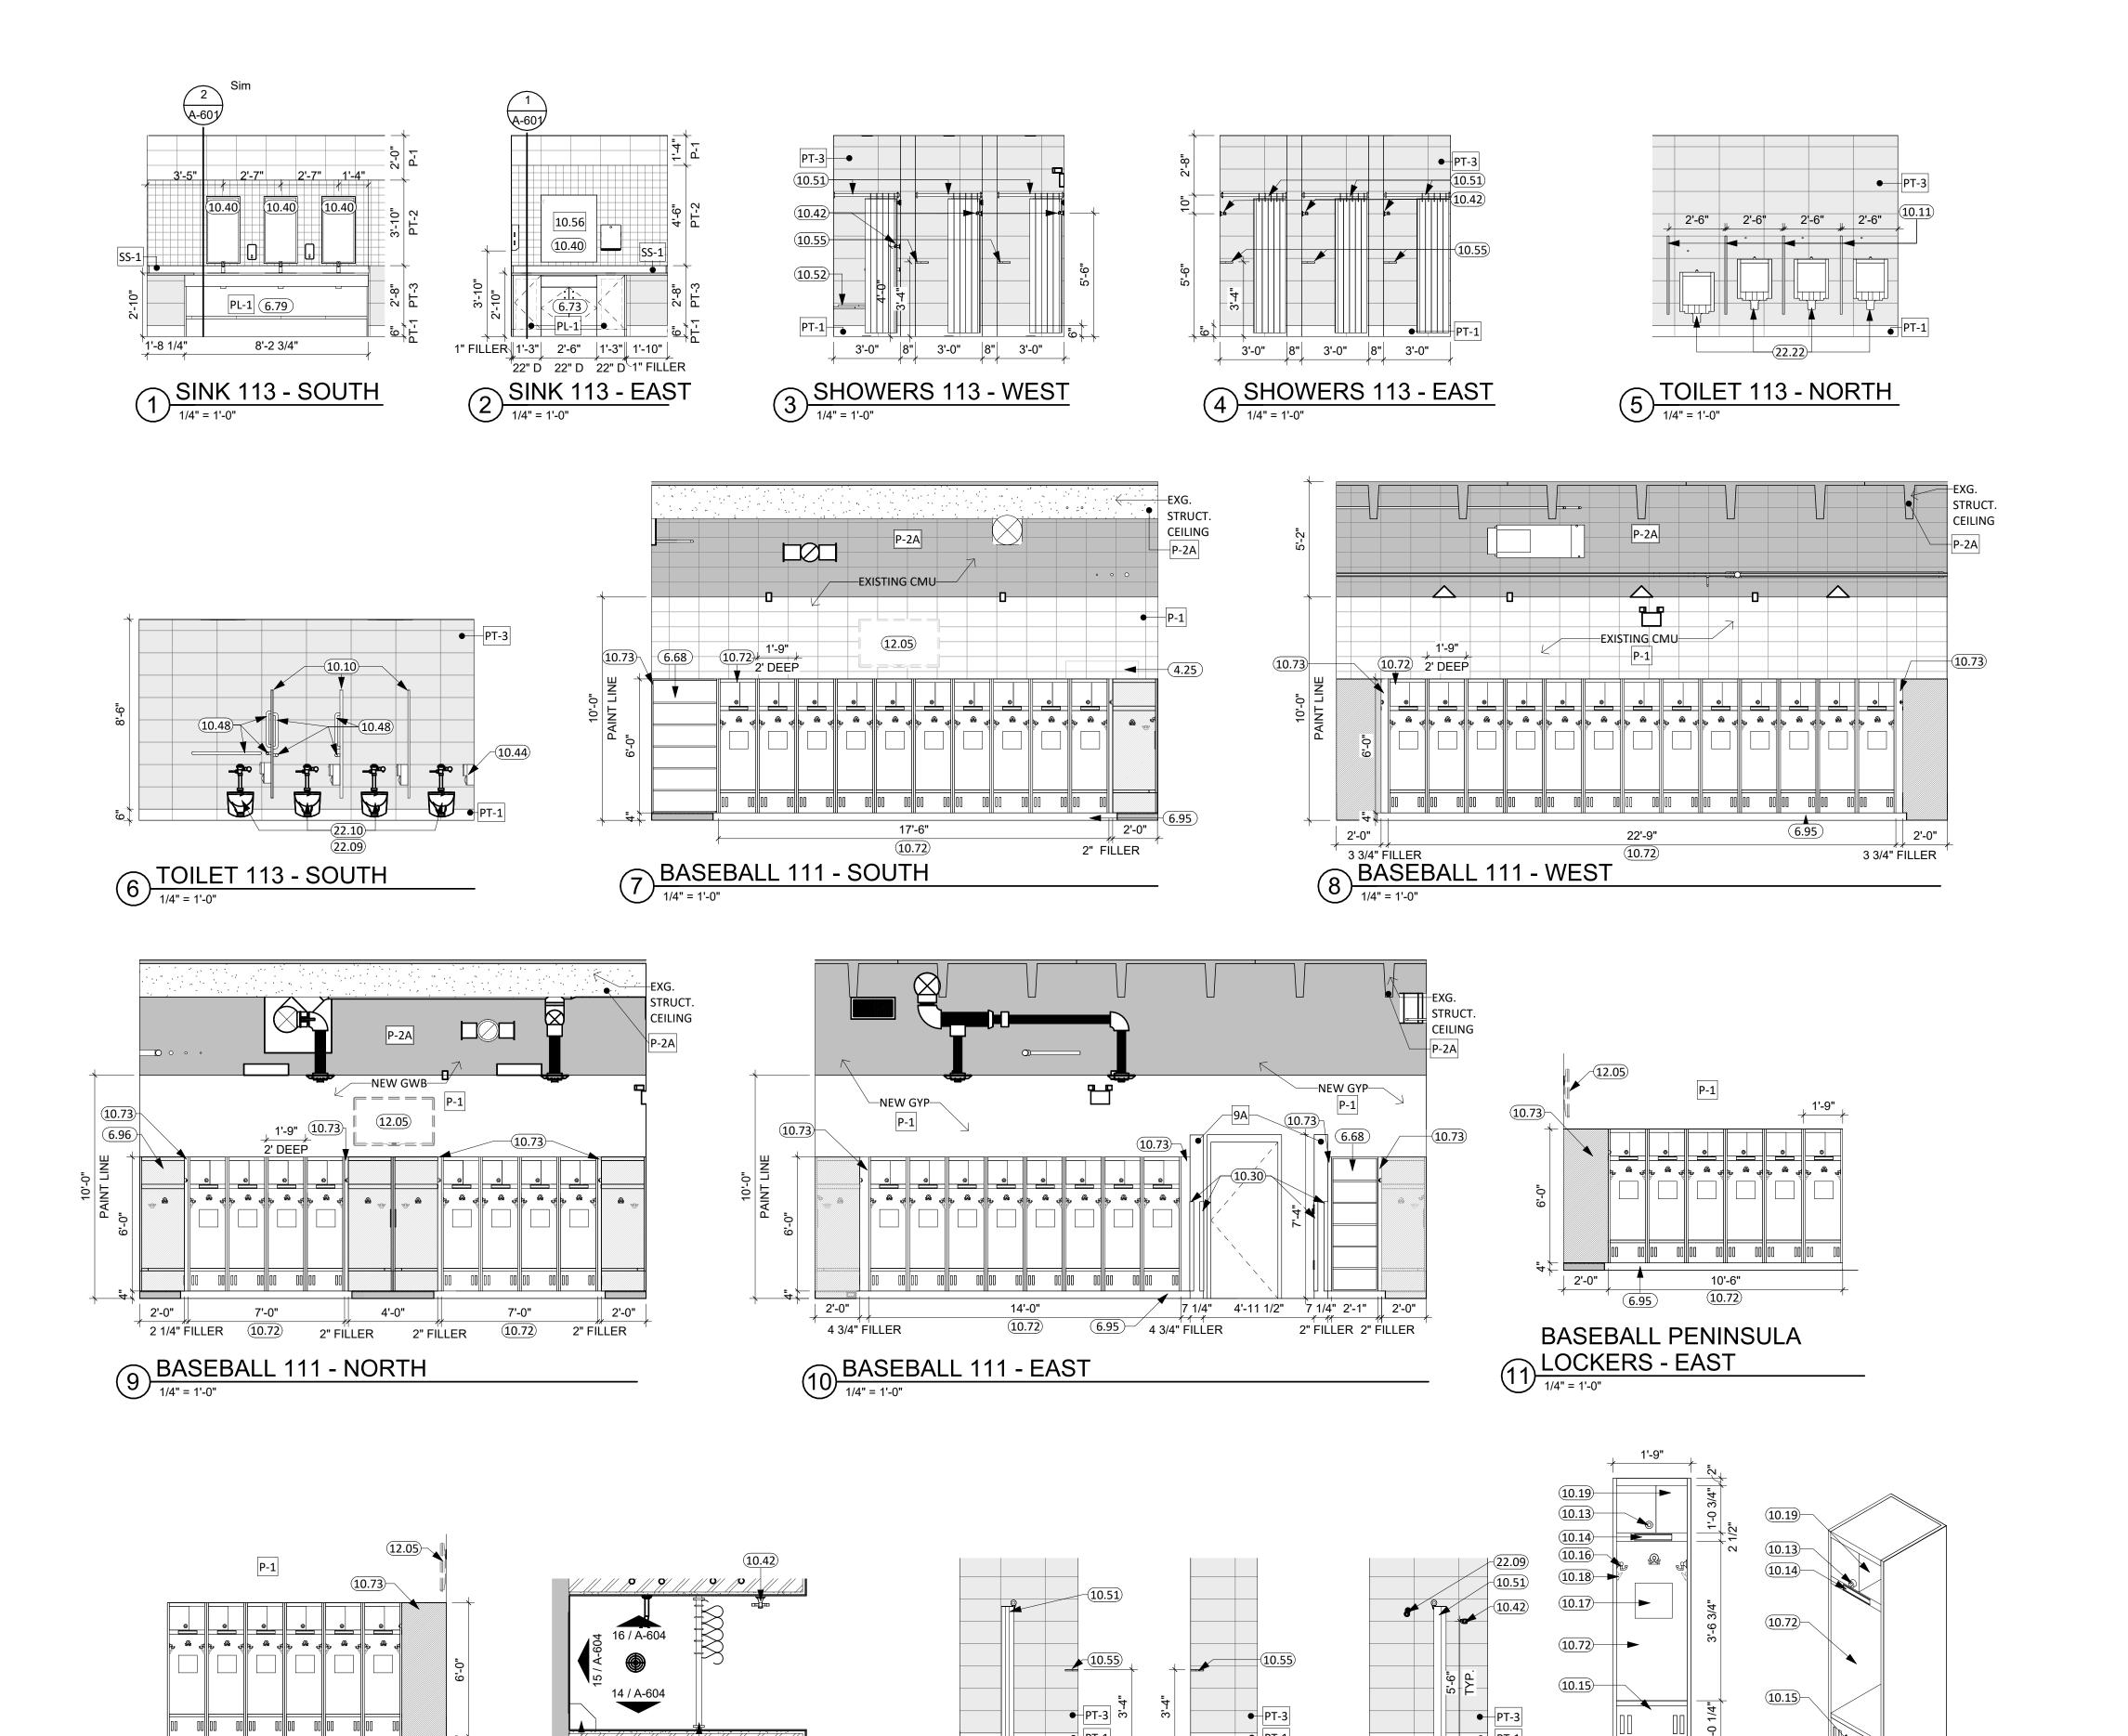

// /o // o/ // o/ o/ // // //

LOCKER ROOM TYP. SHOWER

ENLARGED WRESTLING/BASEBALL

2'-0"

BASEBALL PENNINSULA

LOCKERS - WEST

● PT-1

BACK ELEV. 16 SIDE ELEV.

SHOWER

SHOWER

● PT-1

SHOWER

6.95

BASEBALL LOCKER

BASEBALL

17 LOCKER (TYP)

0. PROVIDE FINISHED END PANELS AT ALL EXPOSED MILLWORK SURFACES Phone: 605-491-2485 . MILLWORK SUPPLIER SHALL PROVIDE FILLER PANELS & SCRIBE STRIPS AS NEEDED FOR COMPLETE INSTALLATION. 300 N. Phillips Ave. 120 2. REVIEW ALL INTERIOR ELEVATION SHEETS FOR ACCESSORY AND EQUIPMENT Sioux Falls, SD 57104 3. PROVIDE 2x BLOCKING AT ALL GRAB BAR AND FUTURE GRAB BAR LOCATIONS. SEE Phone: 605-334-9999 CODE SHEETS FOR ADDITIONAL BLOCKING INFORMATION. 4. CAULK PERIMETER OF ALL TUB/SHOWER UNITS, TOILETS, URINALS, SINKS & COUNTERTOPS AS REQUIRED. co-oparch.com 5. COORDINATE INSTALLATION OF OWNER PROVIDED EQUIPMENT WITH NEW 16. PROVIDE WATER-RESISTANT GYPSUM BOARD PANELS AT ALL BATHROOM WALLS AND ANY WALLS EXPOSED TO MOISTURE. 7. PROVIDE GLASS-MATTE FACED GYPSUM SHEATHING BEHIND TILE FINISHES AT ALL 18. REFER TO SHEET G001 FOR ALL ADA CODE STANDARDS. 19. GC TO CLEAN/PREP. AND PAINT ALL EXPOSED HVAC UNITS. KEYNOTE SCHEDULE PATCH EXISTING CMU WALL TO MATCH SURROUNDING AREA WHERE WALLS, FIXTURES, OR M.E.P. COMPONENTS HAVE BEEN REMOVED (TYP) CUSTOM WOOD SHELVING TO MATCH SURROUNDING ATHLETIC LOCKERS PLASTIC LAMINATE BASE CABINET REMOVABLE PLASTIC LAMINATE PLUMBING SHROUD 2x WOOD FRAME w/ 1/2" PLYWOOD TOP (ALL GREEN TREATED) - COVER W/VB NEW ATHLETIC LOCKERS (TYP) - SEE PROJECT MANUAL TOILET PARTITION, BASIS OF DESIGN SCRANTON HINY HIDERS URINAL SCREEN, BASIS OF DESIGN SCRANTON HINY HIDERS LOCK BOX WITH 2-DIAL COMBINATION LOCK ON UPPER CUBBY NAME PLATE (2.25" x 8") VENTILATED FOOT LOCKER w/ LIFT LID 3 DOUBLE HOOKS LOGO GRAPHIC AT LOCKER BACK OSE PROJECT NO: RO124--16X 2 BASEBALL BAT HOOKS **OPEN CUBBY SHELF** CO-OP PROJECT NO: MIRROR w/SS TRIM, BASIS OF DESIGN BOBRICK B-165 ROBE HOOK, BASIS OF DESIGN BOBRICK B-677 TOILET TISSUE DISPENSER, (BASIS OF DESIGN BOBRICK B-265) -OP/CI SHOWER ROD, CURTAIN, & HOOKS SHOWER SEAT W/GRAB BARS - ADA SCHLUTER SYSTEMS CORNER SHELF ATHLETIC LOCKERS (SEE PROJECT MANUAL) CORNER & FILLER PANELS TO MATCH NEARBY ATHLETIC LOCKERS (SIDES & TOP) TELEVISION & MOUNTING HARDWARE BY OWNER - OUTLINE SHOWN FOR

GENERAL NOTES

SEE MECHANICAL FOR ALL FLOOR DRAIN SIZES AND LOCATIONS U.N.O. SET FLOOR DRAINS MINIMUM 3/4" BELOW FINISHED FLOOR. PROVIDE EVEN SLOPE FROM WALL

VERIFY DRYWALL CONTROL JOINT LOCATIONS w/ ARCHITECT ON SITE PRIOR TO INSTALLATION. THIS INCLUDES, BUT IS NOT LIMITED TO, CONTROL JOINTS AT 30'-0" O.C. MAX. IN LONG WALL EXPANSES. CONTROL JOINTS AT DOOR JAMBS EXTENDING

CONTROL JOINTS FROM FLOOR TO CEILING AT EITHER EDGE OF LARGE WINDOW

COORDINATE DEVICE PENETRATIONS AT COUNTERTOPS W/ MECHANICAL &

FROM DOOR HEAD TO CEILING. CONSIDERATION SHALL ALSO BE GIVEN TO LOCATING

SEE FLOOR PLAN FOR CASEWORK PLAN INFORMATION. FIELD VERIFY ALL CASEWORK

OPENINGS. COORDINATE ALL CASEWORK DIMENSIONS WITH OWNER PROVIDED AND

PROVIDE COUNTERTOP SUPPORTS AT ALL OPEN SPACES AT MIN. OF 32 "O.C. AND

ALL WALLS EXTEND TO DECK UNLESS OTHERWISE NOTED ON WALL TYPES.

ALL DIMENSIONS ARE FROM FACE OF GWB TO FACE OF GWB U.N.O.

RESTROOM WALLS ARE SOUND INSULATED AND EXTEND TO THE DECK.

INTERIOR WALL FINISHES ARE FULL HEIGHT, U.N.O.

TO DRAIN W/ A MAXIMUM SLOPE OF 1/4" PER FOOT.

CONTRACTOR PROVIDED APPLIANCES/EQUIPMENT.

ELECTRICAL

MAX. OF 48" O.C.

INFORMATION.

CONSTRUCTION.

10.10

10.11

10.13

10.14

10.15

10.18

10.19

10.30

10.42

10.44

10.48

10.55

SHOWERS AND BATHTUBS.

CORNER GUARDS

REFERENCE ONLY

EXISTING URINAL TO REMAIN

BE DRILLED AND PROVIDE A FINISHED LOOK.

NAME PLATE (2.25" x 8")

LOGO GRAPHIC AT LOCKER BÁCK

LOCK BOX WITH 2-DIAL COMBINATION LOCK ON UPPER CUBBY

BAT HOLDERS (2 PER LOCKER), & 3 DOUBLE HOOKS (SATIN CHOME)

WATER CLOSET

SEE PLUMBING DRAWINGS AND PROJECT MANUAL FOR MORE INFORMATION

LOCKER FINISH/GENERAL NOTES

(BASEBALL)

SINGLE TIER CUSTOM LOCKER 21"W x 24"D x 72"H - 3/4" PRESSURE LAMINATE PANELS WITH 3MM EDGE BAND, GLUE AND DOWEL CONSTRUCTION, COLOR SELECTED FROM

FOOT LOCKER MATERIAL TO BE SOLID COLOR CORE TO ALLOW FOR VENT HOLES TO

FOOT LOCKER LIFT LID w/ CONCEALED HINGES & HASP LOCK, STORAGE BELOW

GRAB BAR

ISSUE: 2/3/2025 100% CONSTRUCTION DOCUMENTS

14657

SOMMERS

2437

1108 S. Main St. 102

Aberdeen, SD 57401

Phone: 605-725-4852

1113 St Joseph Street

Rapid City, SD 57701

REVISION SCHEDULE:

REV. # REV. DSC. REV. DATE


PROJECT:

BARNETT CENTER, LOCKER ROOM REMODEL

NORTHERN STATE UNIVERSITY ABERDEEN, SOUTH DAKOTA

SHEET TITLE:

BASEBALL LOCKER ROOM INTERIOR ELEVATIONS

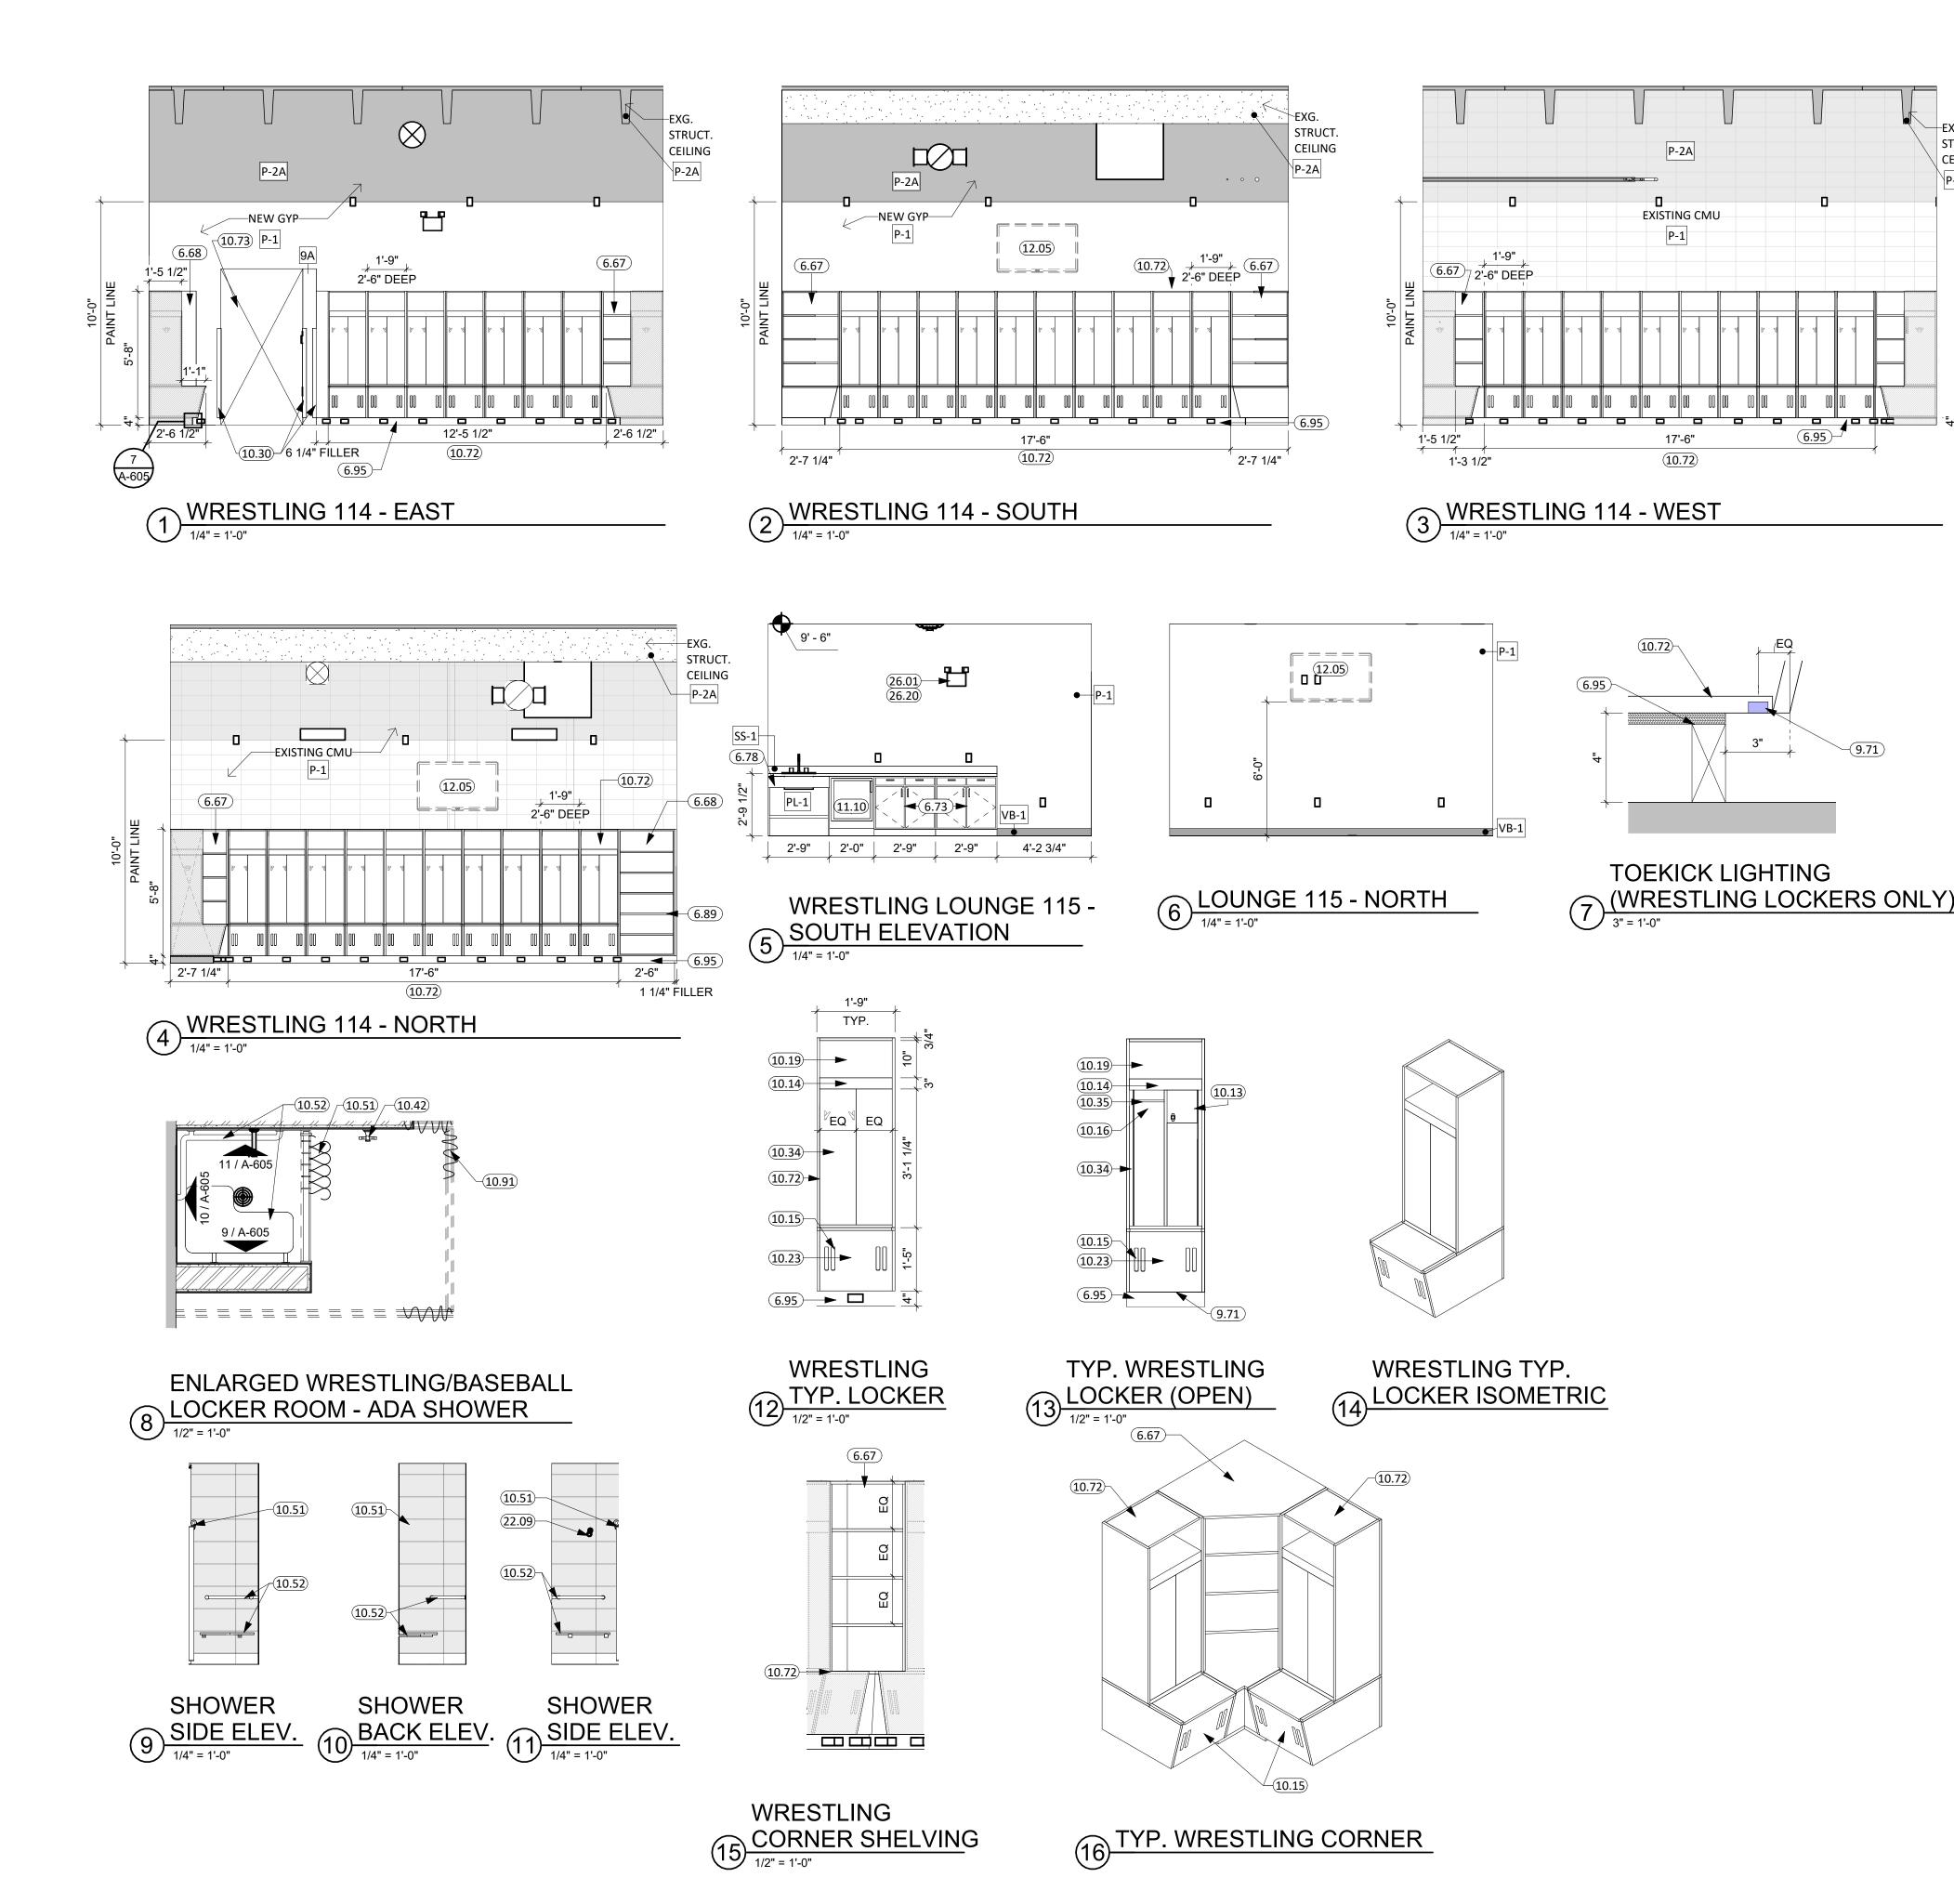

ALL WALLS EXTEND TO DECK UNLESS OTHERWISE NOTED ON WALL TYPES. ALL DIMENSIONS ARE FROM FACE OF GWB TO FACE OF GWB U.N.O. INTERIOR WALL FINISHES ARE FULL HEIGHT, U.N.O.

STRUCT.

CEILING

P-2A

- RESTROOM WALLS ARE SOUND INSULATED AND EXTEND TO THE DECK. SEE MECHANICAL FOR ALL FLOOR DRAIN SIZES AND LOCATIONS U.N.O. SET FLOOR
- DRAINS MINIMUM 3/4" BELOW FINISHED FLOOR. PROVIDE EVEN SLOPE FROM WALL TO DRAIN W/ A MAXIMUM SLOPE OF 1/4" PER FOOT.
- VERIFY DRYWALL CONTROL JOINT LOCATIONS w/ ARCHITECT ON SITE PRIOR TO INSTALLATION. THIS INCLUDES, BUT IS NOT LIMITED TO, CONTROL JOINTS AT 30'-0" O.C. MAX. IN LONG WALL EXPANSES. CONTROL JOINTS AT DOOR JAMBS EXTENDING FROM DOOR HEAD TO CEILING. CONSIDERATION SHALL ALSO BE GIVEN TO LOCATING CONTROL JOINTS FROM FLOOR TO CEILING AT EITHER EDGE OF LARGE WINDOW
- SEE FLOOR PLAN FOR CASEWORK PLAN INFORMATION. FIELD VERIFY ALL CASEWORK OPENINGS. COORDINATE ALL CASEWORK DIMENSIONS WITH OWNER PROVIDED AND
- CONTRACTOR PROVIDED APPLIANCES/EQUIPMENT. COORDINATE DEVICE PENETRATIONS AT COUNTERTOPS W/ MECHANICAL &
- PROVIDE COUNTERTOP SUPPORTS AT ALL OPEN SPACES AT MIN. OF 32 "O.C. AND MAX. OF 48" O.C.
- 0. PROVIDE FINISHED END PANELS AT ALL EXPOSED MILLWORK SURFACES. 1. MILLWORK SUPPLIER SHALL PROVIDE FILLER PANELS & SCRIBE STRIPS AS NEEDED
- FOR COMPLETE INSTALLATION. 2. REVIEW ALL INTERIOR ELEVATION SHEETS FOR ACCESSORY AND EQUIPMENT
- 13. PROVIDE 2x BLOCKING AT ALL GRAB BAR AND FUTURE GRAB BAR LOCATIONS. SEE CODE SHEETS FOR ADDITIONAL BLOCKING INFORMATION.
- 4. CAULK PERIMETER OF ALL TUB/SHOWER UNITS, TOILETS, URINALS, SINKS & COUNTERTOPS AS REQUIRED. 5. COORDINATE INSTALLATION OF OWNER PROVIDED EQUIPMENT WITH NEW
- CONSTRUCTION.
- 16. PROVIDE WATER-RESISTANT GYPSUM BOARD PANELS AT ALL BATHROOM WALLS
- AND ANY WALLS EXPOSED TO MOISTURE.
 7. PROVIDE GLASS-MATTE FACED GYPSUM SHEATHING BEHIND TILE FINISHES AT ALL SHOWERS AND BATHTUBS.
- 18. REFER TO SHEET G001 FOR ALL ADA CODE STANDARDS. 19. GC TO CLEAN/PREP. AND PAINT ALL EXPOSED HVAC UNITS.

ELECTRICAL.

KEYNOTE SCHEDULE
OM WOOD CORNER SHELVING TO MATCH SURROUN

6.67	CUSTOM WOOD CORNER SHELVING TO MATCH SURROUNDING ATHLETIC LOCKERS
6.68	CUSTOM WOOD SHELVING TO MATCH SURROUNDING ATHLETIC LOCKERS
6.73	PLASTIC LAMINATE BASE CABINET
6.78	PLASTIC LAMINATE REMOVABLE PANEL
6.89	ADJUSTABLE SHELVING & BRACKETS
6.95	2x WOOD FRAME w/ 1/2" PLYWOOD TOP (ALL GREEN TREATED) - COVER W/VB
9.71	1/2" DEEP x $7/8$ " WIDE CHANNEL UNDER FOOT LOCKER FOR LED DOWN LIGHTING (VERIFY FINAL SIZE WITH EC)
10.13	LOCK BOX WITH 2-DIAL COMBINATION LOCK ON UPPER CUBBY
10.14	NAME PLATE (2.25" x 8")
10.15	VENTILATED FOOT LOCKER w/ LIFT LID
10.16	3 DOUBLE HOOKS
10.19	OPEN CUBBY SHELF
10.23	LOGO GRAPHIC
10.30	CORNER GUARDS
10.34	POCKET DOORS
10.35	CLOTHES ROD
10.42	ROBE HOOK, BASIS OF DESIGN BOBRICK B-677
10.51	SHOWER ROD, CURTAIN, & HOOKS
10.52	SHOWER SEAT W/GRAB BARS - ADA
10.72	ATHLETIC LOCKERS (SEE PROJECT MANUAL)
10.73	CORNER & FILLER PANELS TO MATCH NEARBY ATHLETIC LOCKERS (SIDES & TOP)
10.91	CEILING MOUNTED CUBICLE CURTAIN, TRACK, & HOOKS
11.10	REFRIGERATOR
12.05	TELEVISION & MOUNTING HARDWARE BY OWNER - OUTLINE SHOWN FOR REFERENCE ONLY
22.09	SEE PLUMBING DRAWINGS AND PROJECT MANUAL FOR MORE INFORMATION
26.01	SURFACE MOUNTED LIGHT FIXTURE (SEE ELECTRICAL)
26.20	ELECTRICAL DEVICE (SEE ELECTRICAL)

LOCKER FINISH/GENERAL NOTES (WRESTLING)

- SINGLE TIER CUSTOM LOCKER 21"W x 30"D x 68"H 3/4" PRESSURE LAMINATE PANELS WITH 3MM EDGE BAND, GLUE AND DOWEL CONSTRUCTION, COLOR SELECTED FROM
- 2-DIAL COMBINATION LOCK NAME PLATE (2.25" x 8")
- FOOT LOCKER MATERIAL TO BE SOLID COLOR CORE TO ALLOW FOR VENT HOLES TO BE DRILLED AND PROVIDE A FINISHED LOOK.
- LOWER FOOT LOCKER WITH SOLID SURFACE SEAT LIFT LID w CONCEALED HINGES & HASP LOCK. STORAGE BELOW
- CLOTHES ROD & 3 DOUBLE HOOKS (SATIN CHOME)
- LOGO GRAPHIC AT FOOT LOCKER FRONT
- POCKET DOORS WITH NO PULLS PUSH TO OPEN HARDWARE INSIDE CONCEALED EURO-STYLE HINGES WITH 110 DEGREE OPENING
- CHANNEL FOR LED DOWN LIGHTING UNDER FOOT LOCKER.


1108 S. Main St. 102 Aberdeen, SD 57401 Phone: 605-725-4852

1113 St Joseph Street Rapid City, SD 57701 Phone: 605-491-2485

300 N. Phillips Ave. 120 Sioux Falls, SD 57104 Phone: 605-334-9999

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REVISION SCHEDULE: REV. # REV. DSC. REV. DATE


PROJECT:

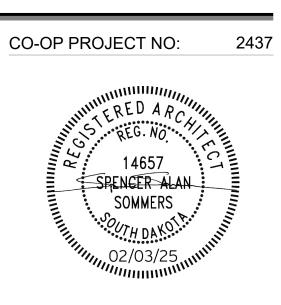BARNETT CENTER, LOCKER ROOM REMODEL

NORTHERN STATE UNIVERSITY ABERDEEN, SOUTH DAKOTA

SHEET TITLE:

WRESTLING LOCKER ROOM INTERIOR ELEVATIONS

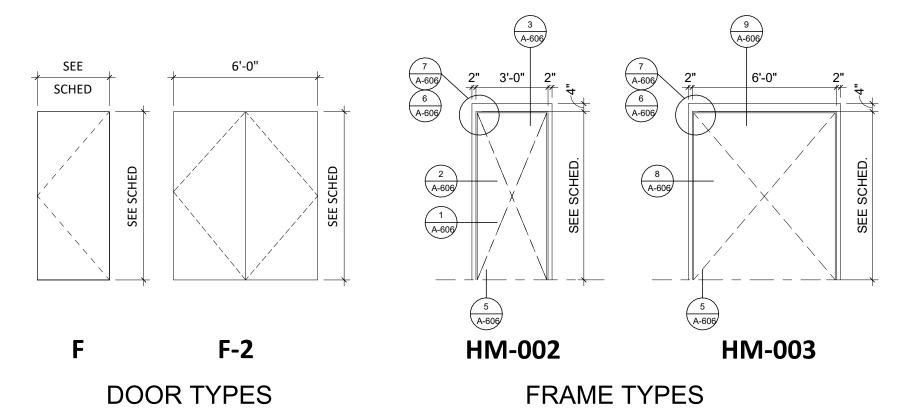

1/4" = 1'-0"


DOOR & FRAME SCHEDULE																					
			DOOR			FRA	AME	Hardware													
NO.	W	Н	T	TYPE	MAT'L	TYPE MAT'L		TYPE MAT'L		TYPE MAT'L		TYPE MAT'L		TYPE MAT'L		TYPE MAT'L		TYPE MAT'L		Group	ADDITIONAL NOTES
A101	3' - 0"	7' - 0"	0' - 1 3/4"	F	WD	HM-002	HM	01	4" HEAD, DOOR SIGNAGE TO INCLUDE MAX. OCC. 49												
A102	3' - 0"	7' - 0"	0' - 1 3/4"	F	WD	HM-002	HM	02	4" HEAD, INCLUDE DOOR SIGNAGE												
A103	3' - 0"	7' - 0"	0' - 1 3/4"	F	WD	HM-002	HM	02	4" HEAD, INCLUDE DOOR SIGNAGE												
A104	3' - 0"	7' - 0"	0' - 1 3/4"	F	WD	HM-002	HM	01	4" HEAD, DOOR SIGNAGE TO INCLUDE MAX. OCC. 49												
A105	3' - 0"	7' - 0"	0' - 1 3/4"	F	WD	HM-002	HM	04	4" HEAD, INCLUDE DOOR SIGNAGE												
A106	3' - 0"	7' - 0"	0' - 1 3/4"	F	WD	HM-002	HM	01	4" HEAD, DOOR SIGNAGE TO INCLUDE MAX. OCC. 49												
A109	3' - 0"	7' - 0"	0' - 1 3/4"	F	WD	HM-002	HM	01	4" HEAD, DOOR SIGNAGE TO INCLUDE MAX. OCC. 49												
A110	6' - 0"	7' - 0"	0' - 1 3/4"	F-2	WD	HM-003	HM	05	4" HEAD, INCLUDE DOOR SIGNAGE												
A111	6' - 0"	7' - 0"	0' - 1 3/4"	F-2	WD	HM-003	HM	05	4" HEAD, INCLUDE DOOR SIGNAGE												

GENERAL NOTES


- ALL HM FRAMES IN STUD PARTITIONS SHALL BE WRAPPED AROUND BOTH SIDES OF PARTITION (U.O.N.) SEE PLAN FOR WALL THICKNESS.
- CAULK ENTIRE PERIMTER OF H.M. FRAMES (BOTH SIDES). PAINT H.M. FRAMES TO MATCH EXISTING. SPLIT PAINT COLOR AT DOOR GASKET AS
- PROVIDE ROOM SIGNAGE AT ALL DOORS. WHERE MOUNTED TO GLAZING, PROVIDE A BLANK BACK PLATE ON OPPOSIZE SIDE OF GLAZING. SEE CODE STANDARDS FOR MOUNTING HEIGHTS AND LOCATIONS. SEE SPECIFICATIONS FOR SPECIAL SIGNAGE
- REFER TO WALL TYPES FOR WALL CONSTRUCTION ELEMENTS FOR ALL DOOR AND WINDOW DETAILS.

	KEYNOTE SCHEDULE								
3.14	4" CONCRETE FLOOR SLAB ON GRADE w/ FIBERMESH REINFORCEMENT & 15 MIL. VAPOR BARRIER BELOW								
4.07	EXISTING CMU WALL								
4.08	GROUT SOLID DOWN TO SLAB								
4.16	CMU BULLNOSE CORNER UNIT								
4.17	CMU SOAP BLOCK								
5.12	STRUCTURAL STEEL LINTEL (2)W8X10 W/3/8" STL. BOT. PL. STOPPED 1/2" SHORT OF JAMB - PAINT EXPOSED STEEL TO MATCH FRAME								
5.15	3/8" END PLATE								
5.16	10"x8"X1/2" STEEL BEARING PLATE w/(2) 5/8"x4" H.A.S. @ EACH END								
5.91	#5 REBAR @ 16" O.C PIN AND EPOXY								
7.13	SEALANT AROUND PERIMETER (TYP. BOTH SIDES)								
7.20	BATT INSULATION								
8.01	DOOR (SEE SCHED.)								
8.02	FRAME (SEE SCHED.)								
8.08	HOLLOW METAL FRAME								
8.12	THRESHOLD								
9.05	6" STEEL STUD @ 16" O.C. (U.N.O.) & TRACK FRAMING								
9.13	1 1/2" CARRYING CHANNEL								
9.21	5/8" GYPSUM BOARD								
9.59	SEE ROOM FINISH SCHEDULE FOR FLOOR FINISHES								
31.08	PROVIDE AND INSTALL ENGINEERED FILL AS REQ'D. COMPACTION TO MEET OR EXCEED 95%								
EXG	EXISTING TO REMAIN								

	KEYNOTE SCHEDULE
3.14	4" CONCRETE FLOOR SLAB ON GRADE w/ FIBERMESH REINFORCEMENT & 15 IVAPOR BARRIER BELOW
4.07	EXISTING CMU WALL
4.08	GROUT SOLID DOWN TO SLAB
4.16	CMU BULLNOSE CORNER UNIT
4.17	CMU SOAP BLOCK
5.12	STRUCTURAL STEEL LINTEL (2)W8X10 W/3/8" STL. BOT. PL. STOPPED 1/2" SHOOF JAMB - PAINT EXPOSED STEEL TO MATCH FRAME
5.15	3/8" END PLATE
5.16	10"x8"X1/2" STEEL BEARING PLATE w/(2) 5/8"x4" H.A.S. @ EACH END
5.91	#5 REBAR @ 16" O.C PIN AND EPOXY
7.13	SEALANT AROUND PERIMETER (TYP. BOTH SIDES)
7.20	BATT INSULATION
8.01	DOOR (SEE SCHED.)
8.02	FRAME (SEE SCHED.)
8.08	HOLLOW METAL FRAME
8.12	THRESHOLD
9.05	6" STEEL STUD @ 16" O.C. (U.N.O.) & TRACK FRAMING
9.13	1 1/2" CARRYING CHANNEL
9.21	5/8" GYPSUM BOARD
9.59	SEE ROOM FINISH SCHEDULE FOR FLOOR FINISHES
31.08	PROVIDE AND INSTALL ENGINEERED FILL AS REQ'D. COMPACTION TO MEET C EXCEED 95%

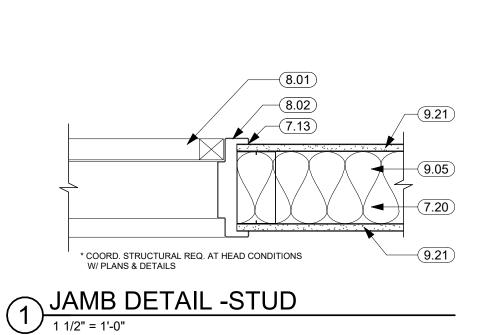


1/4" = 1'-0"

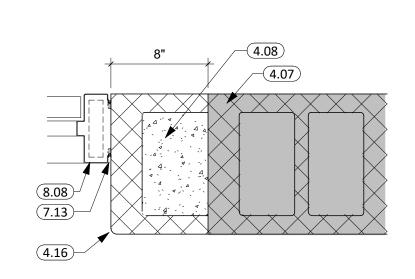


JAMB DETAIL -CMU

1 1/2" = 1'-0"

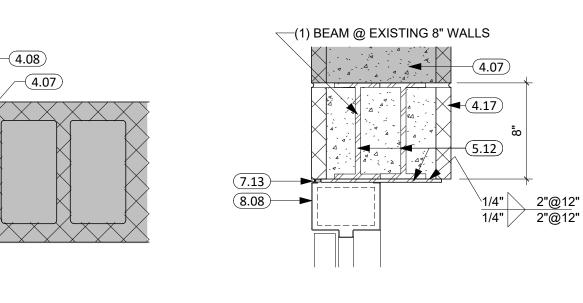



3 HEAD DETAIL - CMU

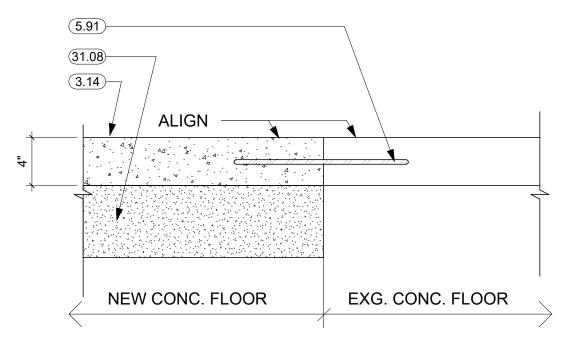



PATCH VB TO MATCH


CONCRETE FLOOR JOINT DETAIL

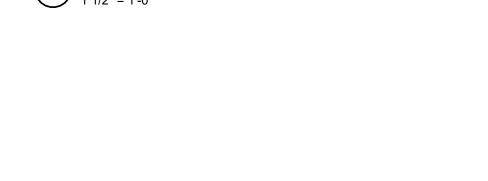


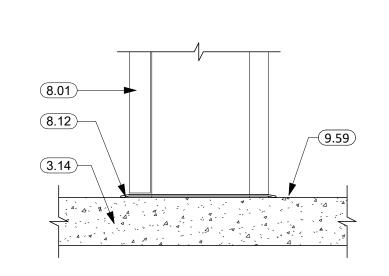

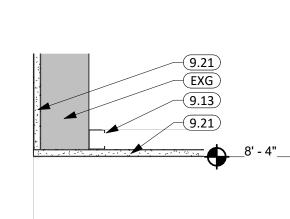

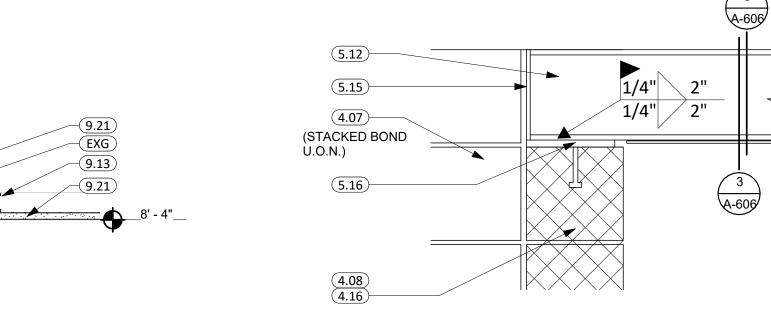

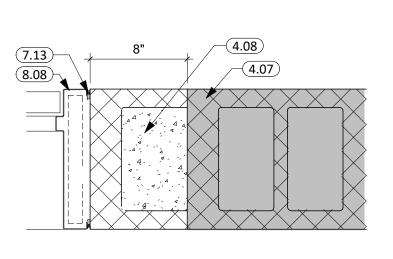

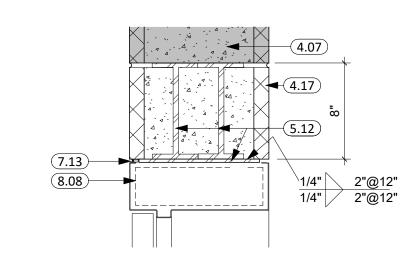

5 THRESHOLD DETAIL
1 1/2" = 1'-0"

6 SECTION @ SOFFIT

7 LINTEL DETAIL (TYP)
1 1/2" = 1'-0"

8 JAMB DETAIL -CMU
1 1/2" = 1'-0"

9 HEAD DETAIL - CMU

PROJECT: BARNETT CENTER, LOCKER ROOM REMODEL

ISSUE:

NORTHERN STATE UNIVERSITY ABERDEEN, SOUTH DAKOTA

1108 S. Main St. 102 Aberdeen, SD 57401 Phone: 605-725-4852

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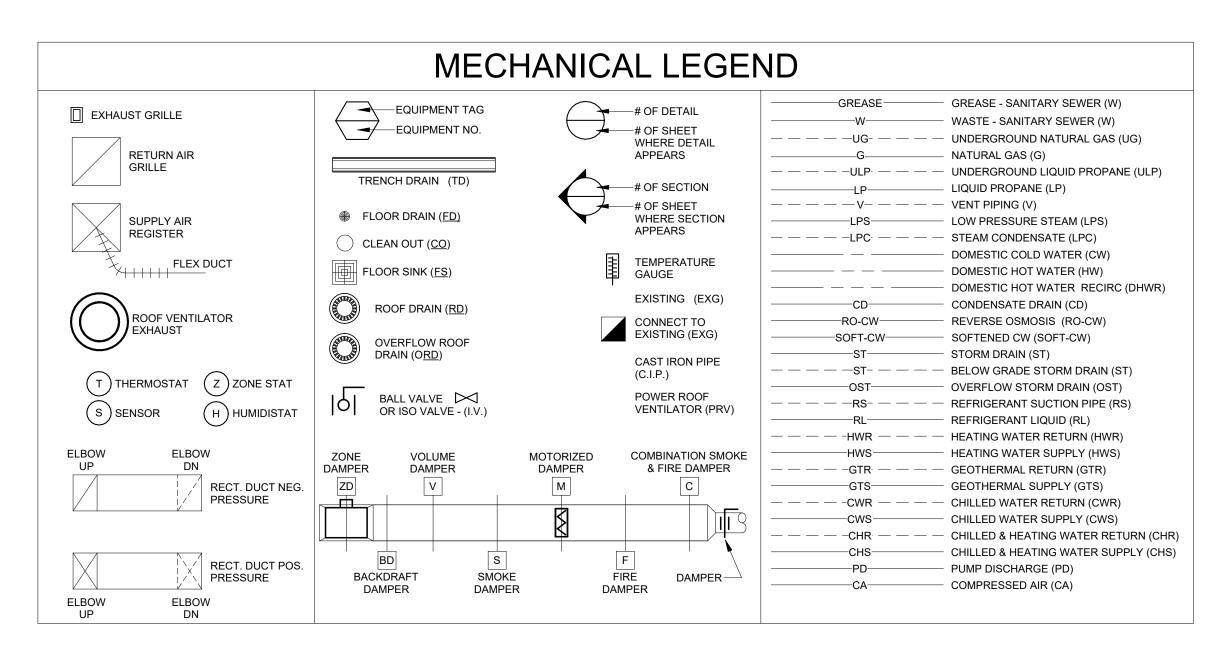
2437

REV. DATE

CO-OP PROJECT NO:

SHEET TITLE:

DOOR SCHEDULE, DETAILS, SECTIONS




		ELI	ECTRICAL LEGEND)	
SYMBOL	DESCRIPTION	SYMBOL	DESCRIPTION	SYMBOL	DESCRIPTION
\$ \$ 3 \$ 4 \$ LV \$ D \$ T \$ O \$ P \$ K \$ F	SINGLE POLE SWITCH THREE WAY SWITCH FOUR WAY SWITCH LOW VOLTAGE PUSH BUTTON SWITCH DIMMER SWITCH TIMER SWITCH OCCUPANCY SENSOR PILOT LIGHT SWITCH KEYED SWITCH VARIABLE SPEED FAN SWITCH	## / a,b	LIGHTING FIXTURE E = EMERGENCY BALLAST NL = NIGHT LIGHT ## = FIXTURE ID TAG a,b = CNTRL/RELAY ID TAG UNDER CABINET FIXTURE WALL MOUNTED FIXTURE RECESSED FIXTURE PHOTO CONTROL SECURITY CAMERA	M H S S S S FACP	SMOKE DETECTOR HEAT DETECTOR (FT = FIXED TEMPERATURE) MANUAL PULL STATION HORN/STROBE CEILING MOUNG HORN/STROBE STROBE ONLY XX CANDELA RATING FIRE ALARM WALL SPEAKER FIRE ALARM CEILING SPEAKER FIRE ALARM CONTROL PANEL
OS1 ⇔ ■ ● ● ●	OCCUPANCY SENSOR - CEILING MOUNTED POWER PACK FOR LOW VOLTAGE OCCUPANCY SENSOR DUPLEX RECEPTACLE GROUND FAULT CIRCUIT INTERRUPTER	\$ 8	WALL SPEAKER EXIT FIXTURE EMERGENCY WALL PACK POLE MOUNTED LIGHT FIXTURE CLOCK	ANNC TS FS BT	FIRE ALARM ANNUNCIATOR PANEL TAMPER SWITCH FLOW SWITCH BEAM TRANSMITTER
♥ _{D1}	DUPLEX RECEPTACLE DROP CORD RECEPTACLE (SEE DETAILS) 250V 4-WIRE RECEPTACLE DOUBLE DUPLEX RECEPTACLE	C	NURSE CALL PULL STATION NURSE CALL DUTY STATION NURSE CALL CORRIDOR LIGHT	REC SD MD	BEAM RECEIVER SMOKE DAMPER MOTORIZED DAMPER
¥	TOP SWITCHED DUPLEX RECEPTACLE SPECIAL OUTLET DATA/PHONE OUTLET XX INDICATES NO. OF JACKS WALL PHONE OUTLET	NCCP T S	NURSE CALL CONTROL PANEL THERMOSTAT INTERCOM SPEAKER	DSD DS CR	DUCT SMOKE DETECTOR DOOR STRIKE CARD READER/KEYPAD DISCONNECT (F = FUSED)
	CEILING DATA/PHONE OUTLET FLOOR BOX WITH POWER AND DATA	H J TC	INTERCOM CALL STATION JUNCTION BOX TIME CLOCK	R	COMBINATION STARTER RELAY CONNECT TO EXISTING
\$ _M	FLOOR BOX WITH POWER ONLY MANUAL MOTOR STARTER MOTOR CONNECTION	T TV	VOLUME CONTROL TRANSFORMER CABLE TV - ONE CAT6 & ONE COAX CABLE	WG WP AC UC	WIRE GUARD WEATHER PROOF ABOVE COUNTER UNDER COUNTER
VFD D	VARIABLE FREQUENCY DRIVE HAND DRYER	DH _	DOOR HOLDER	UPS EXG MON	UNINTERRUPTIBLE POWER SUPPLY EXISTING MONITOR SEE ARCHITECTURAL ELEVATIONS

SPECIAL NOTES:

- 1. IN AREAS WHERE EXISTING CEILINGS ARE TO REMAIN, EACH TRADE SHALL BE RESPONSIBLE FOR ANY DAMAGE OR REPAIR NEEDED TO EXISTING CEILINGS AS A RESULT OF THEIR WORK.
- 2. EACH TRADE SHALL BE RESPONSIBLE FOR CUTTING AND PATCHING AS NECESSARY TO ALLOW FOR COMPLETION OF THEIR WORK. REFER TO ARCHITECTURAL PLANS FOR SELECTIVE DEMOLITION BY
- 3. ALL CONTRACTORS SHALL VISIT THE SITE AND VERIFY ALL EXISTING CONDITIONS AND DIMENSIONS. NOTIFY THE ENGINEER IMMEDIATELY OF ANY DISCREPANCIES.
- 4. THE EXISTING BUILDING WILL BE IN USE DURING THIS CONSTRUCTION. SCHEDULE AND CARRY OUT THE WORK IN SUCH A MANNER AS TO CAUSE THE OWNER A MINIMUM OF INCONVENIENCE DUE TO SERVICE INTERRUPTIONS. TEMPORARY SERVICES SHALL BE INSTALLED IF ONE PHASE OF CONSTRUCTION DISRUPTS SERVICE TO ANOTHER AREA OF THE BUILDING OR IF EQUIPMENT HAS TO BE RELOCATED TO ALLOW CONSTRUCTION TO PROGRESS. SERVICE INTERRUPTIONS SHALL BE CONFINED TO THE SMALLEST AREA POSSIBLE AT ANY ONE TIME AND INTERRUPTIONS SHALL BE SCHEDULE WITH THE OWNER'S SITE REPRESENTATIVE. AFTER SERVICE HAS BEEN RESTORED FOLLOWING AN INTERRUPTION, INSPECT AREAS AFFECTED BY THE INTERRUPTION AND BE RESPONSIBLE FOR RETURNING AUTOMATICALLY CONTROLLED EQUIPMENT TO THE SAME OPERATING CONDITION, WHICH EXISTED PRIOR TO THE INTERRUPTION.
- 5. ALL DDC TEMPERATURE CONTROL WORK TO BE COMPLETED BY G&R CONTROLS (CONTACT PAUL DOOHEN
- 6. DURING THE SHOP DRAWING PROCESS, ALL M&E CONTRACTORS TO BE RESPONSIBLE FOR MARKING UP ALL OPENINGS IN THE CONCRETE SLAB, PRECAST WALL, CORE FLOOR, OR STRUCTURAL STEEL FRAMING, AND STRUCTURAL STEEL ROOF JOIST SYSTEMS REQUIRED FOR THE INSTALLATION OF THEIR RESPECTIVE SYSTEMS IN NEW AND EXISTING STRUCTURAL SYSTEMS.
- 7. WHERE PEX PIPING IS USED, PIPING SHALL BE UPONOR PEX-A POTABLE WATER PIPING WITH UPONOR F1960 EXPANDABLE FITTINGS, NO CRIMP FITTINGS TO BE ACCEPTED, PROVIDED THE CONTRACTOR IS TRAINED AND FOLLOWING ALL MANUFACTURER'S RECOMMENDATIONS TO FULFILL ALL AVAILABLE UPONOR 25 YEAR WARRANTY COVERAGE.

8.	ORIGINAL PLANS ARE AVAILABLE.	PLEASE CONTACT THE ENGINEER'S OFFICE TO REQUEST.	CONTACT
	ISAAC @ 605-225-4344.		

	ELECTRICAL & MECHANICAL SHEET INDEX
Sheet Number	Sheet Name
EM100	LEGENDS & SHEET INDEX
M200	TRACK & FIELD - PLUMBING & HYDRONICS DEMOLITION PLAN
M201	WRESTLING & BASEBALL - PLUMBING & HYDRONICS DEMOLITION PLAN
M300	TRACK & FIELD - FIRE SPRINKLER & HVAC DEMOLITION PLAN
M301	WRESTLING & BASEBALL - FIRE SPRINKLER & HVAC DEMOLITION PLAN
M400	TRACK & FIELD - PLUMBING & HYDRONICS PLAN
M401	WRESTLING & BASEBALL - PLUMBING & HYDRONICS PLAN
M500	TRACK & FIELD - FIRE PROTECTION PLAN
M501	WRESTLING & BASEBALL - FIRE PROTECTION PLAN
M600	TRACK & FIELD - HVAC PLAN
M601	WRESTLING & BASEBALL - HVAC PLAN
M602	OVERALL LOCKER ROOM - HVAC TEMPERATURE CONTROL ZONE PLAN
M700	MECHANICAL SCHEDULES & DETAILS
M701	MECHANICAL SECTIONS (1 OF 2)
M702	MECHANICAL SECTIONS (2 OF 2)
E200	TRACK & FIELD - ELECTRICAL DEMOLITION PLAN
E201	WRESTLING & BASEBALL - ELECTRICAL DEMOLITION PLAN
E300	TRACK & FIELD - POWER & DATA PLAN
E301	WRESTLING & BASEBALL - POWER & DATA PLAN
E400	TRACK & FIELD - LIGHTING & SPECIAL SYSTEMS PLAN
E401	WRESTLING & BASEBALL - LIGHTING & SPECIAL SYSTEMS PLAN
E500	ELECTRICAL SECTIONS - TRACK & FIELD
E502	ELECTRICAL SECTIONS - BASEBALL & WRESTLING
E503	ELECTRICAL RISER DIAGRAM & PANEL SCHEDULE

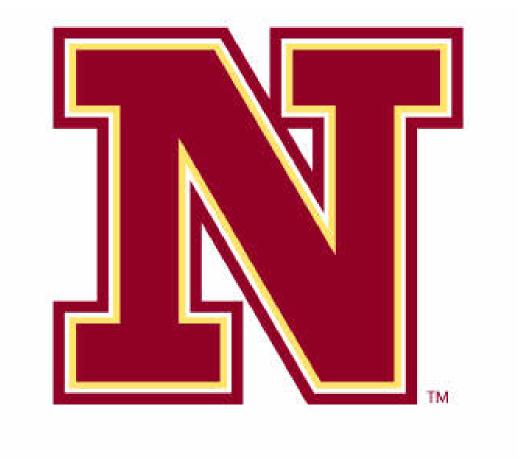

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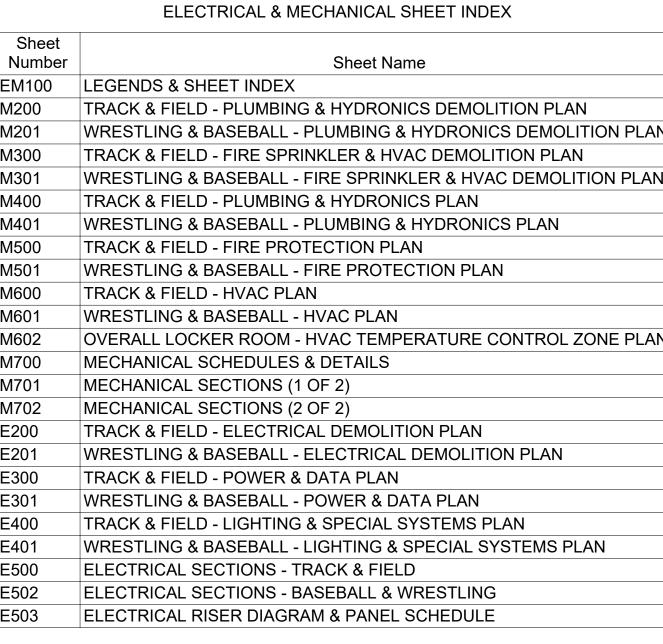
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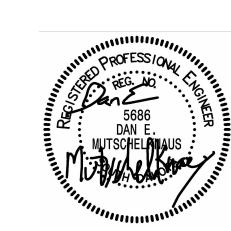


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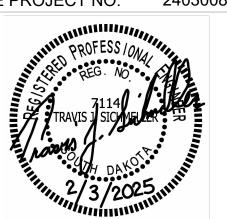
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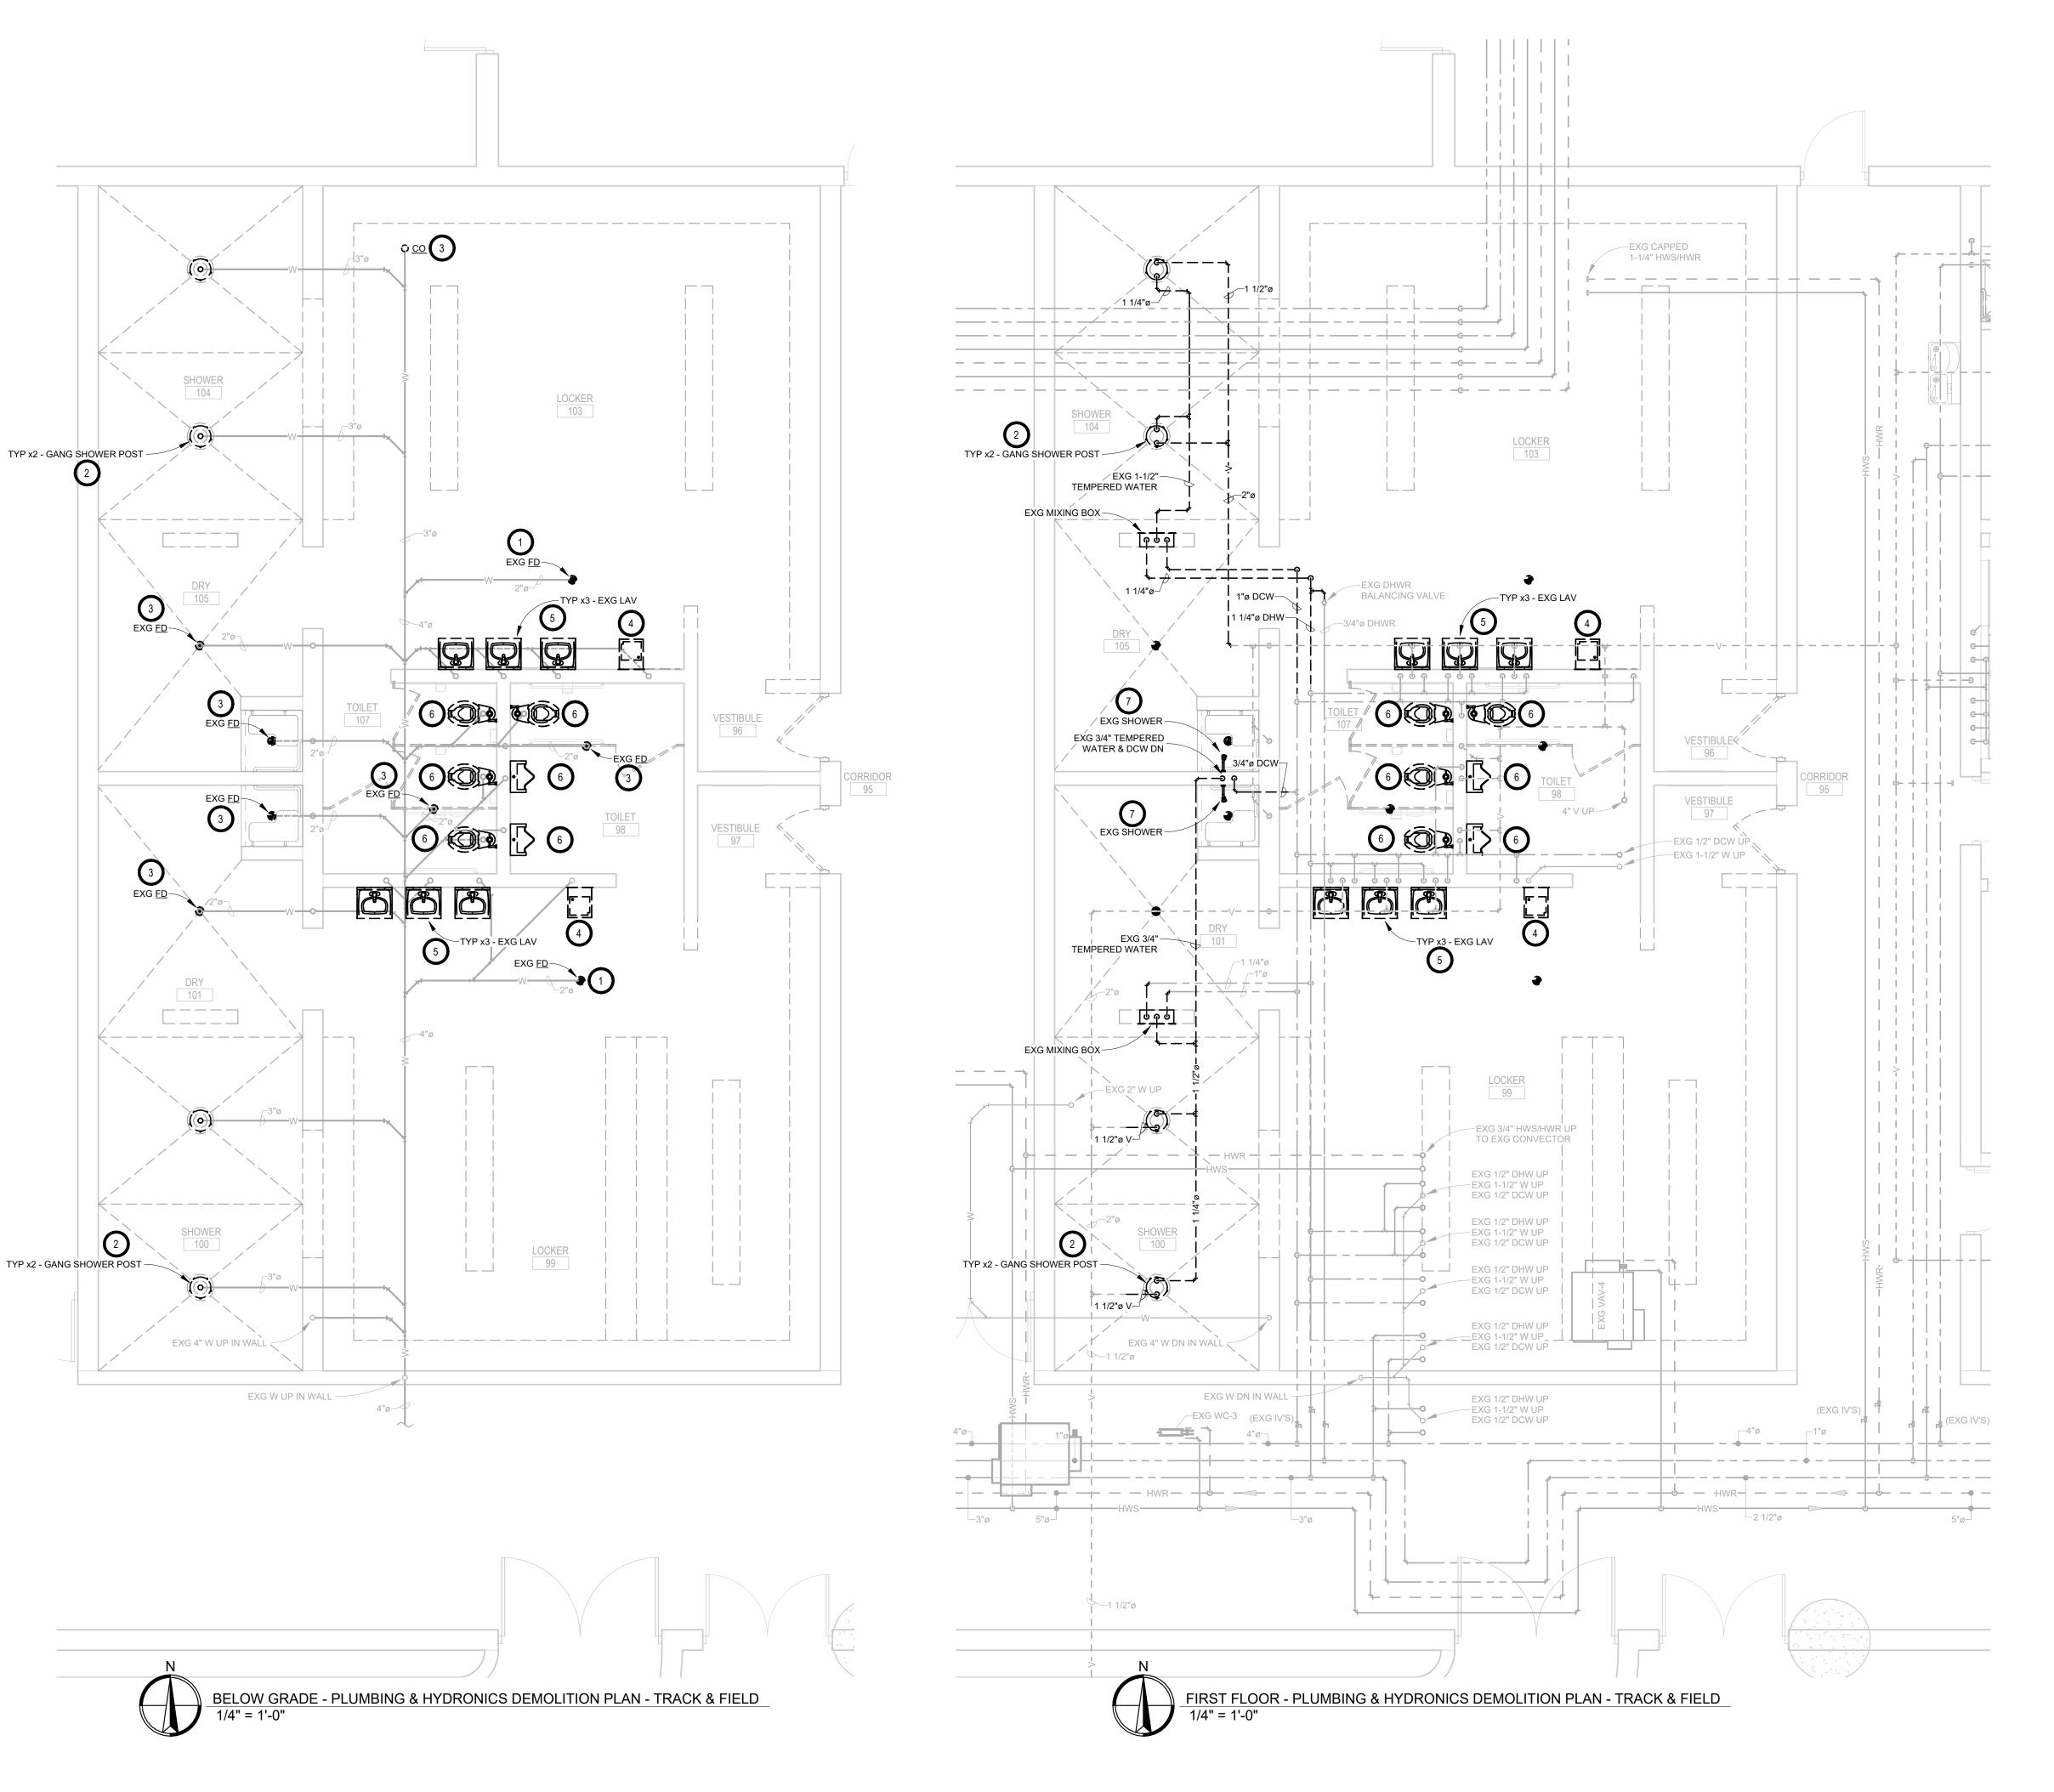
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SHEET TITLE: LEGENDS & SHEET INDEX

EM100





- A. CONTRACTOR SHALL VISIT THE SITE AND VERIFY ALL EXISTING CONDITIONS AND DIMENSIONS. NOTIFY THE ENGINEER IMMEDIATELY OF ANY DISCREPANCIES, INCLUDING ANY NECESSARY DEMOLITION.
- B. REMOVE MECHANICAL EQUIPMENT IN THE AREAS SHOWN ON THE PLAN, DISCONNECT SERVICES AND REMOVE TO A POINT OUT OF THE WAY OF THE GENERAL DEMOLITION. MARK ON THE PLAN TO CLEARLY SHOW WHERE THESE SERVICES ARE STOPPED. DEMOLITION WORK SHALL BE COORDINATED WITH THE OWNER. SHOULD QUESTIONS ARISE REGARDING THE REMOVAL OF EQUIPMENT, CONFER WITH THE OWNER BEFORE SUCH EQUIPMENT IS DEMOLISHED. MATERIALS REMOVED BY DEMOLITION SHALL REMAIN THE PROPERTY OF THE OWNER UNLESS OTHERWISE SPECIFICALLY NOTED. MATERIAL THE OWNER DOES NOT WISH TO RETAIN SHALL BE REMOVED AND DISPOSED OF PROPERLY BY THE CONTRACTOR.
- C. EQUIPMENT SHOWN ON DRAWINGS AS EXISTING IS BASED ON EXISTING PLANS AND LIMITED FIELD INVESTIGATION. THE FIELD SURVEY WAS CONDUCTED TO VERIFY, AS MUCH AS POSSIBLE, THE ACCURACY OF THE LOCATIONS SHOWN. THE CONTRACTOR SHALL VERIFY THE ACCURACY OF THE "EXISTING CONDITIONS" AS SHOWN ON THE DRAWINGS AS THE DEMOLITION WORK PROGRESSES. PERFORM MODIFICATIONS AND ADDITIONS AS NECESSARY TO CORRECT FOR THESE HIDDEN CONDITIONS AND ALLOW FOR THE COMPLETION OF THE NEW WORK.
- D. THE EXISTING BUILDING WILL BE IN USE DURING THIS CONSTRUCTION. SCHEDULE AND CARRY OUT THE WORK IN SUCH A MANNER AS TO CAUSE THE OWNER A MINIMUM OF INCONVENIENCE DUE TO SERVICE INTERRUPTIONS. TEMPORARY SERVICES SHALL BE INSTALLED IF ONE PHASE OF CONSTRUCTION DISRUPTS SERVICE TO ANOTHER AREA OF THE BUILDING OR IF EQUIPMENT HAS TO BE RELOCATED TO ALLOW CONSTRUCTION TO PROGRESS. SERVICE INTERRUPTIONS SHALL BE CONFINED TO THE SMALLEST AREA POSSIBLE AT ANY ONE TIME AND INTERRUPTIONS SHALL BE SCHEDULED WITH THE OWNER'S SITE REPRESENTATIVE. AFTER SERVICE HAS BEEN RESTORED FOLLOWING AN INTERRUPTION. INSPECT AREAS AFFECTED BY THE INTERRUPTION AND BE RESPONSIBLE FOR RETURNING AUTOMATICALLY CONTROLLED EQUIPMENT TO THE SAME OPERATING CONDITION, WHICH EXISTED PRIOR TO THE INTERRUPTION.
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- AND MAINTAIN THE EXISTING BUILDING FIRE RATINGS.

 F. ALL MECHANICAL WORK SHALL BE INSTALLED IN STRICT ACCORDANCE WITH ALL APPLICABLE LOCAL, STATE, NATIONAL PLUMBING REGULATIONS, AND THE AUTHORITY HAVING JURISDICTION.
- G. THE MECHANICAL CONTRACTOR IS RESPONSIBLE FOR THE TESTING & CLEANING OF EACH RESPECTIVE SYSTEM IN ACCORDANCE WITH APPLICABLE STATE & LOCAL CODES. TESTS SHALL BE PERFORMED IN THE PRESENCE OF THE AUTHORITY HAVING JURISDICTION. WRITTEN NOTIFICATION OF TEST, DATE, AND RESULTS SHALL BE FURNISHED TO THE ENGINEER BEFORE CONCEALING OR COVERING THE INSTALLATION. TESTS SHALL BE REPEATED UNTIL EACH SYSTEM IS PROVEN ACCEPTABLE

O KEYNOTES:

- 1. PC TO DISCONNECT & REMOVE EXISTING FLOOR DRAIN. REMOVE EXISTING VENTING AS NECESSARY. CAP SANITARY BELOW FLOOR. FLOOR CUTTING & PATCHING BY GC.
- 2. PC TO DISCONNECT & REMOVE EXISTING GANG SHOWER POSTS WITH INTEGRAL DRAINS. REMOVE EXISTING DOMESTIC WATER PIPING, VENTING AS NECESSARY AND PROVIDE AND INSTALL CAP NEAR MAINS. CAP SANITARY BELOW FLOOR. FLOOR CUTTING & PATCHING BY GC.
- 3. PC TO REMOVE & REPLACE EXISTING FLOOR DRAINS AND CLEANOUTS TO ACCOMMODATE REMODEL. SEE PROPOSED. FLOOR CUTTING & PATCHING BY GC.
- 4. PC TO DISCONNECT & REMOVE EXG PLUMBING FIXTURE, DOMESTIC PIPING, VENTING & WASTE SHOWN DARK AND DASHED. INSTALL CAP NEAR MAINS.
- 5. PC TO DISCONNECT & REPLACE EXG PLUMBING FIXTURE. EXISTING DOMESTIC PIPING, VENT & WASTE CONNECTION TO BE EXTENDED WITHIN EXISTING BLOCK WALL. BLOCK DEMO BY GC, PC TO COORDINATE REQUIRED CONCRETE BLOCK WALL DEMO WITH GC TO EXTEND PIPING WITHIN BLOCK WALL TO NEW LAV LOCATIONS. SEE PROPOSED.
- 6. PC TO DISCONNECT & SALVAGE EXG PLUMBING FIXTURE AS NECESSARY TO ALLOW FOR PROPOSED TILE WORK. SEE PROPOSED.
- PC TO REMOVE EXISTING SHOWER & WATER ROUGH INS. BLOCK DEMO BY GC, COORDINATE REQUIRED CONCRETE BLOCK WALL DEMO WITH GC. SEE PROPOSED.

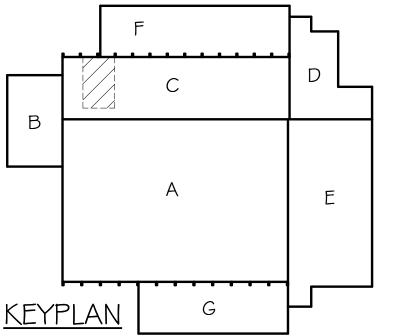

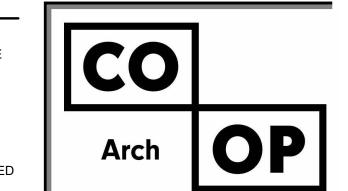

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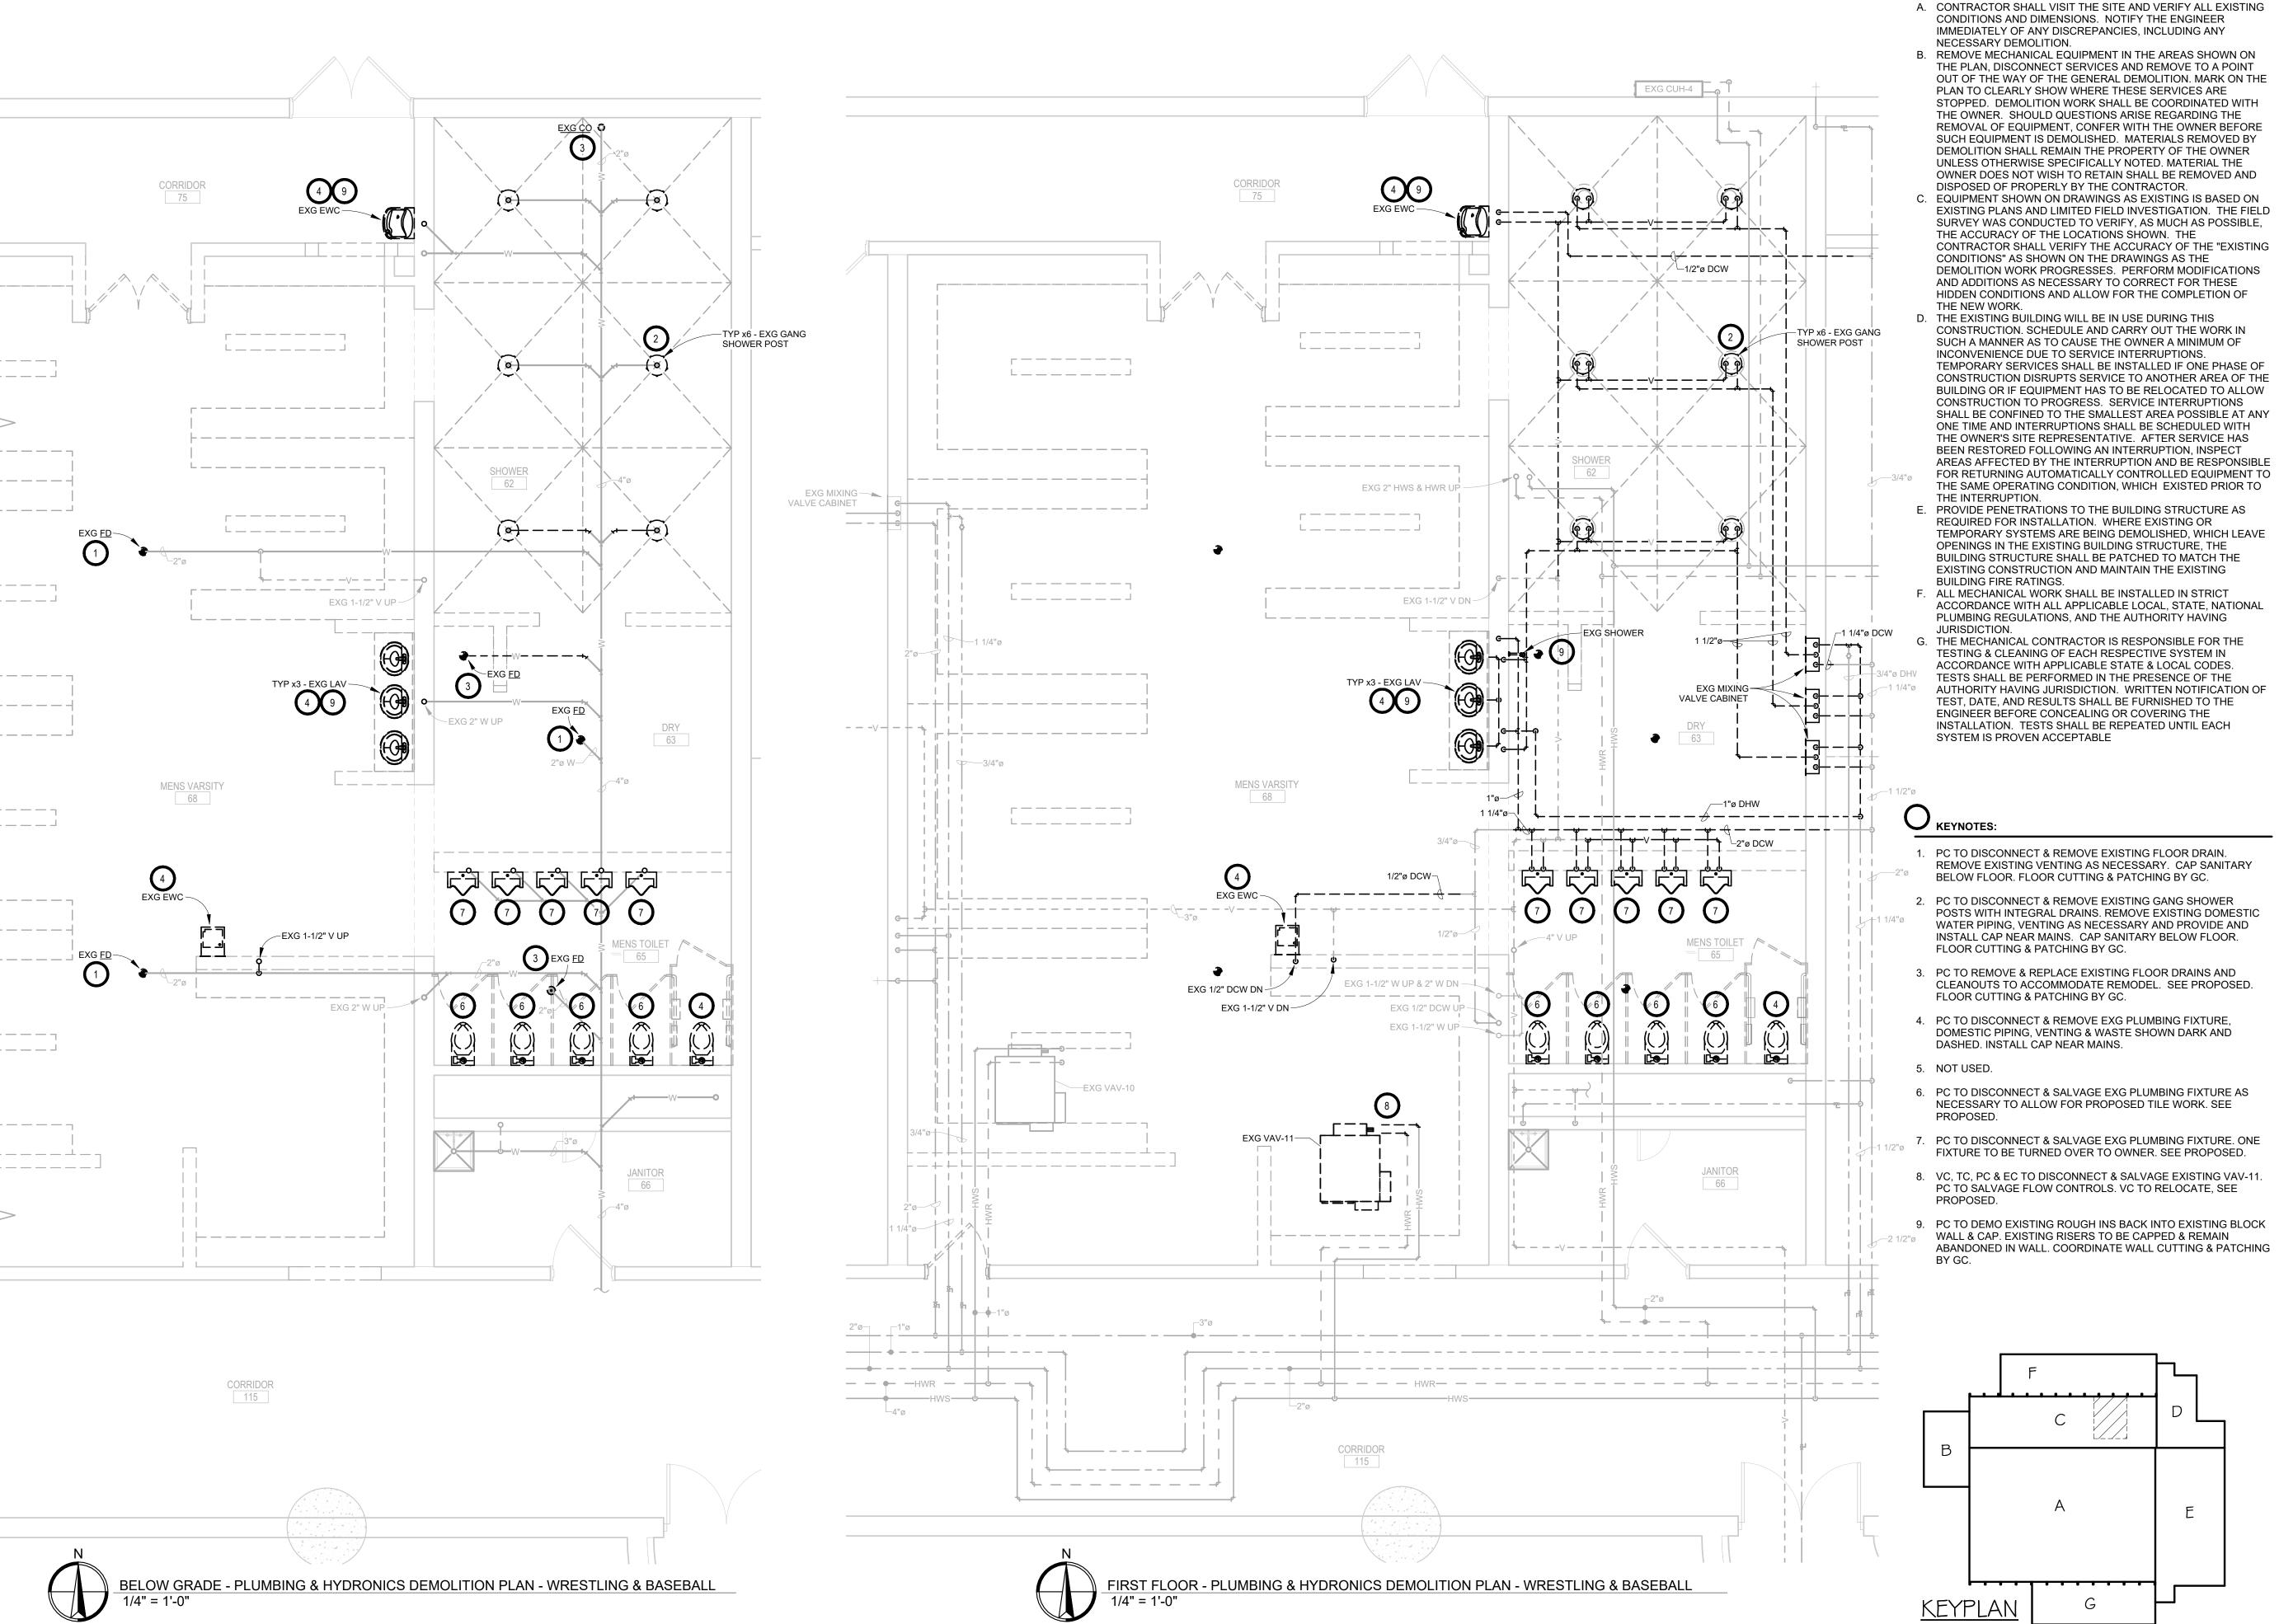
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SHEET TITLE:

TRACK & FIELD - PLUMBING & HYDRONICS DEMOLITION PLAN

M200

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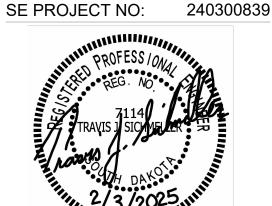
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SHEET TITLE:

WRESTLING & BASEBALL -PLUMBING & HYDRONICS DEMOLITION PLAN

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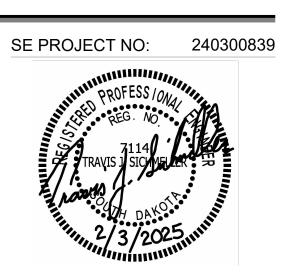
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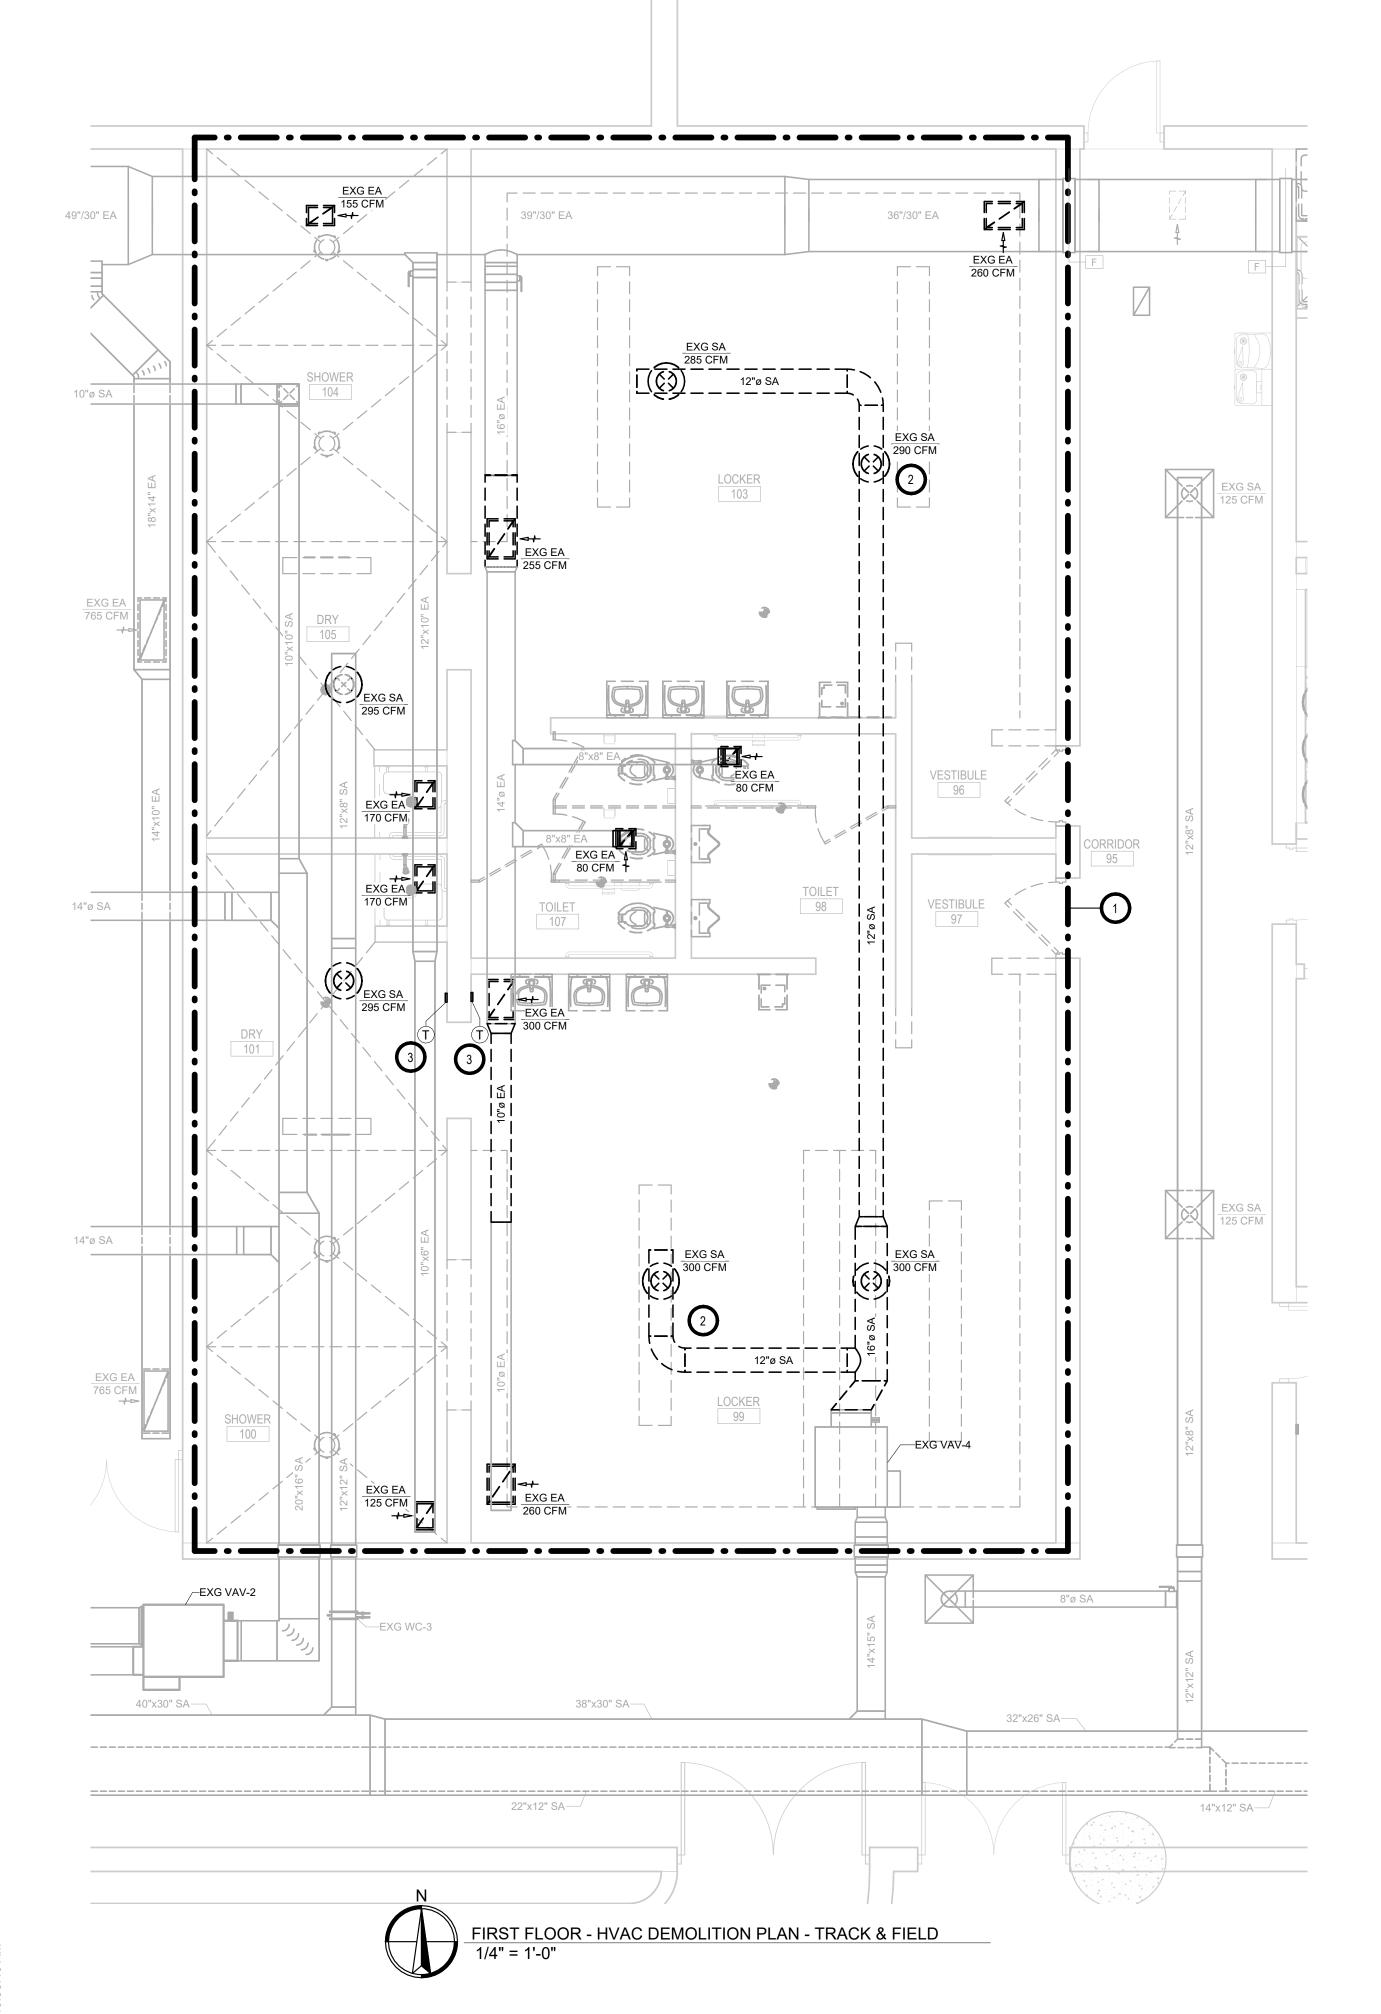
PROJECT:

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SHEET TITLE:

TRACK & FIELD - FIRE SPRINKLER & HVAC DEMOLITION PLAN

M300



A. CONTRACTOR SHALL VISIT THE SITE AND VERIFY ALL EXISTING CONDITIONS AND DIMENSIONS. NOTIFY THE ENGINEER IMMEDIATELY OF ANY DISCREPANCIES,

INCLUDING ANY NECESSARY DEMOLITION.

B. REMOVE MECHANICAL EQUIPMENT IN THE AREAS SHOWN ON THE PLAN, DISCONNECT SERVICES AND REMOVE TO A POINT OUT OF THE WAY OF THE GENERAL DEMOLITION. MARK ON THE PLAN TO CLEARLY SHOW WHERE THESE SERVICES ARE STOPPED. DEMOLITION WORK SHALL BE COORDINATED WITH THE OWNER. SHOULD QUESTIONS ARISE REGARDING THE REMOVAL OF EQUIPMENT, CONFER WITH THE OWNER BEFORE SUCH EQUIPMENT IS DEMOLISHED. MATERIALS REMOVED BY DEMOLITION SHALL REMAIN THE PROPERTY OF THE OWNER UNLESS OTHERWISE SPECIFICALLY NOTED. MATERIAL THE OWNER DOES NOT WISH TO RETAIN SHALL BE REMOVED AND DISPOSED OF PROPERLY BY THE

CONTRACTOR.

C. EQUIPMENT SHOWN ON DRAWINGS AS EXISTING IS BASED ON EXISTING PLANS AND LIMITED FIELD INVESTIGATION. THE FIELD SURVEY WAS CONDUCTED TO VERIFY, AS MUCH AS POSSIBLE, THE ACCURACY OF THE LOCATIONS SHOWN. THE CONTRACTOR SHALL VERIFY THE ACCURACY OF THE "EXISTING CONDITIONS" AS SHOWN ON THE DRAWINGS AS THE DEMOLITION WORK PROGRESSES. PERFORM MODIFICATIONS AND ADDITIONS AS NECESSARY TO CORRECT FOR THESE HIDDEN CONDITIONS AND ALLOW FOR THE COMPLETION OF THE NEW WORK.

D. THE EXISTING BUILDING WILL BE IN USE DURING THIS CONSTRUCTION. SCHEDULE AND CARRY OUT THE WORK IN SUCH A MANNER AS TO CAUSE THE OWNER A MINIMUM OF INCONVENIENCE DUE TO SERVICE INTERRUPTIONS. TEMPORARY SERVICES SHALL BE INSTALLED IF ONE PHASE OF CONSTRUCTION DISRUPTS SERVICE TO ANOTHER AREA OF THE BUILDING OR IF EQUIPMENT HAS TO BE RELOCATED TO ALLOW CONSTRUCTION TO PROGRESS. SERVICE INTERRUPTIONS SHALL BE CONFINED TO THE SMALLEST AREA POSSIBLE AT ANY ONE TIME AND INTERRUPTIONS SHALL BE SCHEDULED WITH THE OWNER'S SITE REPRESENTATIVE. AFTER SERVICE HAS BEEN RESTORED FOLLOWING AN INTERRUPTION, INSPECT AREAS AFFECTED BY THE INTERRUPTION AND BE RESPONSIBLE FOR RETURNING AUTOMATICALLY CONTROLLED EQUIPMENT TO THE SAME OPERATING CONDITION, WHICH EXISTED PRIOR TO THE INTERRUPTION.

E. PROVIDE PENETRATIONS TO THE BUILDING STRUCTURE AS REQUIRED FOR INSTALLATION. WHERE EXISTING OR TEMPORARY SYSTEMS ARE BEING DEMOLISHED, WHICH LEAVE OPENINGS IN THE EXISTING BUILDING STRUCTURE, THE BUILDING STRUCTURE SHALL BE PATCHED TO MATCH THE EXISTING CONSTRUCTION AND MAINTAIN THE EXISTING BUILDING FIRE RATINGS.

F. ALL MECHANICAL WORK SHALL BE INSTALLED IN STRICT ACCORDANCE WITH ALL APPLICABLE LOCAL, STATE, NATIONAL PLUMBING REGULATIONS, AND THE AUTHORITY HAVING JURISDICTION.


G. THE MECHANICAL CONTRACTOR IS RESPONSIBLE FOR THE TESTING & CLEANING OF EACH RESPECTIVE SYSTEM IN ACCORDANCE WITH APPLICABLE STATE & LOCAL CODES. TESTS SHALL BE PERFORMED IN THE PRESENCE OF THE AUTHORITY HAVING JURISDICTION. WRITTEN NOTIFICATION OF TEST, DATE, AND RESULTS SHALL BE FURNISHED TO THE ENGINEER BEFORE CONCEALING OR COVERING THE INSTALLATION. TESTS SHALL BE REPEATED UNTIL EACH SYSTEM IS PROVEN ACCEPTABLE

O KEYNOTES

- 1. AREA WITHIN DASHED BOLD OUTLINE FIRE SPRINKLER CONTRACTOR TO MODIFY THE EXISTING FIRE SPRINKLER SYSTEM INSTALLED AS REQUIRED FOR DEMOLITION & PROPOSED WORK. ORIGINAL FIRE SPRINKLER PLANS ARE AVAILABLE FROM ENGINEER'S OFFICE. FIRE SPRINKLER CONTRACTOR TO REPLACE ANY REMAINING EXISTING FIRE SPRINKLER HEADS SUCH THAT THE AREA OUTLINED WILL BE UPDATED AND THIS NEW OUTLINE TO INCLUDE (1) UPRIGHT HEAD IN VESTIBULE 96, (4) UPRIGHT HEADS IN LOCKER 103, (1) PENDANT HEAD IN DRY 105, (2) PENDANT HEADS IN SHOWER 104, (1) PENDANT HEAD IN TOILET 107, (1) UPRIGHT HEAD IN VESTIBULE 97, (4) UPRIGHT HEADS IN LOCKER 99, (2) PENDANT HEADS IN DRY 101, (2) PENDANT HEADS IN SHOWER 100, AND (1) PENDANT
- 2. TYPICAL VC TO DISCONNECT & REMOVE EXISTING SUPPLY AIR & EXHAUST AIR DUCT & REGISTERS SHOWN DARK & DASHED. SEE PROPOSED.

HEAD IN TOILET 98.

3. TC TO DEMO EXISTING VAV T-STAT. SEE PROPOSED.

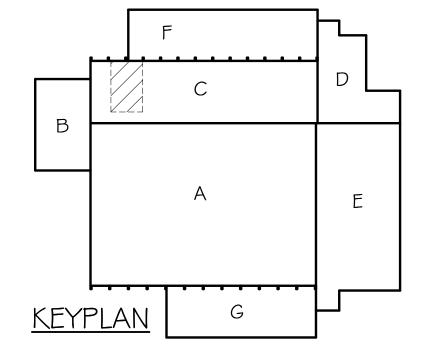

CONTRACTOR.

CLEARLY SHOW WHERE THESE SERVICES ARE

WITH THE OWNER. SHOULD QUESTIONS ARISE REGARDING THE REMOVAL OF EQUIPMENT, CONFER WITH THE OWNER BEFORE SUCH EQUIPMENT IS DEMOLISHED. MATERIALS REMOVED BY DEMOLITION

STOPPED. DEMOLITION WORK SHALL BE COORDINATED

SHALL REMAIN THE PROPERTY OF THE OWNER UNLESS

INVESTIGATION. THE FIELD SURVEY WAS CONDUCTED TO VERIFY, AS MUCH AS POSSIBLE, THE ACCURACY OF THE LOCATIONS SHOWN. THE CONTRACTOR SHALL

VERIFY THE ACCURACY OF THE "EXISTING CONDITIONS"

AS SHOWN ON THE DRAWINGS AS THE DEMOLITION WORK PROGRESSES. PERFORM MODIFICATIONS AND

ADDITIONS AS NECESSARY TO CORRECT FOR THESE

D. THE EXISTING BUILDING WILL BE IN USE DURING THIS CONSTRUCTION. SCHEDULE AND CARRY OUT THE WORK IN SUCH A MANNER AS TO CAUSE THE OWNER A

MINIMUM OF INCONVENIENCE DUE TO SERVICE INTERRUPTIONS. TEMPORARY SERVICES SHALL BE INSTALLED IF ONE PHASE OF CONSTRUCTION

DISRUPTS SERVICE TO ANOTHER AREA OF THE

ALLOW CONSTRUCTION TO PROGRESS. SERVICE INTERRUPTIONS SHALL BE CONFINED TO THE

SMALLEST AREA POSSIBLE AT ANY ONE TIME AND INTERRUPTIONS SHALL BE SCHEDULED WITH THE OWNER'S SITE REPRESENTATIVE. AFTER SERVICE HAS

BEEN RESTORED FOLLOWING AN INTERRUPTION,

CONDITION, WHICH EXISTED PRIOR TO THE

LEAVE OPENINGS IN THE EXISTING BUILDING STRUCTURE, THE BUILDING STRUCTURE SHALL BE

NATIONAL PLUMBING REGULATIONS, AND THE

G. THE MECHANICAL CONTRACTOR IS RESPONSIBLE FOR

WRITTEN NOTIFICATION OF TEST, DATE, AND RESULTS SHALL BE FURNISHED TO THE ENGINEER BEFORE

CONCEALING OR COVERING THE INSTALLATION. TESTS

SHALL BE REPEATED UNTIL EACH SYSTEM IS PROVEN

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OFFICE. FIRE SPRINKLER CONTRACTOR TO REPLACE ANY REMAINING EXISTING FIRE SPRINKLER HEADS

SUCH THAT THE AREA OUTLINED WILL BE UPDATED AND THIS NEW OUTLINE TO INCLUDE (11) UPRIGHT HEADS IN MENS VARSITY 86, (1) PENDANT HEAD IN MENS TOILET 65, (2) PENDANT HEADS IN DRY 63, AND (3)

2. TYPICAL - VC TO DISCONNECT & REMOVE EXISTING SUPPLY AIR & EXHAUST AIR DUCT & REGISTERS

3. TC TO DEMO EXISTING VAV T-STAT. SEE PROPOSED.

 TYPICAL - VC TO PATCH EXISTING DUCTWORK WHERE EXISTING REGISTER WAS REMOVED. SEE PROPOSED.

5. VC, TC, PC & EC TO DISCONNECT & SALVAGE EXISTING VAV-11. PC TO SALVAGE FLOW CONTROLS. VC TO

G

SHOWN DARK & DASHED. SEE PROPOSED.

THE TESTING & CLEANING OF EACH RESPECTIVE SYSTEM IN ACCORDANCE WITH APPLICABLE STATE & LOCAL CODES. TESTS SHALL BE PERFORMED IN THE PRESENCE OF THE AUTHORITY HAVING JURISDICTION.

AUTHORITY HAVING JURISDICTION.

1. AREA WITHIN DASHED BOLD OUTLINE - FIRE

PENDANT HEADS IN SHOWER 62.

RELOCATE, SEE PROPOSED.

KEYPLAN

INTERRUPTION.

ACCEPTABLE

O KEYNOTES

INSPECT AREAS AFFECTED BY THE INTERRUPTION AND

BE RESPONSIBLE FOR RETURNING AUTOMATICALLY CONTROLLED EQUIPMENT TO THE SAME OPERATING

E. PROVIDE PENETRATIONS TO THE BUILDING STRUCTURE

PATCHED TO MATCH THE EXISTING CONSTRUCTION AND MAINTAIN THE EXISTING BUILDING FIRE RATINGS.

F. ALL MECHANICAL WORK SHALL BE INSTALLED IN STRICT ACCORDANCE WITH ALL APPLICABLE LOCAL, STATE,

AS REQUIRED FOR INSTALLATION. WHERE EXISTING OR TEMPORARY SYSTEMS ARE BEING DEMOLISHED, WHICH

BUILDING OR IF EQUIPMENT HAS TO BE RELOCATED TO

HIDDEN CONDITIONS AND ALLOW FOR THE


COMPLETION OF THE NEW WORK.

OTHERWISE SPECIFICALLY NOTED. MATERIAL THE

OWNER DOES NOT WISH TO RETAIN SHALL BE REMOVED AND DISPOSED OF PROPERLY BY THE

C. EQUIPMENT SHOWN ON DRAWINGS AS EXISTING IS

BASED ON EXISTING PLANS AND LIMITED FIELD

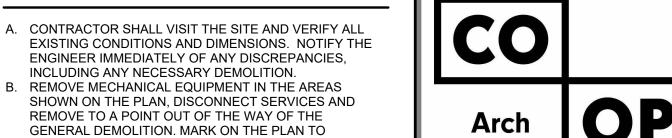

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TRAVIA

ISSUE:

2/3/2025 100% CONSTRUCTION DOCUMENTS

REVISION SCHEDULE:

REV. DSC. REV. DATE


PROJECT:

NSU - BARNETT CENTER - LOCKER ROOM UPGRADES OSE # RO124--16X NORTHERN STATE UNIVERSITY ABERDEEN, SOUTH DAKOTA


SHEET TITLE:

WRESTLING & BASEBALL - FIRE SPRINKLER & HVAC DEMOLITION PLAN

M301

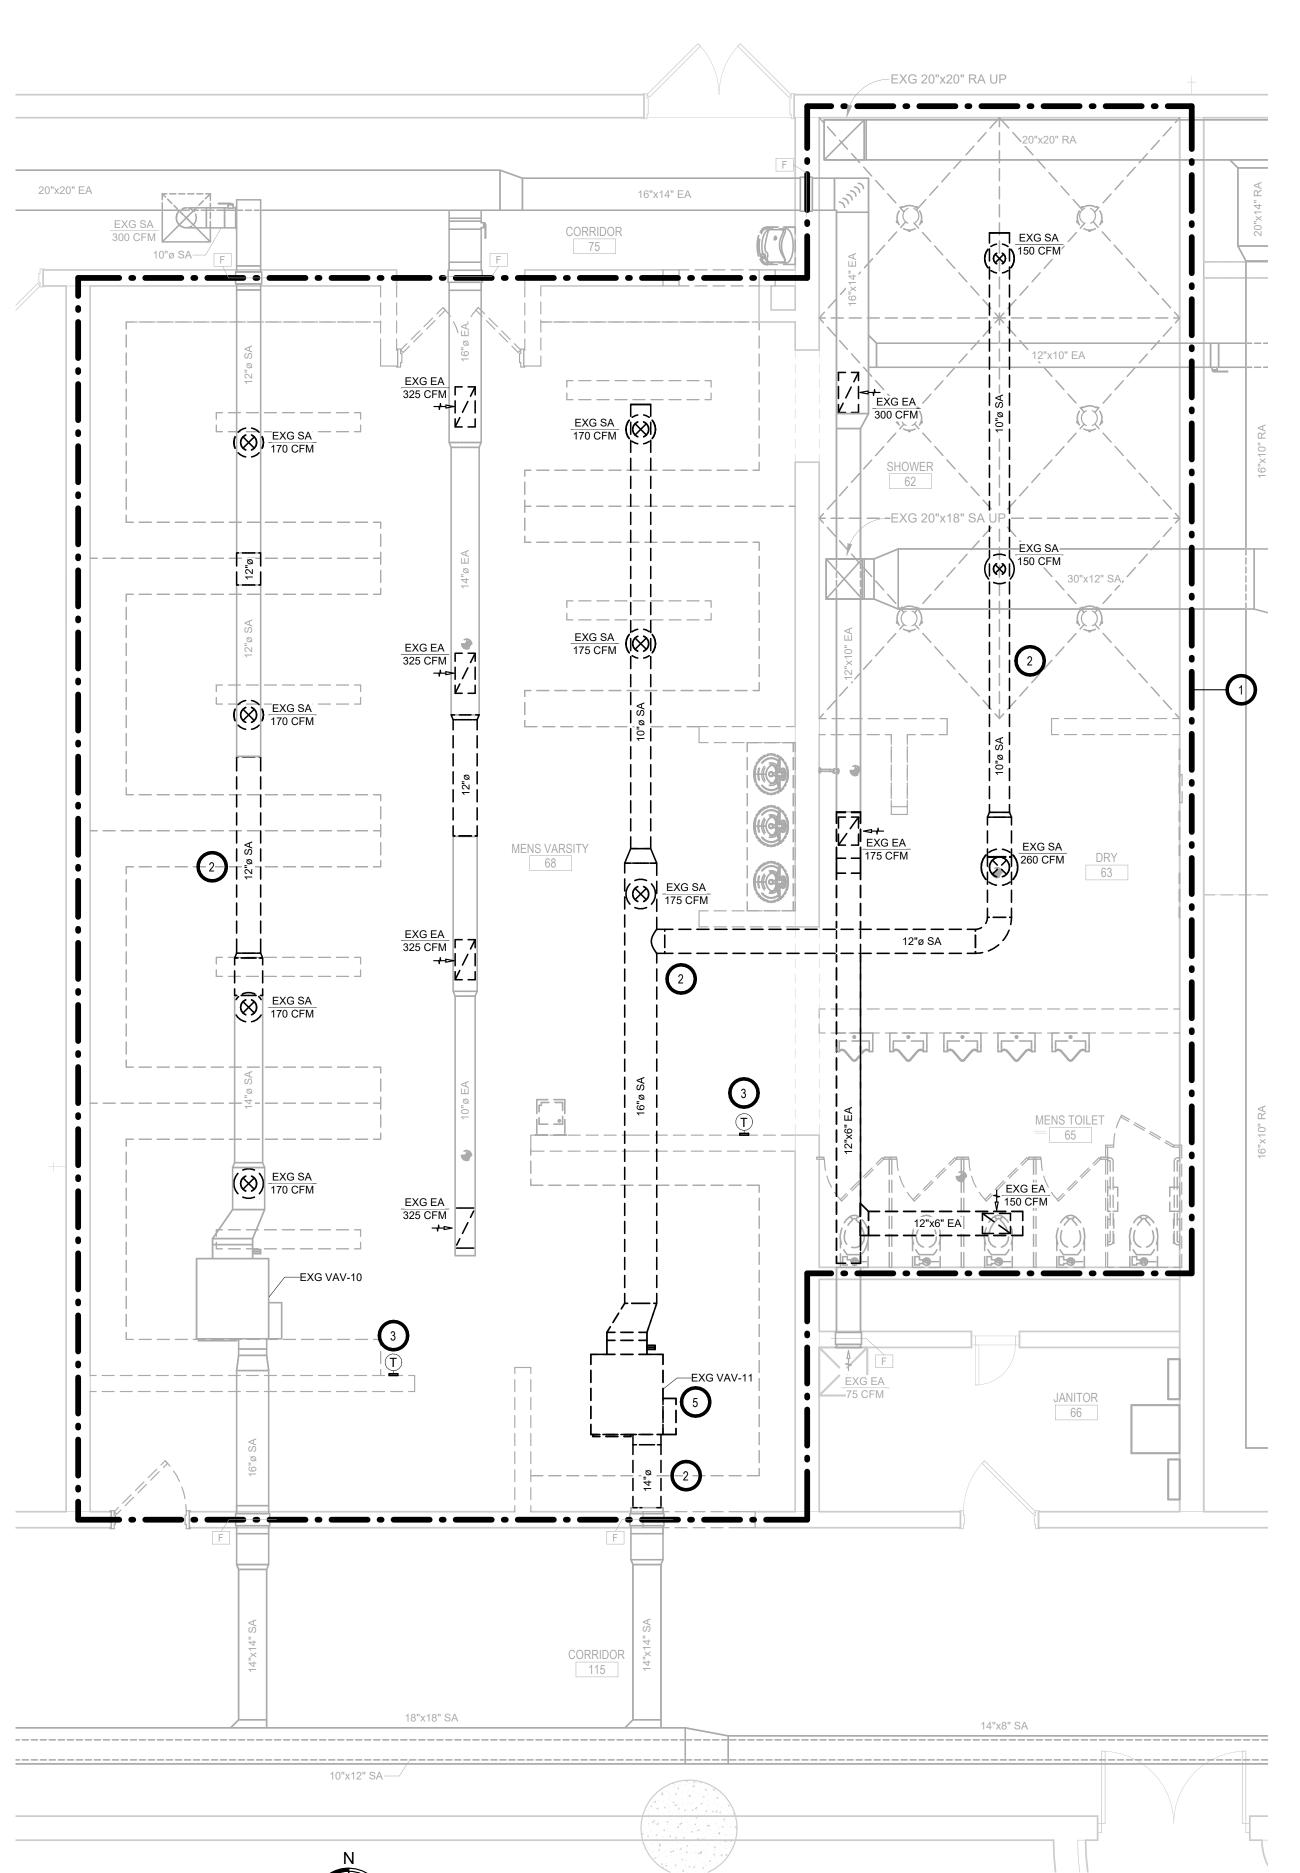

FIRST FLOOR - HVAC DEMOLITION PLAN - WRESTLING & BASEBALL 1/4" = 1'-0"

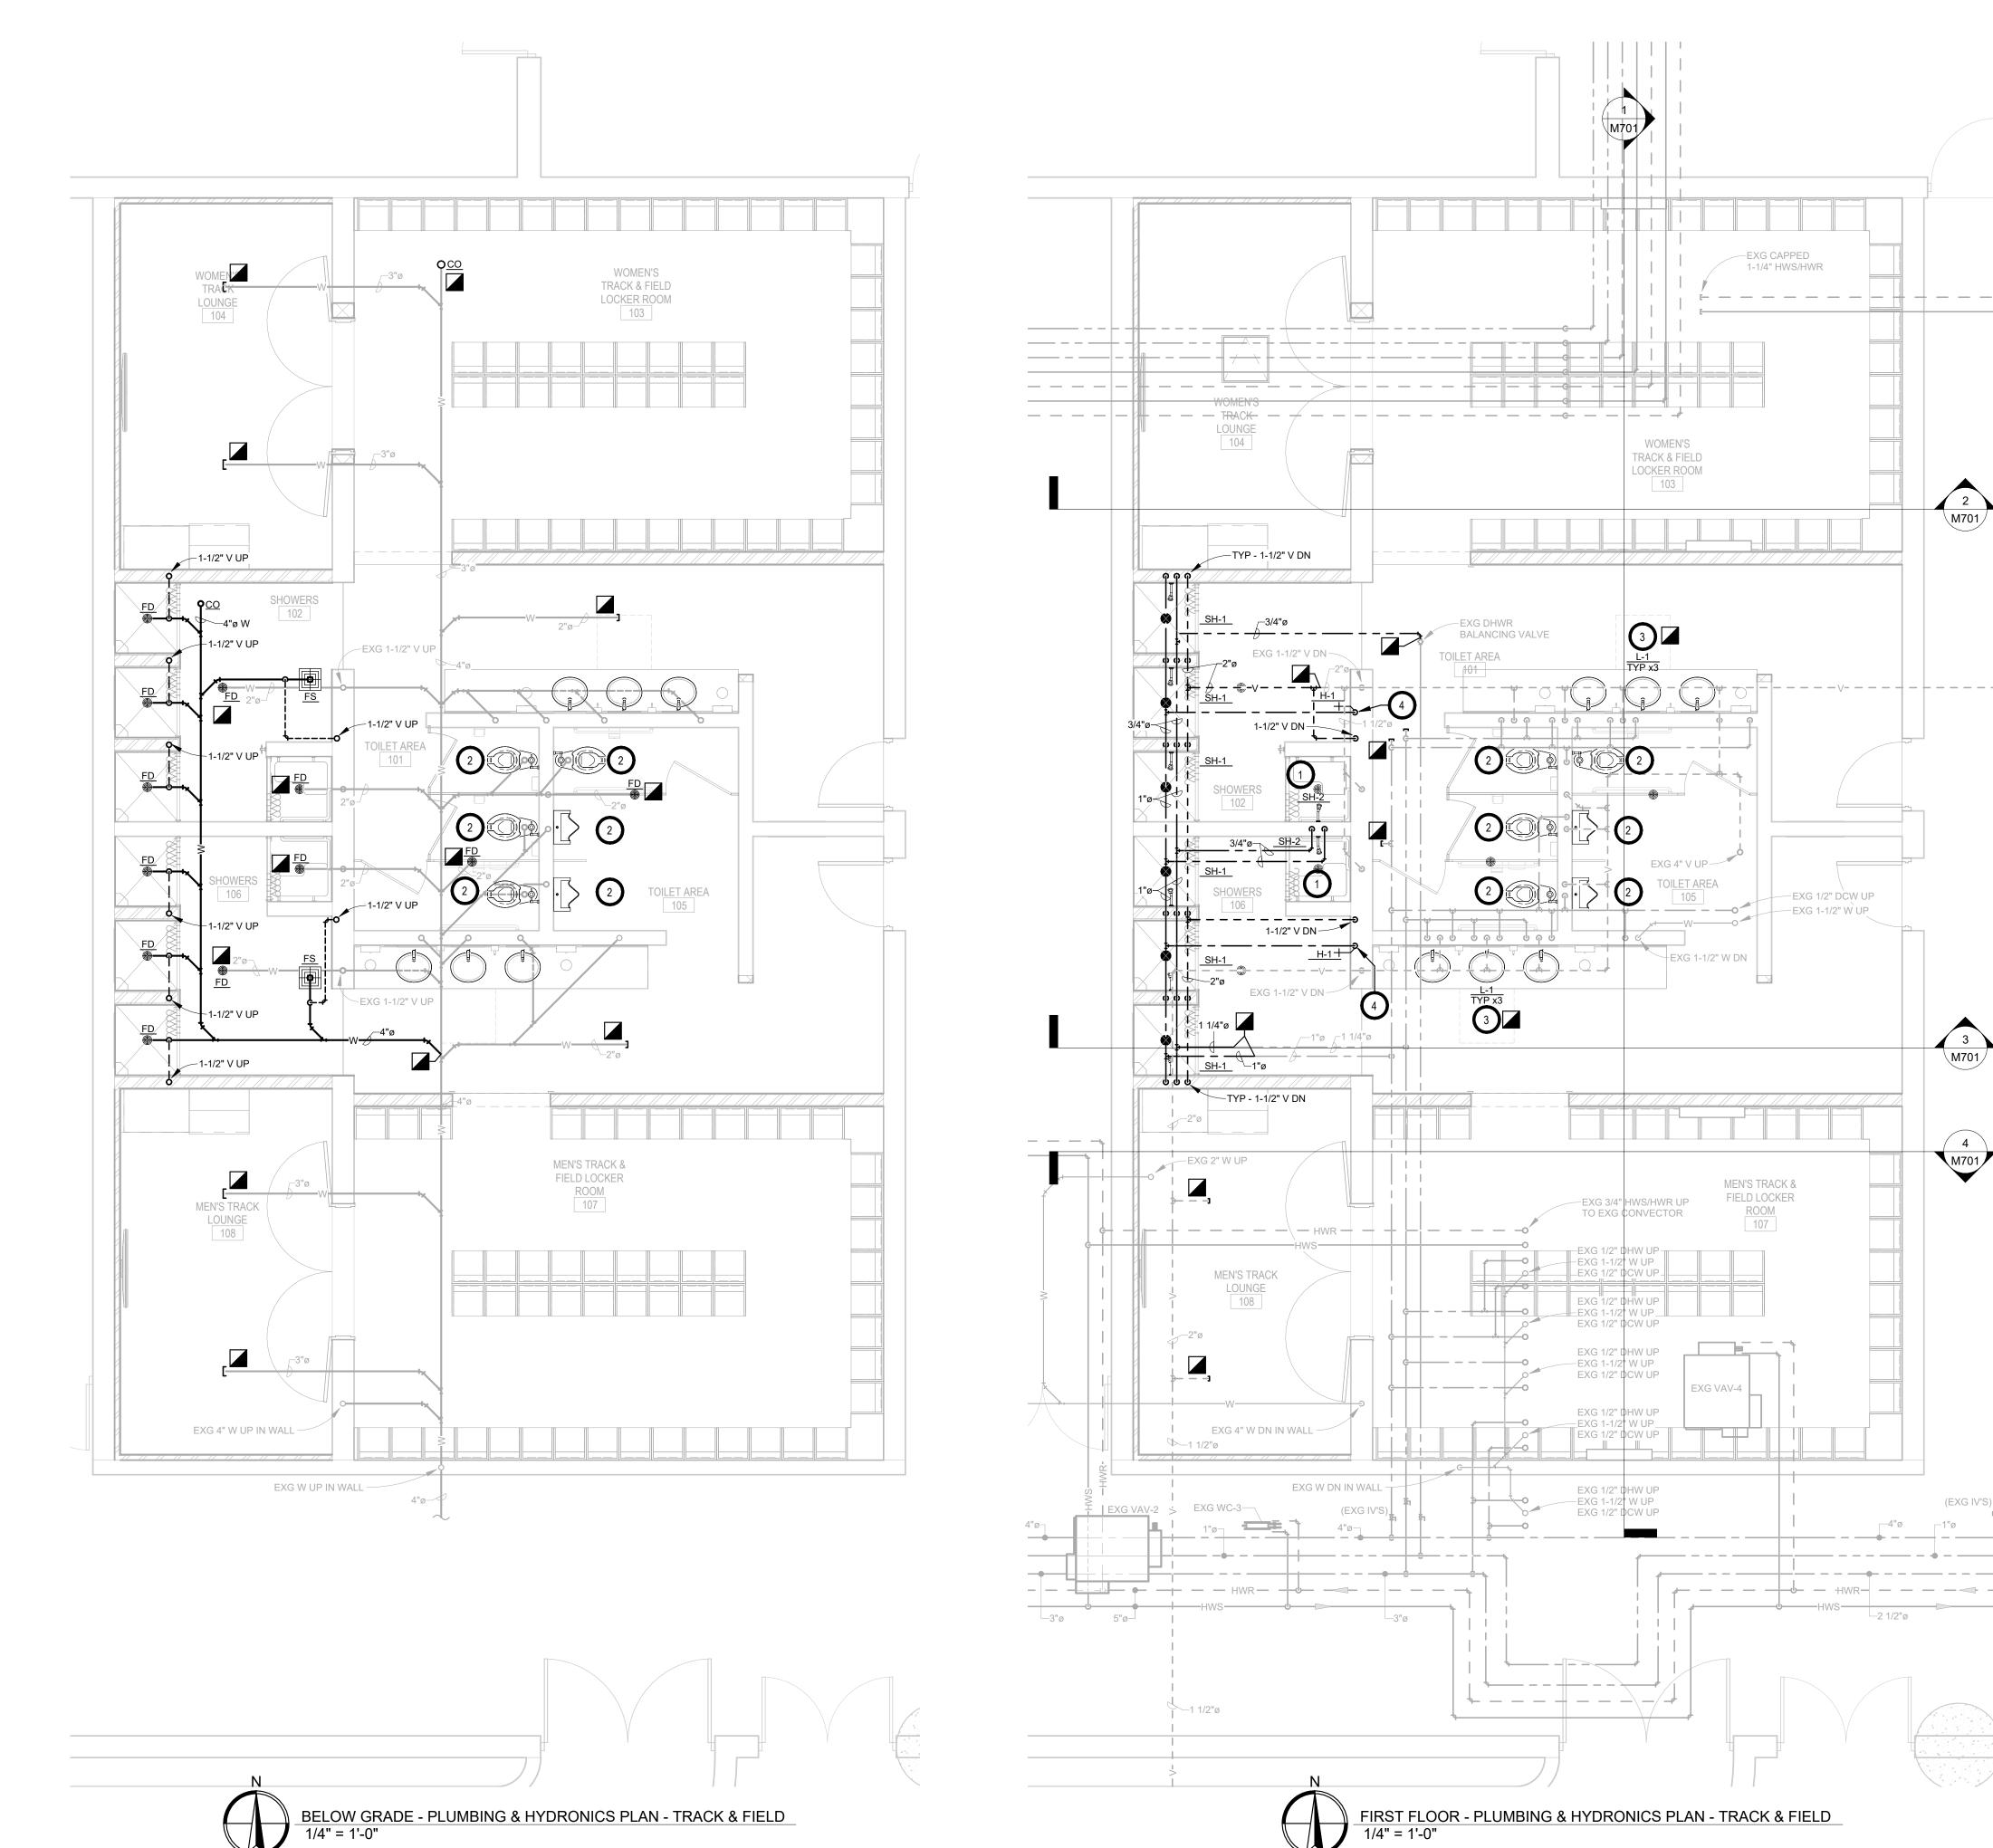

A. ALL WORK SHALL BE PERFORMED IN A CLEAN AND WORKMANLIKE MANNER.

B. THE MECHANICAL CONTRACTOR SHALL BE RESPONSIBLE FOR PATCHING ANY OPENINGS LEFT IN FLOORS, WALLS, AND CEILINGS THAT WERE CAUSED BY HIS/HER ACTIONS. PATCHING SHALL MATCH EXISTING SURFACE IN COLOR, TEXTURE AND QUALITY SO THAT PATCH IS INDISTINGUISHABLE FROM ORIGINAL SURFACE.

C. ALL PENETRATIONS THROUGH DRAFT STOPS AND OTHER FIRE-RATED PARTITIONS SHALL BE FIRE STOPPED AS PER SPECIFICATIONS AND LOCAL CODES.

D. ALL MECHANICAL WORK SHALL BE INSTALLED IN STRICT ACCORDANCE WITH ALL APPLICABLE LOCAL, STATE, NATIONAL PLUMBING REGULATIONS, AND THE AUTHORITY HAVING JURISDICTION.

E. THE MECHANICAL DRAWINGS SHOW GENERAL ARRANGEMENT ONLY. EXACT LOCATION SHALL AVOID INTERFERENCE WITH ELECTRICAL EQUIPMENT & REQUIRED ELECTRICAL CLEARANCES.

F. CONTRACTOR SHALL COORDINATE ALL PLUMBING WITH LIGHT FIXTURES, HVAC, FIRE SPRINKLER, AND STRUCTURAL TO ACCOMMODATE LIMITED CEILING SPACE.

G. FRESH AIR INTAKES TO BE MINIMUM 10' FROM ANY EXHAUST TERMINATION.

H. ALL FLOOR EQUIPMENT SHALL BE SET ON 4" HIGH CONCRETE BASES FURNISHED BY THIS CONTRACTOR.

I. CONTRACTOR SHALL VISIT THE SITE AND VERIFY ALL EXISTING CONDITIONS AND DIMENSIONS. NOTIFY THE A/E IMMEDIATELY OF ANY DISCREPANCIES.

J. COORDINATE NEW SERVICES WITH LOCAL UTILITIES.

K. PLUMBING CONTRACTOR TO PROVIDE VENTING FOR ALL FLOOR DRAINS, TRENCH DRAINS, AND FLOOR SINKS AS SHOWN OR AS REQUIRED BY CODE.


O KEYNOTES


- 1. PC TO PROVIDE & INSTALL NEW HOT AND COLD WATER ROUGH INS AND NEW TEMPERED WATER BETWEEN NEW SHOWER VALVE AND HEAD. INSTALL ALL VALVES AT ELEVATIONS AS PER PLUMBING FIXTURE SCHEDULE TO MEET ADA REQUIREMENTS. ROUTE PIPING TO ACCOMMODATE PROPOSED VALVE AND HEAD LOCATIONS. BLOCK PATCHING BY GC, COORDINATE REQUIRED CONCRETE BLOCK WALL PATCHING WITH GC TO ACCOMMODATE NEW PIPING, VALVES, AND HEAD IN EXISTING BLOCK WALL.
- 2. PC TO REINSTALL EXG PLUMBING FIXTURE & CONNECT TO EXG DOMESTIC, VENT & WASTE PIPING. REINSTALL URINALS AT EXISTING HEIGHTS.
- 3. PC TO INSTALL NEW LAVS/ROUGH INS AT NEW LOCATIONS. EXTEND DCW, DHW, & WASTE PIPING WITHIN EXISTING BLOCK WALL. BLOCK PATCHING BY GC, COORDINATE REQUIRED CONCRETE BLOCK WALL PATCHING WITH GC TO ACCOMMODATE NEW PIPING/ROUGH INS AT NEW LOCATIONS IN EXISTING BLOCK WALL.
- 4. PC TO INSTALL 3/4" DCW DOWN TO H-1 INSTALLED AT 48" AFF (CONFIRM DESIRED HEIGHT WITH OWNER PRIOR TO ROUGH IN). PIPING TO BE ROUTED WITHIN EXISTING BLOCK WALL. BLOCK PATCHING BY GC, COORDINATE REQUIRED CONCRETE BLOCK WALL PATCHING WITH GC TO ACCOMMODATE NEW PIPING IN EXISTING WALL.

SPECIAL NOTES

(EXG IV'S)

- A. ALL MECHANICAL SYSTEMS, EXCLUDING DROPS, TO BE INSTALLED AS HIGH AS POSSIBLE TO PROVIDE MAXIMUM CLEARANCES FOR OWNER.
- B. FLOOR DRAINS & SINK LOCATIONS SHALL BE INSTALLED IN LOCATIONS PROPER TO ACCEPT INDIRECT DRAIN PIPING FROM BOILERS, WATER HEATER, RELIEFS, ETC. (TRIP HAZARDS FROM PIPING WILL NOT BE ACCEPTABLE).
- C. ALL FLOOR CLEANOUTS TO BE LOCATED IN INCONSPICUOUS LOCATIONS. CLEANOUTS LOCATED IN DOORWAYS AND MIDDLE OF HALLWAYS WILL NOT BE ACCEPTABLE.

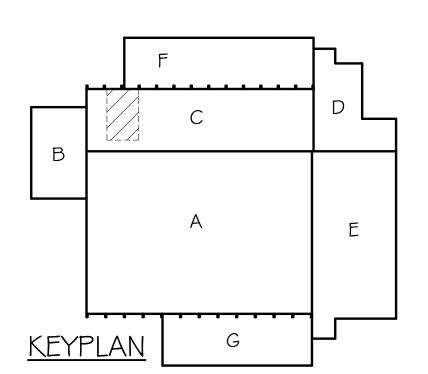

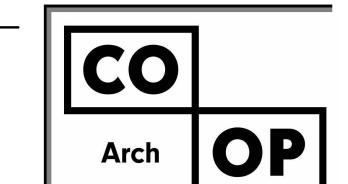

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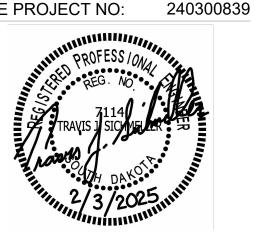
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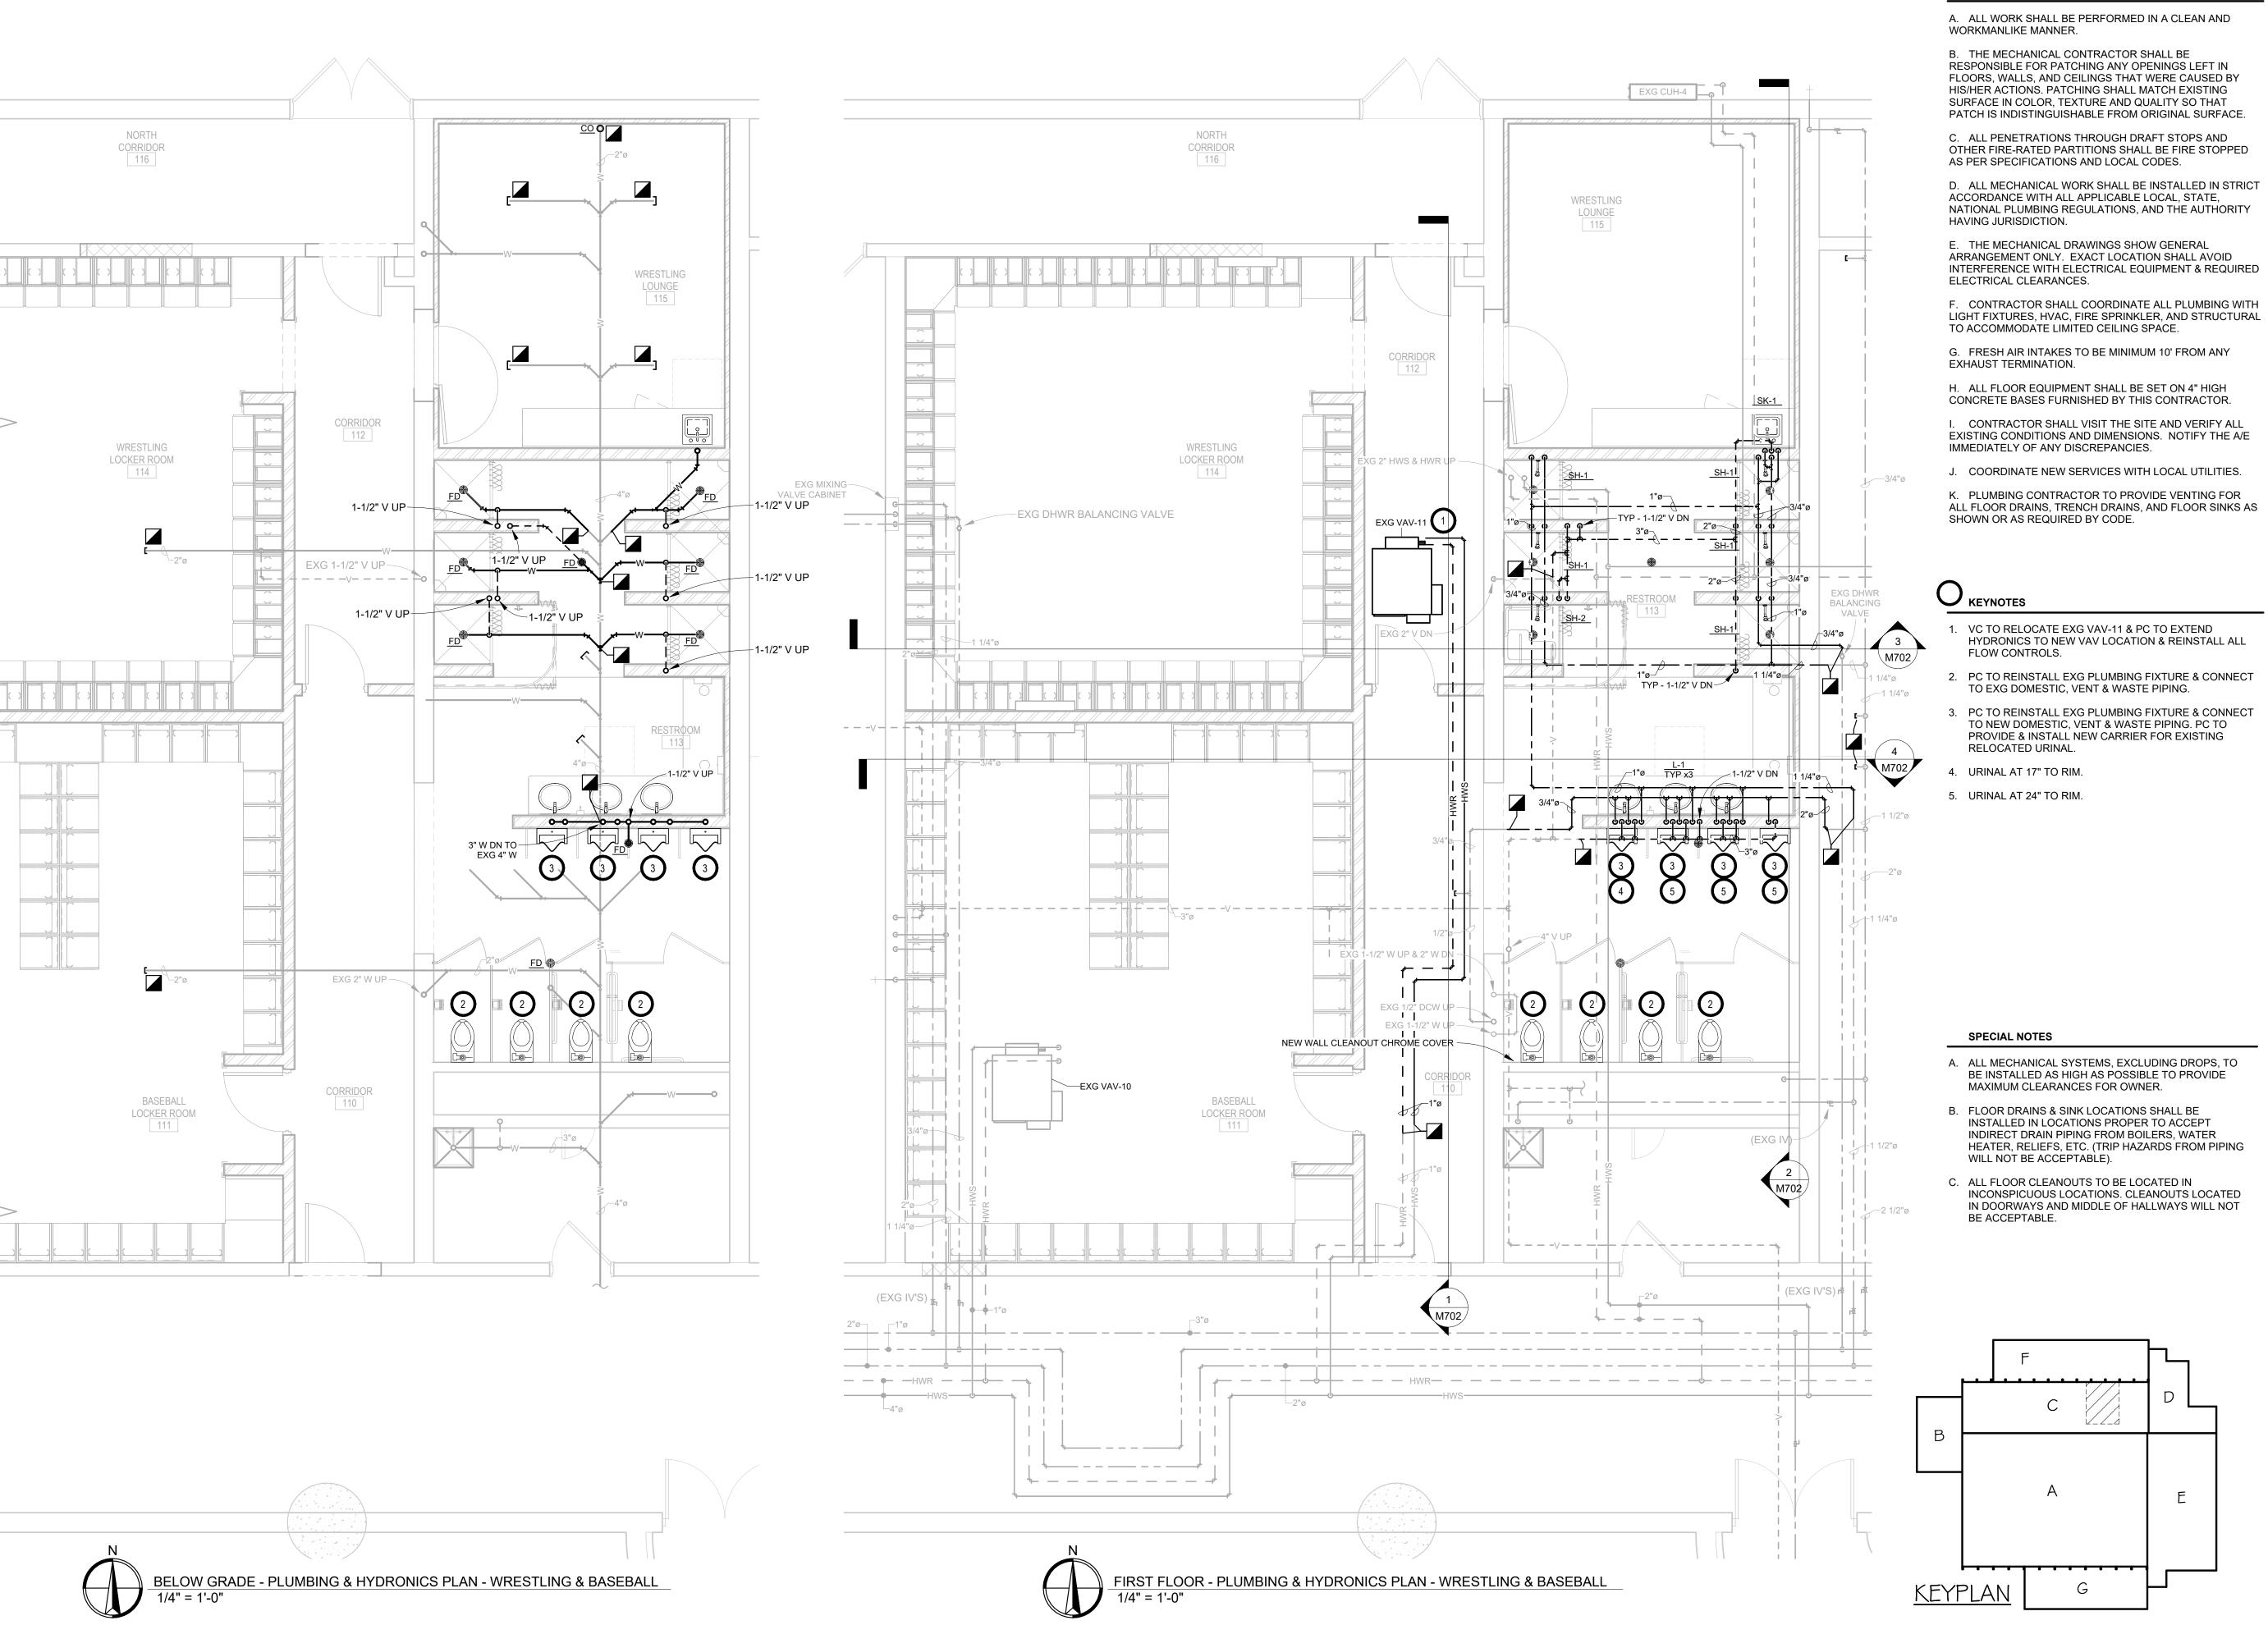
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PROJECT:

NSU - BARNETT CENTER - LOCKER ROOM UPGRADES OSE # RO124--16X NORTHERN STATE UNIVERSITY ABERDEEN, SOUTH DAKOTA


SHEET TITLE:

TRACK & FIELD - PLUMBING & HYDRONICS PLAN



- C. ALL PENETRATIONS THROUGH DRAFT STOPS AND OTHER FIRE-RATED PARTITIONS SHALL BE FIRE STOPPED
- NATIONAL PLUMBING REGULATIONS, AND THE AUTHORITY
- INTERFERENCE WITH ELECTRICAL EQUIPMENT & REQUIRED
- LIGHT FIXTURES, HVAC, FIRE SPRINKLER, AND STRUCTURAL
- EXISTING CONDITIONS AND DIMENSIONS. NOTIFY THE A/E

- HYDRONICS TO NEW VAV LOCATION & REINSTALL ALL
- 2. PC TO REINSTALL EXG PLUMBING FIXTURE & CONNECT

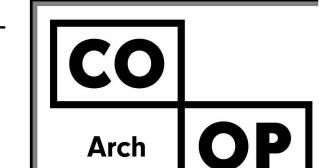

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INCONSPICUOUS LOCATIONS. CLEANOUTS LOCATED IN DOORWAYS AND MIDDLE OF HALLWAYS WILL NOT

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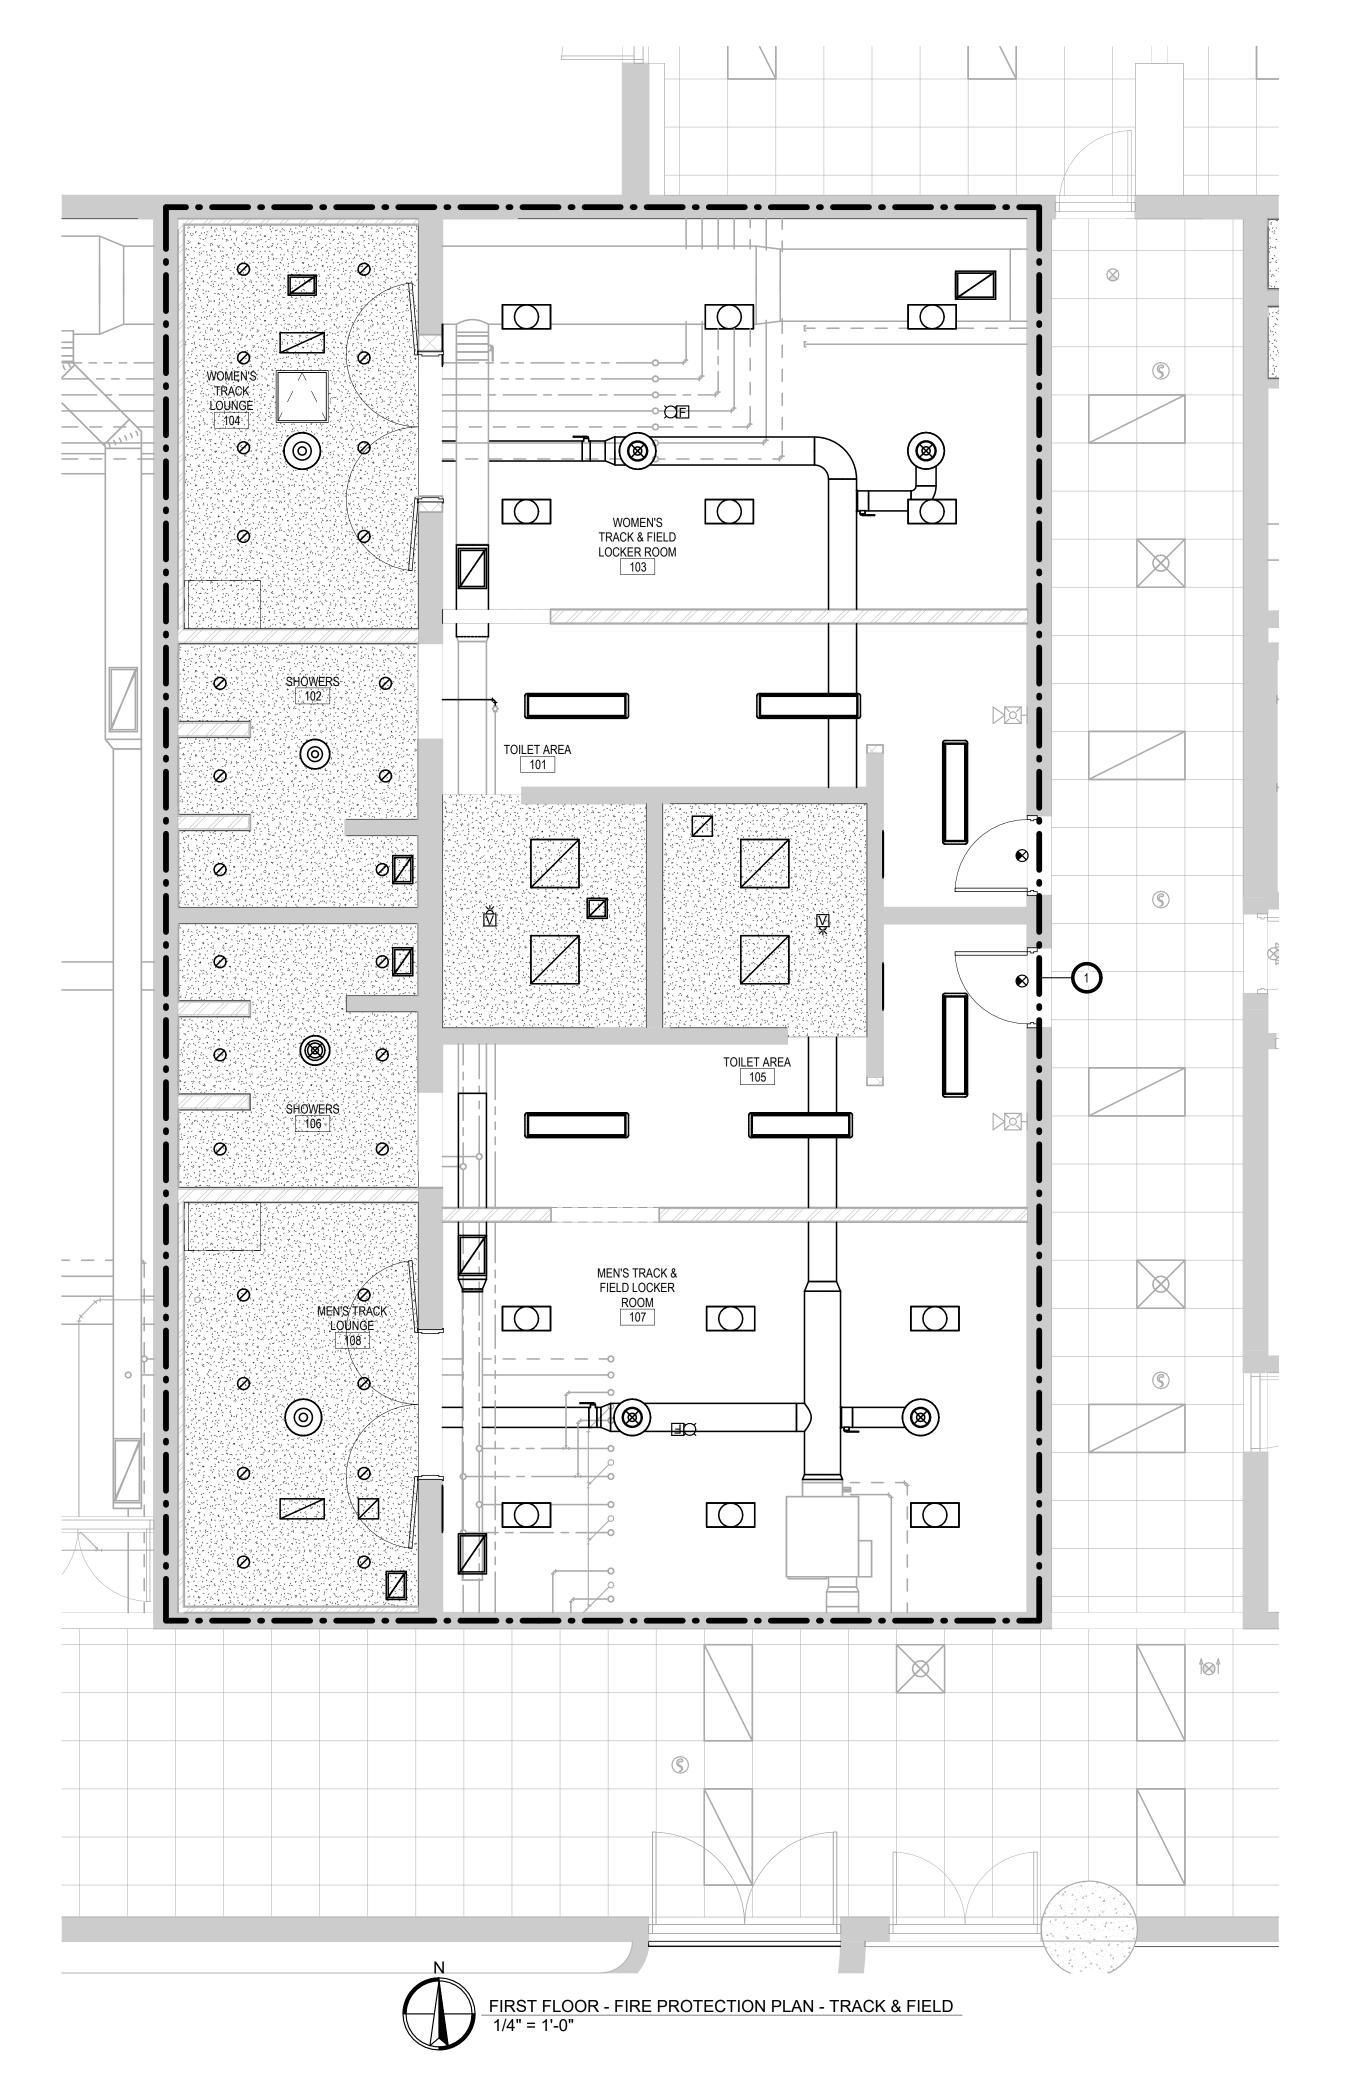
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PROJECT:

NSU - BARNETT CENTER - LOCKER ROOM UPGRADES OSE # RO124--16X NORTHERN STATE UNIVERSITY ABERDEEN, SOUTH DAKOTA

SHEET TITLE:

WRESTLING & BASEBALL -PLUMBING & HYDRONICS PLAN



FIRE PROTECTION GENERAL NOTES:

- A. THE ENTIRE BUILDING SHALL CONTINUE TO BE PROTECTED BY A COMPLETE AUTOMATIC WET (INTERIOR BUILDING) FIRE SPRINKLER SYSTEM AS PER NFPA 13 AND LOCAL CODES. PIPING SIZES SHALL BE PROVED BY HYDRAULIC CALCULATIONS & IN COMPLIANCE WITH NFPA, LOCAL AUTHORITIES, AUTHORITIES HAVING JURISDICTION, AND THE BUILDING OWNER.
- B. SPRINKLER HEADS IN THE FINISHED CEILING SHALL BE **CHROME SEMI-RECESSED TYPE**. CENTER HEADS IN CEILING TILE WHERE APPLICABLE. CONTRACTOR SHALL REFER TO ARCHITECTS REFLECTED CEILING PLAN FOR CEILING INSTALLATION & HEIGHTS.
- C. PLANS AND HYDRAULIC CALCULATIONS TO BE PREPARED BY OR CHECKED BY A NICET LEVEL III OR IV TECHNICIAN. PIPING SIZES SHALL BE PROVED BY HYDRAULIC CALCULATIONS. THE SPRINKLER PLANS AND HYDRAULIC CALCULATIONS MUST BE SUBMITTED TO THE FOLLOWING AUTHORITIES HAVING JURISDICTION FOR REVIEW:

SICHMELLER ENGINEERING ATTN: TRAVIS SICHMELLER 801 RAILROAD AVE SE

ABERDEEN, SD 57401

ABERDEEN FIRE MARSHALL ATTN: MAX STOLTENBURG 111 2ND AVE SE ABERDEEN, SD 57401

CITY OF ABERDEEN
PLANNING AND ZONING
123 S. LINCOLN
ABERDEEN, SD 57401

OFFICE OF THE STATE ENGINEER ATTN: SEAN CAMPBELL 523 EAST CAPITOL AVE PIERRE, SD 57501-3182

- D. COORDINATE INSTALLATION REQUIREMENTS WITH OTHER TRADES. PROVIDE DESIGN & INSTALLATION OF A COMPLETE FIRE PROTECTION SYSTEM.
- E. AFTER COMPLETION OF PROJECT, AS-BUILTS AND REQUIRED TESTING/TEST CERTIFICATE SHALL BE SUBMITTED TO AUTHORITIES LISTED ABOVE.
- F. FIRE PROTECTION SYSTEM SHALL NOT BE INTERRUPTED DURING TIMES WHEN THE BUILDING IS OCCUPIED. IF INTERRUPTING EXISTING FIRE PROTECTION SYSTEM, NOTIFY THE BUILDING OWNER OF THE TIME AND DURATION OF THE FIRE PROTECTION WORK. DO NOT LEAVE THE SYSTEM INOPERABLE OVERNIGHT.
- G. AS LONG AS FIELD CONDITIONS ALLOW, THIS CONTRACTOR SHALL INSTALL ALL MAIN PIPING AND BRANCH PIPING A MINIMUM OF 12" ABOVE FINISHED CEILING HEIGHT OR GREATER AS REQUIRED BY FIELD CONDITIONS.
- H. THIS CONTRACTOR SHALL COORDINATE WITH ALL TRADES INCLUDING CEILING CONTRACTOR, ELECTRICAL CONTRACTOR, VENTILATION CONTRACTOR, PLUMBING CONTRACTOR, BEFORE FABRICATION AND INSTALLATION.
- I. AT NO TIME SHALL THE DROPS BE INSTALLED WITHOUT COORDINATION WITH THE CEILING CONTRACTOR.

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FIRE PROTECTION KEYNOTES:

AREA WITHIN DASHED BOLD OUTLINE - MODIFY THE EXISTING FIRE SPRINKLER SYSTEM INSTALLED AS REQUIRED FOR DEMOLITION & PROPOSED WORK. ORIGINAL FIRE SPRINKLER PLANS ARE AVAILABLE FROM ENGINEER'S OFFICE. FIRE SPRINKLER CONTRACTOR TO REPLACE ANY REMAINING EXISTING FIRE SPRINKLER HEADS SUCH THAT THE AREA OUTLINED WILL BE UPDATED. ADD/EXTEND BRANCH RUNOUTS PIPING & ADD PENDANTS & UPRIGHTS AS REQUIRED TO PROVIDE COVERAGE PER NFPA 13 BASED ON NEW WALLS.

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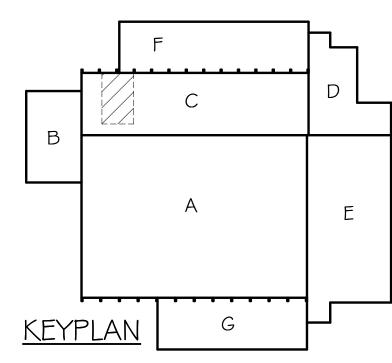
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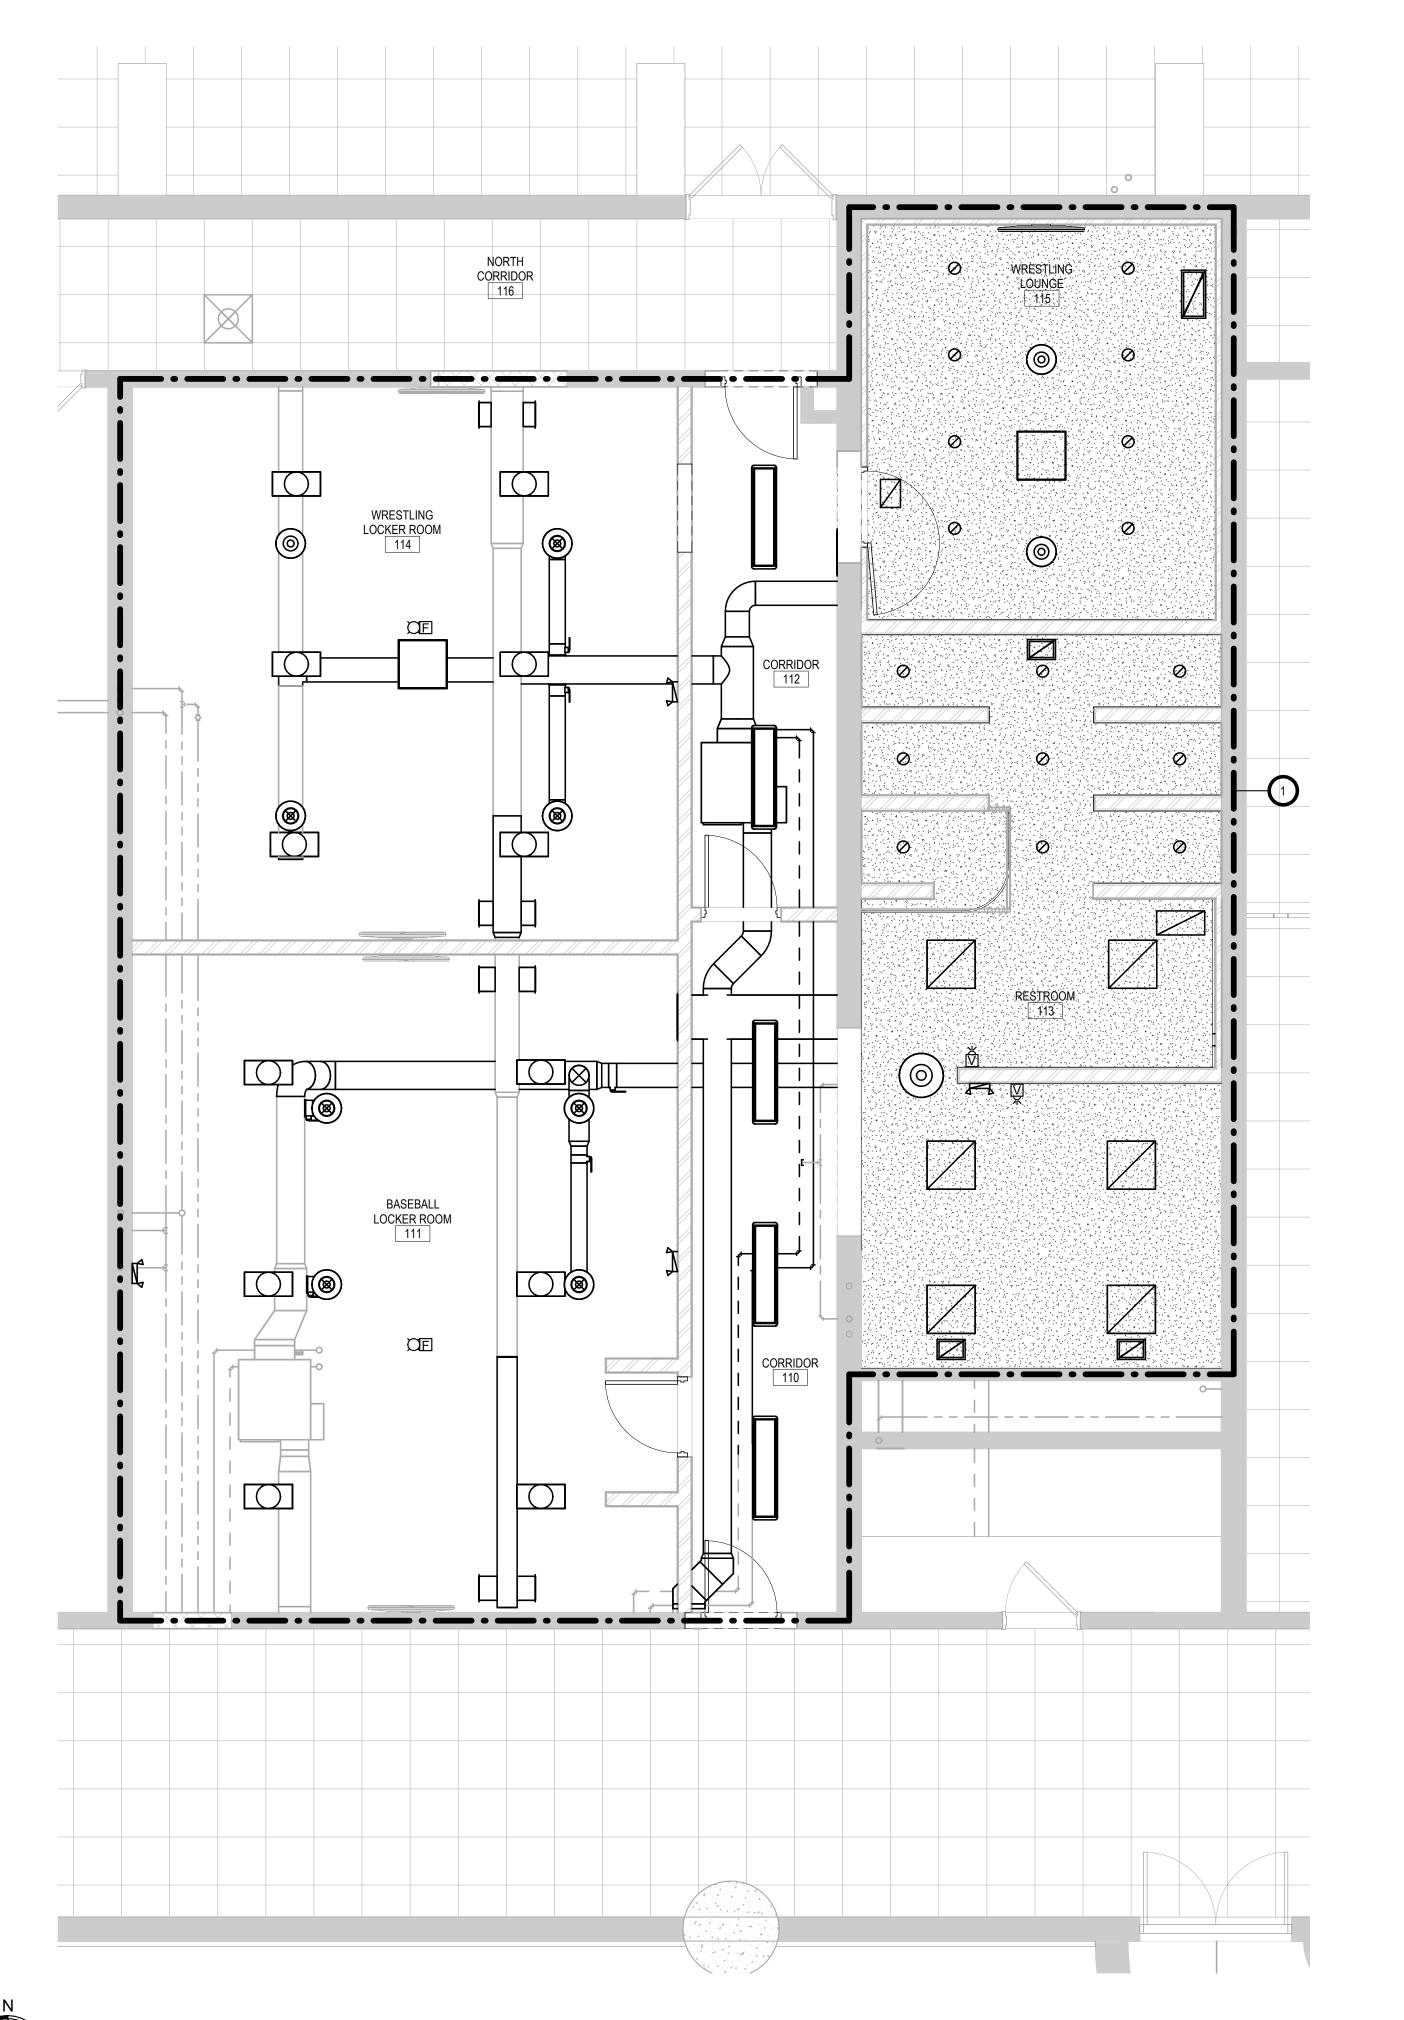


PROJECT:

NSU - BARNETT CENTER - LOCKER ROOM UPGRADES OSE # RO124--16X NORTHERN STATE UNIVERSITY ABERDEEN, SOUTH DAKOTA

SHEET TITLE:

TRACK & FIELD - FIRE PROTECTION PLAN



FIRE PROTECTION GENERAL NOTES:

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ATTN: TRAVIS SICHMELLER ATT
801 RAILROAD AVE SE 111
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- I. AT NO TIME SHALL THE DROPS BE INSTALLED WITHOUT COORDINATION WITH THE CEILING CONTRACTOR.

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AREA WITHIN DASHED BOLD OUTLINE - MODIFY THE EXISTING FIRE SPRINKLER SYSTEM INSTALLED AS REQUIRED FOR DEMOLITION & PROPOSED WORK. ORIGINAL FIRE SPRINKLER PLANS ARE AVAILABLE FROM ENGINEER'S OFFICE. FIRE SPRINKLER CONTRACTOR TO REPLACE ANY REMAINING EXISTING FIRE SPRINKLER HEADS SUCH THAT THE AREA OUTLINED WILL BE UPDATED. ADD/EXTEND BRANCH RUNOUTS PIPING & ADD PENDANTS & UPRIGHTS AS REQUIRED TO PROVIDE COVERAGE PER NFPA 13 BASED ON NEW WALLS.

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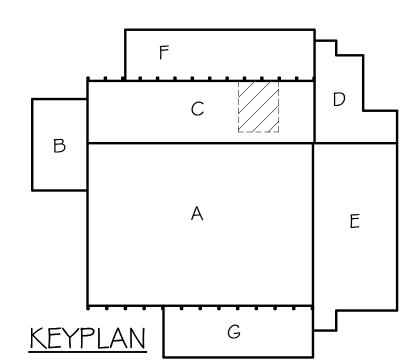
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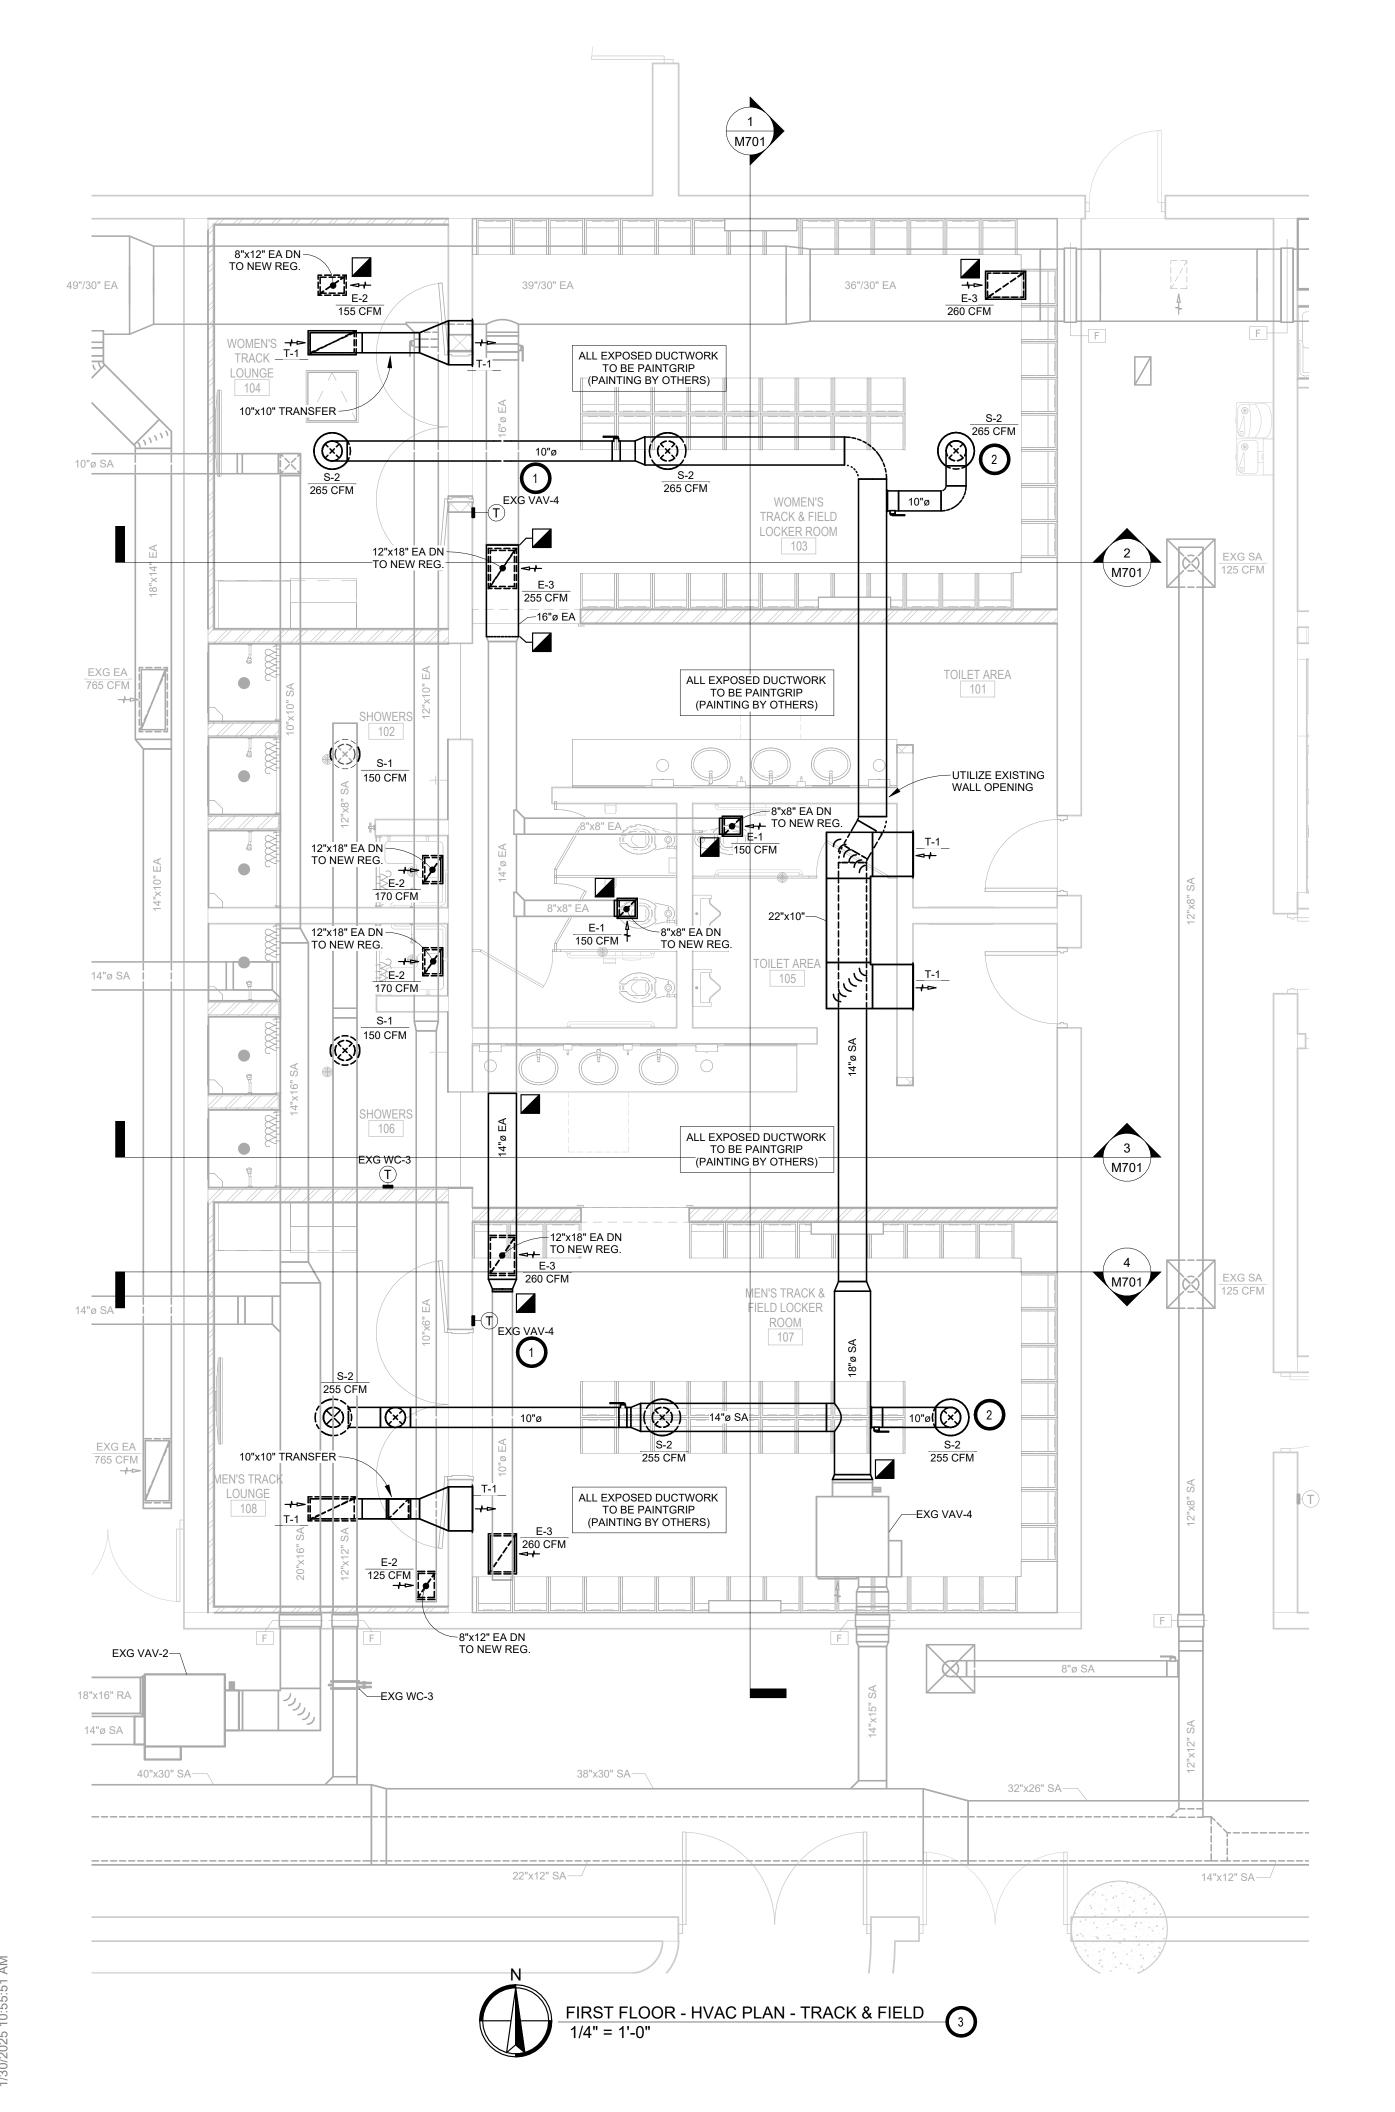


PROJECT:

NSU - BARNETT CENTER - LOCKER ROOM UPGRADES OSE # RO124--16X NORTHERN STATE UNIVERSITY ABERDEEN, SOUTH DAKOTA

SHEET TITLE:

WRESTLING & BASEBALL - FIRE PROTECTION PLAN



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- B. THE MECHANICAL CONTRACTOR SHALL BE RESPONSIBLE FOR PATCHING ANY OPENINGS LEFT IN FLOORS, WALLS, AND CEILINGS THAT WERE CAUSED BY HIS/HER ACTIONS. PATCHING SHALL MATCH EXISTING SURFACE IN COLOR, TEXTURE AND QUALITY SO THAT PATCH IS INDISTINGUISHABLE FROM ORIGINAL SURFACE.
- C. ALL PENETRATIONS THROUGH DRAFT STOPS AND OTHER FIRE-RATED PARTITIONS SHALL BE FIRE STOPPED AS PER SPECIFICATIONS AND LOCAL CODES.
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- E. THE MECHANICAL DRAWINGS SHOW GENERAL ARRANGEMENT ONLY. EXACT LOCATION SHALL AVOID INTERFERENCE WITH ELECTRICAL EQUIPMENT & REQUIRED ELECTRICAL CLEARANCES.
- F. COORDINATE INSTALLATION OF ALL HVAC WITH PLUMBING, FIRE SPRINKLER, LIGHT FIXTURES, AND STRUCTURE TO ACCOMMODATE LIMITED CEILING SPACE.
- G. FOR SIMPLICITY DUCT INSULATION NOT SHOWN, DUCT SIZES INDICATED ON DRAWING ARE INTERNAL DIMENSIONS. AS NEEDED ADJUST ACTUAL SIZE FOR INSULATION THICKNESS AS SPECIFIED.
- H. ALL FLEXIBLE DUCTWORK AND CONNECTORS
 BETWEEN THE LOW PRESSURE DUCTWORK AND THE
 DIFFUSERS SHALL BE THE SIZE OF THE DIFFUSER INLET.
- I. PROVIDE & INSTALL VIBRATION ISOLATION ON ALL HANGING EQUIPMENT. PROVIDE & INSTALL VIBRATION ABSORPTION MOUNTING PADS ON ALL EQUIPMENT MOUNTED ON FLOOR.
- J. PROVIDE AND INSTALL DURODINE FLEX DUCT CONNECTORS AT ALL EQUIPMENT CONNECTIONS.
- K. ALL DUCTWORK TO BE SEALED AIRTIGHT.
- H. FRESH AIR INTAKES TO BE MINIMUM 10' FROM ANY EXHAUST TERMINATION.
- I. ALL FLOOR EQUIPMENT SHALL BE SET ON 4" HIGH CONCRETE BASES FURNISHED BY THIS CONTRACTOR.

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KEYNOTES:

- TC TO INSTALL NEW T-STAT AS SHOWN. UTILIZE T-STATS IN ROOMS 103 & 107 FOR TEMPERATURE AVERAGING CONTROL OF EXG VAV-4.
- 2. TYP SEE TYPICAL DIFFUSER CONNECTION DETAIL.
- 3. VC TO COORDINATE DUCTWORK, VAV, & DIFFUSER ELEVATIONS WITH EC. DIFFUSER ELEVATIONS TO MATCH LIGHT FIXTURES. MAXIMIZE DUCTWORK ELEVATIONS WHERE POSSIBLE.

SE PROJECT NO: 240300839 PROFESS/ONAL TRAVIS I SICMEDIA TRAVIS I SICMEDIA AND DAKO PROFESS/ONAL TO DAKO P

SPECIAL NOTES:


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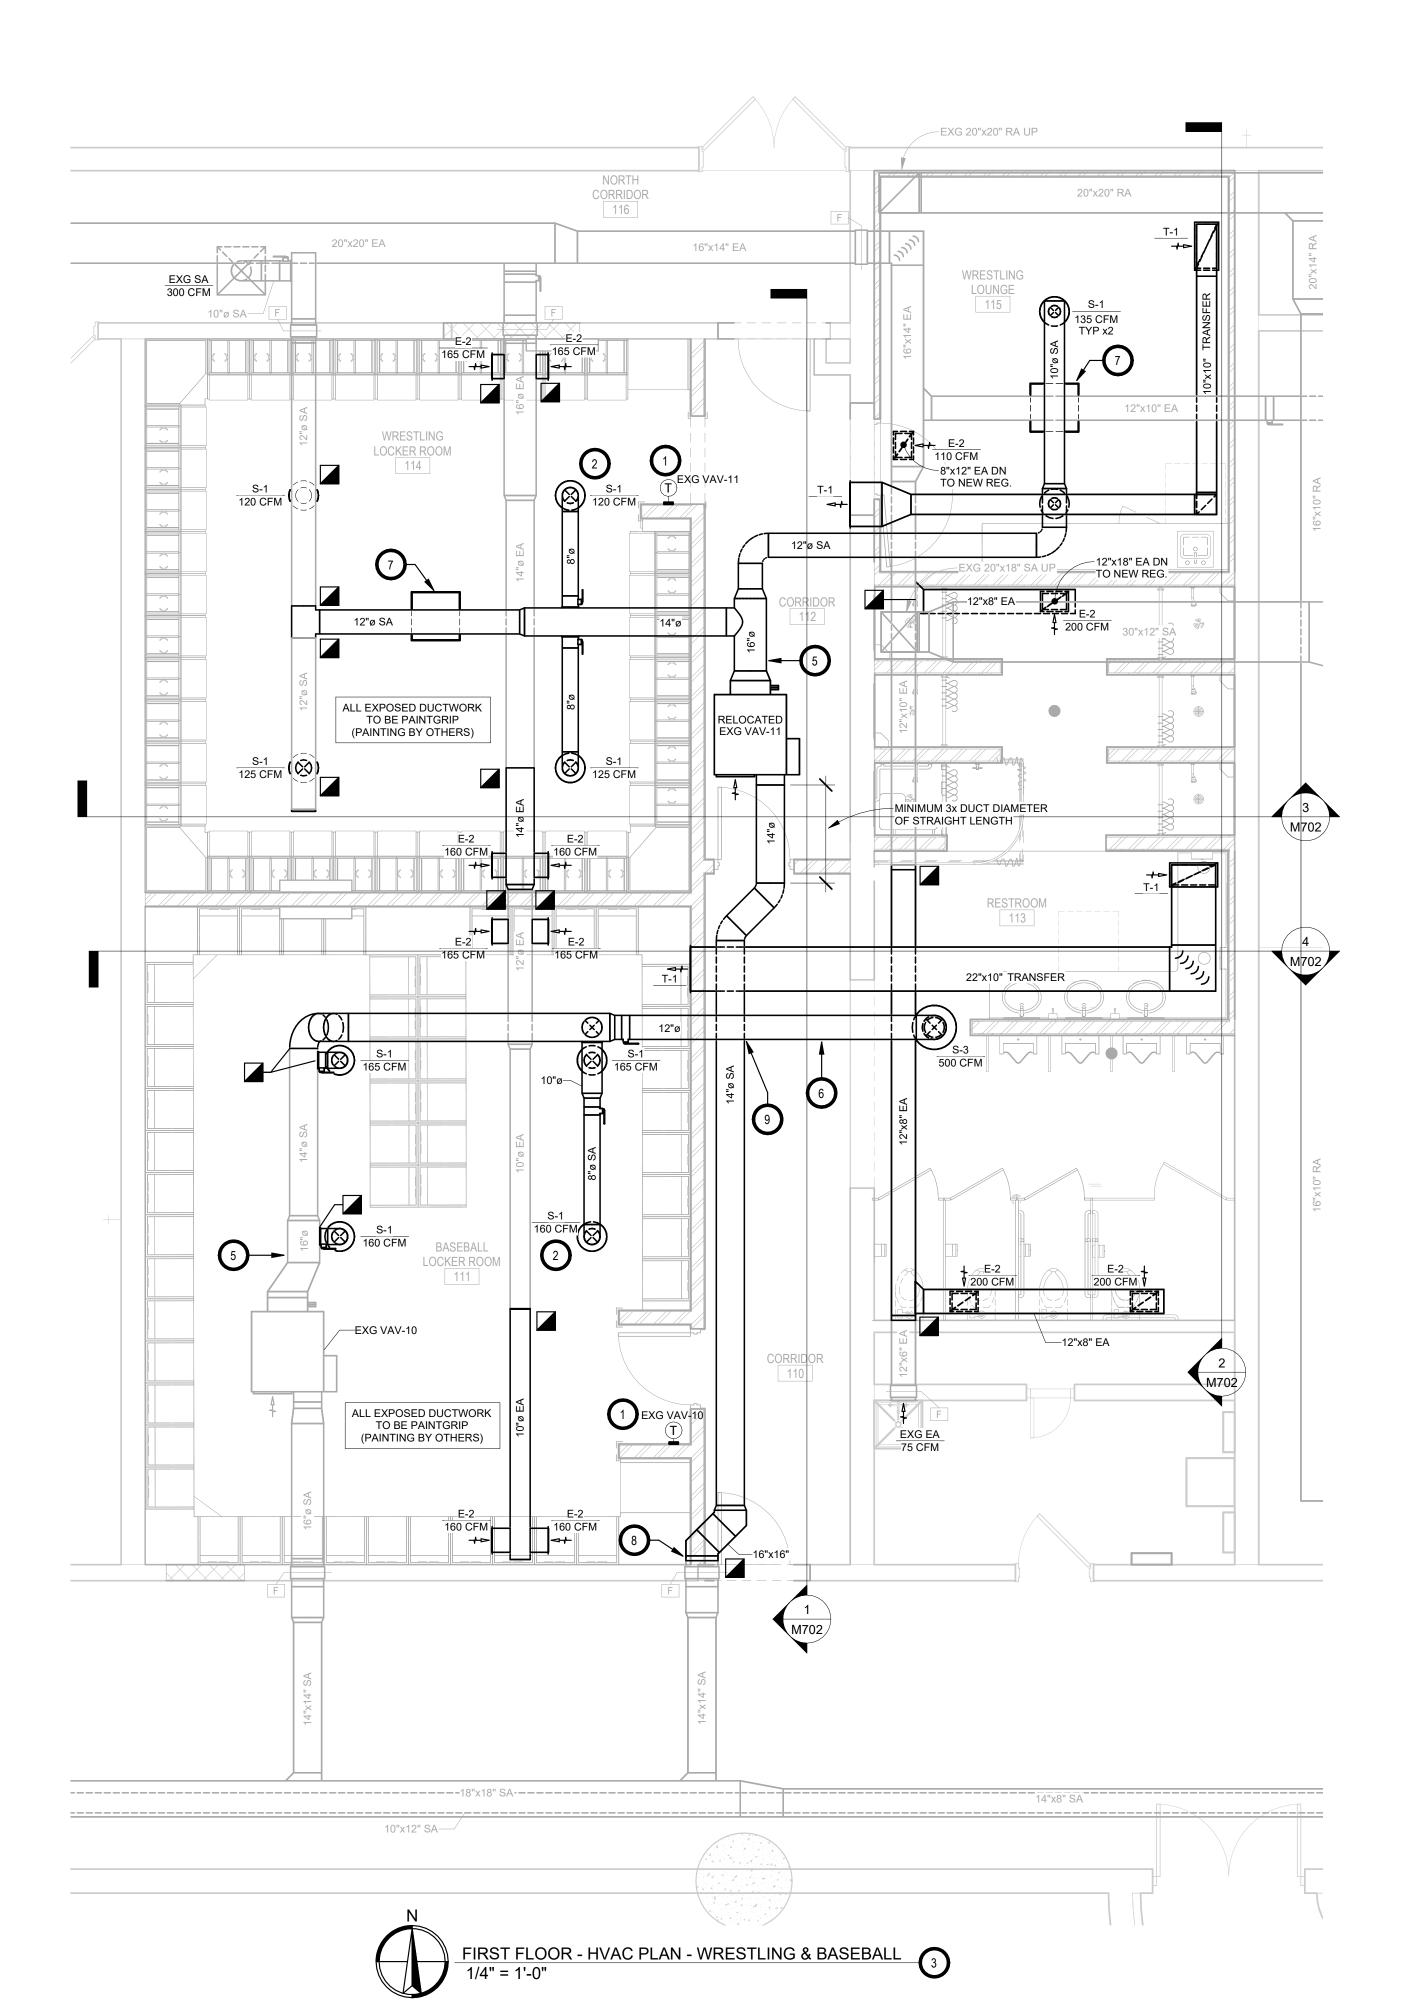


PROJECT:

NSU - BARNETT CENTER - LOCKER ROOM UPGRADES OSE # RO124--16X NORTHERN STATE UNIVERSITY ABERDEEN, SOUTH DAKOTA

SHEET TITLE:

TRACK & FIELD - HVAC PLAN

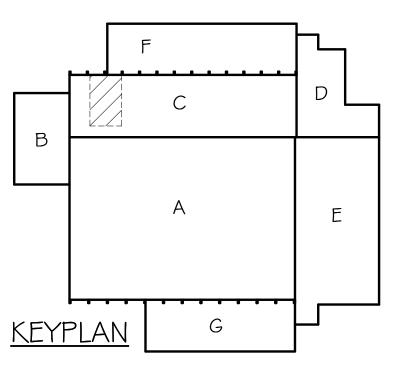



- 1. TC TO INSTALL NEW T-STAT AS SHOWN.
- 2. TYP SEE TYPICAL DIFFUSER CONNECTION DETAIL.
- 3. VC TO COORDINATE DUCTWORK, VAV, & DIFFUSER ELEVATIONS WITH EC. DIFFUSER ELEVATIONS TO MATCH LIGHT FIXTURES.
- VC TO RELOCATE EXISTING FAN POWERED VAV-11 TO LOCATION SHOWN. INSTALL WITH CLEARANCES AS PER MANUFACTURER'S REQUIREMENTS. COORDINATE WITH PC, TC, & EC.
- 5. BY ALTERNATE #1 VC TO PROVIDE & INSTALL SCHEDULED NEEDLEPOINT BI-POLAR IONIZATION SYSTEM IN DUCTWORK WHERE INDICATED ON PLANS. TC TO WIRE IONIZERS TO CONTROL BOX ON VAV SERVING DUCTWORK UNIT IS MOUNTED IN.
- 6. BY ALTERNATE #2 VC TO PROVIDE & INSTALL AIR DISINFECTION SYSTEM IN DUCTWORK WHERE INDICATED ON PLANS. 120V POWER WIRING & DISCONNECT BY EC, VC TO COORDINATE.
- 7. BY ALTERNATE #2 VC TO PROVIDE & INSTALL AIR DISINFECTION SYSTEM IN EXPOSED STRUCTURE CEILING WHERE INDICATED ON PLANS. CABLE HANG FROM STRUCTURE AS PER MANUFACTURER'S RECOMMENDATIONS, MATCH ELEVATION OF ADJACENT DIFFUSERS WHERE APPLIES. WHERE MOUNTED IN GPDW CEILING PROVIDE & INSTALL GPDW FRAME KIT IN ADDITION TO CABLE SUPPORT FROM STRUCTURE. 120V POWER WIRING & DISCONNECT BY EC, VC TO COORDINATE.
- 8. COORDINATE WALL FRAMING & DUCTWORK INSTALLATION IN WALL WITH GC.
- 9. 12" ROUTED ABOVE 14" IN BETWEEN CONCRETE STRUCTURAL BEAMS. INSTALL TO ALLOW CLEARANCE FOR SERVICE OF IONIZER & AIR DISINFECTION SYSTEM INSTALLED ON SIDE OF DUCTWORK.

SPECIAL NOTES:

A. ALL MECHANICAL SYSTEMS, EXCLUDING DROPS, TO BE INSTALLED AS HIGH AS POSSIBLE TO PROVIDE MAXIMUM CLEARANCES FOR OWNER.

GENERAL NOTES:

A. ALL WORK SHALL BE PERFORMED IN A CLEAN AND WORKMANLIKE MANNER.

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F. COORDINATE INSTALLATION OF ALL HVAC WITH PLUMBING, FIRE SPRINKLER, LIGHT FIXTURES, AND STRUCTURE TO ACCOMMODATE LIMITED CEILING SPACE.

G. FOR SIMPLICITY DUCT INSULATION NOT SHOWN, DUCT SIZES INDICATED ON DRAWING ARE INTERNAL DIMENSIONS. AS NEEDED ADJUST ACTUAL SIZE FOR INSULATION THICKNESS AS SPECIFIED.

H. ALL FLEXIBLE DUCTWORK AND CONNECTORS BETWEEN THE LOW PRESSURE DUCTWORK AND THE DIFFUSERS SHALL BE THE SIZE OF THE DIFFUSER INLET.


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J. PROVIDE AND INSTALL DURODINE FLEX DUCT CONNECTORS AT ALL EQUIPMENT CONNECTIONS.

K. ALL DUCTWORK TO BE SEALED AIRTIGHT.

H. FRESH AIR INTAKES TO BE MINIMUM 10' FROM ANY EXHAUST TERMINATION.

I. ALL FLOOR EQUIPMENT SHALL BE SET ON 4" HIGH CONCRETE BASES FURNISHED BY THIS CONTRACTOR.

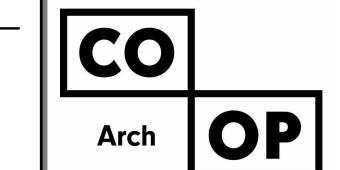

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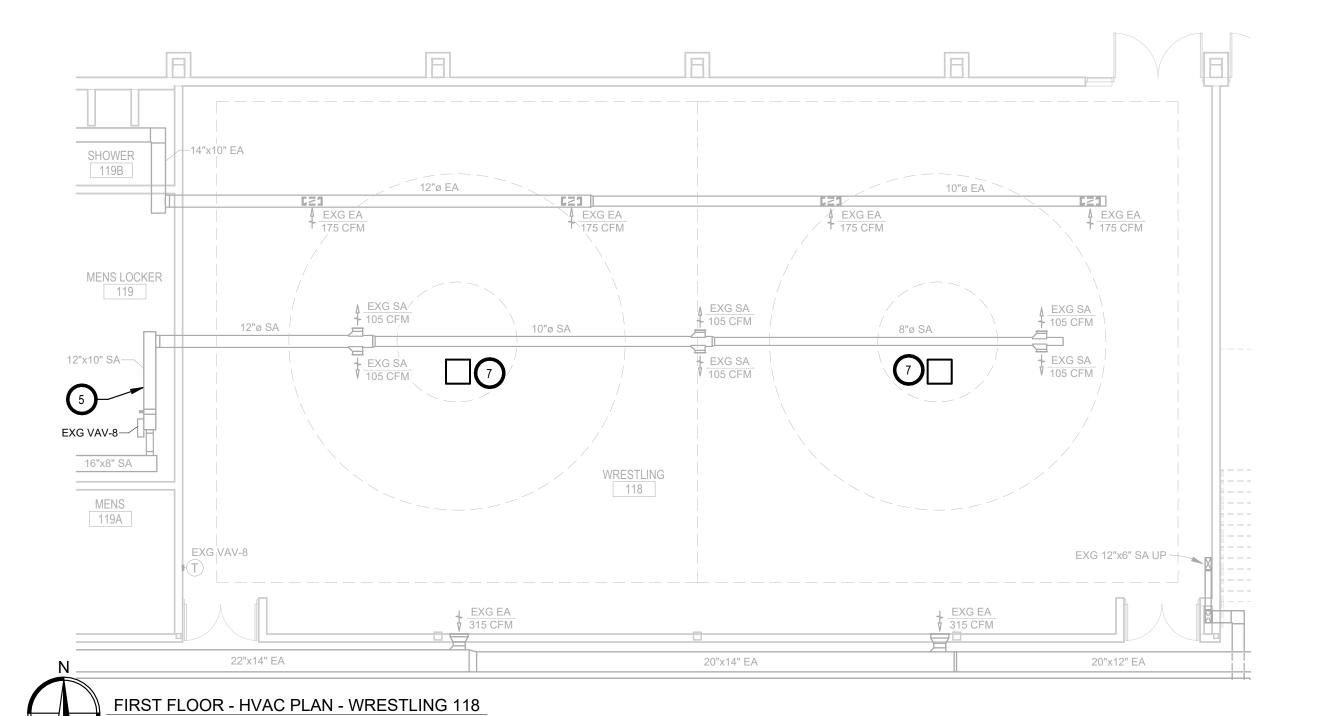
PROJECT:

NSU - BARNETT CENTER - LOCKER ROOM UPGRADES OSE # RO124--16X NORTHERN STATE UNIVERSITY ABERDEEN, SOUTH DAKOTA

SHEET TITLE:


WRESTLING & BASEBALL -

M601



C B A A KEYPLAN G

WRESTLING 118

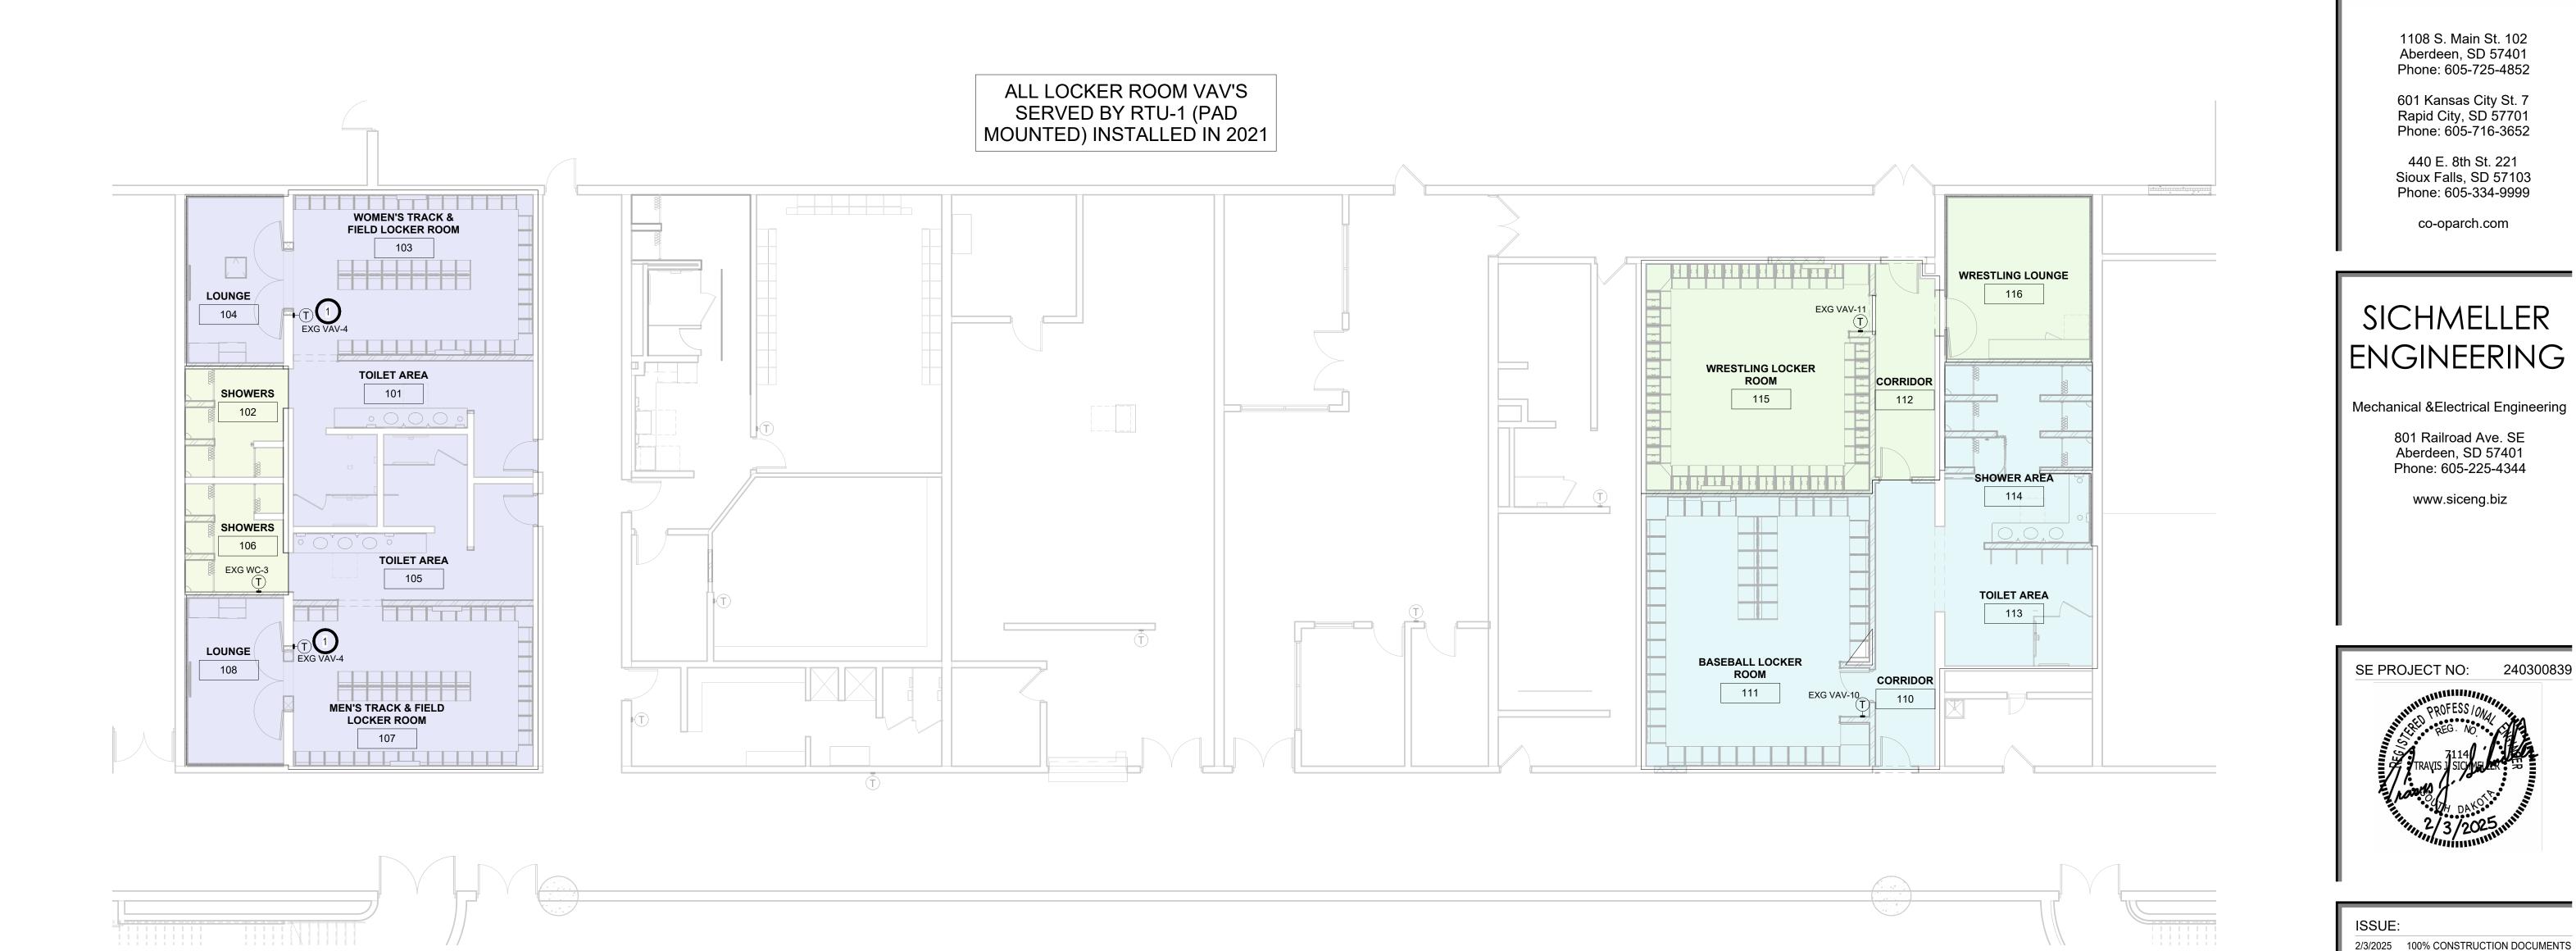

KEYNOTES:

1. TC TO UTILIZE T-STATS IN ROOMS 103 & 107 FOR TEMPERATURE AVERAGING CONTROL OF EXG VAV-4. PROJECT:

NSU - BARNETT CENTER - LOCKER ROOM UPGRADES OSE # RO124--16X NORTHERN STATE UNIVERSITY ABERDEEN, SOUTH DAKOTA

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SHEET TITLE:

REVISION SCHEDULE:

REV. # REV. DSC.

OVERALL LOCKER ROOM -HVAC TEMPERATURE CONTROL ZONE PLAN

HVAC TEMPERATURE CONTROL ZONE PLAN

				EX(G F	FA	N F	POWER	REI	D \	/A\	/ 1	ΓEF	RMI	NA	L :	SC	HEI	DU	LE						EXG	VAV-X		
EQUIP.		ER & MODEL SERVED FROM	o E DVI VO	INLET	FAN			ELECTRICAL			PRIMARY MAX CFM TERM		MAX MAX									COIL	RUNOUT						
NO.	MANUFACTURER & MODEL			SIZE	CFM	НР	ESP (W.G.)	V./PH./CY.	FLA	MCA	MOCP	MAX CFM	MIN CFM	APD (W.G.)	NC NC	NC NC				CFM	CFM MIN	EAT	BOX LAT	GPM	LWT	WPD (FT)	ROWS	SIZE	SIZE
EXG VAV - 4	DAIKIN APPLIED MQFVI5	RTU-1	TRACK & FIELD	14"	1560	1/4	0.29	120/1/60	4.8	6.0	15	1560	625	0.20	23	13	625	35.3	75	135.3	7.2	170	0.04	2		1-1/4"	1		
EXG VAV - 10	DAIKIN APPLIED MQFVI5	RTU-1	BASEBALL	14"	1150	1/4	0.33	120/1/60	4.8	6.0	15	1150	460	0.31	37	25	460	45.8	75	129.4	10.3	171	0.08	2		1-1/4"	1		
EXG VAV - 11	DAIKIN APPLIED MQFVI5	RTU-1	WRESTLING	14"	1060	1/8	0.27	120/1/60	2.6	3.3	15	1060	400	0.21	32	8	400	17.3	75	140.2	3.3	169	0.02	2		3/4"	1,2		
NOTES: 1	NOTES: 1. UNIT IS EXISTING, BALANCING CONTRACTOR TO REBALANCE TO NEW SCHEDULED CFMS.																												

2. VC TO RELOCATE EXG FAN POWERED VAV. COORDINATE WITH PC & EC.

NEEDLEPOINT		TANTTATTAN		
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MEEDELI OTNI	DT-I OFUI	TONTENITON	CICILII	COLLEGE

MANUFACTURER & MODEL	SERVING	COIL LENGTH	BAR LENGTH	NUMBER OF BARS	TOTAL ION OUTPUT (IONS/CC)	MINIMUM NEEDLEPOINT SPACING	NOTES
GLOBAL PLASMA SOLUTIONS DM48-AC	EXG VAV-8 WRESTLING ROOM	-	-	-	400,000,000	-	1,2,3,4,5
GLOBAL PLASMA SOLUTIONS DM48-AC	EXG VAV-10 RESTROOM/SHOWER AREA	-	-	-	400,000,000	-	1,2,3,4,5
GLOBAL PLASMA SOLUTIONS DM48-AC	EXG VAV-11 WRESTLING LOCKER & LOUNGE AREAS	-	-	-	400,000,000	-	1,2,3,4,5

1. ALC FORTING WITH SELF CLEANING FUNCTION, & DM-S SADDLE INSTALLATION ACCESSORY AS NECESSARY FOR INSTALLATION ON SPIRAL DUCTWORK, SEE PLANS.

3. VC TO PROVIDE & INSTALL IN SUPPLY AIR DUCTWORK DISCHARGE OF VAV WHERE SHOWN ON PLANS, PER MANUFACTURER'S RECOMMENDATIONS.

4. TC TO WIRE 24V POWER/CONTROL WIRING TO ASSOCIATED VAV CONTROLLER. ROUTE CABLING AS HIGH AS STRUCTURALLY POSSIBLE WHERE ROUTED THROUGH EXPOSED STRUCTURE AREAS.

AIR & SURFACE DISINFECTION SYSTEM SCHEDULE

MANUFACTURER & MODEL	SERVING	SIZE (H"XW"XD")		ELECTRICAL (V/PH/HZ)		NOTES
		, ,	V./PH./CY.	FLA	WATTS	
CASPR TECHNOLOGIES BLU TILE	WRESTLING LOCKER ROOM 115	23.9 X 23.9 X 5.4	120/1/60	0.5		1,2,4,6
CASPR TECHNOLOGIES BLU TILE	WRESTLING LOUNGE 116	23.9 X 23.9 X 5.4	120/1/60	0.5		1,3,4,6
CASPR TECHNOLOGIES BLU TILE	EXISTING WRESTLING ROOM 118	23.9 X 23.9 X 5.4	120/1/60	0.5		1,2,4,6
CASPR TECHNOLOGIES DUCT MOUNTED MEDIK 6" UNIT	EXG VAV-10 RESTROOM/SHOWER AREA	9 X 9 X 10.5	120/1/60		28.3	1,5,6
NOTES: 1. ALL POWERING WIRING & MEANS OF D	ISCONNECT BY EC. VC TO CO	OORDINATE INSTALLATION LOCATION WITH EC.				

2. VC TO PROVIDE & INSTALL TILE STYLE UNIT HUNG FROM STRUCTURE VIA CABLES. MATCH INSTALLATION HEIGHT OF ADJACENT DIFFUSERS.

3. VC TO PROVIDE & INSTALL TILE STYLE UNIT HUNG FROM STRUCTURE VIA CABLES. MATCH INSTALLATION HEIGHT OF ADJACENT DIFFUSERS.

4. SEE PLANS FOR QUANTITIES IN EACH SPACE. 5. INSTALL IN SUPPLY AIR DUCTWORK DISCHARGE OF VAV WHERE SHOWN ON PLANS, PER MANUFACTURER'S RECOMMENDATIONS.

6. BY ALTERNATE #2.

GRILLE	- REGISTER	- DTFFIISER	SCHEDIII I

		_					<u> </u>			
EQUIP.	MANUFACTURER & MODEL	NOMINAL SIZE	THROAT SIZE	MAX CFM	MAX APD (IN. W.G.)	THROW	NC	FRAME	FINISH	NOTES
S-1	PRICE ARCD	18"Ø	8 " Ø	225	0.05"	7 '	18	SURFACE		1,2,4,6,7
S-2	PRICE ARCD	22 1/2"Ø	10"Ø	370	0.06"	9'	21	SURFACE	SEE NOTE 7 AND	1,2,4,7
S-3	PRICE ARCD	27 "Ø	12"Ø	550	0.06"	12'	23	SURFACE	REFLECTED	1,2,4,7
E-1	PRICE 630	10X10	8X8	150	0.05"		< 15	SURFACE	CEILING PLANS/HVAC	1,2,3,5,7
E-2	PRICE 630	14X10	12X8	250	0.06"		< 15	SURFACE	PLANS,	1,2,3,5,7
E-3	PRICE 630	20X14	18X12	450	0.04"		< 15	SURFACE	FINISH VARIES	1,2,3,5,7
T_1	DDICE 630	24712	22710	650	0.07"		10	SIIDEVCE		1 2 3 5 7

NOTES: 1. M.C. SHALL COORDINATE MOUNTING AND SURFACE CONSTRUCTION PRIOR TO FURNISHING MATERIAL. M.C. SHALL ALSO COORDINATE EXACT LOCATION OF EQUIPMENT.

 ALUMINUM CONSTRUCTION. 45 DEG DEFLECTION.

PROVIDE 3 POSITION ADJUSTABLE CONE DIFFUSER. PROVIDE WITH OPPOSED BLADE BALANCING DAMPER, OR IN TAKEOFF. MATCH EXISTING.

PROVIDE WITH OPPOSED BLADE BALANCING DAMPER IN ROOMS 102, 106 AND 116. 7. PROVIDE WHITE FINISH WHERE INSTALLED ON SIDEWALL OR IN GPDW CEILING. PROVIDE BLACK FINISH WHERE INSTALLED IN EXPOSED STRUCTURE AREAS.


CO

ADJUSTABLE

CLEAN OUT

2" ADJUSTABLE

RELLE - REGISIER - DIFFUSER SCHEDULE T-1 PRICE 630 24X12 22X10 650 0.07" --- 19 SURFACE

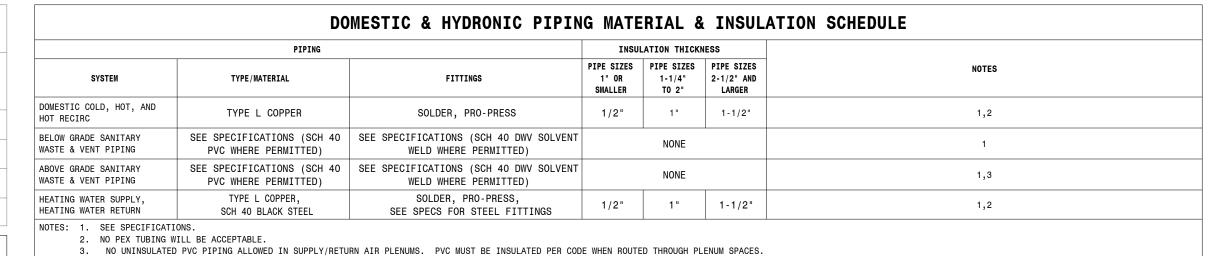

HVAC SHEET METAL DUCTWORK CONSTRUCTION & INSULATION SCHEDULE										
			INSULATION THIC	KNESS (EXTERIOR	WRAP UNLESS OTHERW	ISE NOTED)				
SYSTEM	MAX DIMENSION OF RECTANGULAR DUCTS OR DIAMETER OF ROUND DUCTS	GALVANIZED SHEET METAL GAUGE NUMBER	PRESSURE RATING	CONSTRUCTION	ROUND SUPPLY AIR	RETURN AIR	EXHAUST AIR	TRANSFER AIR	NOTES	
	UP THRU 12"	26		WHEN LONGEST		1/2" LINER	NONE			
OW	OVER 12" THRU 30"	24		SIDE IS 36" OR GREATER, SHALL	NONE WITH					
PRESSURE	OVER 30" THRU 54"	22	2" W.G.	BE CONSTRUCTED USING DUCTMATE	NONE, WITH EXCEPTION,			1/2" LINER	1,2,3,4,5	
DUCTWORK	OVER 54" THRU 84"	20		35/25 SLIDE ON SYSTEM, TDF	SEE NOTE 5					
	OVER 84"	18		FLANGE						

SH-2

HANDICAPPED SHOWER

VALVE & HEAD

FIXED HEAD TO BE INSTALLED 6" OFFSET

FROM CENTER OF
SHOWER TO SHOWER

SEE ARCHITECTURAL PLANS

FOR RIGHT-HANDED OR

ORIENTATION TO MEET

*FOR SH-2's IN SHOWERS

DCW & DHW PIPING & MIXED TO SHOWER HEAD FROM SHOWER VALVE IN

PROVIDE & INSTALL VALVE ASSEMBLIES, SHOWER HEAD, AND HAND SHOWER ASSEMBLY FOR EXISTING SHOWER STALL LOCATION WHERE INDICATED ON THE PLANS. UTILIZ EXISTING PIPING WITHIN THE WALL. COORDINATE BLOCK DEMO AND PATCHING AS REQUIRED TO REMOVE EXISTING FIXTURE AND INSTALL NEW IN THE SAME LOCATIONS,

PLUMBING ACCESSORIES:

PROVIDE 2° FLOOR DRAIN.

C. TO TILE SHOWER WALLS AND FLOOR AND PROVIDE & INSTALL SEAT AND GRAB BAR.

EXISTING SHOWER LOCATION TO BE UTILIZED. REPLACE ALL PIPING BOUGH INS IN WALL AND INSTALL NEW VALVES WHERE SHOWN TO MEET ADA. COORDINATE BLOCK CUTTING WITH GC.

COLD WATER HOT WATER

LEFT-HANDED ROUGH- IN

FLOOR PLAN REQUIREMENTS.

NOTES: 1. FOLLOW ALL SMACNA STANDARDS, SEE SPECIFICATIONS. 2. ALL DUCTWORK 18" AND GREATER IN WIDTH SHALL BE CROSS-BROKEN.


SH - 1


3. ALL SYSTEMS TO BE COMPLETELY INSULATED UNLESS OTHERWISE NOTED.

SEE HVAC PLANS FOR PLENUM LOCATIONS, COORDINATE WITH VC.

4. ALL EXPOSED DUCTWORK TO BE PAINTGRIP, INCLUDING WHERE LINED.

5. ALL SUPPLY AIR DUCTWORK ROUTED ABOVE ALL CEILINGS SHALL BE EXTERIOR AND 1-172THICK. SEE HVAC PLANS AND ARCHITECTURAL REFLECTED CEILING PLAN. ANY SUPPLY AIR DUCTWORK ROUTED IN EXPOSED STRUCTURE AREAS TO BE UNINSULATED AND SHALL BE PAINTGRIP SHEET METAL.

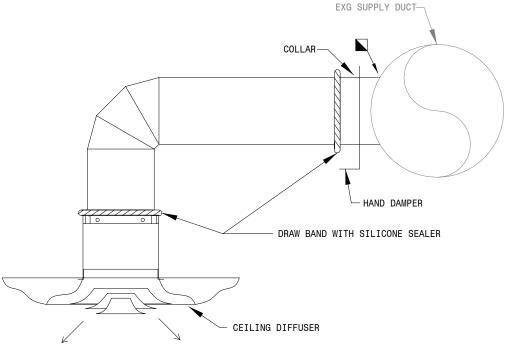

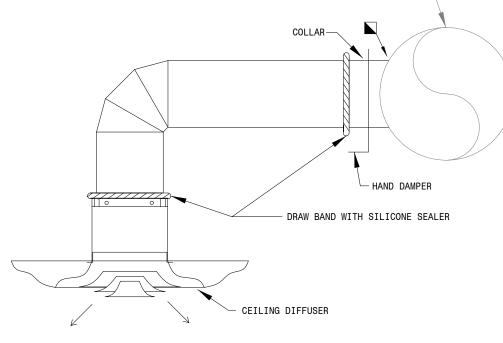

Typical Diffuser Connection

(SIDE OF DUCT CONNECTION)

NOT TO SCALE

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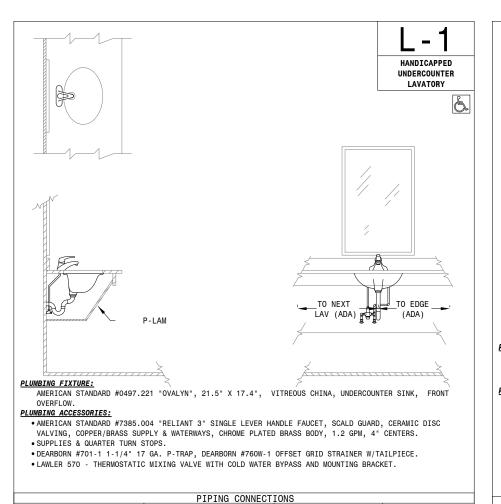
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PROJECT:

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SHEET TITLE:


MECHANICAL SCHEDULES & **DETAILS**




PLUMBING FIXTURE:
SIOUX CHIEF MODEL 834-4DNR ADJUSTABLE ON-GRADE FLOOR CLEANOUT. LIGHT DUTY ROUND NICKEL-BRONZE


SIOUX CHIEF MODEL 832-2PNR ADJUSTABLE ON-GRADE FLOOR DRAIN. LIGHT DUTY ROUND NICKEL-BRONZE STRAINER IN PEDESTRIAN LOAD AREAS ONLY.


COVER IN PEDESTRIAN LOAD AREAS ONLY.

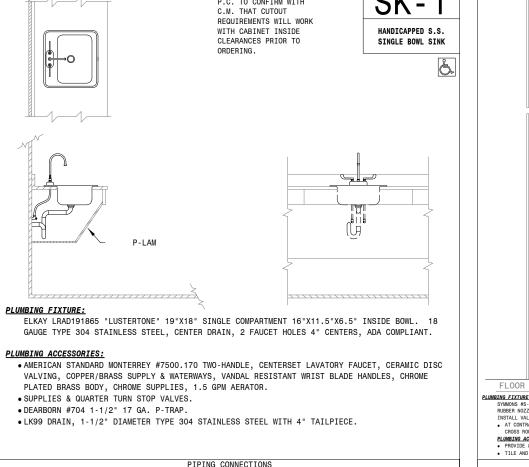


P.C. TO CONFIRM WITH

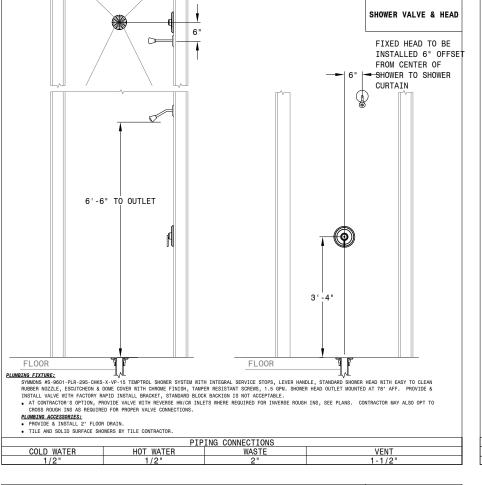


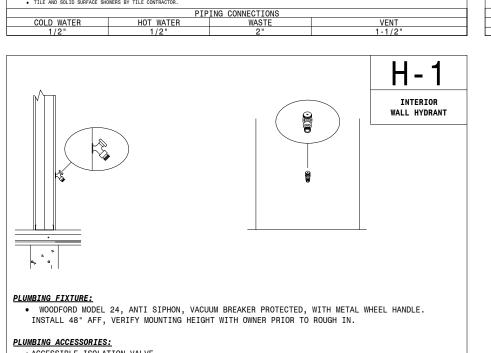


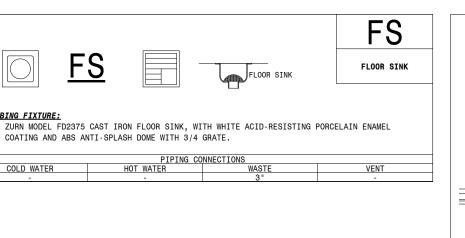





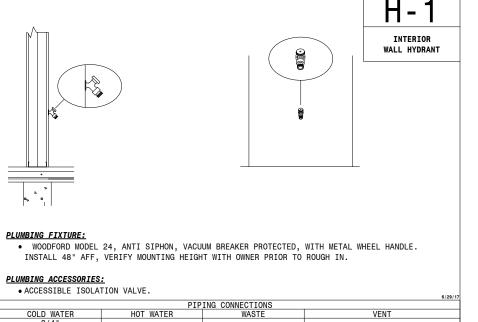


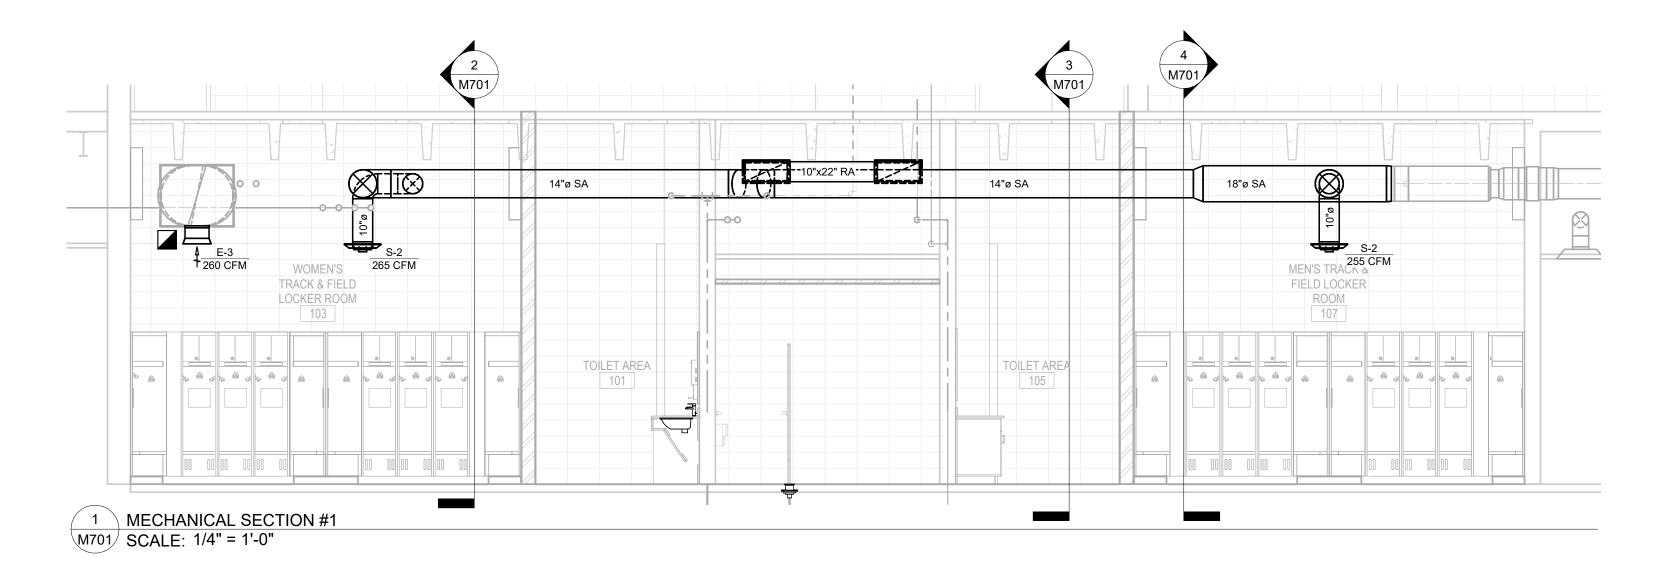

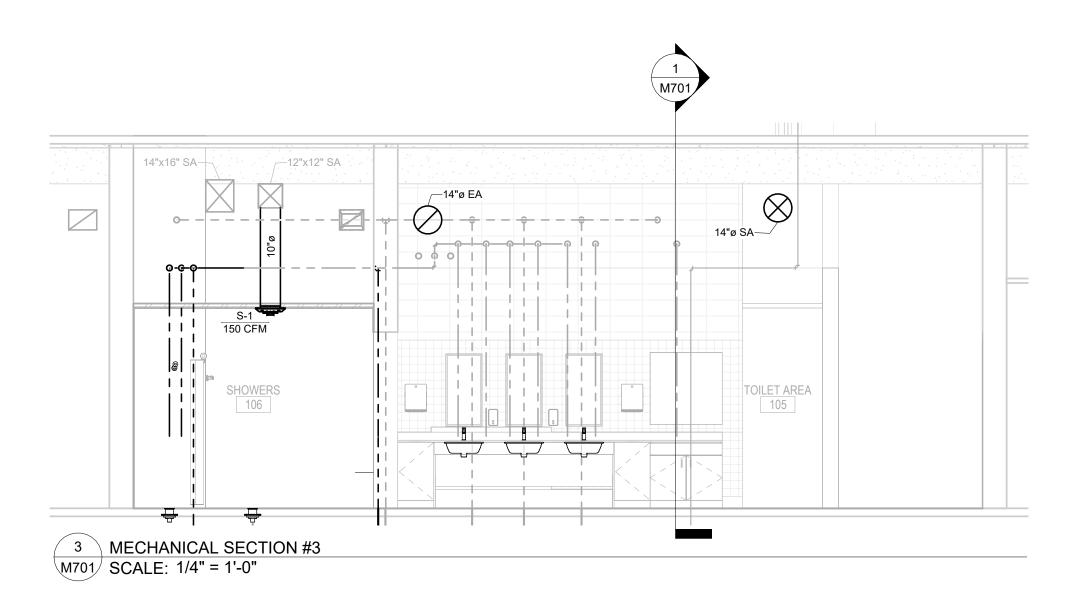

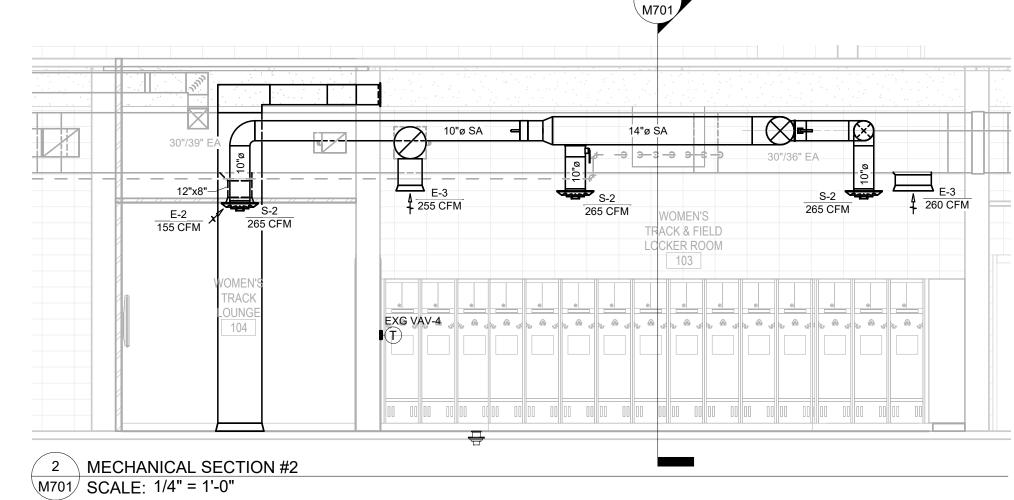

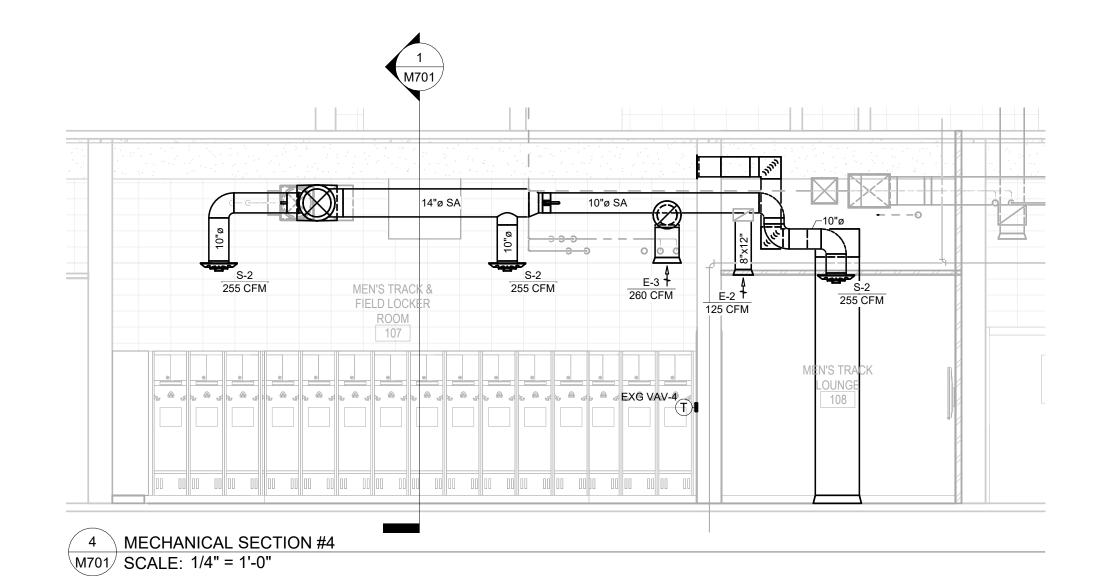

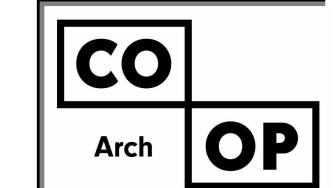

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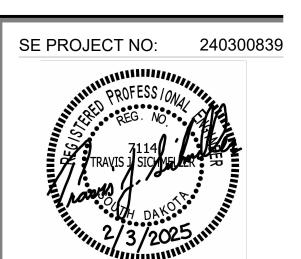
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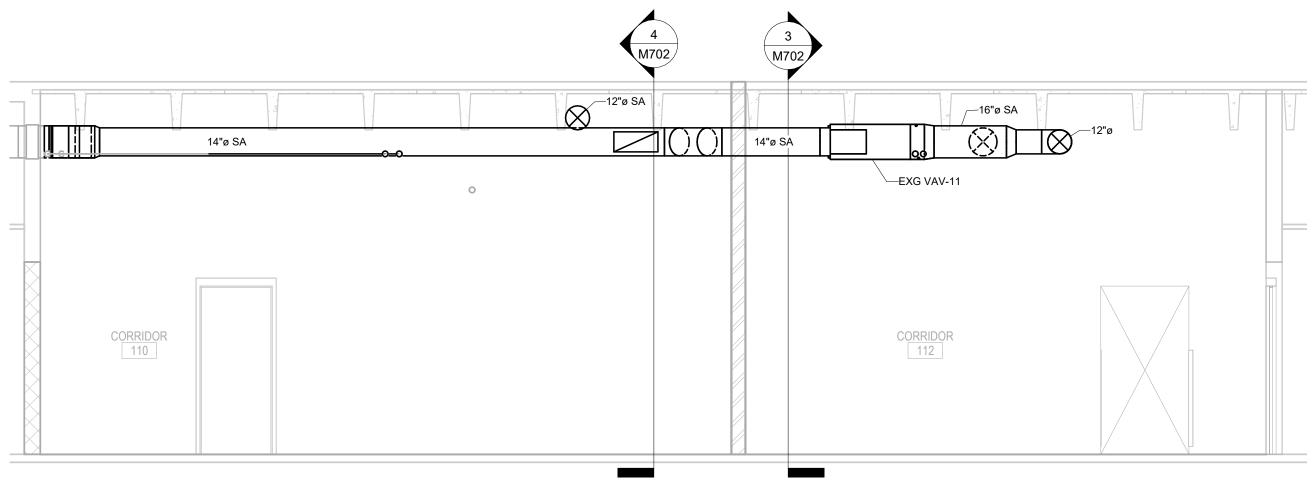
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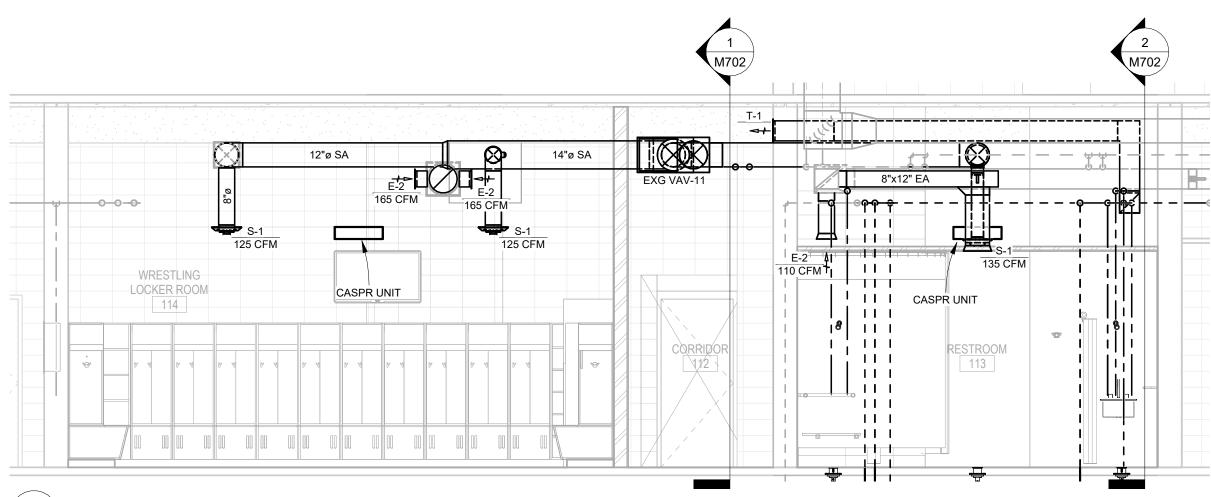
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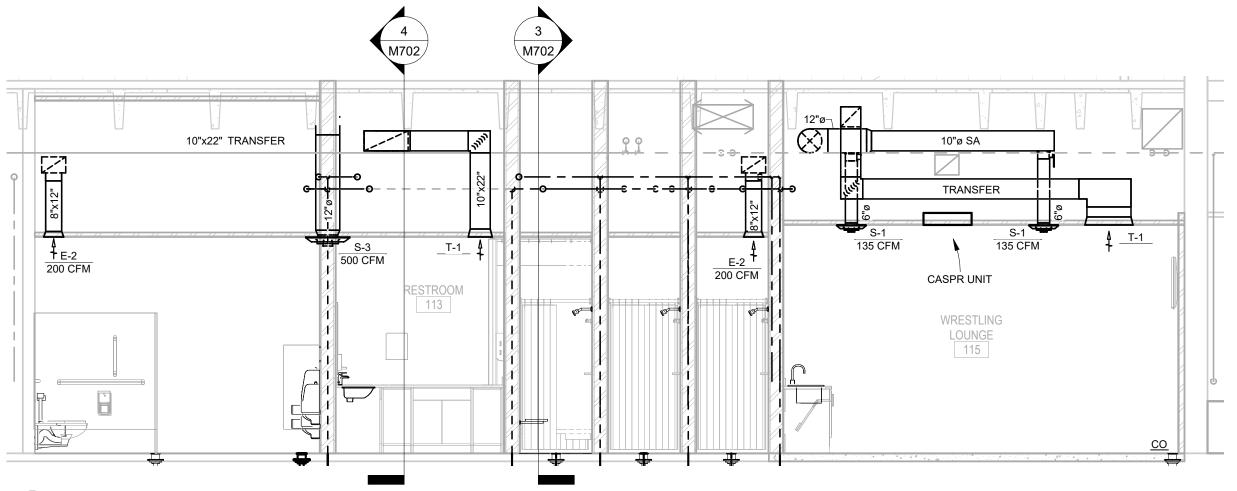
MECHANICAL SECTIONS (1 OF 2)









MECHANICAL SECTION #7
SCALE: 1/4" = 1'-0"



2 MECHANICAL SECTION #6 M702 SCALE: 1/4" = 1'-0"

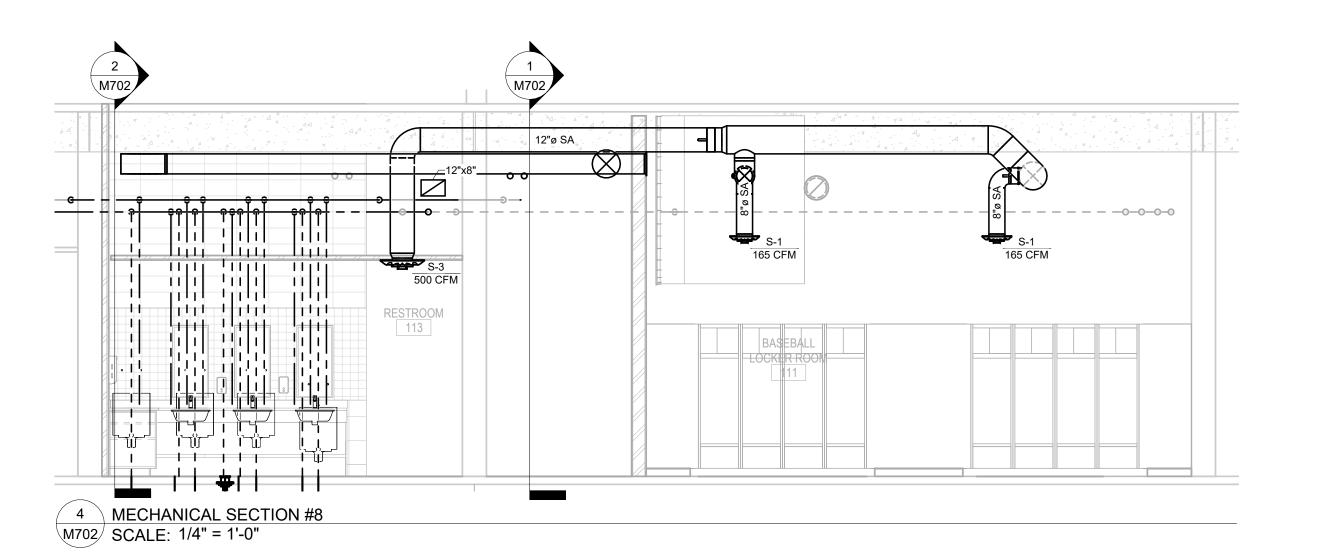

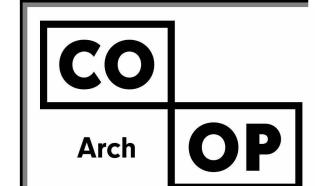

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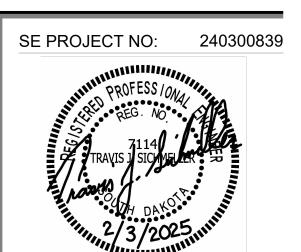
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SHEET TITLE:

MECHANICAL SECTIONS (2 OF 2)

A. CONTRACTOR SHALL VISIT THE SITE AND VERIFY ALL EXISTING CONDITIONS AND DIMENSIONS. NOTIFY THE ENGINEER IMMEDIATELY OF ANY DISCREPANCIES, INCLUDING ANY NECESSARY DEMOLITION.

B. REMOVE ELECTRICAL EQUIPMENT IN THE AREAS SHOWN ON THE PLAN, DISCONNECT CIRCUITS AND CONDUITS AND REMOVE TO A POINT OUT OF THE WAY OF THE GENERAL DEMOLITION. MARK ON THE PLAN TO CLEARLY SHOW WHERE THESE CIRCUITS ARE STOPPED. DISCONNECT THE POWER AND LIGHTING CIRCUITS IN THE PANELS TO ASSURE THAT THERE IS NO DANGER FROM ELECTRICAL SHOCK HAZARD PRESENT. DEMOLITION WORK SHALL BE COORDINATED WITH THE OWNER. SHOULD QUESTIONS ARISE REGARDING THE REMOVAL OF EQUIPMENT, CONFER WITH THE OWNER BEFORE SUCH EQUIPMENT IS DEMOLISHED. MATERIALS REMOVED BY DEMOLITION SHALL REMAIN THE PROPERTY OF THE OWNER UNLESS OTHERWISE SPECIFICALLY NOTED. MATERIAL THE OWNER DOES NOT WISH TO RETAIN SHALL BE REMOVED AND DISPOSED OF PROPERLY BY THE CONTRACTOR.

THE CONTRACTOR.

C. EQUIPMENT SHOWN ON DRAWINGS AS EXISTING IS BASED ON EXISTING PLANS AND LIMITED FIELD INVESTIGATION. THE FIELD SURVEY WAS CONDUCTED TO VERIFY, AS MUCH AS POSSIBLE, THE ACCURACY OF THE LOCATIONS SHOWN. THE CONTRACTOR SHALL VERIFY THE ACCURACY OF THE "EXISTING CONDITIONS" AS SHOWN ON THE DRAWINGS AS THE DEMOLITION WORK PROGRESSES. PERFORM MODIFICATIONS AND ADDITIONS AS NECESSARY TO CORRECT FOR THESE HIDDEN CONDITIONS AND ALLOW FOR THE COMPLETION OF THE NEW WORK.

D. THE EXISTING BUILDING WILL BE IN USE DURING THIS CONSTRUCTION. SCHEDULE AND CARRY OUT THE WORK IN SUCH A MANNER AS TO CAUSE THE OWNER A MINIMUM OF INCONVENIENCE DUE TO SERVICE INTERRUPTIONS. TEMPORARY SERVICES SHALL BE INSTALLED IF ONE PHASE OF CONSTRUCTION DISRUPTS SERVICE TO ANOTHER AREA OF THE BUILDING OR IF EQUIPMENT HAS TO BE RELOCATED TO ALLOW CONSTRUCTION TO PROGRESS. SERVICE INTERRUPTIONS SHALL BE CONFINED TO THE SMALLEST AREA POSSIBLE AT ANY ONE TIME AND INTERRUPTIONS SHALL BE SCHEDULED WITH THE OWNER'S SITE REPRESENTATIVE. AFTER SERVICE HAS BEEN RESTORED FOLLOWING AN INTERRUPTION, INSPECT AREAS AFFECTED BY THE INTERRUPTION AND BE RESPONSIBLE FOR RETURNING AUTOMATICALLY CONTROLLED EQUIPMENT TO THE SAME OPERATING CONDITION, WHICH EXISTED PRIOR TO THE INTERRUPTION.

E. PROVIDE PENETRATIONS TO THE BUILDING STRUCTURE AS REQUIRED FOR INSTALLATION. WHERE EXISTING OR TEMPORARY SYSTEMS ARE BEING DEMOLISHED, WHICH LEAVE OPENINGS IN THE EXISTING BUILDING STRUCTURE, THE BUILDING STRUCTURE SHALL BE PATCHED TO MATCH THE EXISTING CONSTRUCTION AND MAINTAIN THE EXISTING BUILDING FIRE RATINGS.

ELECTRICAL NOTES:

DISCONNECT & REMOVE EXG LIGHTING CIRCUIT BACK
 TO PANEL "H1 - 3". LABEL SPARE IN PANEL.

2. DISCONNECT & REMOVE EXG HAND/HAIR DRYERS & REMOVE CIRCUIT BACK TO PANEL "L1".

3. DISCONNECT, REMOVE EXG RECEPTACLES AND RACEWAYS AS REQUIRED. DEMO CIRCUITS BACK TO EXG PANEL AS NEEDED.

4. SALVAGE & GIVE TO OWNER EXG HAND DRYER. SEE PROPOSED.

5. TYPICAL - EC TO DISCONNECT & REMOVE EXISTING LIGHTS SHOWN DARK & DASHED.

6. TYPICAL - EC TO DISCONNECT & REMOVE EXISTING FIRE ALARM DEVICES SHOWN DARK & DASHED.


7. DISCONNECT & MAINTAIN EXG DEVICES DOWNSTREAM. SALVAGE EXG POWERED CLOCK & TURN OVER TO OWNER.


8. EC TO REMOVE OCCUPANCY SENSOR & INSTALL BLANK COVER.

9. EC TO COORDINATE WITH GC TO CUT AND PATCH CONCRETE FOR INSTALLATION OF CONDUITS FOR LOCKER TOE-KICK POWER. SEE ARCHITECTURAL AND PROPOSED.

 DEMO EXG SWITCH AND BOX IN CMU WALL.
 COORDINATE WITH GC FOR CONCRETE BLOCK PATCHING. SEE PROPOSED.

11. EC TO REMOVE EXG SCOREBOARD TIME CLOCK .
MAINTAIN EXG LOW VOLTAGE CIRCUITRY TO NOT
INTERRUPT UP/DOWN STREAM DEVICES. REINSTALL
SCOREBOARD TIME CLOCK SEE PROPOSED.

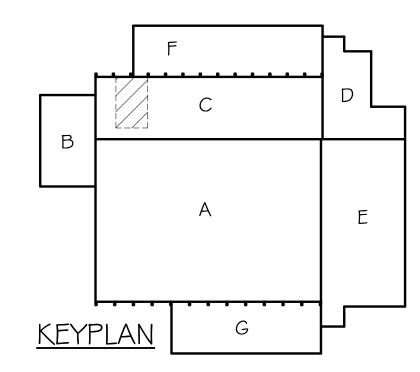

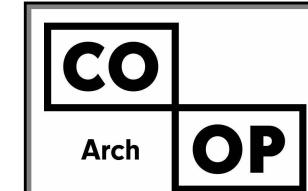

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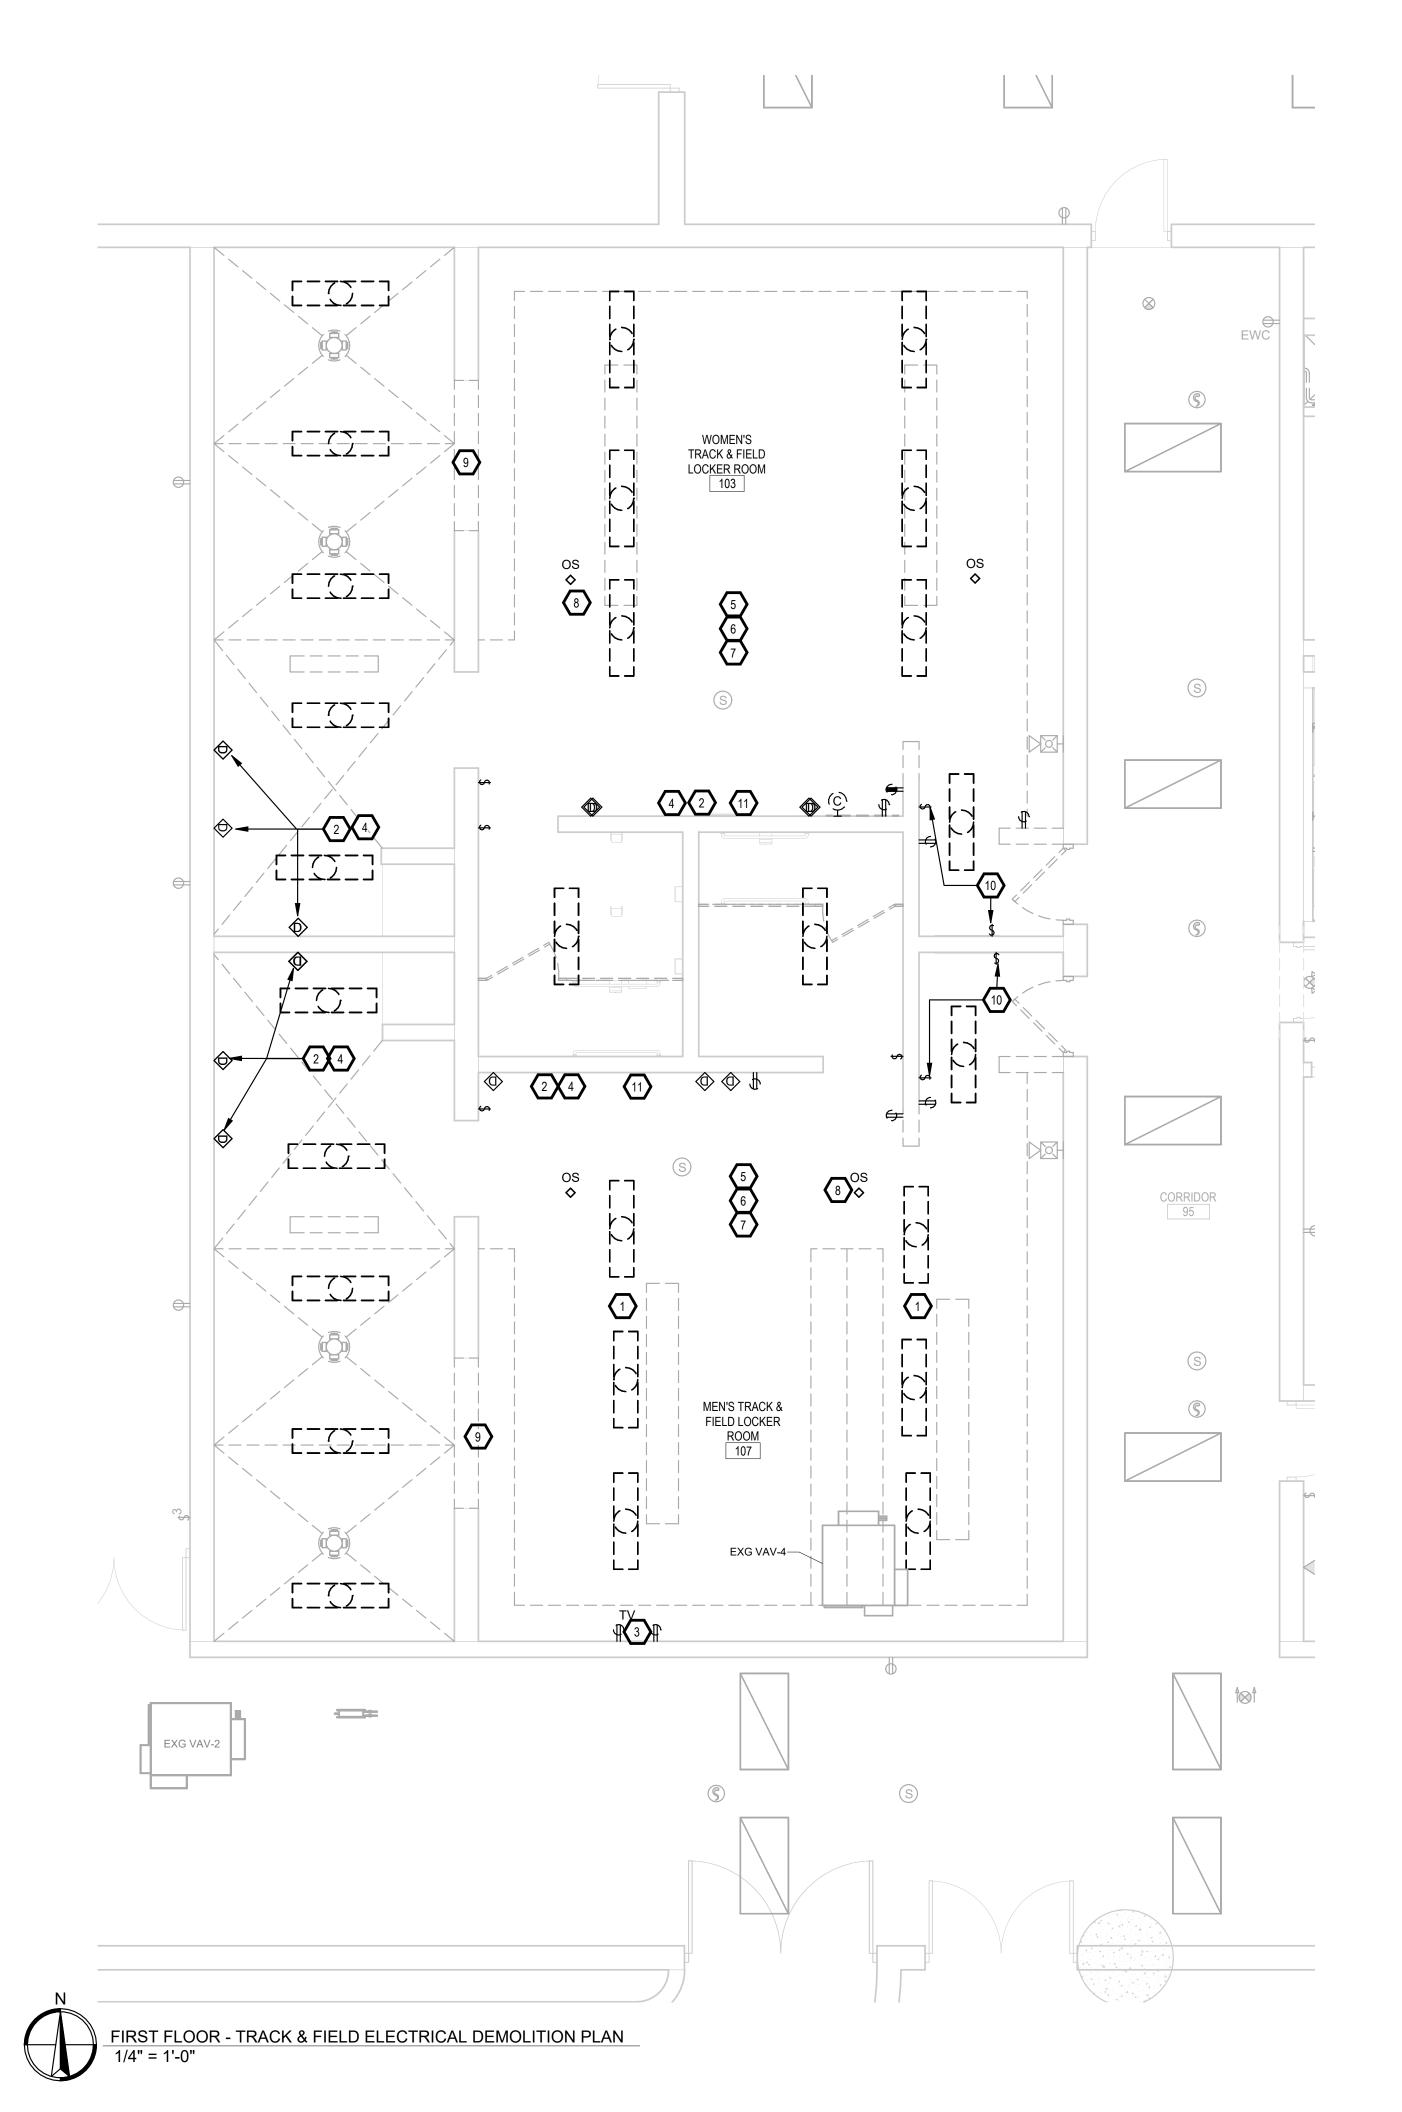
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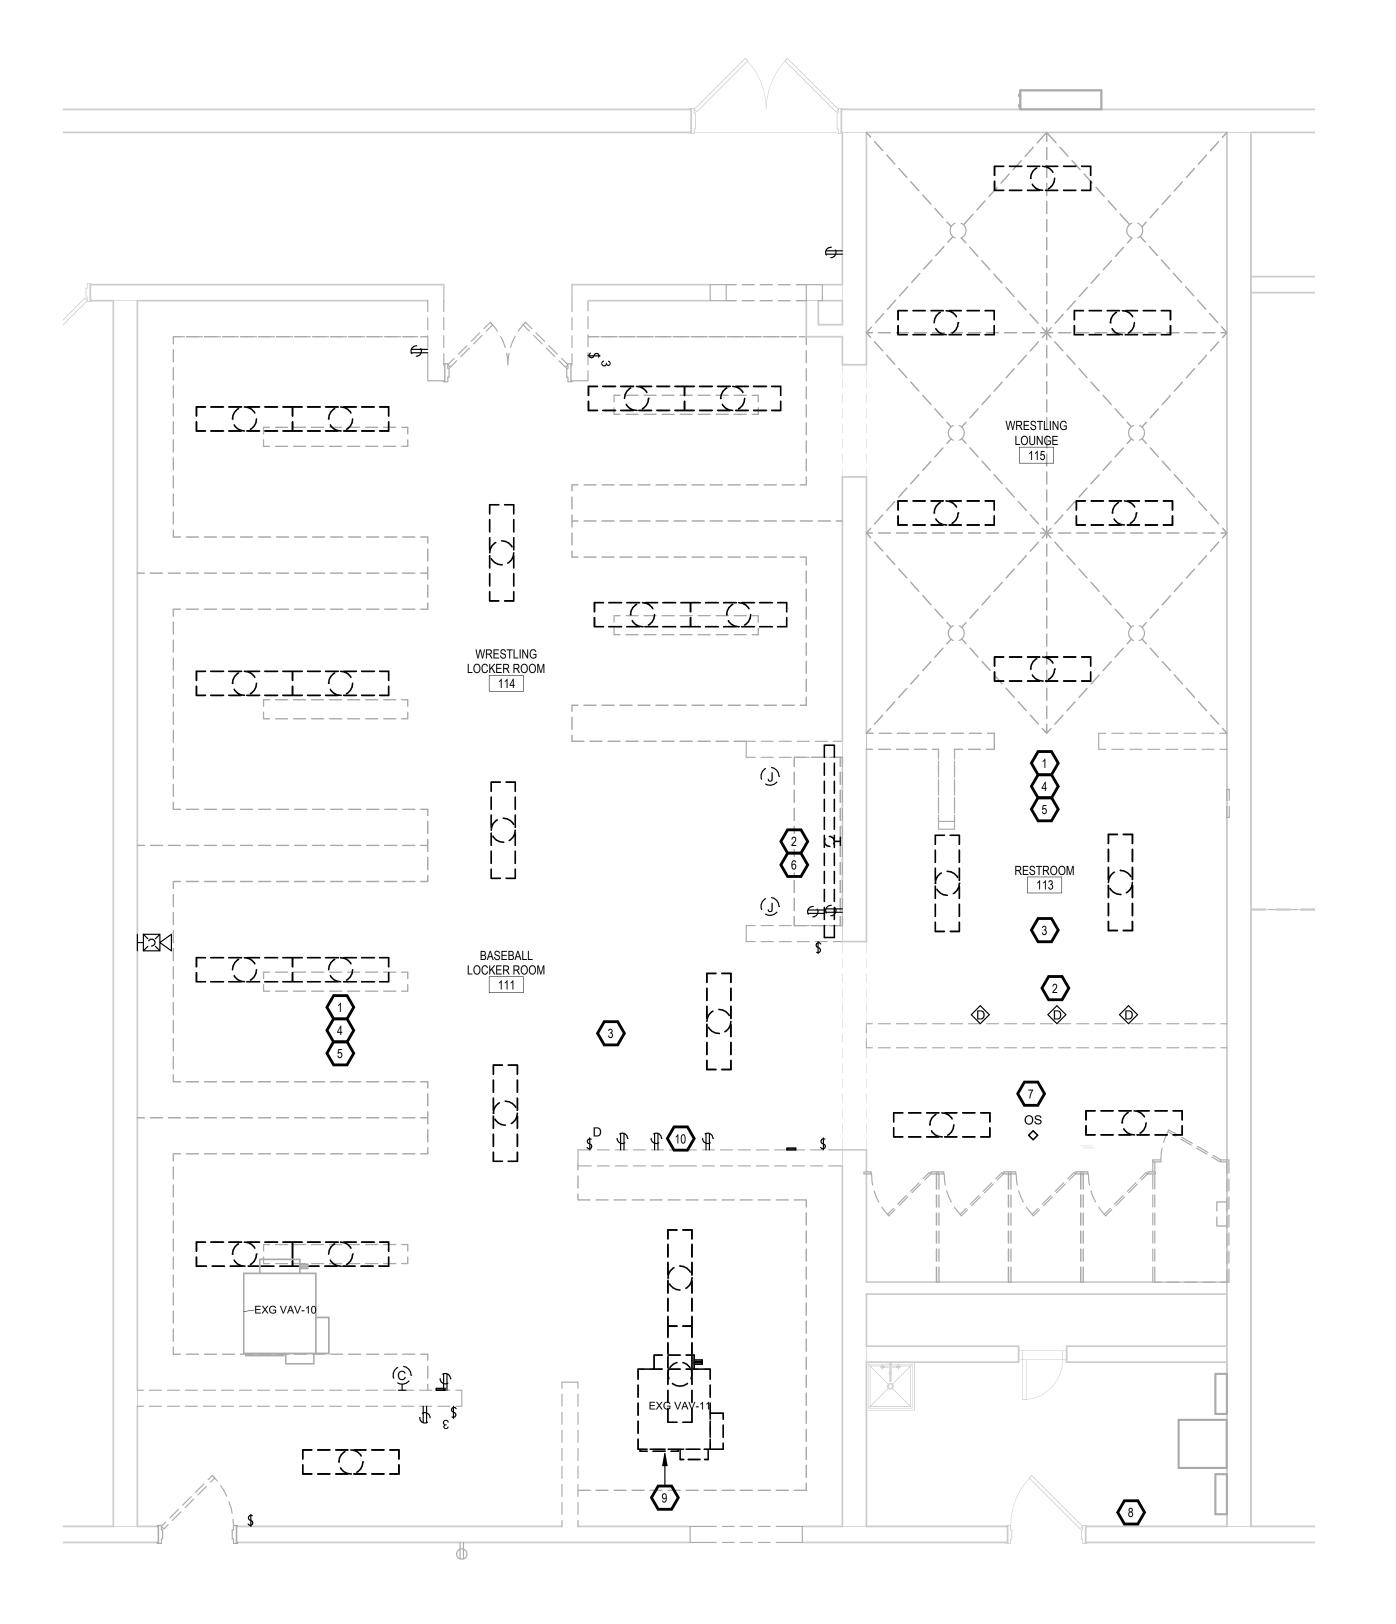
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SHEET TITLE:

TRACK & FIELD - ELECTRICAL DEMOLITION PLAN






FIRST FLOOR - WRESTLING/BASEBALL ELECTRICAL DEMOLITION PLAN


GENERAL NOTES:

- A. CONTRACTOR SHALL VISIT THE SITE AND VERIFY ALL EXISTING CONDITIONS AND DIMENSIONS. NOTIFY THE ENGINEER IMMEDIATELY OF ANY DISCREPANCIES, INCLUDING ANY NECESSARY DEMOLITION.
- B. REMOVE ELECTRICAL EQUIPMENT IN THE AREAS SHOWN ON THE PLAN, DISCONNECT CIRCUITS AND CONDUITS AND REMOVE TO A POINT OUT OF THE WAY OF THE GENERAL DEMOLITION. MARK ON THE PLAN TO CLEARLY SHOW WHERE THESE CIRCUITS ARE STOPPED. DISCONNECT THE POWER AND LIGHTING CIRCUITS IN THE PANELS TO ASSURE THAT THERE IS NO DANGER FROM ELECTRICAL SHOCK HAZARD PRESENT. DEMOLITION WORK SHALL BE COORDINATED WITH THE OWNER. SHOULD QUESTIONS ARISE REGARDING THE REMOVAL OF EQUIPMENT, CONFER WITH THE OWNER BEFORE SUCH EQUIPMENT IS DEMOLISHED. MATERIALS REMOVED BY DEMOLITION SHALL REMAIN THE PROPERTY OF THE OWNER UNLESS OTHERWISE SPECIFICALLY NOTED. MATERIAL THE OWNER DOES NOT WISH TO RETAIN SHALL BE REMOVED AND DISPOSED OF PROPERLY BY THE CONTRACTOR.
- C. EQUIPMENT SHOWN ON DRAWINGS AS EXISTING IS BASED ON EXISTING PLANS AND LIMITED FIELD INVESTIGATION. THE FIELD SURVEY WAS CONDUCTED TO VERIFY, AS MUCH AS POSSIBLE, THE ACCURACY OF THE LOCATIONS SHOWN. THE CONTRACTOR SHALL VERIFY THE ACCURACY OF THE "EXISTING CONDITIONS" AS SHOWN ON THE DRAWINGS AS THE DEMOLITION WORK PROGRESSES. PERFORM MODIFICATIONS AND ADDITIONS AS NECESSARY TO CORRECT FOR THESE HIDDEN CONDITIONS AND ALLOW FOR THE COMPLETION OF THE NEW WORK.
- D. THE EXISTING BUILDING WILL BE IN USE DURING THIS CONSTRUCTION. SCHEDULE AND CARRY OUT THE WORK IN SUCH A MANNER AS TO CAUSE THE OWNER A MINIMUM OF INCONVENIENCE DUE TO SERVICE INTERRUPTIONS. TEMPORARY SERVICES SHALL BE INSTALLED IF ONE PHASE OF CONSTRUCTION DISRUPTS SERVICE TO ANOTHER AREA OF THE BUILDING OR IF EQUIPMENT HAS TO BE RELOCATED TO ALLOW CONSTRUCTION TO PROGRESS. SERVICE INTERRUPTIONS SHALL BE CONFINED TO THE SMALLEST AREA POSSIBLE AT ANY ONE TIME AND INTERRUPTIONS SHALL BE SCHEDULED WITH THE OWNER'S SITE REPRESENTATIVE. AFTER SERVICE HAS BEEN RESTORED FOLLOWING AN INTERRUPTION, INSPECT AREAS AFFECTED BY THE INTERRUPTION AND BE RESPONSIBLE FOR RETURNING AUTOMATICALLY CONTROLLED EQUIPMENT TO THE SAME OPERATING CONDITION, WHICH EXISTED PRIOR TO THE INTERRUPTION.
- E. PROVIDE PENETRATIONS TO THE BUILDING STRUCTURE AS REQUIRED FOR INSTALLATION. WHERE EXISTING OR TEMPORARY SYSTEMS ARE BEING DEMOLISHED, WHICH LEAVE OPENINGS IN THE EXISTING BUILDING STRUCTURE, THE BUILDING STRUCTURE SHALL BE PATCHED TO MATCH THE EXISTING CONSTRUCTION AND MAINTAIN THE EXISTING BUILDING FIRE RATINGS.

ELECTRICAL NOTES:

- 1. EC TO REMOVE EXG. LIGHTING CIRCUITRY BACK TO PANEL "H3 - 3 & 5". VERIFY CIRCUITRY.
- 2. DISCONNECT & REMOVE EXG HAND/HAIR DRYERS & REMOVE CIRCUIT BACK TO PANEL "L3".
- 3. DISCONNECT, REMOVE EXG RECEPTACLES AND RACEWAYS AS REQUIRED. DEMO CIRCUITS BACK TO EXG PANEL AS NEEDED.
- 4. TYPICAL EC TO DISCONNECT & REMOVE EXISTING LIGHTS SHOWN DARK & DASHED.
- 5. TYPICAL EC TO DISCONNECT & REMOVE EXISTING FIRE ALARM DEVICES SHOWN DARK & DASHED.
- 6. DISCONNECT & MAINTAIN EXG DEVICES DOWNSTREAM. SALVAGE EXG POWERED CLOCK & TURN OVER TO OWNER.
- 7. EC TO DEMO EXG CEILING OCCUPANCY SENSOR.
- 8. REMOVE EXG CABINET AND RETURN TO OWNER FOR INSTALLATION OF NEW SUB-PANEL SEE PROPOSED.
- 9. EC TO DISCONNECT POWER FOR EXG VAV-11. REWORK EXG POWER AND EXTEND TO PROPOSED LOCATION. SEE PROPOSED ON E301.
- 10. EC TO REMOVE EXG SCOREBOARD TIME CLOCK. MAINTAIN EXG LOW VOLTAGE CIRCUITRY TO NOT INTERRUPT UP/DOWN STREAM DEVICES. REINSTALL SCOREBOARD TIME CLOCK SEE PROPOSED.

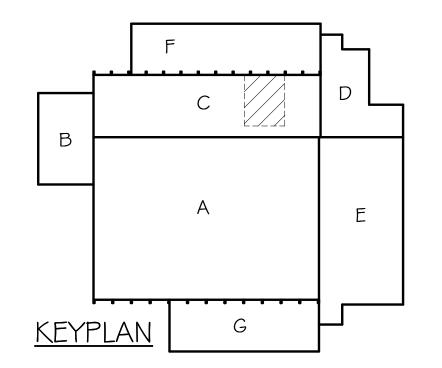

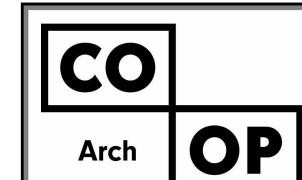

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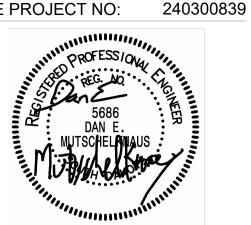
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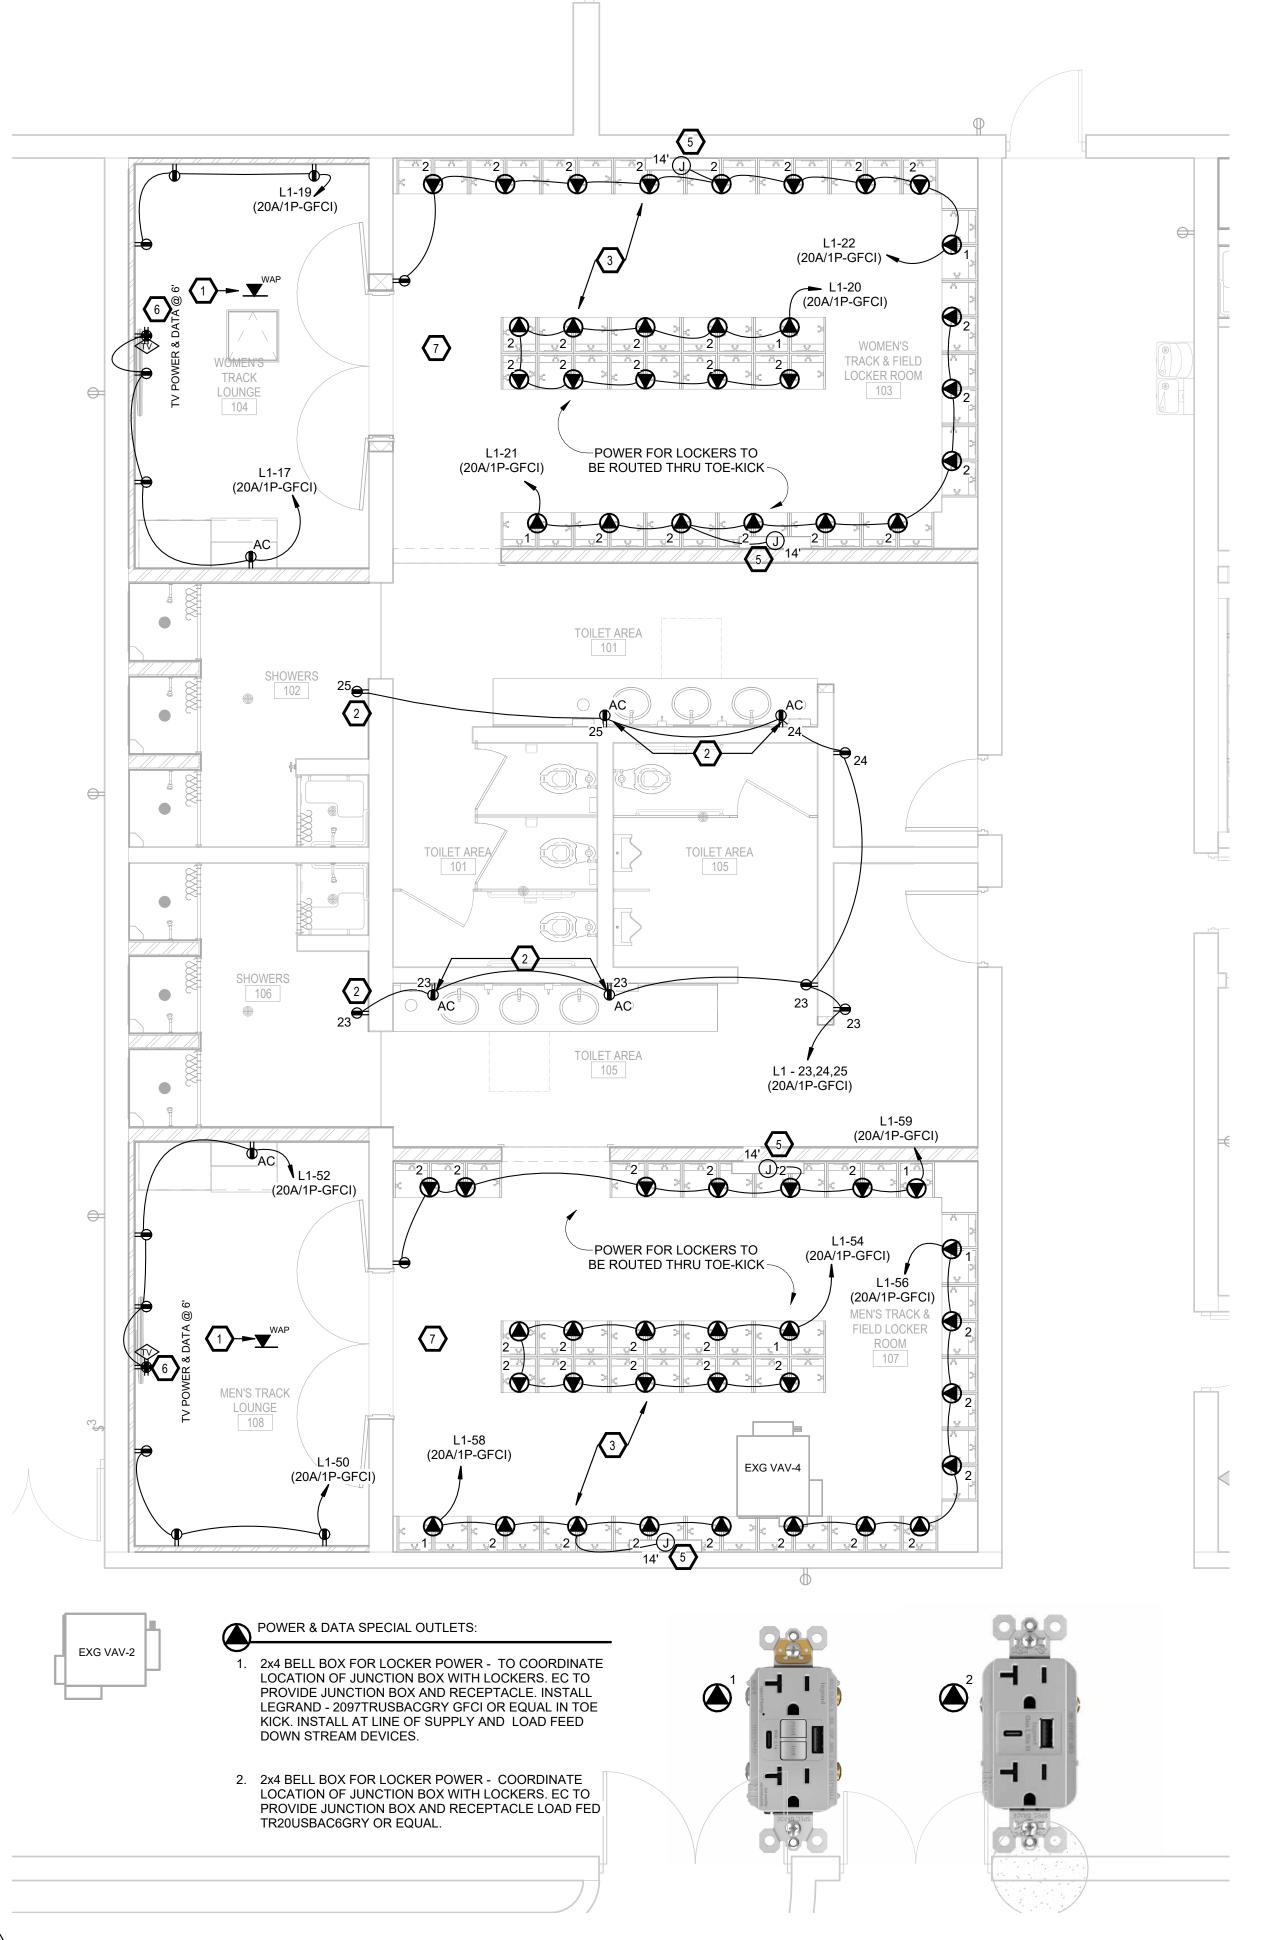
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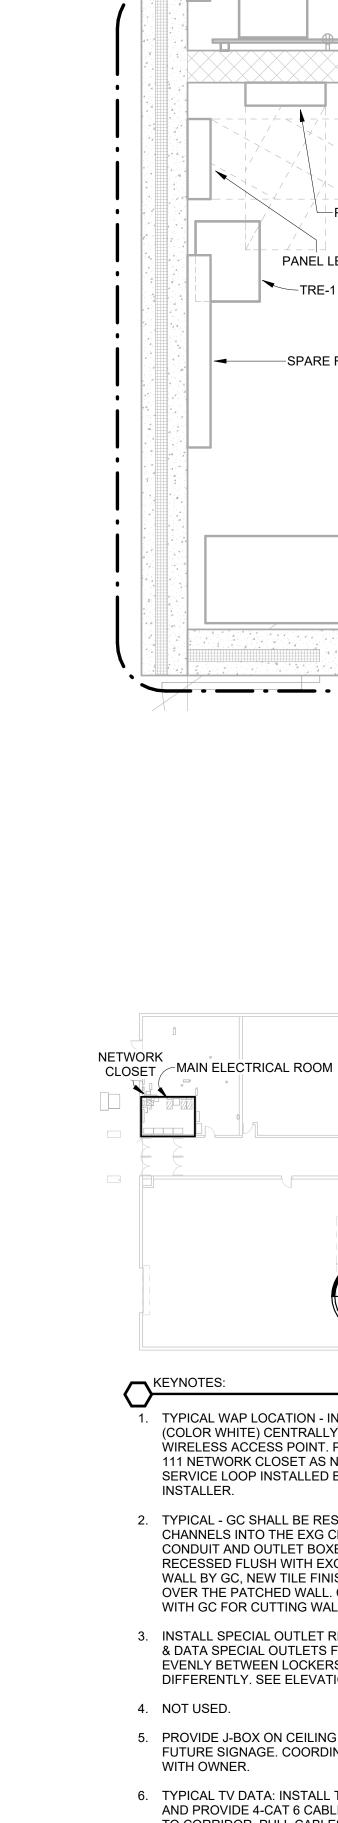
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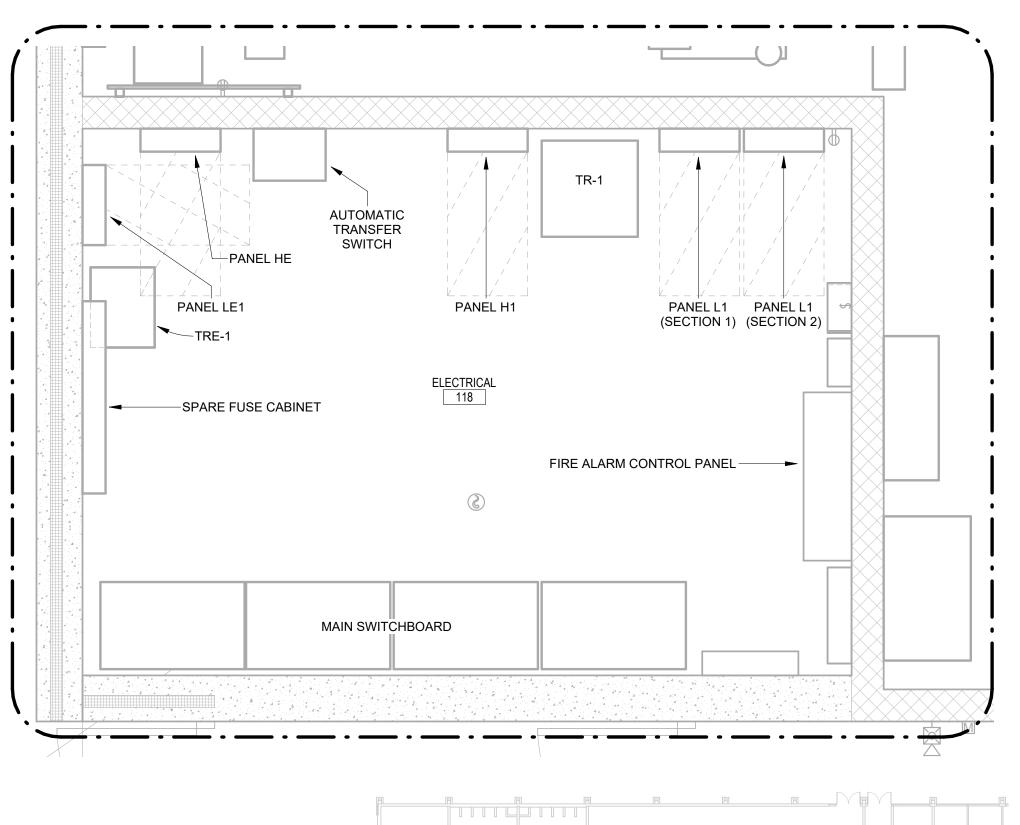
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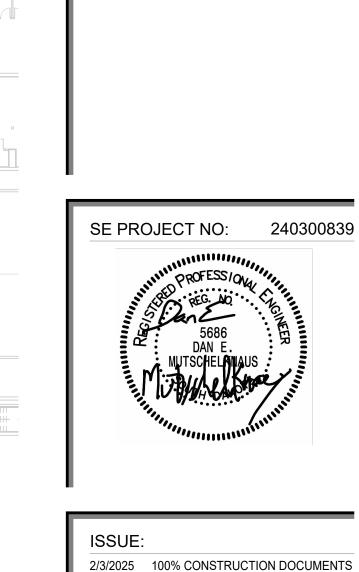
SHEET TITLE:

WRESTLING & BASEBALL -ELECTRICAL DEMOLITION PLAN









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TYPICAL WAP LOCATION - INSTALL ONE CAT6A CABLE (COLOR WHITE) CENTRALLY TO OWNER PROVIDE WIRELESS ACCESS POINT. PULL CABLES TO MECH RM 111 NETWORK CLOSET AS NOTED ON PLAN. LEAVE 15' SERVICE LOOP INSTALLED BY BICSI CERTIFIED

REMODEL AREAS

OVERALL PLAN

2. TYPICAL - GC SHALL BE RESPONSIBLE TO CUT CHANNELS INTO THE EXG CMU WALL SO THAT CONDUIT AND OUTLET BOXES FOR RECEPTACLES ARE RECESSED FLUSH WITH EXG WALL. PATCHING OF WALL BY GC, NEW TILE FINISHES WILL BE INSTALLED OVER THE PATCHED WALL. COORDINATE ROUTING WITH GC FOR CUTTING WALL.

3. INSTALL SPECIAL OUTLET RECEPTACLES SEE POWER & DATA SPECIAL OUTLETS FOR TYPE USED. SPACE EVENLY BETWEEN LOCKERS UNLESS ILLUSTRATED DIFFERENTLY. SEE ELEVATIONS FOR DETAILS.

5. PROVIDE J-BOX ON CEILING WITH 120V POWER FOR FUTURE SIGNAGE. COORDINATE EXACT LOCATION

6. TYPICAL TV DATA: INSTALL TWO GANG BOX OPENING AND PROVIDE 4-CAT 6 CABLES IN CONDUIT ROUTED TO CORRIDOR. PULL CABLES TO MECH RM 49 NETWORK CLOSET AS NOTED ON PLAN. LEAVE 15' SERVICE LOOP INSTALLED BY BISCI CERTIFIED INSTALLER. VERIFY EXACT HEIGHTS AND LOCATIONS WITH OWNER.

7. INSTALL 1" CONDUIT BELOW GRADE FOR POWER TO SERVE LOCKER TOE-KICK OUTLETS.

PROJECT:

KEYPLAN

G

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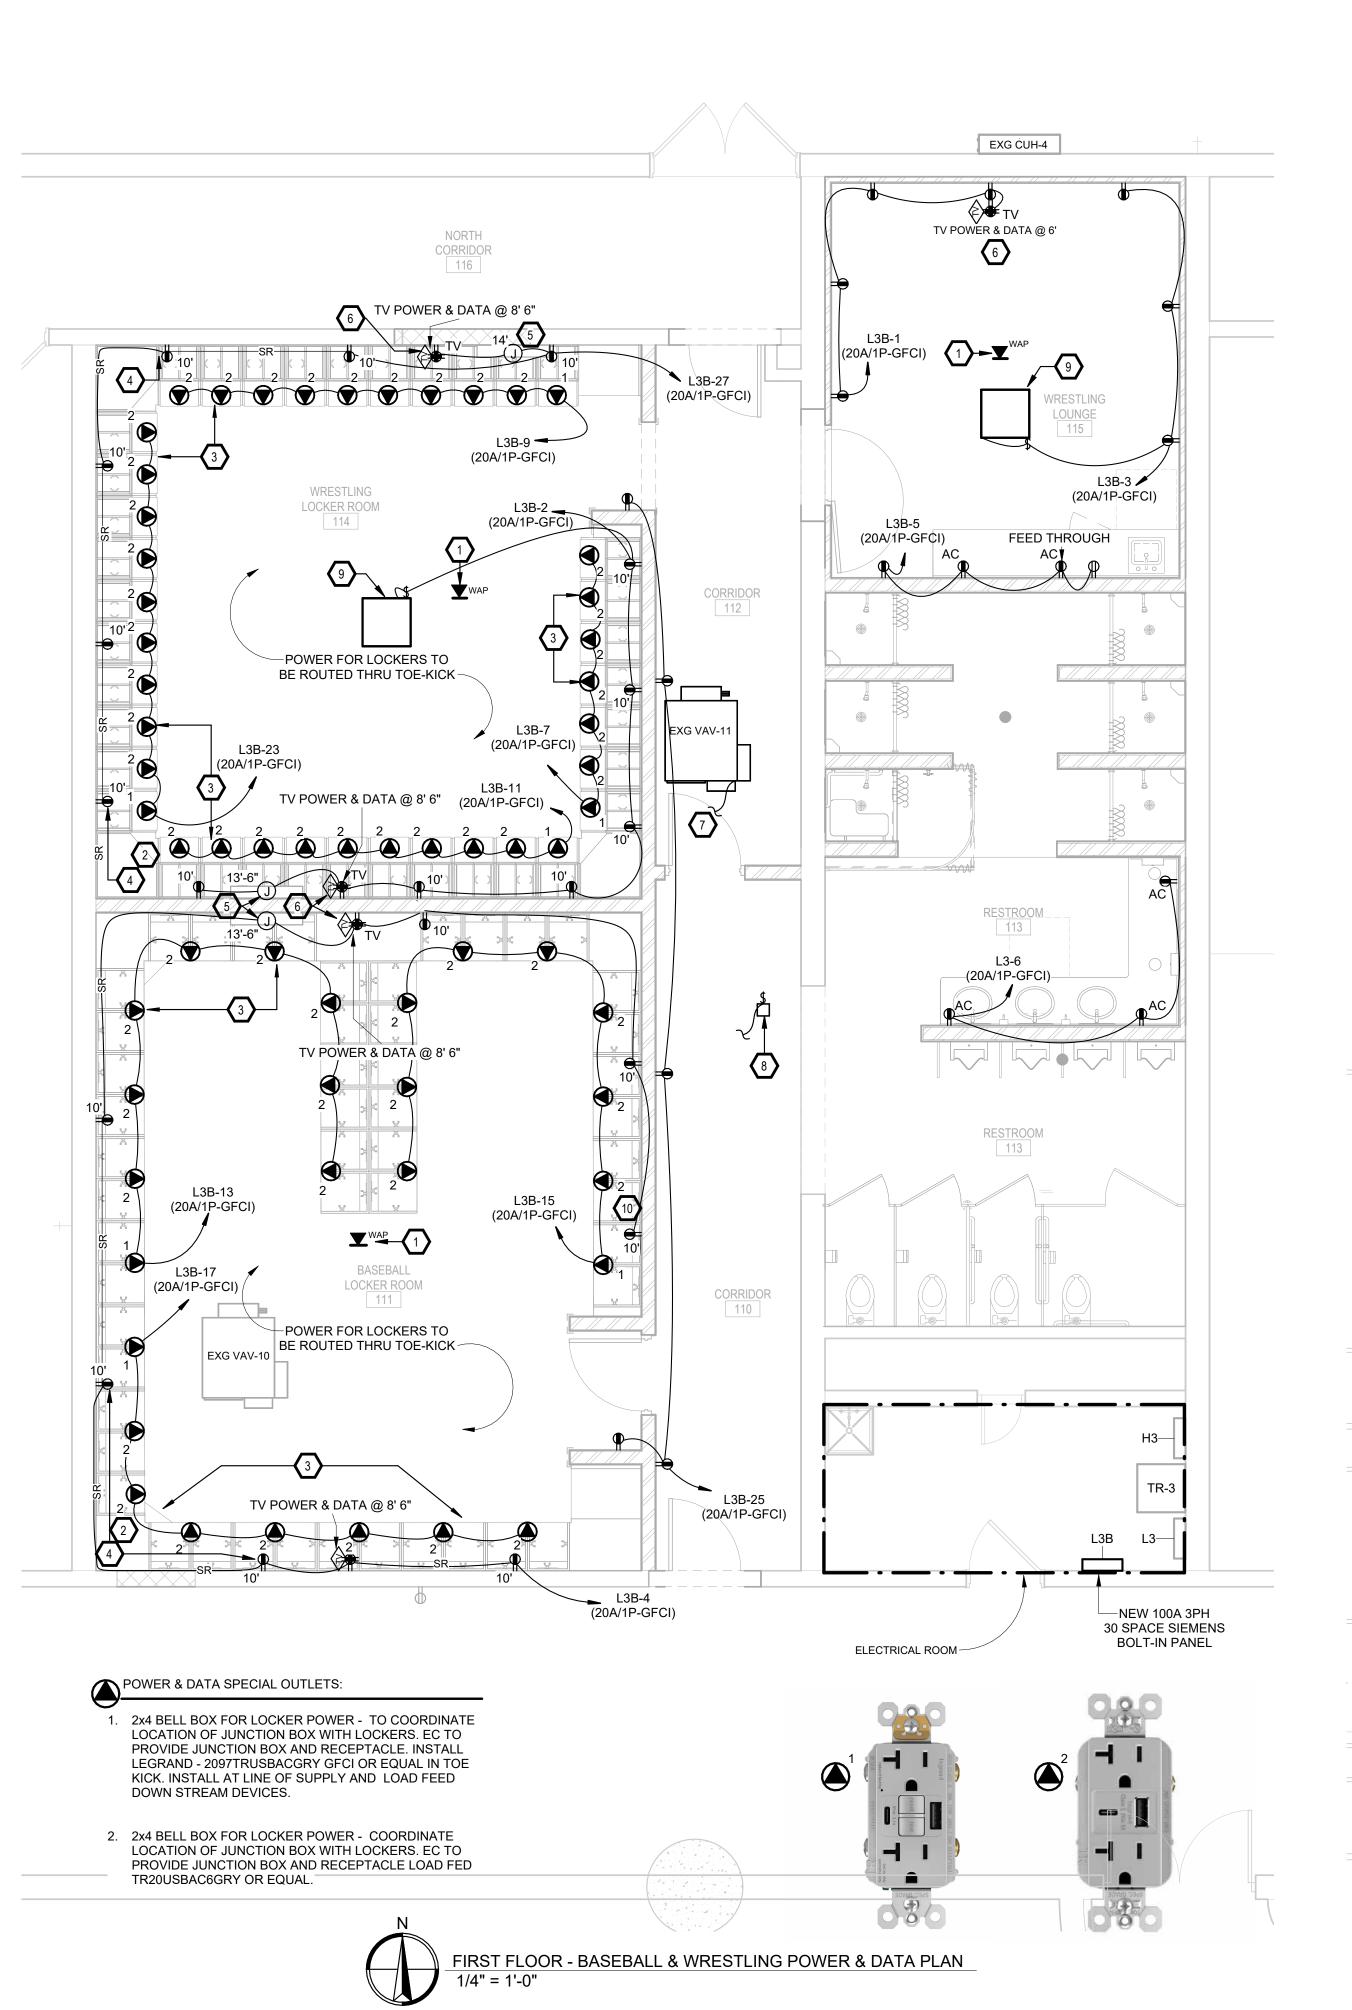
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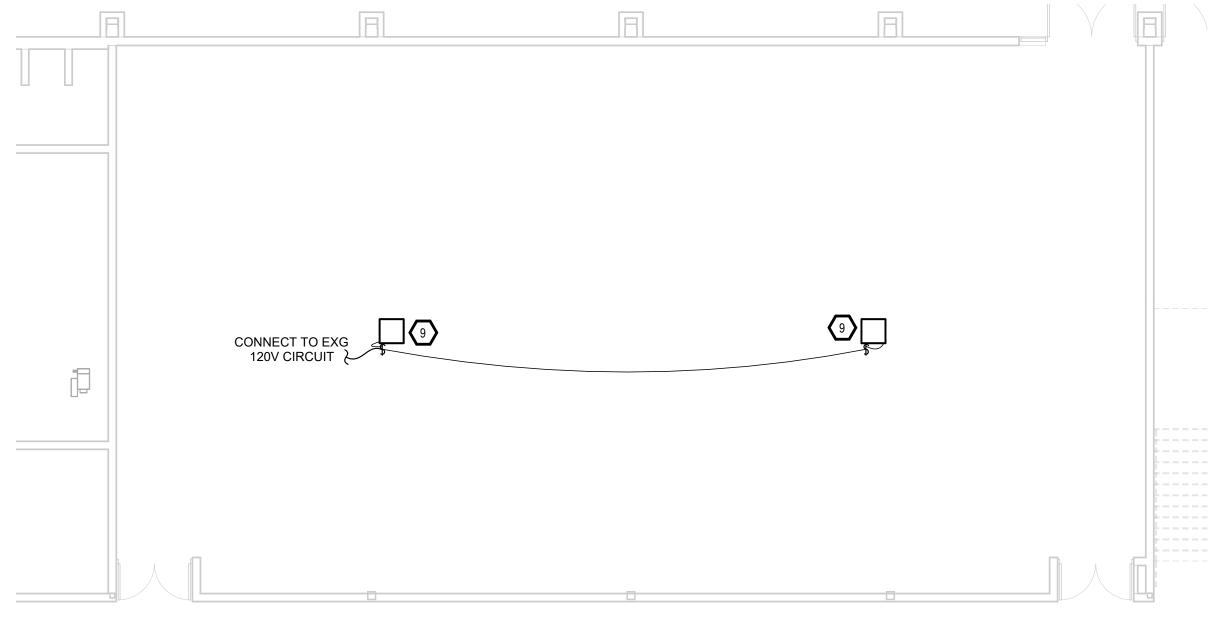
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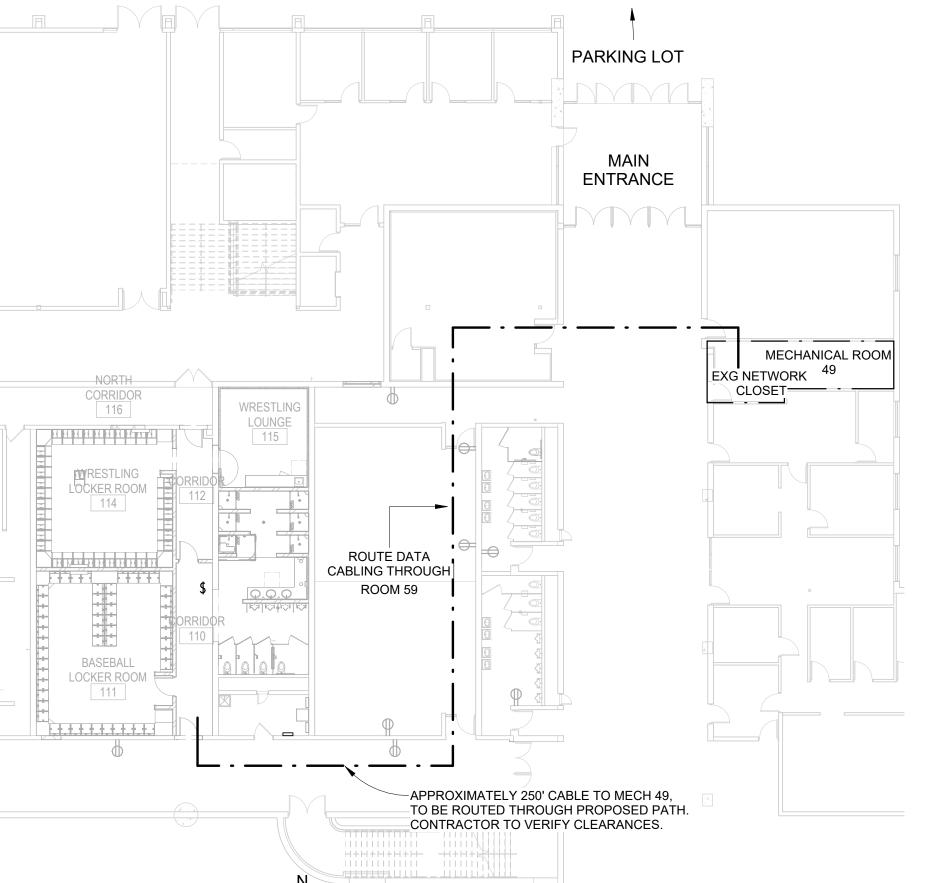
SHEET TITLE:

TRACK & FIELD - POWER & DATA PLAN











FIRST FLOOR - BASEBALL & WRESTLING NETWORK CLOSET

KEYNOTES:

- TYPICAL WAP LOCATION INSTALL ONE CAT6A CABLE (COLOR WHITE) CENTRALLY TO OWNER PROVIDE WIRELESS ACCESS POINT. PULL CABLES TO MECH RM 49 NETWORK CLOSET AS NOTED ON PLAN. LEAVE 15' SERVICE LOOP IN CEILING FOR FLEXIBILITY. ALL DATA SHALL BE INSTALLED BY BICSI CERTIFIED INSTALLER.
- 2. GFCI DEVICES MOUNTED @ 10' SHALL BE BLACK DEVICES WITH BLACK FACEPLATES WHERE APPLICABLE.
- 3. INSTALL SPECIAL OUTLET RECEPTACLES SEE POWER & DATA SPECIAL OUTLETS FOR TYPE USED. SPACE EVENLY BETWEEN LOCKERS UNLESS ILLUSTRATED DIFFERENTLY. SEE ELEVATIONS FOR DETAILS.
- 4. TYPICAL: INSTALL SURFACE MOUNTED RECEPTACLES AS REQUIRED. SEE SPEC'S FOR SURFACE RACEWAY DETAILS.
- 5. OWNER PROVIDED SIGNAGE, PROVIDE J-BOX ON CEILING WITH 120V POWER FOR FUTURE SIGNAGE. COORDINATE EXACT LOCATION WITH OWNER.
- 6. TYPICAL TV DATA: INSTALL TWO GANG BOX OPENING AND PROVIDE 4-CAT 6 CABLES IN CONDUIT ROUTED TO CORRIDOR, PULL CABLES TO MECH RM 49 NETWORK CLOSET AS NOTED ON PLAN. LEAVE 15' SERVICE LOOP INSTALLED BY BISCI CERTIFIED INSTALLER. VERIFY EXACT HEIGHTS AND LOCATIONS WITH OWNER.
- 7. RE-WORK AND RE-CONNECT TO EXG CIRCUIT.
- 8. BY ALTERNATE #2 VC TO PROVIDE & INSTALL AIR DISINFECTION SYSTEM IN DUCTWORK WHERE INDICATED ON PLANS. EC TO PROVIDE 120V POWER WIRING & DISCONNECT, COORDINATE WITH VC.
- 9. BY ALTERNATE #2 VC TO PROVIDE & INSTALL AIR DISINFECTION SYSTEM IN EXPOSED STRUCTURE OR GPDW CEILING WHERE INDICATED ON PLANS. 120V POWER WIRING & DISCONNECT BY EC, COORDINATE WITH VC.
- 10. REINSTALL SALVAGED SCOREBOARD CLOCK. VERIFY WITH OWNER ON EXACT HEIGHT & LOCATION.

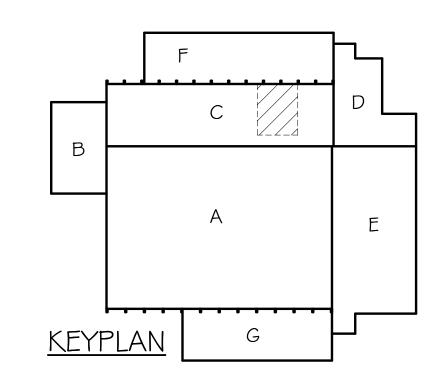

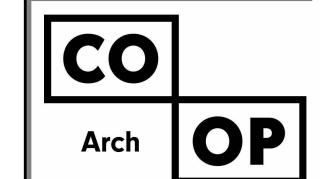

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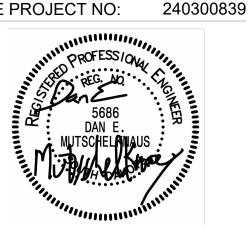
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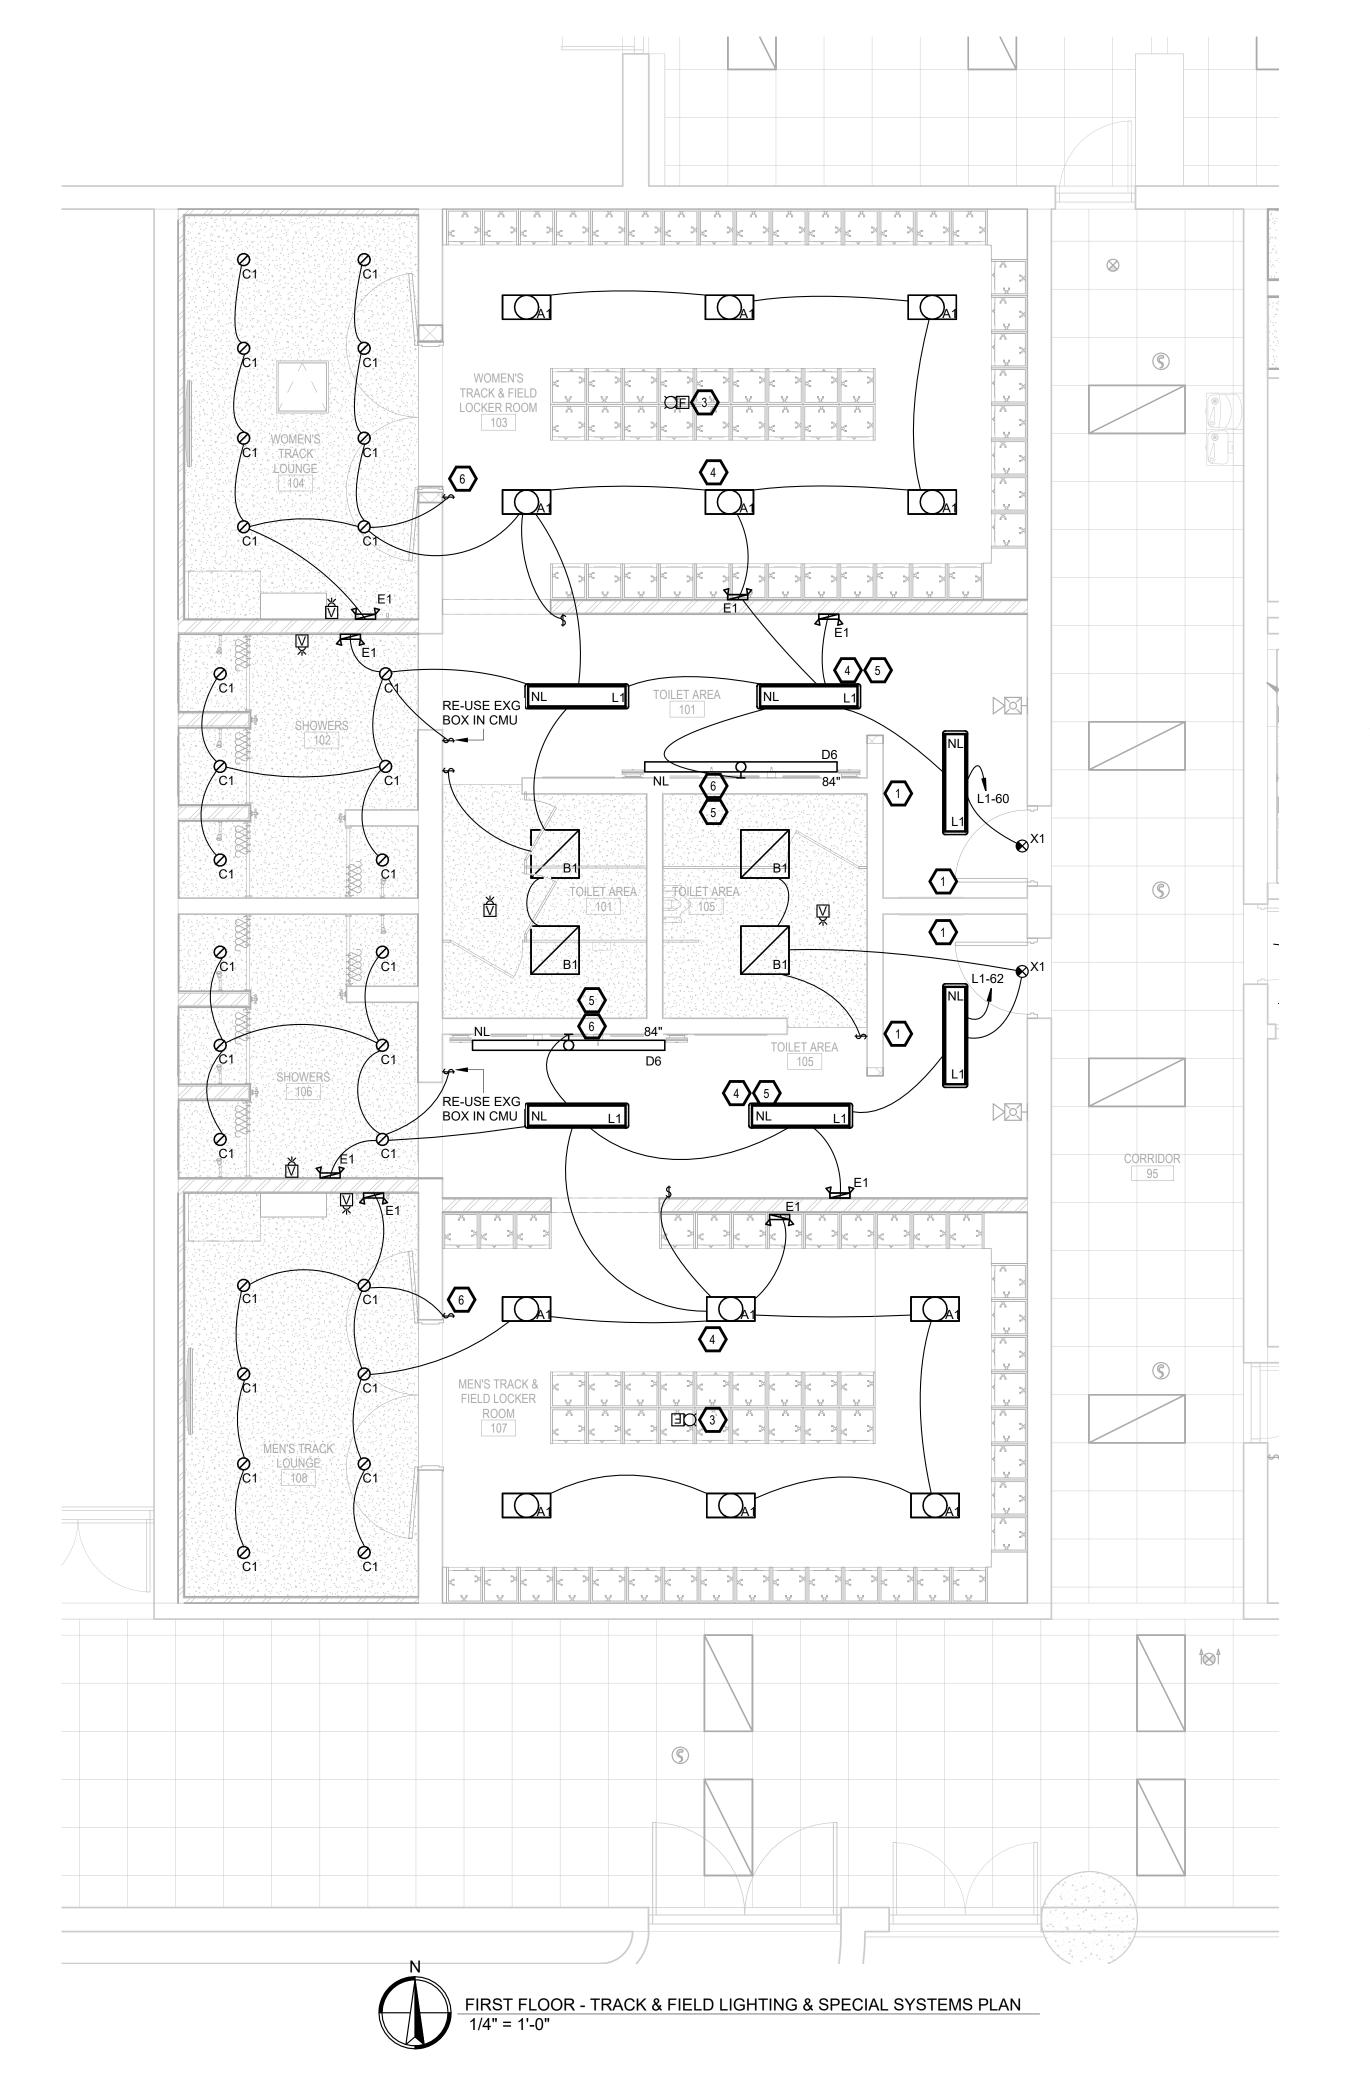
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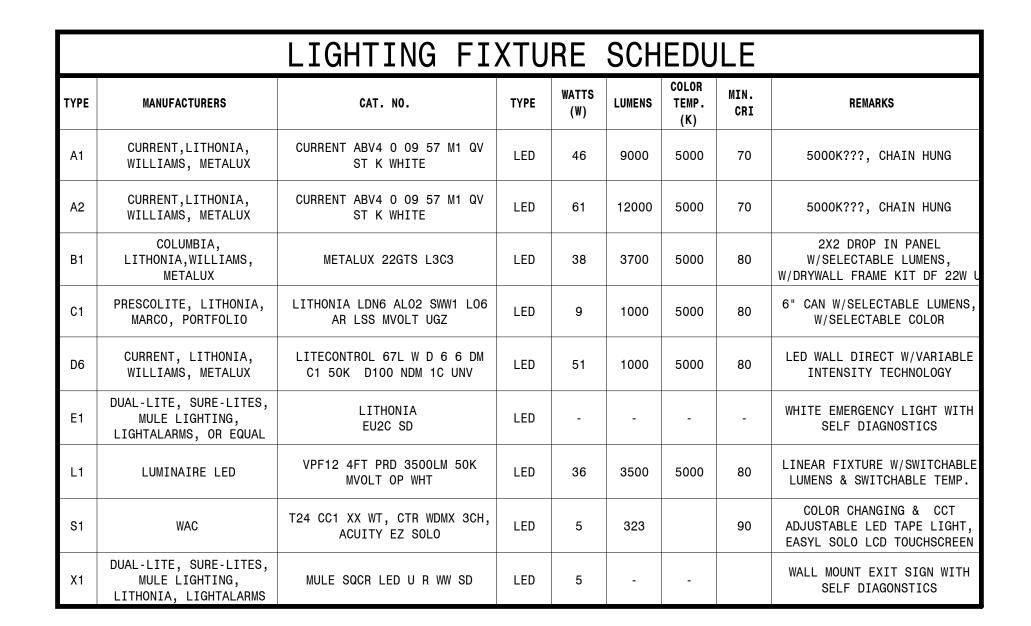
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SHEET TITLE:

WRESTLING & BASEBALL -POWER & DATA PLAN





ELECTRICAL NOTES

1. COORDINATE WITH GC FOR PATCHING OF DEMOED


NOT USED

3. INSTALL CEILING MOUNTED SIEMENS HORN/STROBE FIRE ALARM DEVICES. CONTRACTOR TO VERIFY CLEARANCES.

4. EC SHALL HANG TYPE "A1 & L1" LIGHT FIXTURES AT 10 FOOT AFF AT LOCATIONS SHOWN. CONTRACTOR SHALL NOTIFY ARCHITECT/ENGINEER OF ANY CONFLICTS PRIOR TO FIXTURE INSTALLATION.

BE CONTINUOUSLY OPERATING.

6. TYPICAL - GC SHALL BE RESPONSIBLE TO CUT CHANNELS INTO THE EXG CMU WALL SO THAT

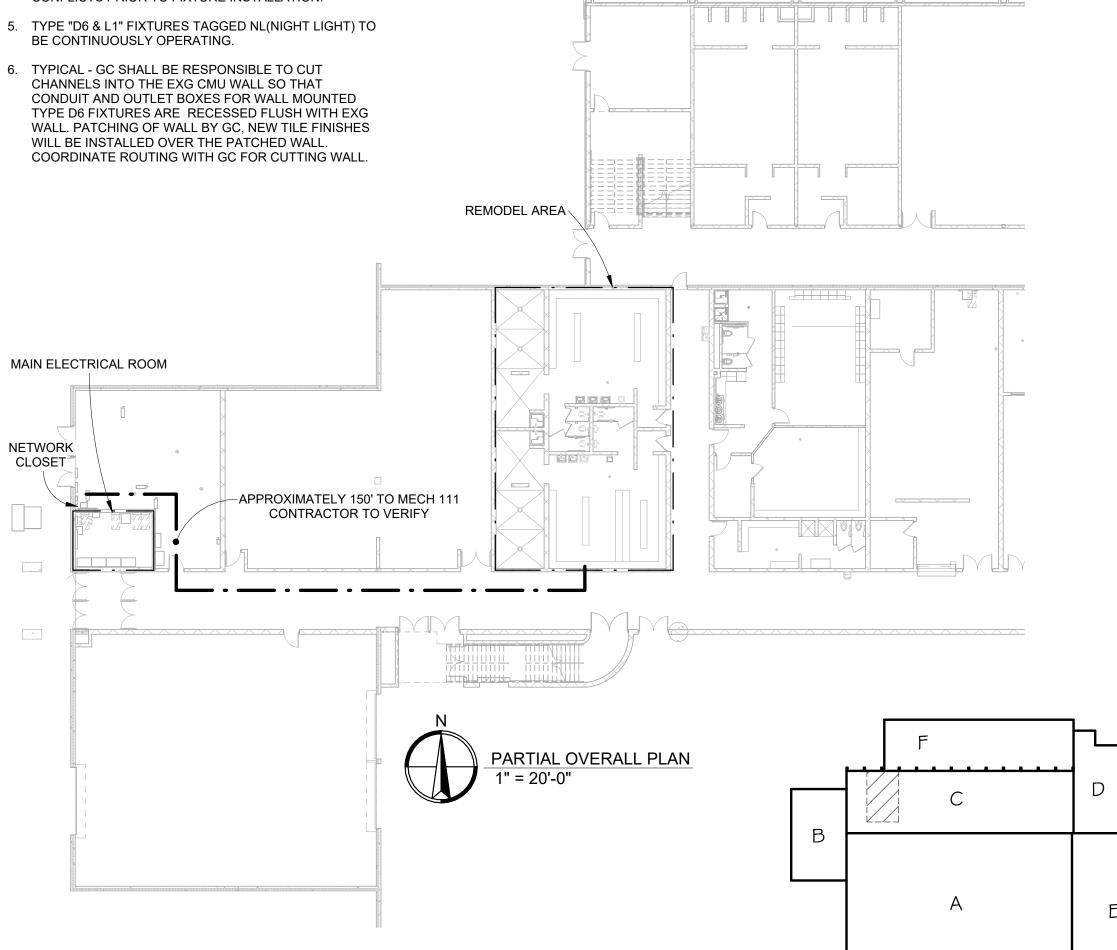



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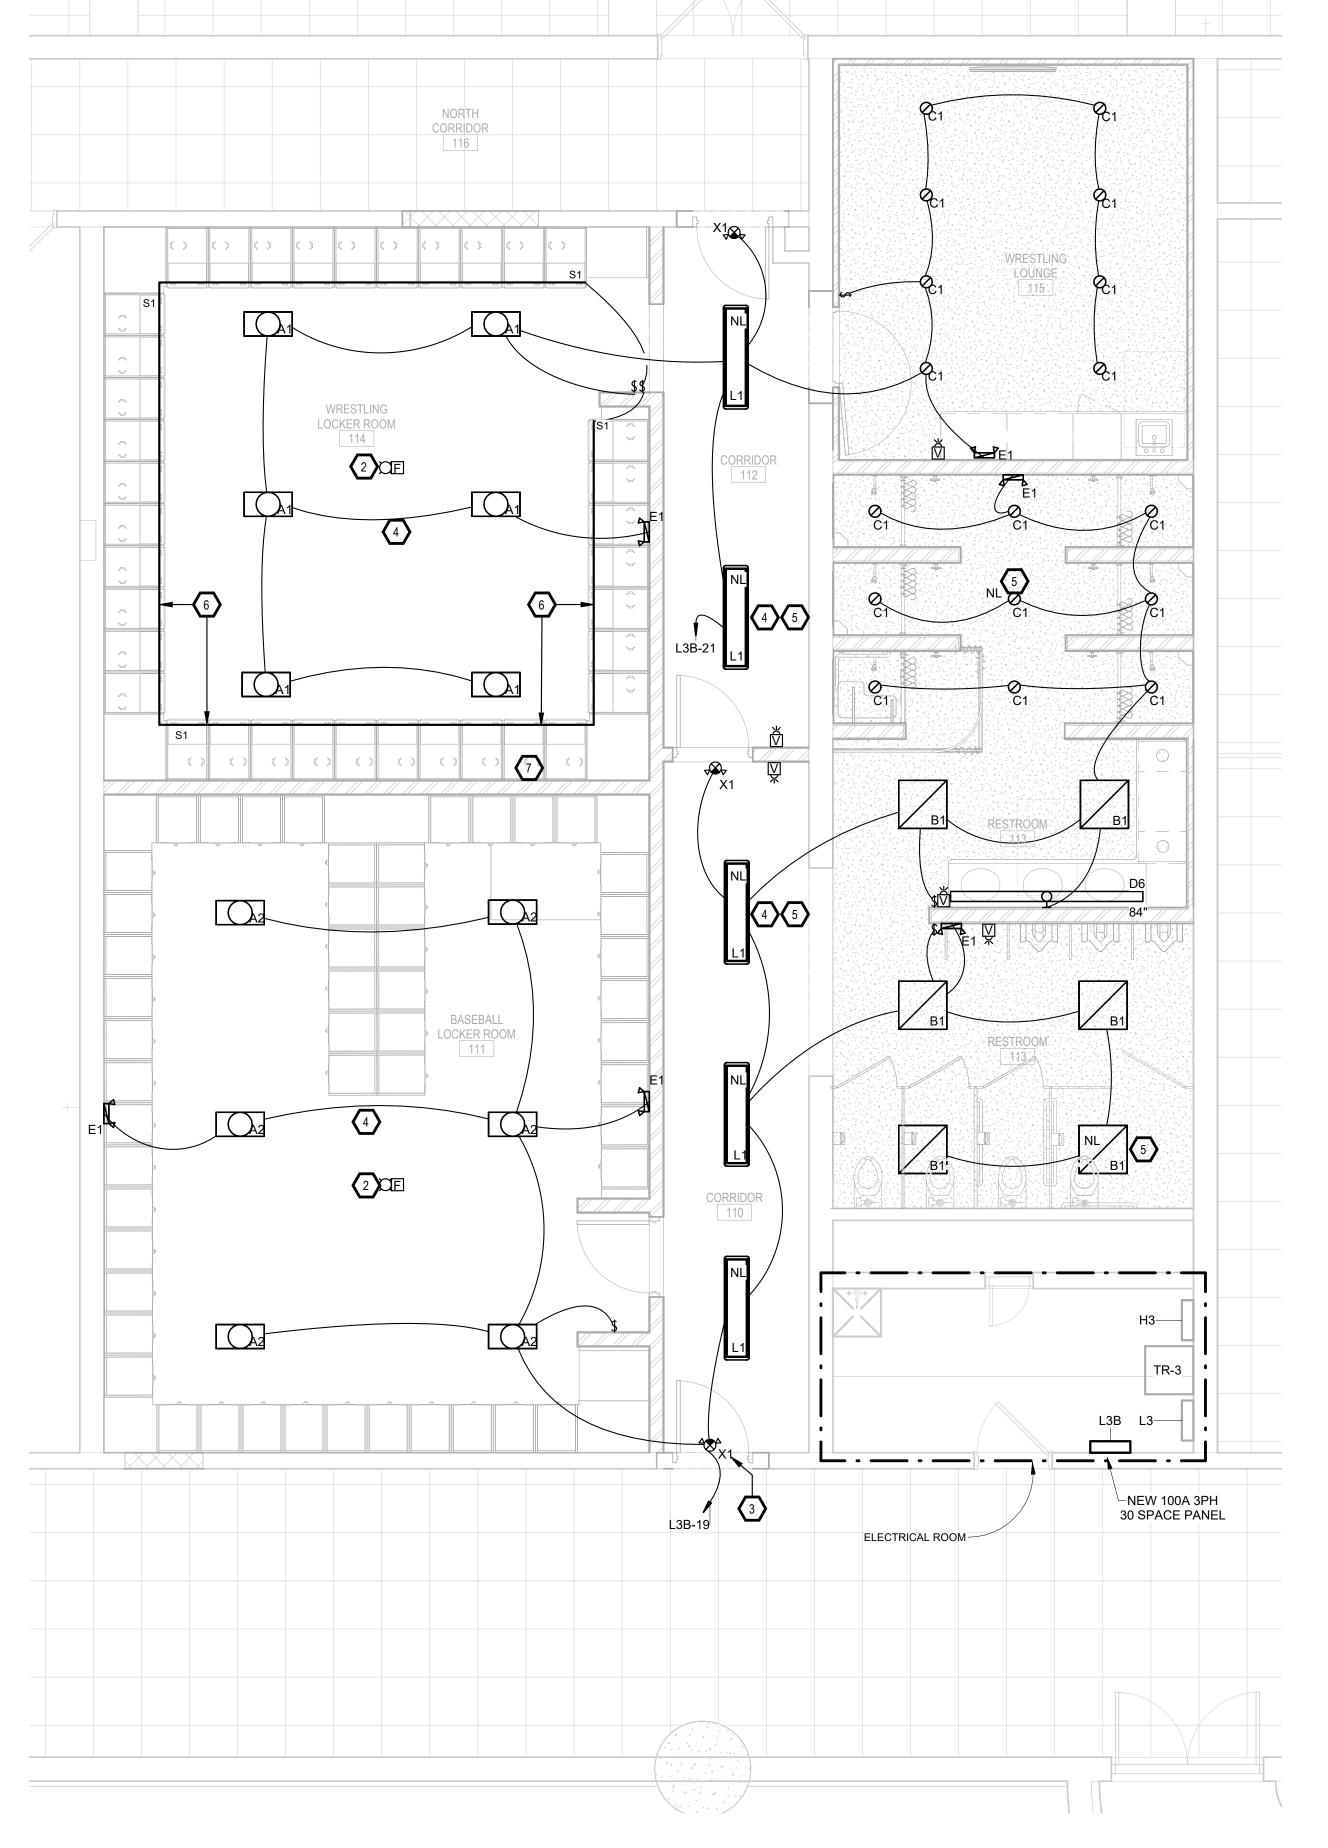
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KEYPLAN

NSU - BARNETT CENTER -LOCKER ROOM UPGRADES OSE # RO124--16X NORTHERN STATE UNIVERSITY ABERDEEN, SOUTH DAKOTA


SHEET TITLE:

TRACK & FIELD - LIGHTING & SPECIAL SYSTEMS PLAN





FIRST FLOOR - BASEBALL & WRESTLING LIGHTING & SPECIAL SYSTEMS PLAN

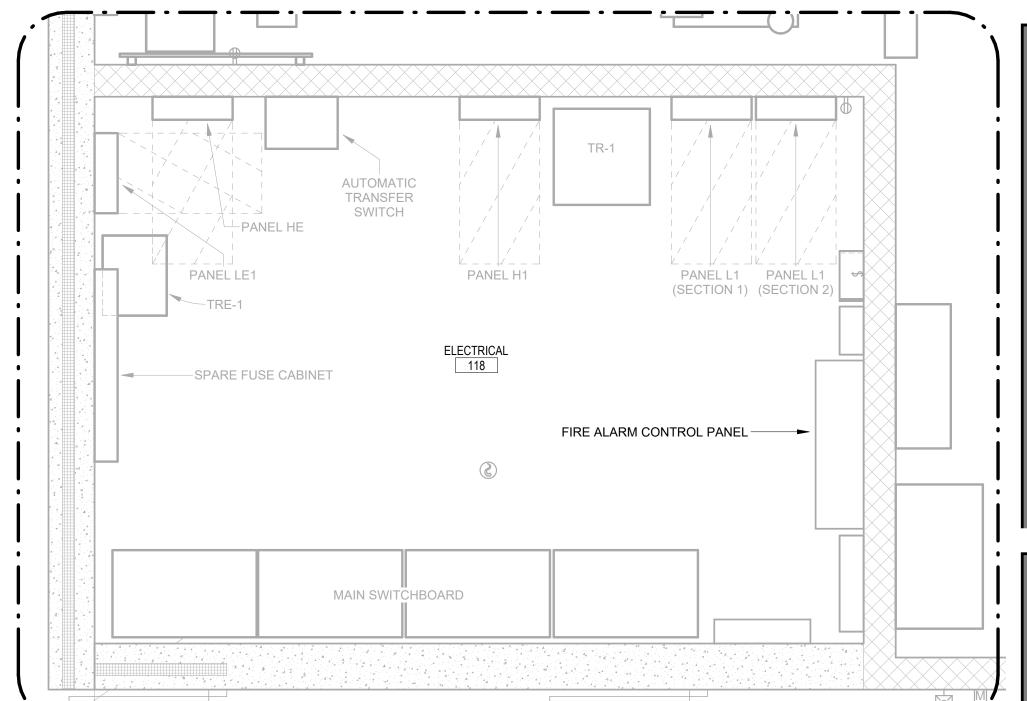




ENLARGED ELECTRICAL ROOM 118 1/2" = 1'-0"

		LIGHTING FI	XTU	RE	SCH	EDU	LE	
ТҮРЕ	MANUFACTURERS	CAT. NO.	TYPE	WATTS (W)	LUMENS	COLOR TEMP. (K)	MIN. CRI	REMARKS
A1	CURRENT,LITHONIA, WILLIAMS, METALUX	CURRENT ABV4 0 09 57 M1 QV ST K WHITE	LED	46	9000	5000	70	5000K???, CHAIN HUNG
A2	CURRENT,LITHONIA, WILLIAMS, METALUX	CURRENT ABV4 0 09 57 M1 QV ST K WHITE	LED	61	12000	5000	70	5000K???, CHAIN HUNG
B1	COLUMBIA, LITHONIA,WILLIAMS, METALUX	METALUX 22GTS L3C3	LED	38	3700	5000	80	2X2 DROP IN PANEL W/SELECTABLE LUMENS, W/DRYWALL FRAME KIT DF 22W U
C1	PRESCOLITE, LITHONIA, MARCO, PORTFOLIO	LITHONIA LDN6 ALO2 SWW1 LO6 AR LSS MVOLT UGZ	LED	9	1000	5000	80	6" CAN W/SELECTABLE LUMENS, W/SELECTABLE COLOR
D6	CURRENT, LITHONIA, WILLIAMS, METALUX	LITECONTROL 67L W D 6 6 DM C1 50K D100 NDM 1C UNV	LED	51	1000	5000	80	LED WALL DIRECT W/VARIABLE INTENSITY TECHNOLOGY
E1	DUAL-LITE, SURE-LITES, MULE LIGHTING, LIGHTALARMS, OR EQUAL	LITHONIA EU2C SD	LED	-	-	-	-	WHITE EMERGENCY LIGHT WITH SELF DIAGNOSTICS
L1	LUMINAIRE LED	VPF12 4FT PRD 3500LM 50K MVOLT OP WHT	LED	36	3500	5000	80	LINEAR FIXTURE W/SWITCHABLE LUMENS & SWITCHABLE TEMP.
S1	WAC	T24 CC1 XX WT, CTR WDMX 3CH, ACUITY EZ SOLO	LED	5	323		90	COLOR CHANGING & CCT ADJUSTABLE LED TAPE LIGHT, EASYL SOLO LCD TOUCHSCREEN
X1	DUAL-LITE, SURE-LITES, MULE LIGHTING, LITHONIA, LIGHTALARMS	MULE SQCR LED U R WW SD	LED	5	-	-		WALL MOUNT EXIT SIGN WITH SELF DIAGONSTICS

ELECTRICAL NOTES

- NOT USED
- 2. INSTALL CEILING MOUNTED SIEMENS HORN/STROBE FIRE ALARM DEVICES. CONTRACTOR TO VERIFY CLEARANCES.
- 3. NEW EXIT SIGN PROVIDE SURFACE MOUNTED RACEWAY.
- 4. EC SHALL HANG TYPE "A1 & L1" LIGHT FIXTURES AT 10 FOOT AFF AT LOCATIONS SHOWN. CONTRACTOR SHALL NOTIFY ARCHITECT/ENGINEER OF ANY CONFLICTS PRIOR TO FIXTURE INSTALLATION.
- 5. TYPE "B1, C1 & L1" FIXTURES TAGGED NL(NIGHT LIGHT) TO BE CONTINUOUSLY OPERATING.
- 6. COLOR OF CHANNEL SHALL BE SELECTED BY ARCHITECT. SUPPLIER SHALL PROVIDE POWER SUPPLIES AND NECESSARY FITTINGS FOR A COMPLETE AND FUNCTIONING SYSTEM. SEE ARCHITECTURAL DETAIL 7 ON SHEET A-605 FOR COORDINATION.
- PROVIDE AND INSTALL POWER SUPPLY FOR RECESSED TOE KICK LIGHTING "S1". INSTALL JUNCTION BOX FLUSH WITHIN WALL CONCEALING POWER SUPPLY.

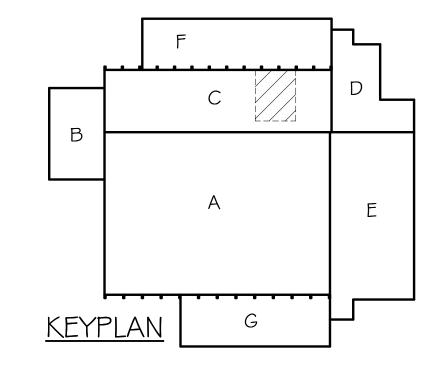



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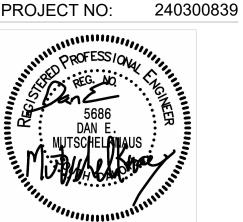
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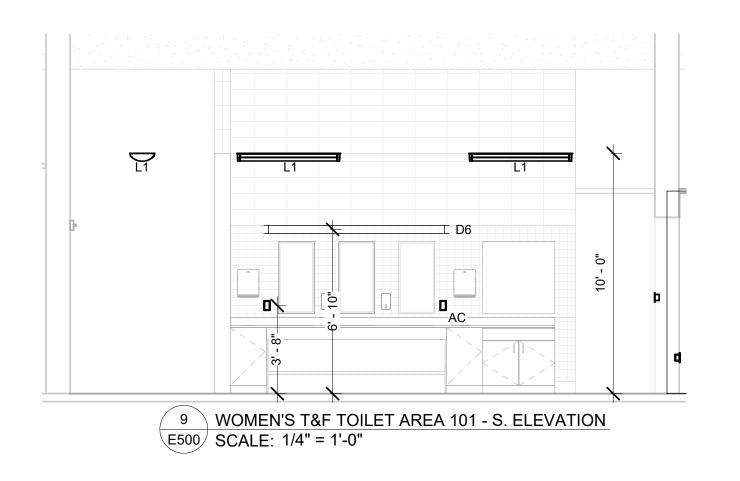
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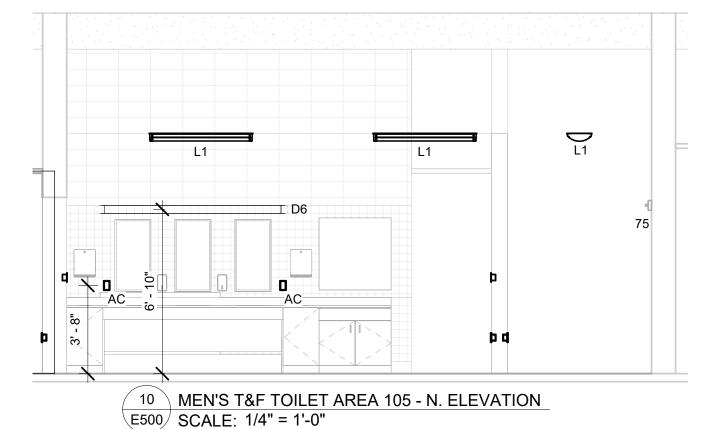
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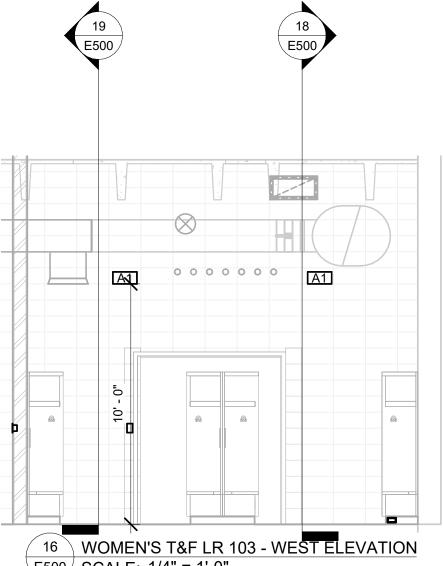
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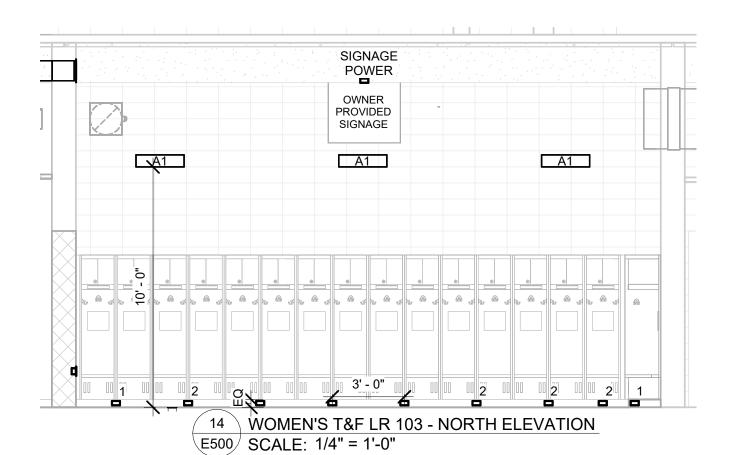
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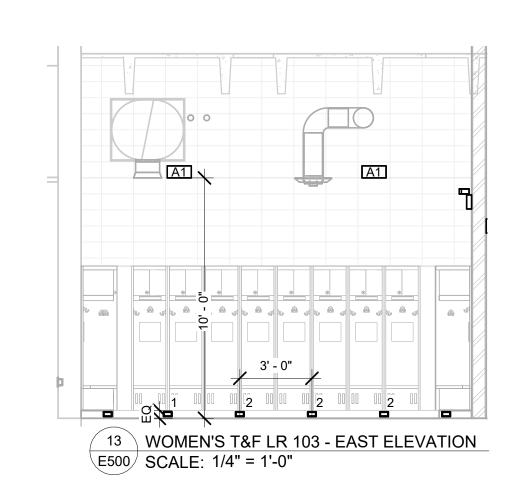
WRESTLING & BASEBALL -LIGHTING & SPECIAL SYSTEMS PLAN














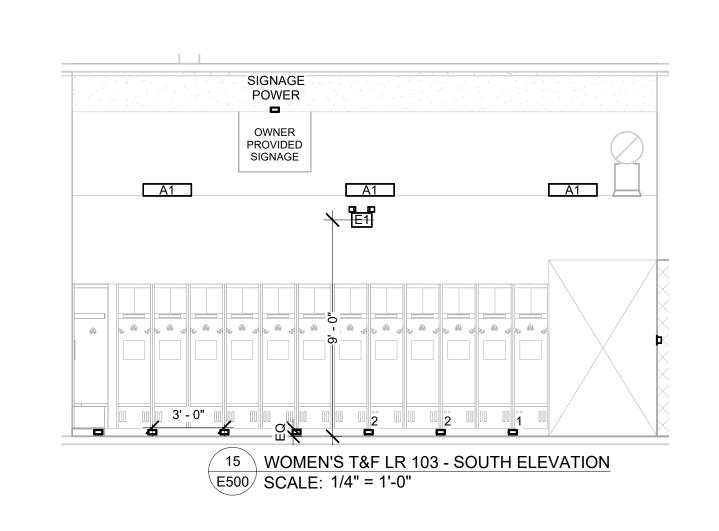

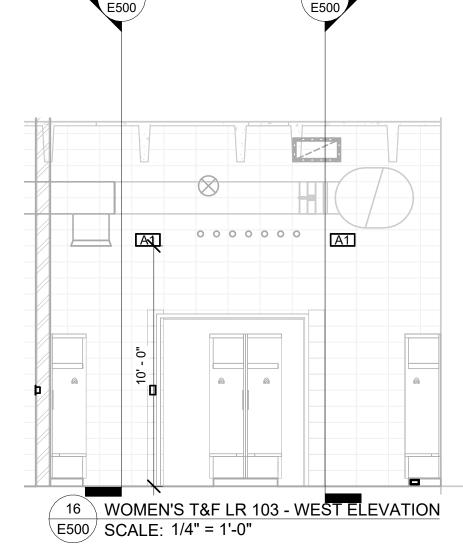



POWER & DATA SPECIAL OUTLETS:


- 2x4 BELL BOX FOR LOCKER POWER TO COORDINATE LOCATION OF JUNCTION BOX WITH LOCKERS. EC TO PROVIDE JUNCTION BOX AND RECEPTACLE. INSTALL LEGRAND - 2097TRUSBACGRY GFCI OR EQUAL IN TOE KICK. INSTALL AT LINE OF SUPPLY AND LOAD FEED DOWN STREAM DEVICES.
- 2. 2x4 BELL BOX FOR LOCKER POWER COORDINATE LOCATION OF JUNCTION BOX WITH LOCKERS. EC TO PROVIDE JUNCTION BOX AND RECEPTACLE LOAD FED TR20USBAC6GRY OR EQUAL.

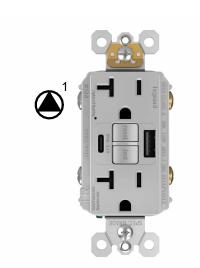





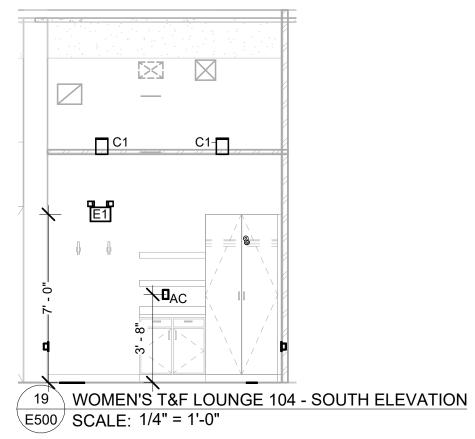

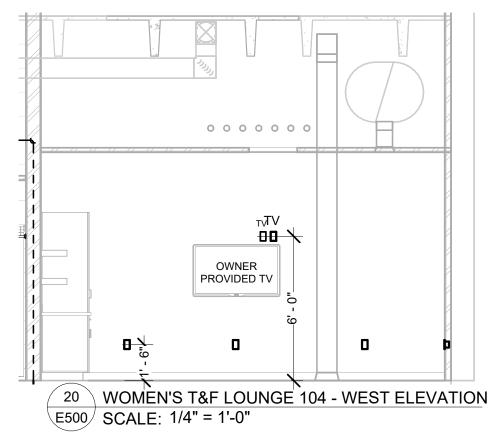

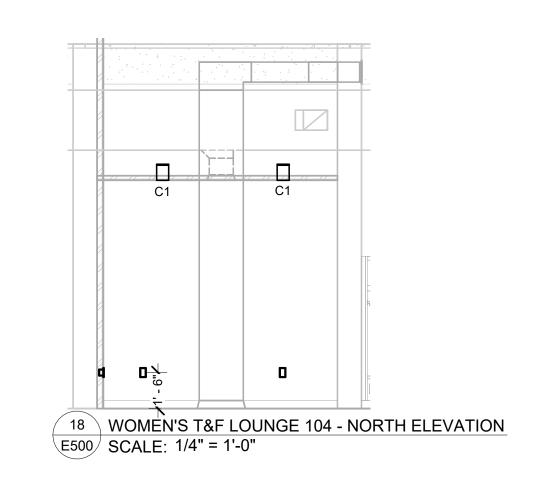

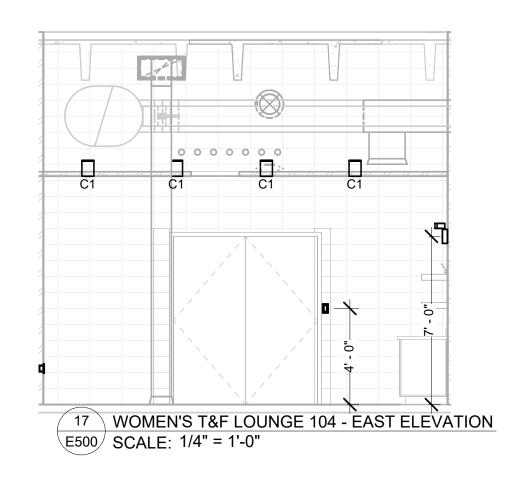

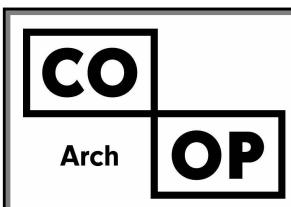

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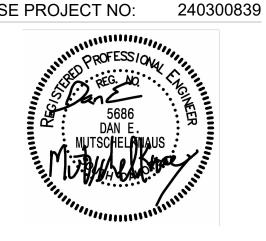
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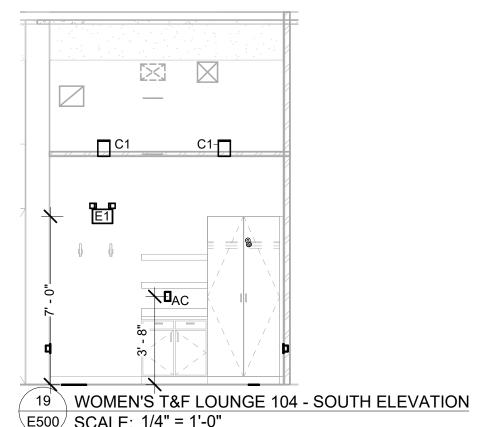
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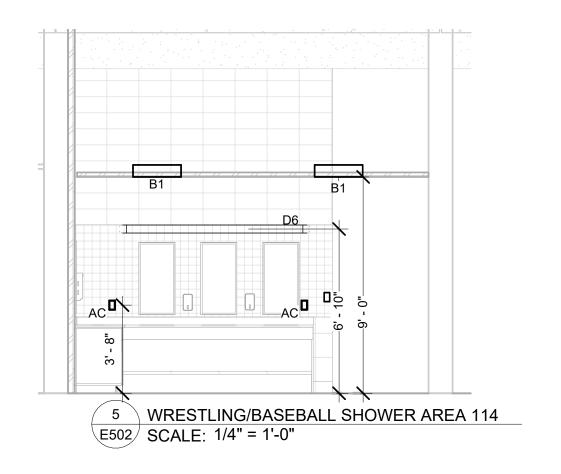
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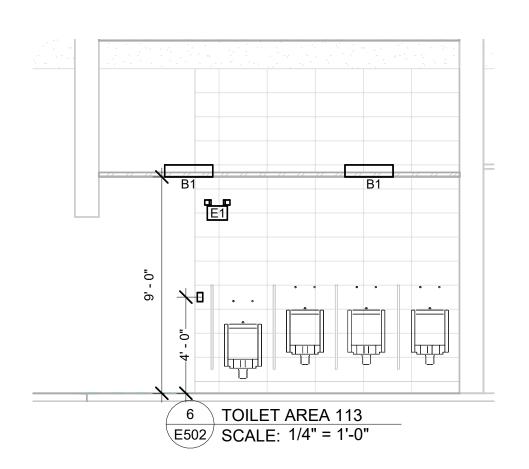
ELECTRICAL SECTIONS -TRACK & FIELD
















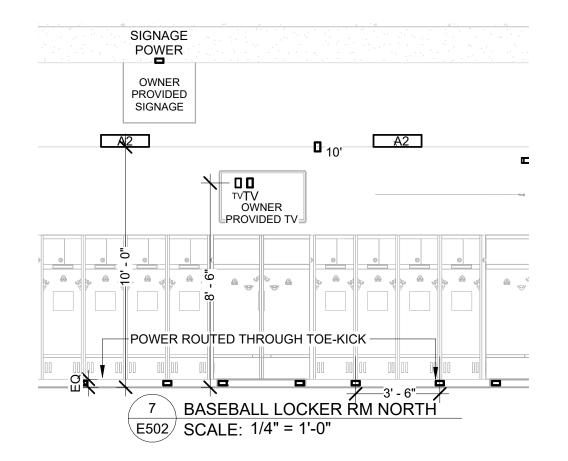


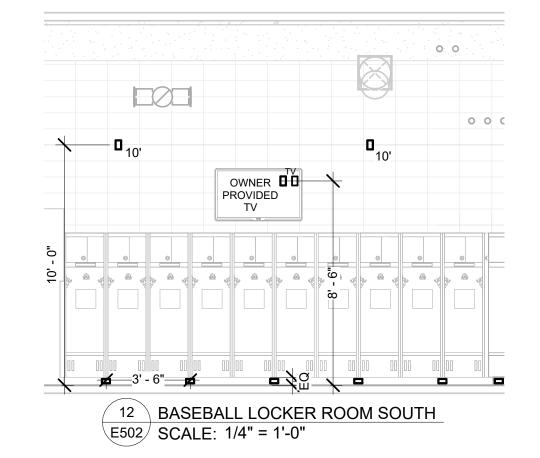

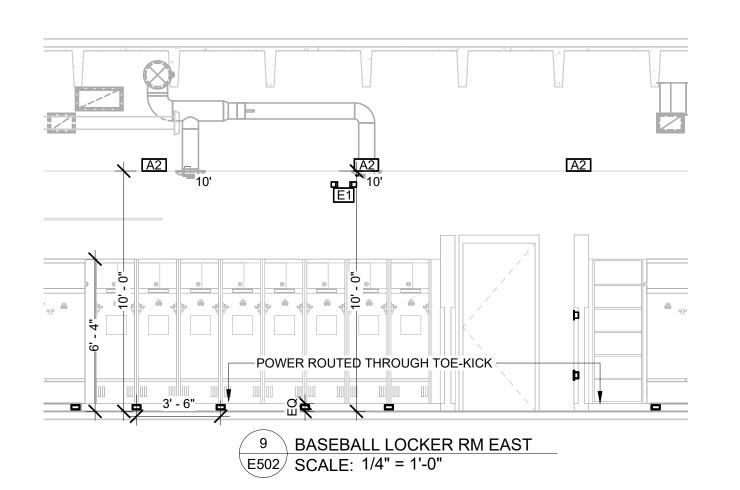

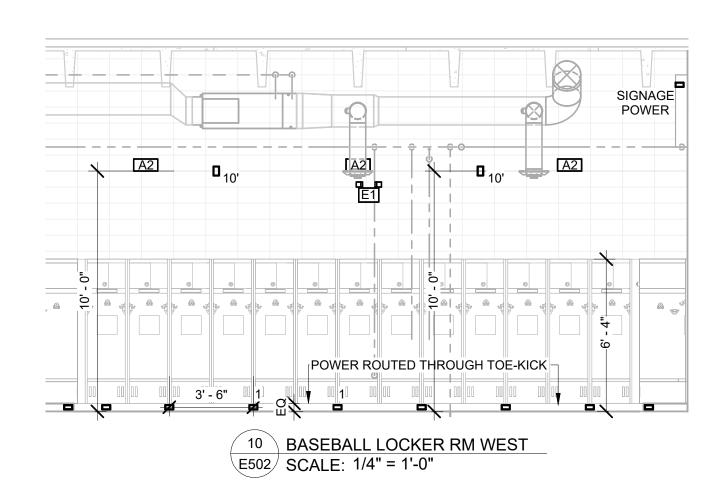


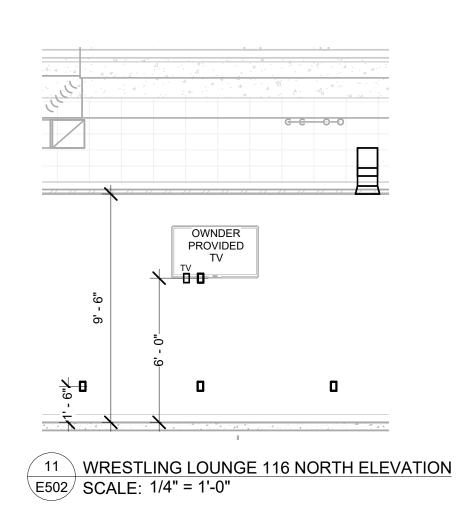


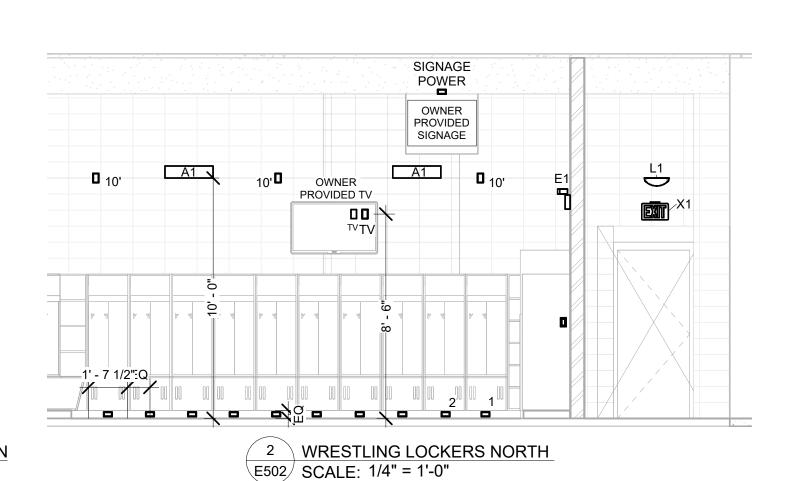



POWER & DATA SPECIAL OUTLETS:

- 2x4 BELL BOX FOR LOCKER POWER TO COORDINATE LOCATION OF JUNCTION BOX WITH LOCKERS. EC TO PROVIDE JUNCTION BOX AND RECEPTACLE. INSTALL LEGRAND - 2097TRUSBACGRY GFCI OR EQUAL IN TOE KICK. INSTALL AT LINE OF SUPPLY AND LOAD FEED DOWN STREAM DEVICES.
- 2x4 BELL BOX FOR LOCKER POWER COORDINATE LOCATION OF JUNCTION BOX WITH LOCKERS. EC TO PROVIDE JUNCTION BOX AND RECEPTACLE LOAD FED TR20USBAC6GRY OR EQUAL.

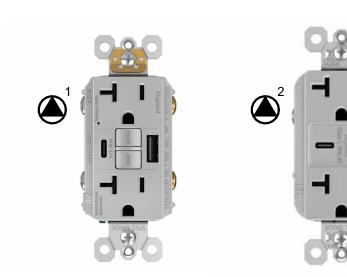

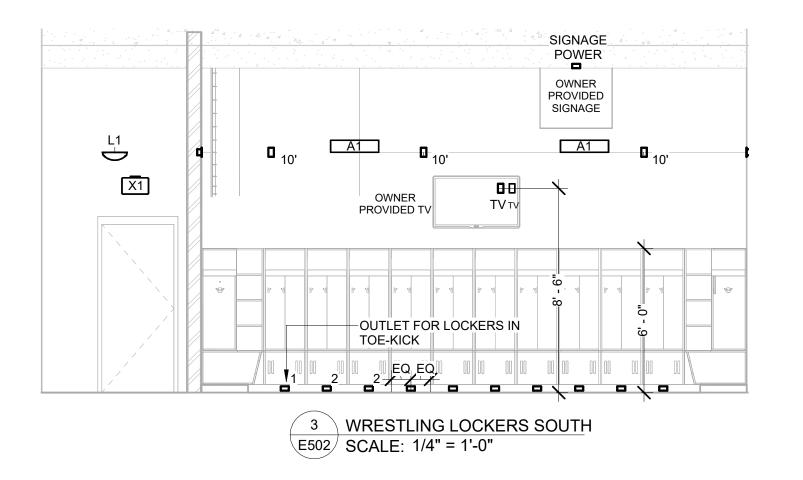

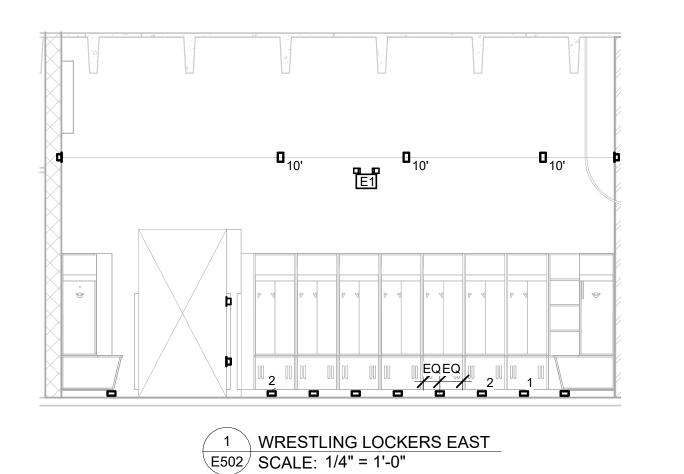

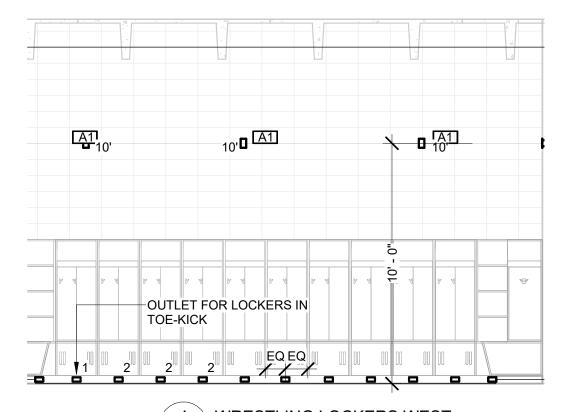

WRESTLING LOCKERS WEST

SCALE: 1/4" = 1'-0"

CO
Arch OP

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440 E. 8th St. 221 Sioux Falls, SD 57103 Phone: 605-334-9999

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SE PROJECT NO: 240300839

PROFESS/ON

5686

DAN E.

ISSUE:

2/3/2025 100% CONSTRUCTION DOCUMENTS

REV. DATE

REVISION SCHEDULE:

REV. # REV. DSC.


PROJECT:


NSU - BARNETT CENTER -LOCKER ROOM UPGRADES OSE # RO124--16X NORTHERN STATE UNIVERSITY ABERDEEN, SOUTH DAKOTA

SHEET TITLE:

ELECTRICAL SECTIONS -BASEBALL & WRESTLING

Panel: L3B Location: Mounting: Surface					Volts: 120/208 Wye Phases: 3 Wires: 4						A.I.C. Rating: Mains Type: MLO Rating: 100 A			
скт	LOAD	CKT BRK	POLES	A	\	E	3	C	;	POLES	CKT BRK	LOAD	скт	
1	Receptacle	20 A	1	900 VA	1760 VA					1	20 A	Receptacle	2	
3	Receptacle	20 A	1			660 VA	540 VA			1	20 A	Receptacle CORRIDOR 110	4	
5	Receptacle	20 A	1					560 VA					6	
7	Power	20 A	1	0 VA									8	
9	Power	20 A	1			0 VA							10	
11	Power WRESTLING LOCKER ROOM 115	20 A	1					0 VA					12	
13	Power	20 A	1	0 VA									14	
15	Power	20 A	1			0 VA							16	
17	Power	20 A	1					0 VA					18	
19	Lighting	20 A	1	1909 VA									20	
21	Lighting	20 A	1			1267 VA							22	
23	Power WRESTLING LOCKER ROOM 115	20 A	1					0 VA					24	
25	Receptacle CORRIDOR 110	20 A	1	900 VA									26	
27		20 A	1			860 VA							28	
29													30	

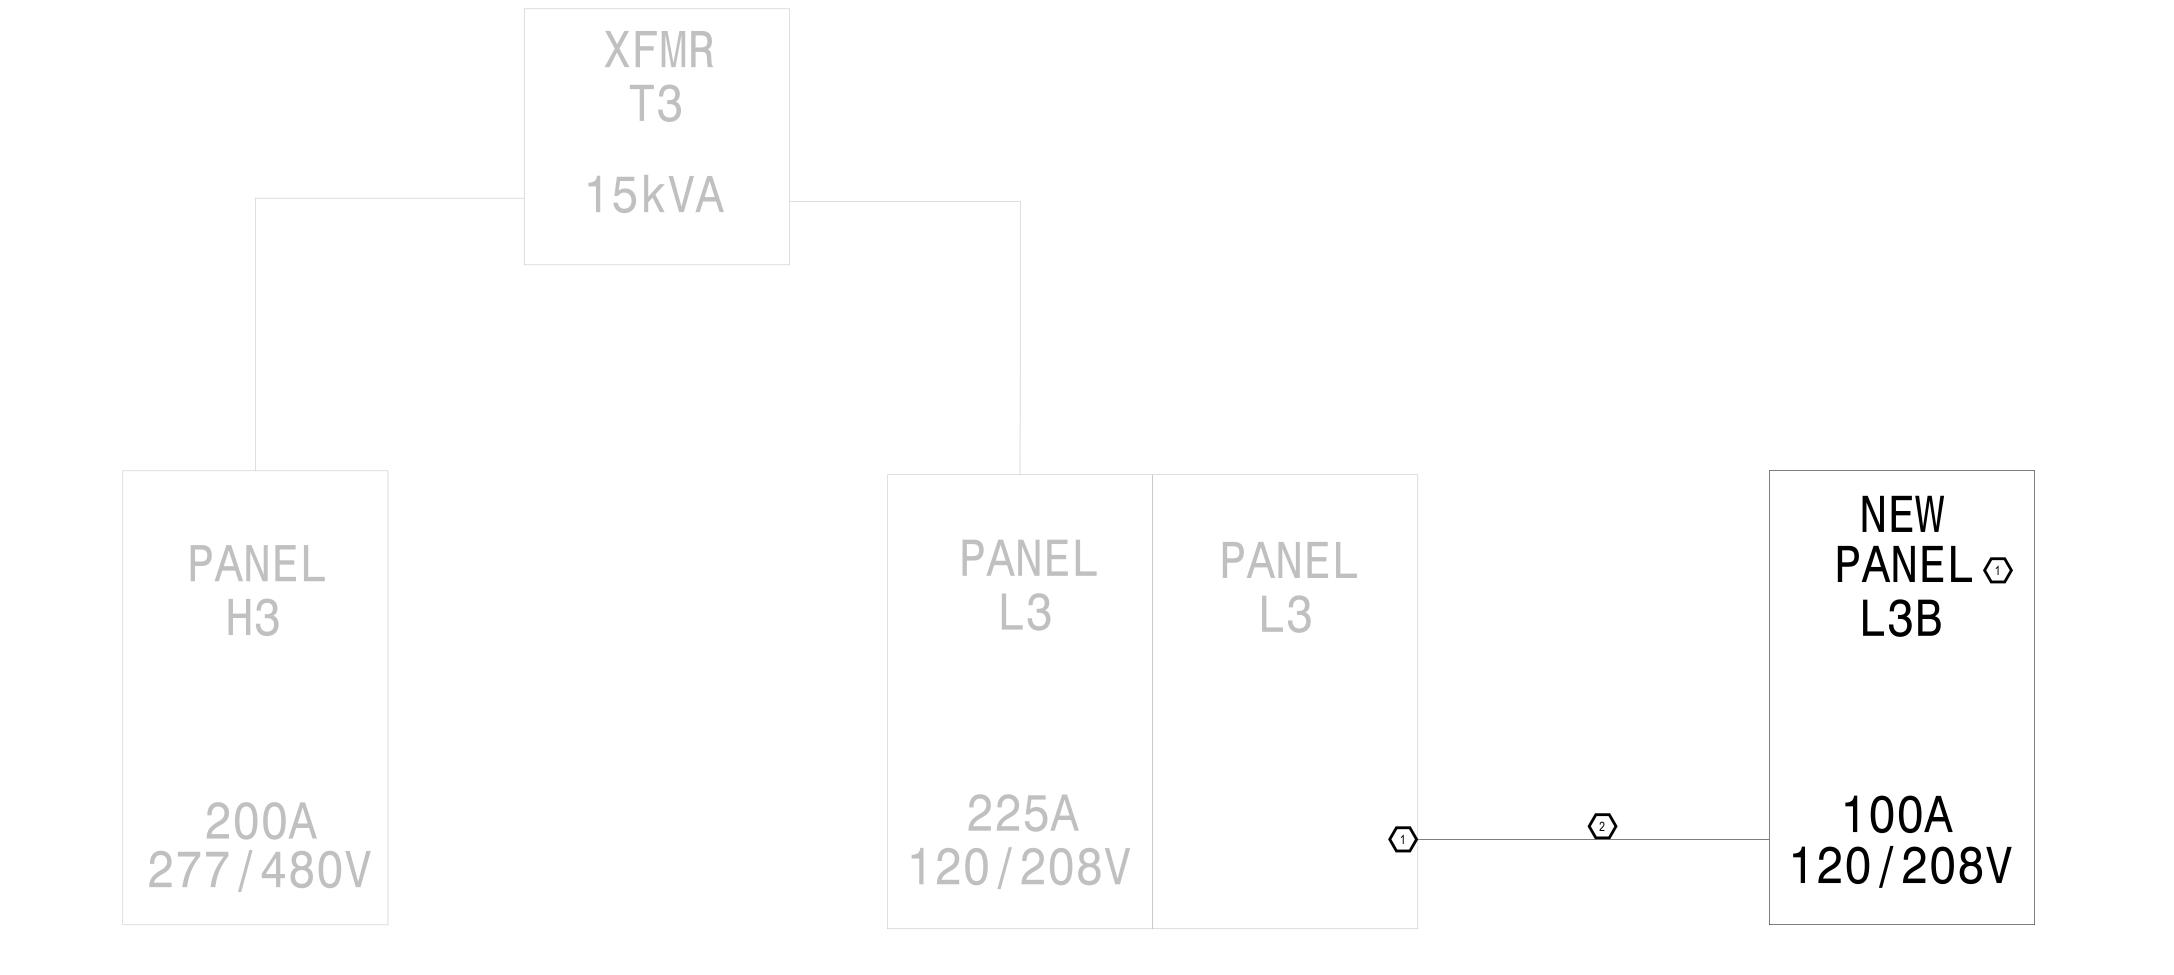


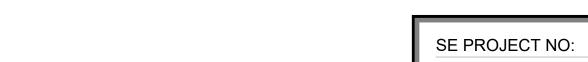

ELECTRICAL NOTES

 RELOCATE 3 - 20A SINGLE POLE CIRCUITS INTO NEW PANEL L3B. INSTALL NEW 100A 3P SIEMENS BQ3B100 BREAKER INTO PANEL L3.

2. INSTALL 1-1/4" EMT CONDUIT WITH 4 - #3 THHN WITH 1 - #8 THHN GND.

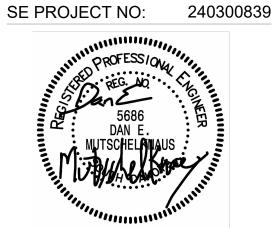

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PROJECT:

NSU - BARNETT CENTER -LOCKER ROOM UPGRADES OSE # RO124--16X NORTHERN STATE UNIVERSITY ABERDEEN, SOUTH DAKOTA

SHEET TITLE:

ELECTRICAL RISER DIAGRAM & PANEL SCHEDULE