
NORTHERN ELECTRIC

NORTHERN ELECTRIC COOPERATIVE BATH, SOUTH DAKOTA



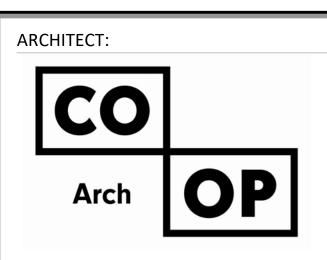

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ASSOCIATES
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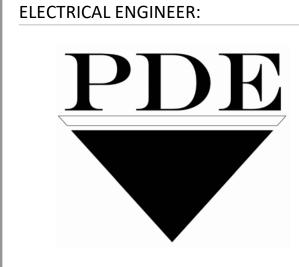
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Rise Structural Associates, Inc. 6909 S Lyncrest Place, Suite 110 Sioux Falls, SD 57108 Phone: 605-743-2510 1405 Prairie Pkwy, Suite B West Fargo, ND 58078 Phone: 701-318-1782 www.riseincorp.com

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ENGINEERING

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Professional Design Engineers 48731 265th Street Brandon, SD 57005 Phone: 605-941-3337

ORIENTATION PLAN MOTOR SCHEDULE, LEGEND & ASSEMBLIES, CODE STANDARDS SHEET INDEX & SYMBOLS LEGEND EM101 ELECTRICAL & MECHANICAL SITE **DEMOLITION PLAN** CIVIL **ELECTRICAL & MECHANICAL SITE** C100 TOPOGRAPHIC SURVEY **ELECTRICAL & MECHANICAL** SITE DEMOLITION PLAN SITE GRADING & SURFACING SITE UTILITIES **MECHANICAI** PAVEMENT MARKING & SWPPF **DEMOLITION PLAN - NORTH** C105 PLUMBING & HYDRONICS **DEMOLITION PLAN - SOUTH DEMOLITION** HVAC DEMOLITION PLAN **HVAC DEMOLITION PLAN** ARCHITECTURAL BELOW GRADE PLUMBING FIRST FLOOR PLAN **HYDRONICS PLAN - NORTH ROOF PLAN** BELOW GRADE PLUMBING & REFLECTED CEILING PLANS **HYDRONICS PLAN - SOUTH** M401.N ABOVE GRADE PLUMBING & FINISH SCHEDULE & LEGENDS **HYDRONICS PLAN - NORTH** FF&E PLANS **HYDRONICS PLAN - SOUTH EXTERIOR ELEVATIONS** HVAC PLAN - NORTH **BUILDING SECTIONS BUILDING SECTIONS** HVAC PLAN - SOUTH **HVAC TEMPERATURE CONTROL** WALL SECTIONS **ZONE PLAN** PLUMBING FIXTURE SCHEDULE MECHANICAL DETAILS - 1 OF 4 WALL SECTIONS MECHANICAL DETAILS - 2 OF 4 **ENLARGED PLANS & ELEVATIONS** MECHANICAL DETAILS - 3 OF 4 **ENLARGED PLANS & ELEVATIONS** MECHANICAL DETAILS - 4 OF 4 **ENLARGED PLANS & ELEVATIONS MECHANICAL SECTIONS - 1 OF 3 EXTERIOR DETAILS MECHANICAL SECTIONS - 2 OF 3 MECHANICAL SECTIONS - 3 OF 3 ROOF DETAILS MECHANICAL SCHEDULES** INTERIOR DETAILS MECHANICAL SCHEDULES DOOR SCHEDULE, DOOR & CONTINUED DOOR & WINDOW DETAILS ELECTRICAL DOOR & WINDOW DETAILS ELECTRICAL DEMOLITION PLAN STRUCTURAL ELECTRICAL DEMOLITION PLAN STRUCTURAL NOTES STRUCTURAL NOTES & POWER & DATA PLAN - NORTH SCHEDULES **POWER & DATA PLAN - SOUTH** WIND UPLIFT PLAN LIGHTING PLAN - NORTH S101 FOOTING & FOUNDATION PLAN LIGHTING PLAN - SOUTH FLOOR FRAMING PLAN SPECIAL SYSTEMS PLAN - NORTH S301 ROOF FRAMING PLAN SPECIAL SYSTEMS PLAN - SOUTH S401 FRAMING ELEVATIONS ELECTRICAL DETAILS FRAMING ELEVATIONS **ELECTRICAL SCHEDULES** STRUCTURAL DETAILS STRUCTURAL DETAILS STRUCTURAL DETAILS

MECHANICAL/ELECTRICAL

DRAWING SHEET INDEX:

GENERAL NOTES, CODE &

STRUCTURAL DETAILS

100% CONSTRUCTION
DOCUMENTS
5/15/2025

ARCHITECTURAL GENERAL NOTES

GENERAL NOTES

- FIRE RATED WALLS ARE INDICATED ON THE CODE PLANS. PROVIDE FIRE EXTINGUISHERS AND CABINETS AS SHOWN ON THE CODE PLAN(S). • SEE CIVIL, STRUCTURAL, MECHANICAL, AND ELECTRICAL FOR ADDITIONAL INFORMATION AND COORDINATION.
- REFER TO SHEET <u>A0-1</u> FOR ALL ADA CODE STANDARDS. SQUARE FOOTAGES LISTED ARE FOR CODE REVIEW PURPOSES ONLY AND SHOULD NOT BE
- USED FOR ANY OTHER PURPOSES. COORDINATE WORK DONE BY OTHERS AS INDICATED ON THE DRAWINGS.
- CONTRACTOR TO VERIFY ALL EXISTING CONDITIONS, ELEVATIONS AND DIMENSIONS. ALL WORK SHALL BE IN ACCORDANCE WITH OSHA CODES AND STANDARDS. NOTHING INDICATED ON THESE DRAWINGS SHALL RELIEVE THE CONTRACTOR FROM COMPLYING WITH
- ANY APPROPORIATE SAFETY REGULATIONS. • THE CONTRACTOR SHALL CONSTRUCT ALL ITEMS WITHIN THIS CONTRACT IN ACCORDANCE WITH THE STATE AND LOCAL REGULATIONS AND CODES.
- COMPARE AND MATCH EXISTING CONDITIONS. ALL FLOOR ELEVATIONS, ROOF SLOPES, PRECAST SHAPES AND ELEVATIONS, BANDINGS AND MILLWORK TO MATCH THAT OF THE
- EXISTING BUILDING. REVIEW ALL INTERIOR ELEVATION SHEETS FOR ACCESSORY AND EQUIPMENT INFORMATION.
- COORDINATE WITH CODE STANDARD SHEET A0-2. COORDINATE ANY EXTERIOR REQUIRED WORK WITH MECH. & ELECTRICAL. VERIFY HOISTWAY SHAFT SIZE REQUIREMENTS W/ ELEVATOR MANUFACTURER &

COORDINATE ALL SHEAR WALL LOCATIONS W/ STRUCTURAL PLANS.

COORDINATE. • COORDINATE ALL CHASE SIZES AND LOCATIONS W/ MECHANICAL. PROVIDE CHASES AT ALL EXPOSED MACHANICAL & ELECTRICAL WITH ADJACENT WALL MATERIAL AS REQUIRED.

DEMOLITION NOTES

- SEE MECHANICAL, AND ELECTRICAL DRAWINGS FOR ADDITIONAL INFORMATION RELEVANT TO DEMOLITION & PATCHING.
- PATCH REMAINING EXISTING CONSTRUCTION, AFFECTED BY DEMOLITION, TO MATCH EXISTING U.O.N. COORDINATE WITH OWNER ANY DEMO ITEMS TO BE SALVAGED FOR THE OWNERS REUSE.
- **CASEWORK NOTES** SEE FLOOR PLAN FOR CASE WORK PLAN INFORMATION. SEE INTERIOR ELEVATIONS FOR
- PROVIDE COUNTERTOP SUPPORTS AT ALL OPEN SPACES AT MIN. OF 32" O.C. AND MAX. OF 48" O.C. COORDINATE DEVICE PENETRATIONS AT COUNTERTOPS W/ MECHANICAL & ELECTRICAL.

ADDITIONAL CASEWORK INFORMATION. FIELD VERIFY ALL CASEWORK OPENINGS.

- TALL CABINETS OVER 30" WIDE SHALL HAVE VERTICAL DIVIDER FULL HEIGHT. MILLWORK SUPPLIER SHALL PROVIDE FILLER PANELS & SCRIBE STRIPS AS NEEDED FOR COMPLETE INSTALLATION.
- PROVIDE FINISHED END PANELS AT ALL EXPOSED MILLWORK SURFACES. PROVIDE ONE GROMENT FOR EVERY 8' OF COUNTERTOP WITHOUT CASEWORK BELOW. COORDINATE INSTALLATION LOCATION WITH OWNER

CEILING NOTES

- ALL ITEMS INSTALLED IN CEILINGS, INCLUDING SPRINKLER HEADS, ARE TO BE CENTERED OR SYMMETRICALLY ARRANGED ON OR ABOUT CENTERLINES OF ROOMS AND CENTERED IN CEILING TILES
- WALL MOUNTED EXIT SIGNS AND FIXTURES ARE TO BE CENTERED OVER DOOR OR DOOR
- OPENING WHERE APPLICABLE. • REFER TO SPECIFICATIONS FOR CEILING AND FIXTURE SUSPENSION REQUIREMENTS. • PROVIDE ACCESS DOORS AT ALL MECHANICAL UNIT LOCATIONS ABOVE SOFFIT. COORD.
- NUMBER REQUIRED AND LOCATIONS WITH MECHANICAL SHEETS. • CENTER CEILING GRID IN AREAS SUCH THAT THERE WILL BE NO CEILING TILE LESS THAN 6" IN THE SMALLEST DIMENSION, U.N.O.
- THE REFLECTED CEILING PLANS ARE INTENDED TO AID IN COORDINATION ONLY AND ARE NOT INTENDED TO BE COMPREHENSIVE. SEE MECHANICAL AND ELECTRICAL DRAWINGS FOR ADDITIONAL INFORMATION, WHERE CONFLICTS OCCUR, NOTIFY ARCHITECT.
- COORDINATE WITH MEP FOR LOCATION OF CEILING ACCESS PANELS. • CENTER LIGHT FIXTURES BETWEEN WALLS AND/OR CEILING BULKHEADS UNLESS DIMENSIONED OTHERWISE.
- ALIGN GYPSUM BOARD CEILINGS AND SOFFITS WITH ADJACENT PARTITIONS, U.N.O. • IN ALL EXPOSED TO STRUCTURE ROOMS, CENTER LIGHT FIXTURE WITHIN ROOM

DOORS, HARDWARE & WINDOWS NOTES

- ALL HM FRAMES IN STUD PARTITIONS SHALL BE WRAPPED AROUND BOTH SIDES OF PARTITION (U.O.N.) SEE PLAN FOR WALL THICKNESS.
- ALL EXTERIOR FRAMES & DOORS ARE TO BE THERMALLY BROKEN.

• CAULK ENTIRE PERIMETER OF H.M. FRAMES (BOTH SIDES).

- PAINT FRAMES TO MATCH WALL. SPLIT PAINT COLOR AT DOOR GASKET AS REQUIRED. • PROVIDE ROOM SIGNAGE AT ALL DOORS. WHERE MOUNTED TO GLAZING, PROVIDE A BLANK BACK PLATE ON OPPOSIZE SIDE OF GLAZING. SEE CODE STANDARDS FOR MOUNTING HEIGHTS
- AND LOCATIONS. SEE SPECIFICATIONS FOR SPECIAL SIGNAGE REQ. REFER TO WALL TYPES FOR WALL CONSTRUCTION ELEMENTS FOR ALL DOOR AND WINDOW
- DETAILS. COORDINATE ALL STRUCTURAL REQ. WITH STRUCTURAL DRAWINGS. WALL MOUNTED EXIT SIGNS AND FIXTURES ARE TO BE CENTERED OVER DOOR OR DOOR

FINISHES NOTES

OPENING WHERE APPLICABLE.

- SEE DRAWING SHEET <u>A1-3</u> FOR ROOM FINISH SCHEDULE.
- INTERIOR WALL FINISHES ARE FULL HEIGHT, U.N.O.
- PREP ALL EXISTING WALLS AS REQUIRED FOR PROPER ADHESION OF NEW WALL TILE. PREP ALL EXISTING WALLS AS REQUIRED FOR NEW PAINTING.

FIXTURES NOTES

- COORDINATE INSTALLATION OF OWNER PROVIDED EQUIPMENT WITH NEW CONSTRUCTION. • CAULK PERIMETER OF ALL TUB/SHOWER UNITS, TOILETS, URINALS, SINKS & COUNTERTOPS AS
- REVIEW ALL INTERIOR ELEVATION SHEETS FOR ACCESSORY AND EQUIPMENT INFORMATION. • PROVIDE 2x BLOCKING AT ALL GRAB BAR AND FUTURE GRAB BAR LOCATIONS. SEE CODE SHEETS FOR ADDITIONAL BLOCKING INFORMATION.

FLOOR NOTES

• SEE MECHANICAL FOR ALL FLOOR DRAIN SIZES AND LOCATIONS U.N.O. SET FLOOR DRAINS MINIMUM 3/4" BELOW FINISHED FLOOR. PROVIDE EVEN SLOPE FROM WALL TO DRAIN W/ A MAXIMUM SLOPE OF 1/4" PER FOOT.

ROOF NOTES


- SEE CIVIL, STRUCTURAL, MECHANICAL, AND ELECTRICAL FOR ADDITIONAL INFORMATION AND COORDINATION.
- ALL ROOF TAPERED ROOF SYSTEM SLOPES ARE ¼" PER FOOT U.O.N. • ALL THRU ROOF PENETRATION BOOTS IN ROOF SYSTEM ARE TO BE PROVIDED.
- THE AIR & MOISTURE WEATHER BARRIER IS TO BE CONTINUOUS FROM THE BASE OF THE WALLS UP TO & TYING INTO THE ROOF BARRIER SYSTEM. COORDINATE ROOF PENETRATIONS WITH MECHANICAL, ELECTRICAL, AND PLUBMING
- CONTRACTORS. • ALL ROOF SADDLES SHALL HAVE A MINIMUM OF 1/2" PER FOOT SLOPE.
- PROVIDE ROOF CURBS FOR ALL EQUIPMENT SCHEDULED TO BE ON THE ROOF. COORDINATE SIZE AND LOCATION WITH APPLICABLE TRADES.
- PROVIDE CRICKETS AT ALL ROOF TOP EQUIPEMENT TO ALLOW FOR UNIMPEDED WATER
- DIMENSIONS AND LOCATIONS OF EQUIPMENT ON THE ROOF ARE APPROX., DO NOT SCALE THE DRAWINGS. VERIFY WITH APPLICABLE TRADES. • TAPERED INSULATION SHALL HAVE A MINIMUM OF 1/4" PER FOOT SLOPE. PROVIDE TAPERED
- INSULATION AS REQUIRED TO ACHIEVE 1/4" PER FOOT SLOPE. • PROVIDE R-30 MINIMUM ROOF INSULATION AT ROOF DRAINS.
- PROVIDE ROOF WALKING PADS AS SHOWN.


SITE NOTES


• SEE SITE PLAN FOR ADDITIONAL INFORMATION REGARDING CONSTRUCTION LIMITS, STAGING, LAWN IRRIGATION, SOD & LANDSCAPING.


WALL NOTES

- ALL WALLS TO BE TYPE #1 U.O.N. AND EXTEND TO DECK UNLESS OTHERWISE NOTED ON
- ALL DIMENSIONS ARE FROM FACE GWB TO FACE OF GWB U.N.O. • COORDINATE ALL CHASE SIZES AND LOCATIONS W/ MECHANICAL. PROVIDE CHASES AT ALL
- EXPOSED MACHANICAL & ELECTRICAL WITH ADJACENT WALL MATERIAL AS REQUIRED. INCREASE WALL THICKNESS OF METAL STUD AND CONCRETE BLOCK WALLS
 AS REQUIRED TO
- ACCOMMODATE MECHANICAL AND ELECTRICAL DEVICES- VERIFY WITH ARCHITECT PRIOR TO WORK.
- PROVIDE WATER-RESISTANT GYPSUM BOARD PANELS AT ALL BATHROOM AND SHOWER ROOM WALLS AND CEILINGS WHERE EXPOSED TO MOISTURE. RESTROOM WALLS ARE SOUND INSULATED AND EXTEND TO THE DECK.
- VERIFY DRYWALL CONTROL JOINT LOCATIONS w/ARCHITECT ON SITE PRIOR TO INSTALLATION. THIS INCLUDES, BUT IS NOT LIMITED TO, CONTROL JOINTS AT 30'-0" O.C. MAX. IN LONG WALL EXPANSES. CONTROL JOINTS AT DOOR JAMBS EXTENDING FROM DOOR HEAD TO CEILING. CONSIDERATION SHALL ALSO BE GIVEN TO LOCATING CONTROL JOINTS FROM FLOOR TO CEILING AT EITHER EDGE OF LARGE WINDOW OPENINGS.
- THE AIR & MOISTURE WEATHER BARRIER IS TO BE CONTINUOUS FROM THE BASE OF THE

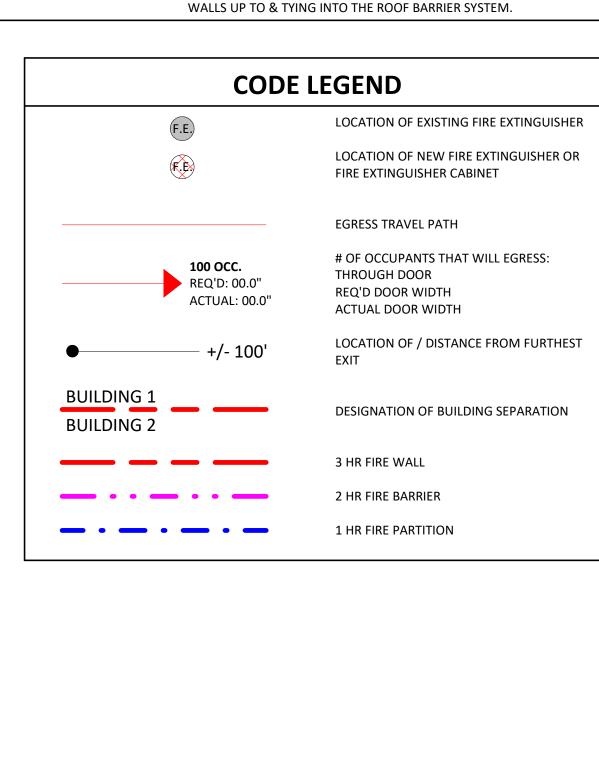

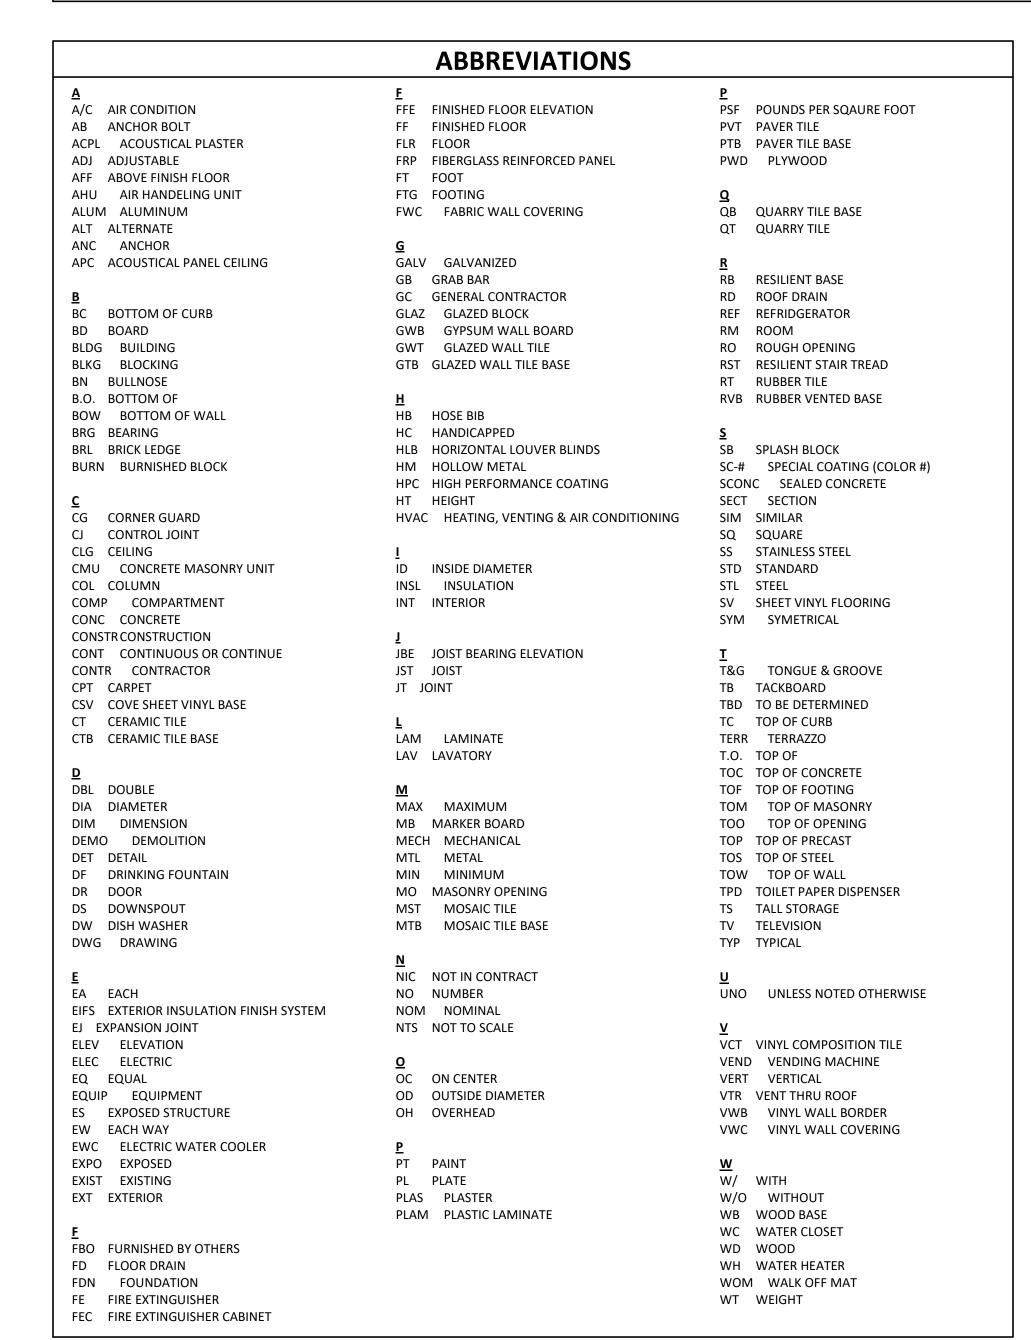

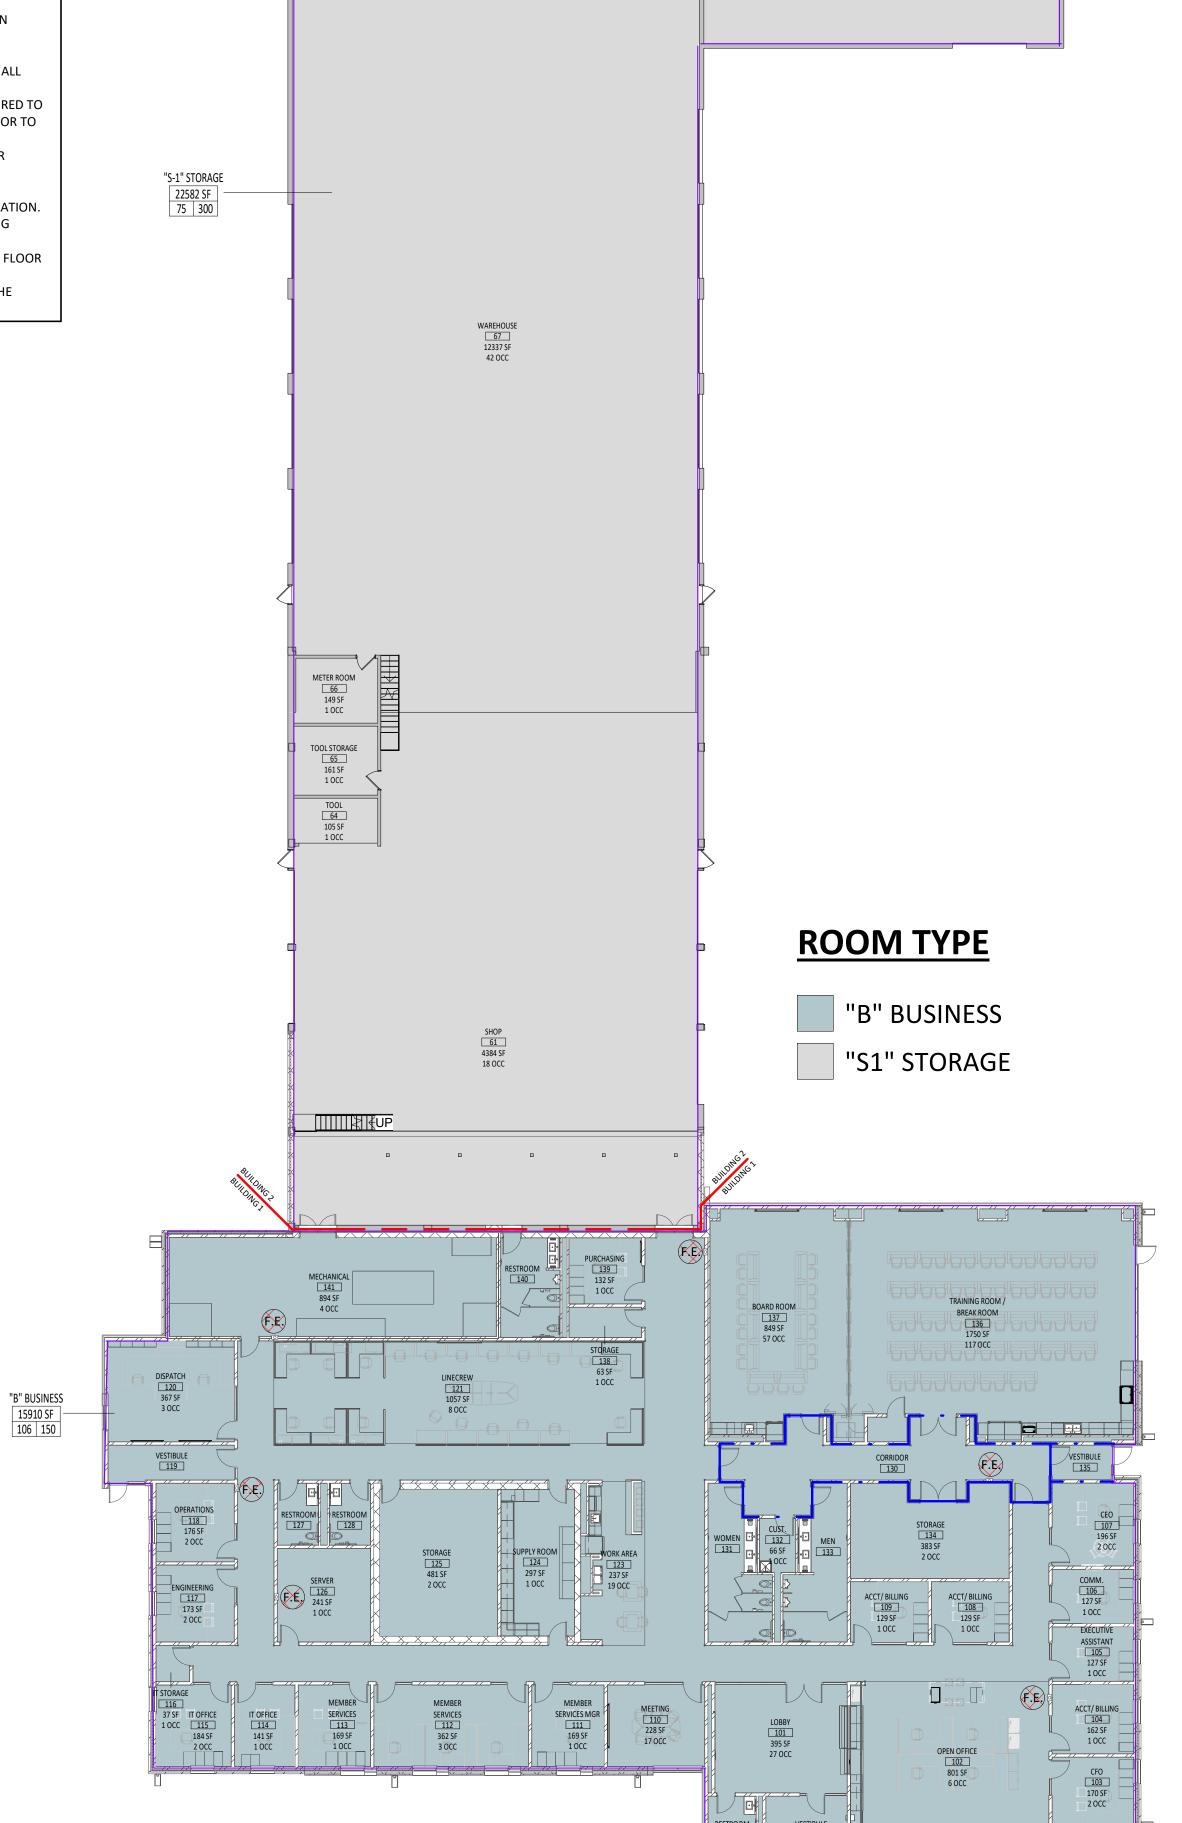

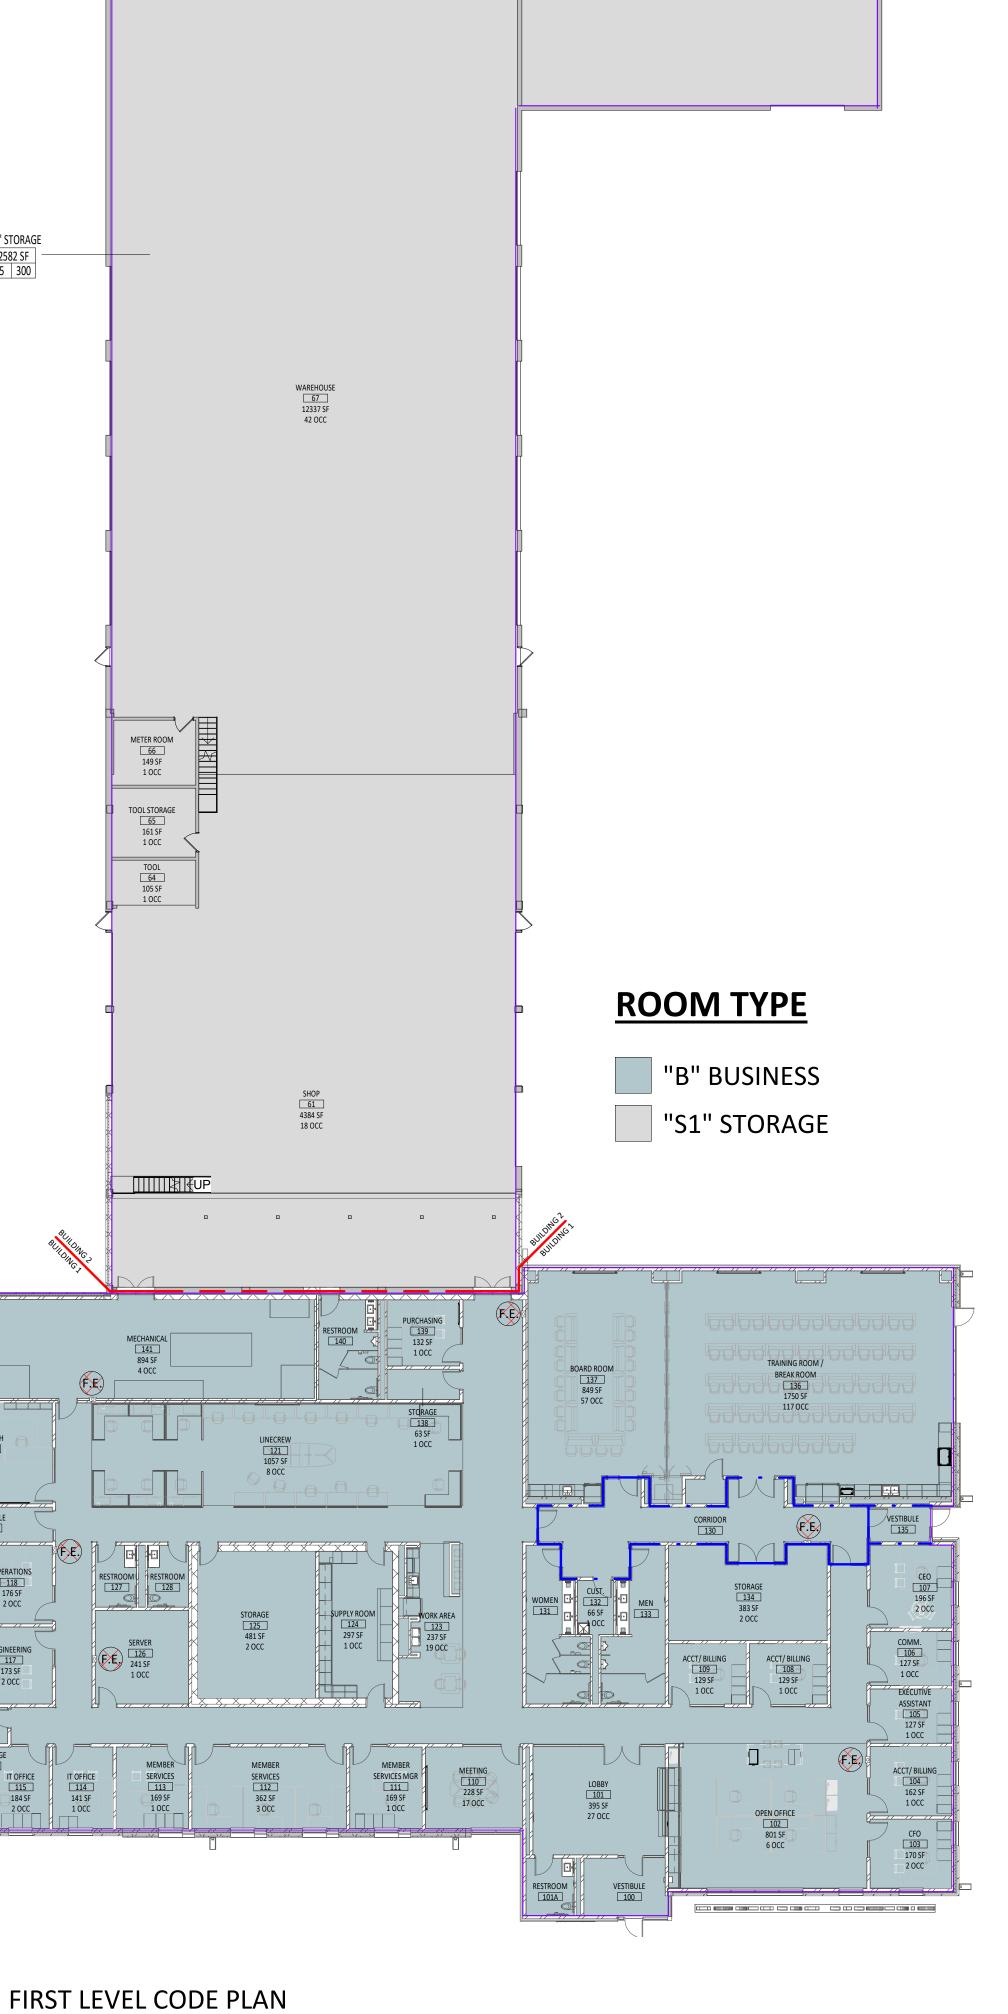



BUILDING CODE SUMMARY

APPLICABLE CODES L. BUILDING CODE: 2021 INTERNATIONAL BUILDING CODE

. MECHANICAL CODE: 2018 INTERNATIONAL MECHANICAL CODE . PLUMBING CODE: 2015 UNIFORM PLUMBING CODE 4. ELECTRICAL CODE: NATIONAL ELECTRICAL CODE **2014**

6. FIRE CODE: FIRE CODE **2015** OF SOUTH DAKOTA

5. ENERGY CONSERVATION CODE: **NOT REQUIRED, 2012 IECC AS BASIS** 7. STORM SHELTER DESIGN: 2014 ICC 500/NSSA (SEE IBC CHAPTER 4)

CODE SUMMARY BUILDING: NORTHERN ELECTRIC COOPERATIVE LOCATION: 39456 133RD ST, BATH, SD 57427

GENERAL: ONE STORY SLAB ON GRADE, OFFICE AND SHOP, NON-SPRINKLERED

USE AND OCCUPANCY CLASSIFICATION (CHAPTER 3) 1. OCCUPANCY CLASSIFICATION:

- GROUP B OFFICE GROUP S-1 SHOP
- . ACCESSORY OCCUPANCIES:
- ACCESSORY STORAGE SPACES CLASSIFIED AS PART OF OCCUPANCY (311.1.1) B. MIXED OCCUPANCY: NONE
- 1. OCCUPANCY SEPARATION: 3 HOUR (SECTION 508.4) • TWO SEPARATE BUILDINGS ARE DIVIDED BY A 3-HR FIRE WALL
- 5. HAZARDOUS AREAS: NONE 5. INCIDENTAL USE AREAS:
- A. MECHANICAL ROOM(S): AUTOMATIC FIRE-EXTINGUISHING SYSTEM
- B. ELECTRICAL ROOM(S): AUTOMATIC FIRE-EXTINGUISHING SYSTEM C. STORAGE ROOMS OVER 100 SF: AUTOMATIC FIRE-EXTINGUISHING SYSTEM D. OTHER

BUILDING LOCATION

1. REFERENCE SITE & CODE PLAN • BUILDING 1: N: EXCEEDS 30' CLEAR E: EXCEEDS 30' CLEAR S: EXCEEDS 30' CLEAR

GENERAL BUILDING HEIGHTS & AREAS (CHAPTER 5) B OCCUPANCY NON-SPRINKLERED TYPE IIB CONSTRUCTION S-1 OCCUPANCY NON-SPRINKLERED TYPE IIB CONSTRUCTION

W: EXCEEDS 30' CLEAR

B OCCUPANCY (BUILDING 1) MAX PERMITTED PROPOSED ALLOWABLE BUILDING HEIGHT 55'-0" 28'-0" (APPROX). # OF STORES ABOVE GRADE PLAN 3 STORIES 1 STORY

ALLOWABLE AREA 15,750 SF 23,000 SF INCREASE NOT REQUIRED. THE ACTUAL AREA AND HEIGHT ARE LESS THAN THE ALLOWABLE AREA AND HEIGHT. S-1 OCCUPANCY (BUILDING 2) MAX PERMITTED PROPOSED

ALLOWABLE BUILDING HEIGHT 55'-0" 18'-8" (APPROX). # OF STORES ABOVE GRADE PLAN 2 STORIES 1 STORY 22,600 SF ALLOWABLE AREA 17,500 SF INCREASE NOT REQUIRED. THE ACTUAL AREA AND HEIGHT ARE LESS THAN THE ALLOWABLE AREA AND HEIGHT.

ADDRESS IDENTIFICATION (SECTION 502.1) PROVIDE ADDRESS IDENTIFICATION NUMBERS ON BUILDING VISIBLE FROM STREET.

ROOF CONSTRUCTION & SECONDARY MEMBERS

FLOOR CONSTRUCTION & SECONDARY MEMBERS

TYPES OF CONSTRUCTION (CHAPTER 6) TYPE IIB CONSTRUCTION

FIRE RESISTIVE RATING REQUIREMENTS FOR BUILDING ELEMENTS (TABLE 601):

BUILDING 1 (B) ELEMENT OF CONSTRUCTION FIRE RESISTANCE RATING (HRS) PRIMARY STRUCTURAL FRAME 0 HRS BEARING WALLS (INTERIOR & EXTERIOR) 0 HRS NONBEARING WALLS AND PARTITIONS 0 HRS FLOOR CONSTRUCTION & SECONDARY MEMBERS 0 HRS

FIRE RESISTANCE RATING (HRS) BUILDING 2 (S-1) ELEMENT OF CONSTRUCTION PRIMARY STRUCTURAL FRAME BEARING WALLS (INTERIOR & EXTERIOR) 0 HRS NONBEARING WALLS AND PARTITIONS 0 HRS

ROOF CONSTRUCTION & SECONDARY MEMBERS 0 HRS CONSTRUCTION CLASSIFICATION (SECTION 602) TYPE II CONSTRUCTION IS THAT TYPE OF CONSTRUCTION IN WHICH THE BUILDING ELEMENTS,

SPECIFIED IN TABLE 601 ARE NONCOMBUSTIBLE MATERIALS, EXCEPT AS PERMITTED IN SECTION

0 HRS

603 AND ELSEWHERE IN THIS CODE (SECTION 602.2). FIRE AND SMOKE PROTECTION FEATURES (CHAPTER 7)

STRUCTURAL MEMBERS (SECT 704): 0 HR (PER TABLE 601) **EXTERIOR WALLS (SECTION 705):** PROJECTIONS (SECTION 705.2):

PROJECTIONS PERMITTED NO FIRE RESISTANCE RATING REQ'D. (SECTION 705.5) FIRE-RESISTANCE RATING:

FIRE WALLS (SECTION 706): HORIZONTAL CONTINUITY: CONTINOUS FROM EXTERIOR WALL TO EXTERIOR WALL FIRE BARRIERS (SECTION 707): FIRE PARTITION (SECTION 708): AREA OF SEPARATION (SECTION 708.1) SMOKE BARRIER (SECTION 709): AREA OF SEPARATION

SMOKE PARTITION (SECTION 710): AREA OF SEPARATION VERTICAL OPENINGS (SECTION 712): TYPES OF OPENINGS SHAFT ENCLOSURES (SECTION 713): TYPES OF ENCLOSURES OPENING PROTECTIVES (SECTION 716) - TO COMPLY WITH TABLES 716.3 & 716.5

MEANS OF EGRESS (CHAPTER 10)

- 1. MAXIMUM FLOOR AREA ALLOWANCES PER OCCUPANT (TABLE 1004.1.2) A. ASSEMBLY (UNCONCENTRATED TABLES/CHAIRS): 15 SF/OCCUPANT NET B. BUSINESS: 150 SF/OCCUPANT GROSS
- C. STORAGE/MECHANICAL EQUIPMENT ROOM: 300 SF/OCCUPANT GROSS 2. OCCUPANT LOADS (CALCULATED FOR EXITING) A. TOTAL BUILDING OCCUPANT LOAD B (OFFICE): 15,750 SF/150 = 105
- B. TOTAL BUILDING OCCUPANT LOAD S-1 (SHOP): 22,600 SF/300 = 75 3. EGRESS WIDTH PER OCCUPANT SERVED (SECTION 1005.1) A. STAIRWELLS: 0.3 INCHES/OCCUPANT
- B. OTHER EGRESS COMPONENTS: 0.2 INCHES/OCCUPANT C. EXIT STAIRWAYS - MINIMUM CLEAR WIDTH: 44" MIN. D. CORRIDORS - MINIMUM WIDTH (TABLE 1020.1): 44" MIN. (AISLES: 44" MIN.) • 1 HR FIRE RESISTANCE RATING REQ'D WHERE OCC LOAD SERVED BY CORRIDOR IS > 30
- E. DOOR ENCROACHMENT: DOOR SWING DOES NOT REDUCT REQUIRED WIDTH BY MORE THAN 1/2 FULLY OPEN DOES NOT PROJECT MORE THAN 7"
- EXIT REQUIREMENTS A. COMMON PATH OF EGRESS TRAVEL DISTANCE (TABLE 1006.2):
- OL IS LESS THAN OR EQUAL TO 30 = 100 FT MAX. OL IS MORE THAN 30 = 75 FT MAX.

WIDE WITH 5FT ACCESS AISLE.

- EGRESS BASED ON OL AND COMMON PATH OF EGRESS TRAVEL. TWO EXITS OR EXIT ACCESS DOORWAYS FROM ANY SPACE SHALL BE PROVIDED WHERE THE OL OR COMMON PATH OF EGRESS TRAVEL EXCEEDS VALUES LISTED ON 1006.2.1. B. MAXIMUM TRAVEL DISTANCE (TABLE 1017.2):
- B OCCUPANCY: 200 FT WITHOUT SPRINKLER SYSTEM • S-1 OCCUPANCY: 200 FT WITHOUT SPRINKLER SYSTEM C. MAXIMUM DEAD-END CORRIDOR LENGTH (SECTION 1020.5): 20 FT . MINIMUM NUMBER OF EXITS PER STORY (TABLE 1006.3.2):
- MINIMUM OF 2 EXITS FOR OCCUPANCY LOAD PER STORY OF 1-500 OCC. . ACCESIBLE MEANS OF EGRESS A. EXAMPLE - AN ELEVATOR PROVIDES THE ACCESSIBLE MEANS OF EGRESS TO FLOORS ABOVE THE LEVEL OF DISCHARGE. THE ELEVATOR WILL COMPLY WITH SECTION 1009.4. B. EXAMPLE - AREA OF REFUGE IS NOT REQ'D IN BUILDINGS AND FACILITIES EQUIPPED THROUGHOUT WITH AN AUTOMATIC SPRINKLER SYSTEM INSTALLED IN ACCORDANCE

ACCESSIBILITY (CHAPTER 11) L. ACCESSIBLE ELEMENTS HAVE BEEN INCORPORATED INTO THE DOCUMENTS

WITH SECTION 903.3.1.1 OR 903.1.2 (SECTION 1009.3.3; EXCEPTION 2)

. ACCESSIBLE PARKING SPACES (TABLE 1106.2): 1 OF EVERY 6 SHALL BE ACCESSIBLE AND SHALL BE VAN ACCESSIBLE. PROVIDE STRIPING AND SIGNAGE. VAN ACCESSIBLE SIGN SHALL BE MOUNTED MINIMUM 60" ABOVE PARKING SURFACE. A. VAN ACCESSIBLE PARKING SPACE CAN BE EITHER 8FT WIDE WITH 8FT ACCESS AISLE OR 11FT

PLUMBING CALCULATIONS (CHAPTER 29) RESTROOMS MUST MEET ACCESSIBILITY REQ'S PER ICC ANSI 117.1 AND IBC 1110.2 MIN. NUMBER OF REQ'D PLUMBING FIXTURES (TABLE 2902.1): WATER CLOSETS LAVATORIES DF SERVICE SINK

TOTAL OCCUPANTS PER OCCUPANCY (CALCULATED FOR REQ'D PLUMBING FIXTURES): B OCCUPANCY: 269

B REQ'D: 4 4 3 3 TOTAL REQ'D: 4 4 3 3 PROVIDED: 6 6 4 5 *DUAL (2) ACCESS DRINKING FOUNTAIN W/ INTEGRATED BOTTLE FILLER (1) PROVIDED. GENERAL OFFICE DAY USE: 95 OCCUPANTS/100 = 1 DF REQ'D

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CO-OP PROJECT NO:



5/15/2025 100% CONSTRUCTION DOCUMENTS

REVISION SCHEDULE:


REV. # REV. DSC.

PROJECT: NORTHERN ELECTRIC NORTHERN ELECTRIC COOPERATIVE BATH, SOUTH DAKOTA

SHEET TITLE:

ORIENTATION PLAN

GENERAL NOTES, CODE &

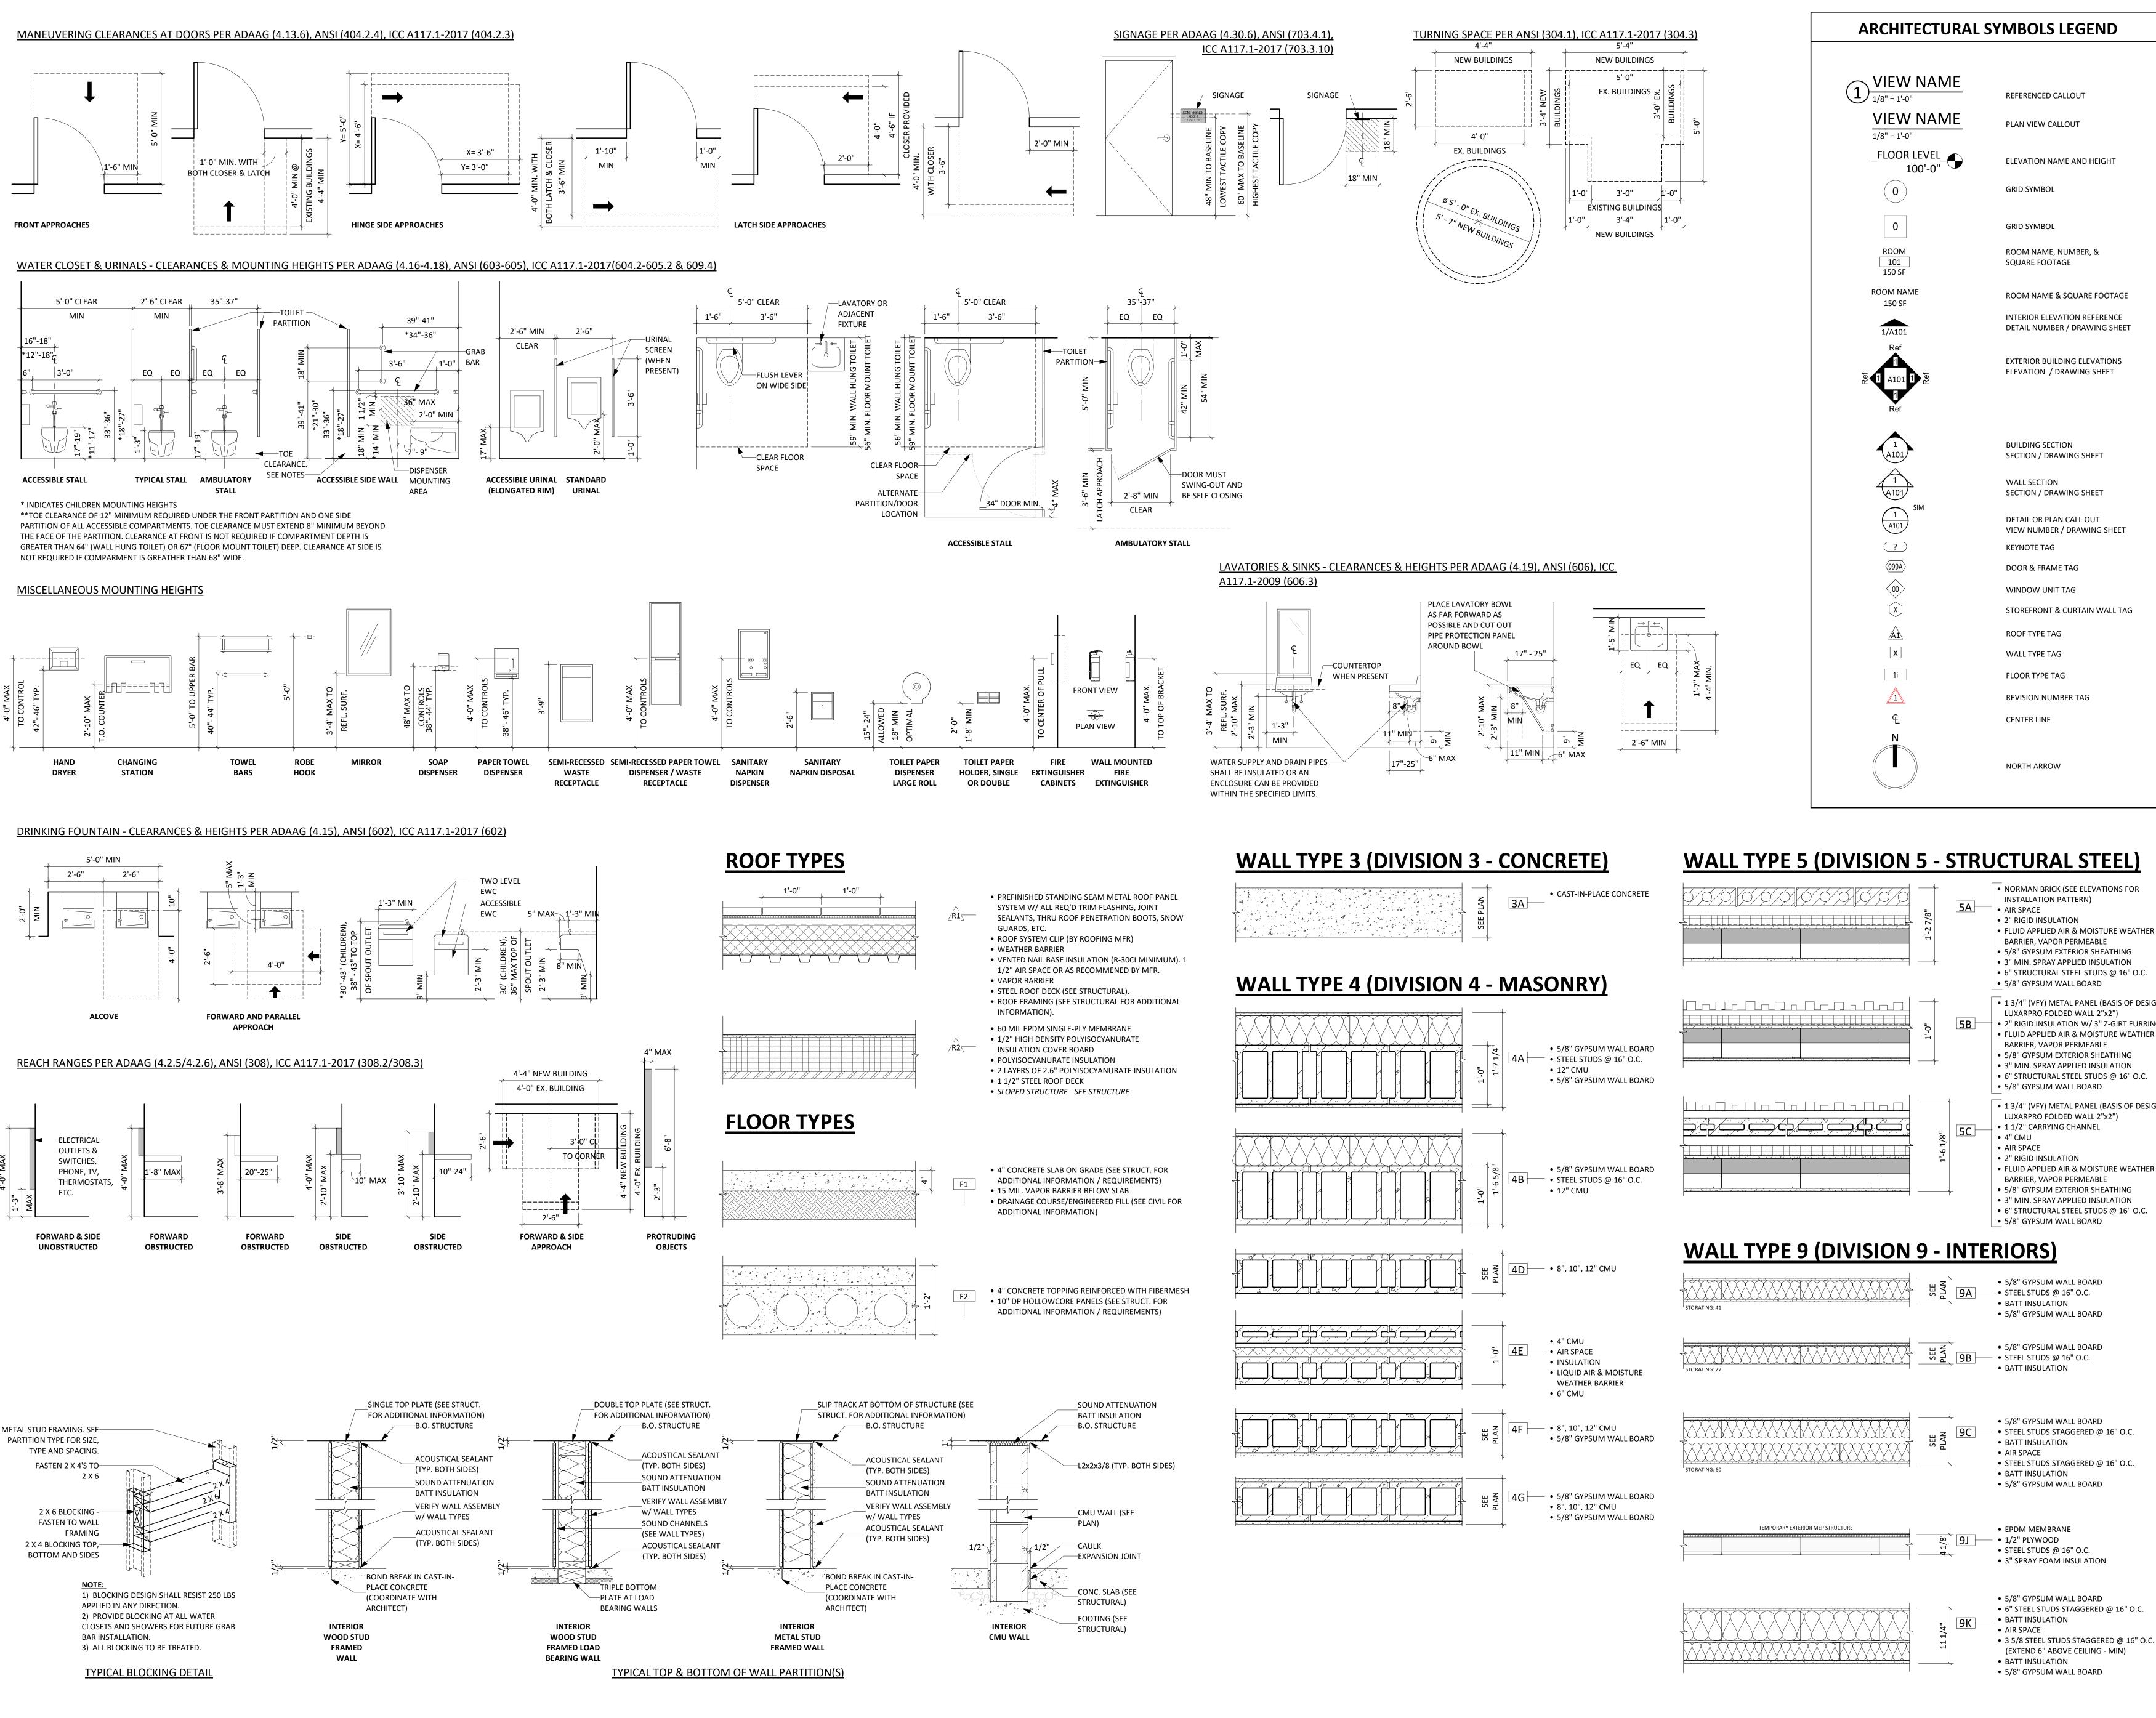


ARCHITECTURAL SYMBOLS LEGEND REFERENCED CALLOUT PLAN VIEW CALLOUT **ELEVATION NAME AND HEIGHT** ROOM NAME, NUMBER, & SQUARE FOOTAGE **ROOM NAME & SQUARE FOOTAGE** INTERIOR ELEVATION REFERENCE DETAIL NUMBER / DRAWING SHEET **EXTERIOR BUILDING ELEVATIONS** ELEVATION / DRAWING SHEET **BUILDING SECTION** SECTION / DRAWING SHEET SECTION / DRAWING SHEET DETAIL OR PLAN CALL OUT VIEW NUMBER / DRAWING SHEET DOOR & FRAME TAG WINDOW UNIT TAG STOREFRONT & CURTAIN WALL TAG **REVISION NUMBER TAG**

• 5/8" GYPSUM WALL BOARD • 1 3/4" (VFY) METAL PANEL (BASIS OF DESIGN: LUXARPRO FOLDED WALL 2"x2") • 2" RIGID INSULATION W/ 3" Z-GIRT FURRING • FLUID APPLIED AIR & MOISTURE WEATHER BARRIER, VAPOR PERMEABLE • 5/8" GYPSUM EXTERIOR SHEATHING

• 3" MIN. SPRAY APPLIED INSULATION • 6" STRUCTURAL STEEL STUDS @ 16" O.C. • 5/8" GYPSUM WALL BOARD • 1 3/4" (VFY) METAL PANEL (BASIS OF DESIGN: LUXARPRO FOLDED WALL 2"x2") • 1 1/2" CARRYING CHANNEL

• 2" RIGID INSULATION • FLUID APPLIED AIR & MOISTURE WEATHER

• 3" MIN. SPRAY APPLIED INSULATION • 6" STRUCTURAL STEEL STUDS @ 16" O.C. • 5/8" GYPSUM WALL BOARD

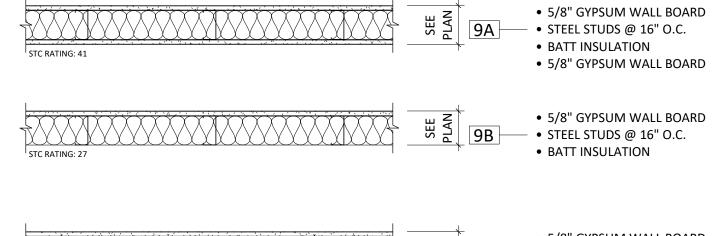

• 5/8" GYPSUM WALL BOARD STEEL STUDS STAGGERED @ 16" O.C. BATT INSULATION STEEL STUDS STAGGERED @ 16" O.C.

 BATT INSULATION • 5/8" GYPSUM WALL BOARD

• 5/8" GYPSUM WALL BOARD BATT INSULATION

• 6" STEEL STUDS STAGGERED @ 16" O.C. • 3 5/8 STEEL STUDS STAGGERED @ 16" O.C. (EXTEND 6" ABOVE CEILING - MIN)

600 Kansas City St. #1 Rapid City, SD 57701 Phone: 605-716-3652 440 E. 8th St. 221 Sioux Falls, SD 57103 Phone: 605-334-9999 co-oparch.com

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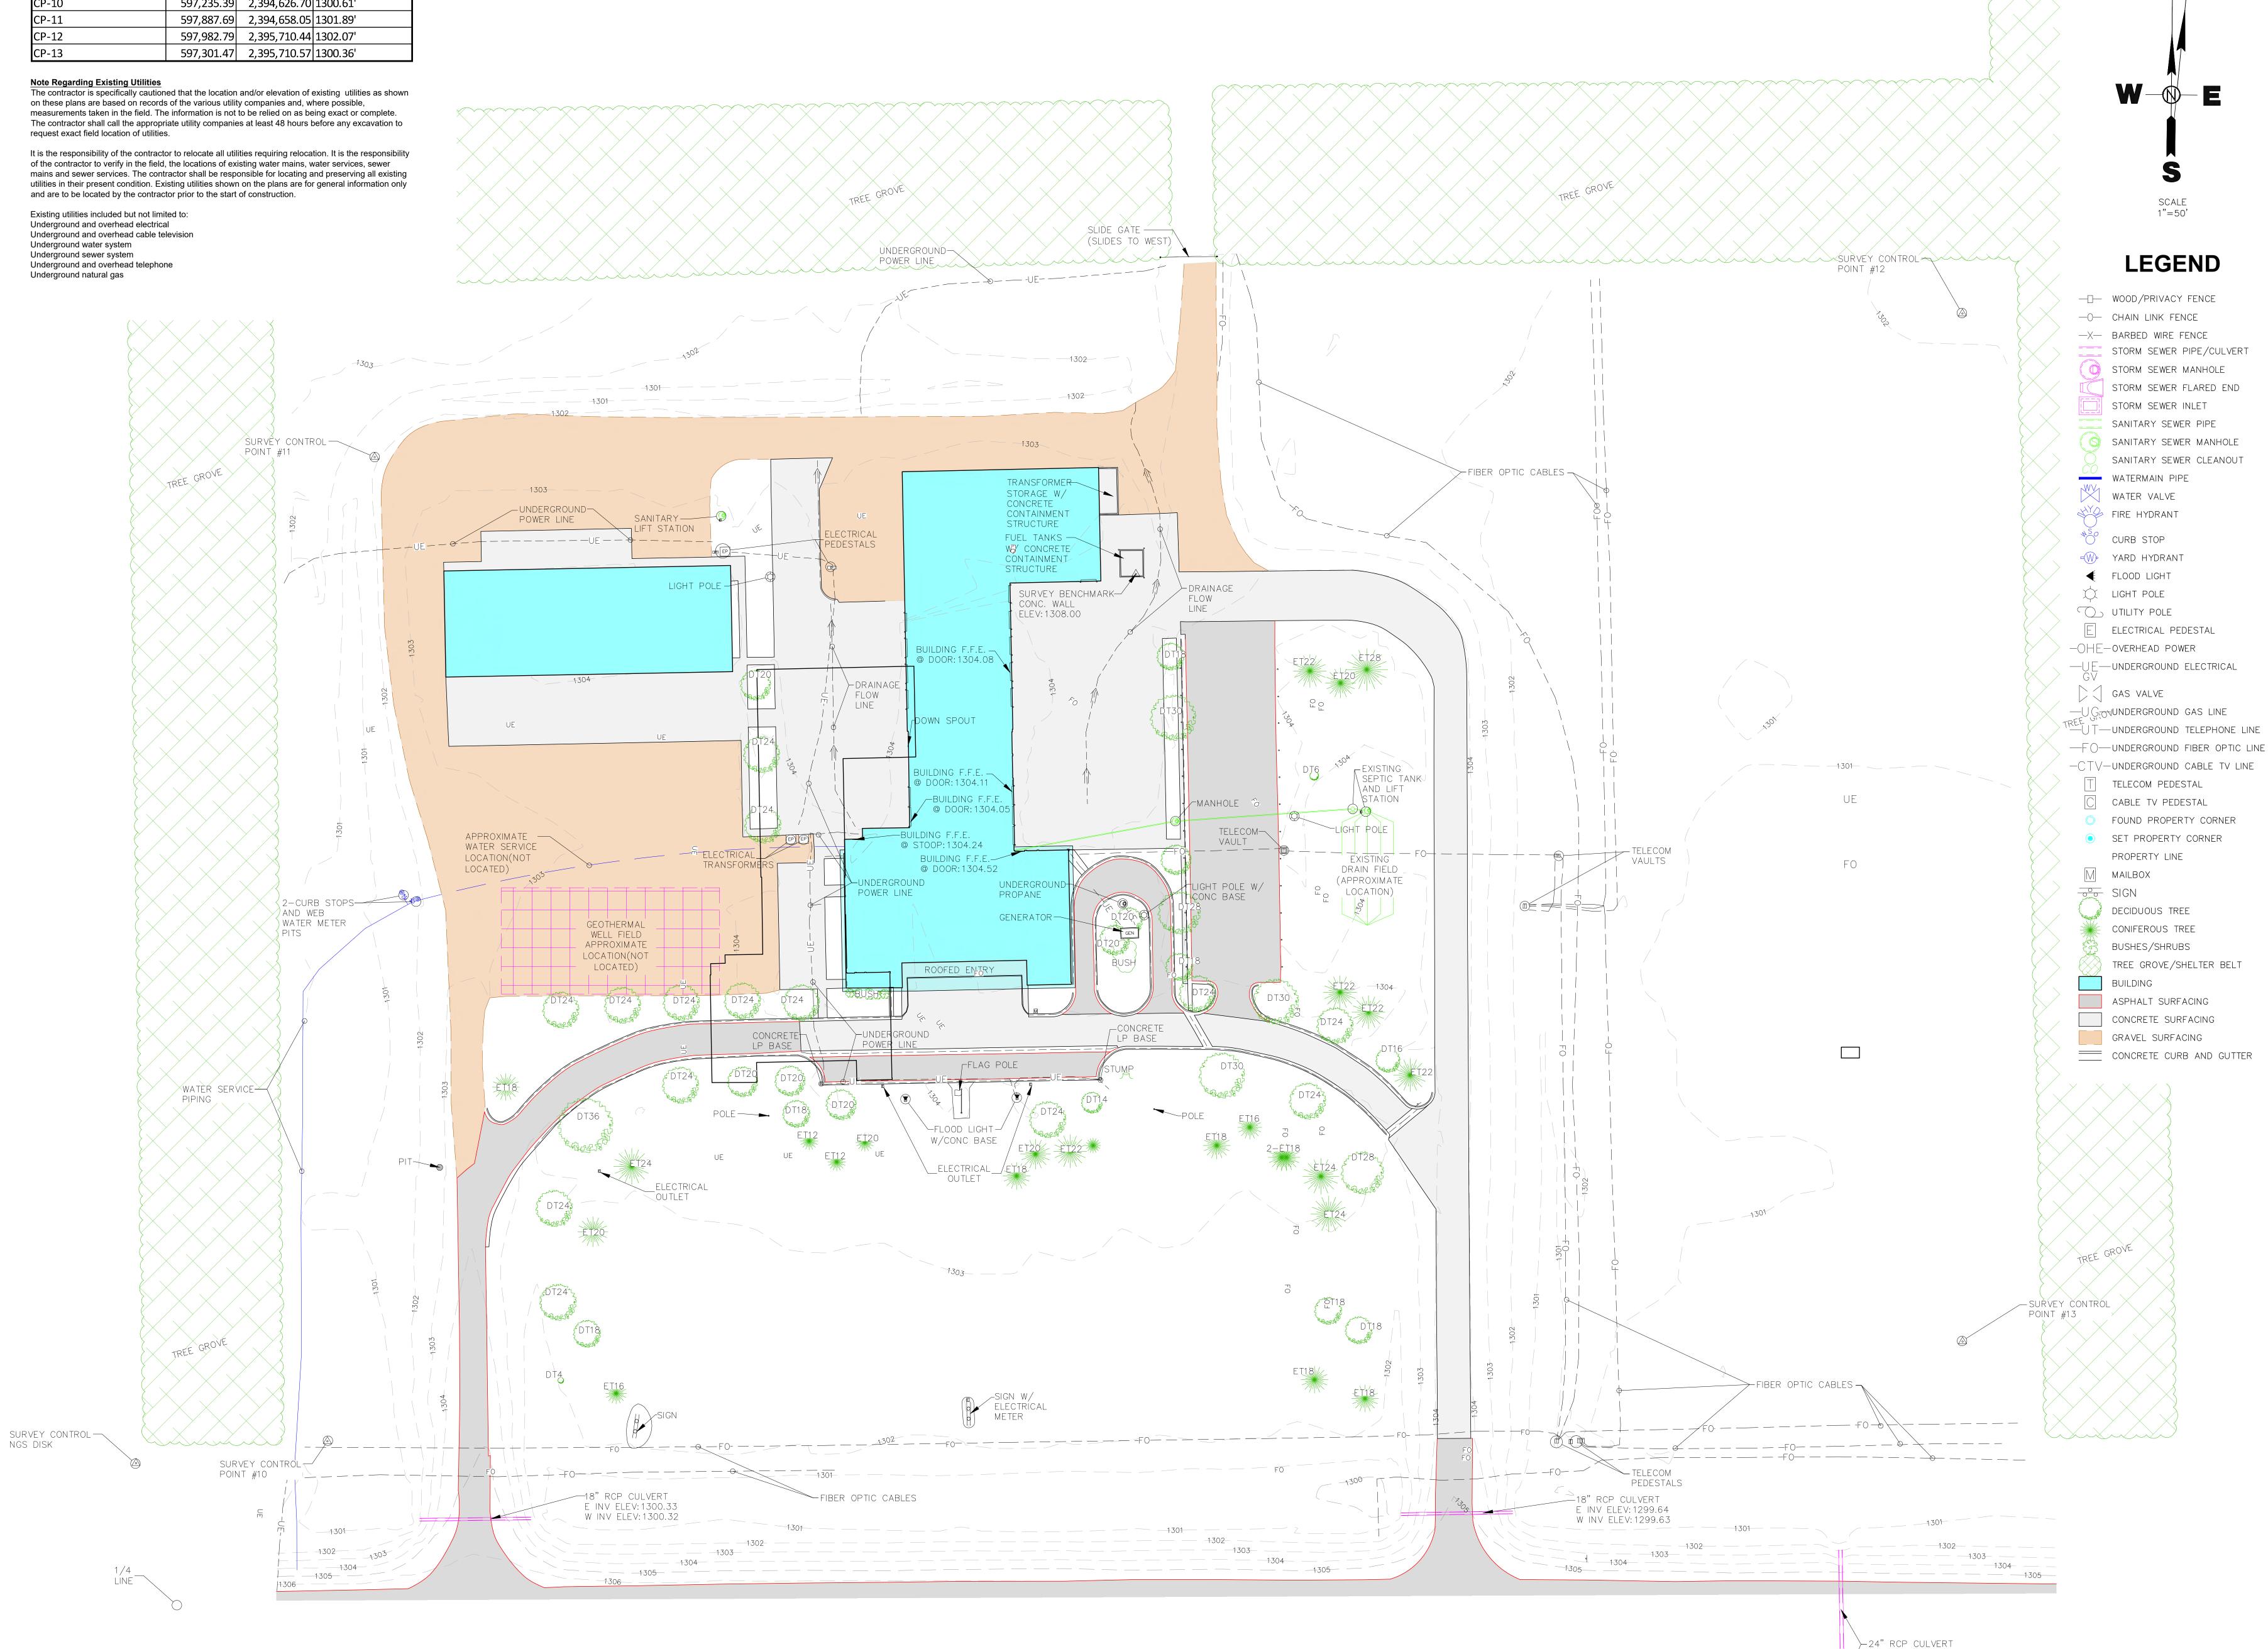
CO-OP PROJECT NO: 14657 SPENCER ALAN


ISSUE: 5/15/2025 100% CONSTRUCTION DOCUMENTS **REVISION SCHEDULE:**

PROJECT: NORTHERN ELECTRIC NORTHERN ELECTRIC COOPERATIVE BATH, SOUTH DAKOTA

SHEET TITLE: ASSEMBLIES, CODE STANDARDS & SYMBOLS LEGEND

SURVEY CONTROL POINT	NORTHING	EASTING	POINT ELEVATION
DISK	597,220.91	2,394,499.83	1301.69'
CP-10	597,235.39	2,394,626.70	1300.61'
CP-11	597,887.69	2,394,658.05	1301.89'
CP-12	597,982.79	2,395,710.44	1302.07'
CP-13	597,301.47	2,395,710.57	1300.36'
Note Regarding Existing Utilities The contractor is specifically caution on these plans are based on records measurements taken in the field. The The contractor shall call the approprieduest exact field location of utilities	s of the various utilit e information is not iate utility companie	y companies and, w to be relied on as be	here possible, eing exact or complete.
The contractor is specifically caution on these plans are based on records measurements taken in the field. The contractor shall call the appropring the contractor shall call the call the contractor shall call the contractor shall call the call the contractor shall call the call t	s of the various utilite information is not iate utility companies. or to relocate all util, the locations of exitation shall be responsiting utilities shown	y companies and, we to be relied on as be as at least 48 hours but it it is requiring relocating water mains, we consible for locating as on the plans are for	here possible, eing exact or complete. pefore any excavation to tion. It is the responsibility atter services, sewer and preserving all existing



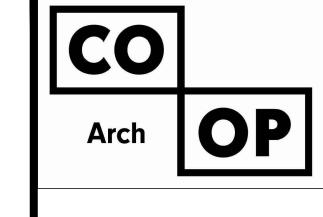

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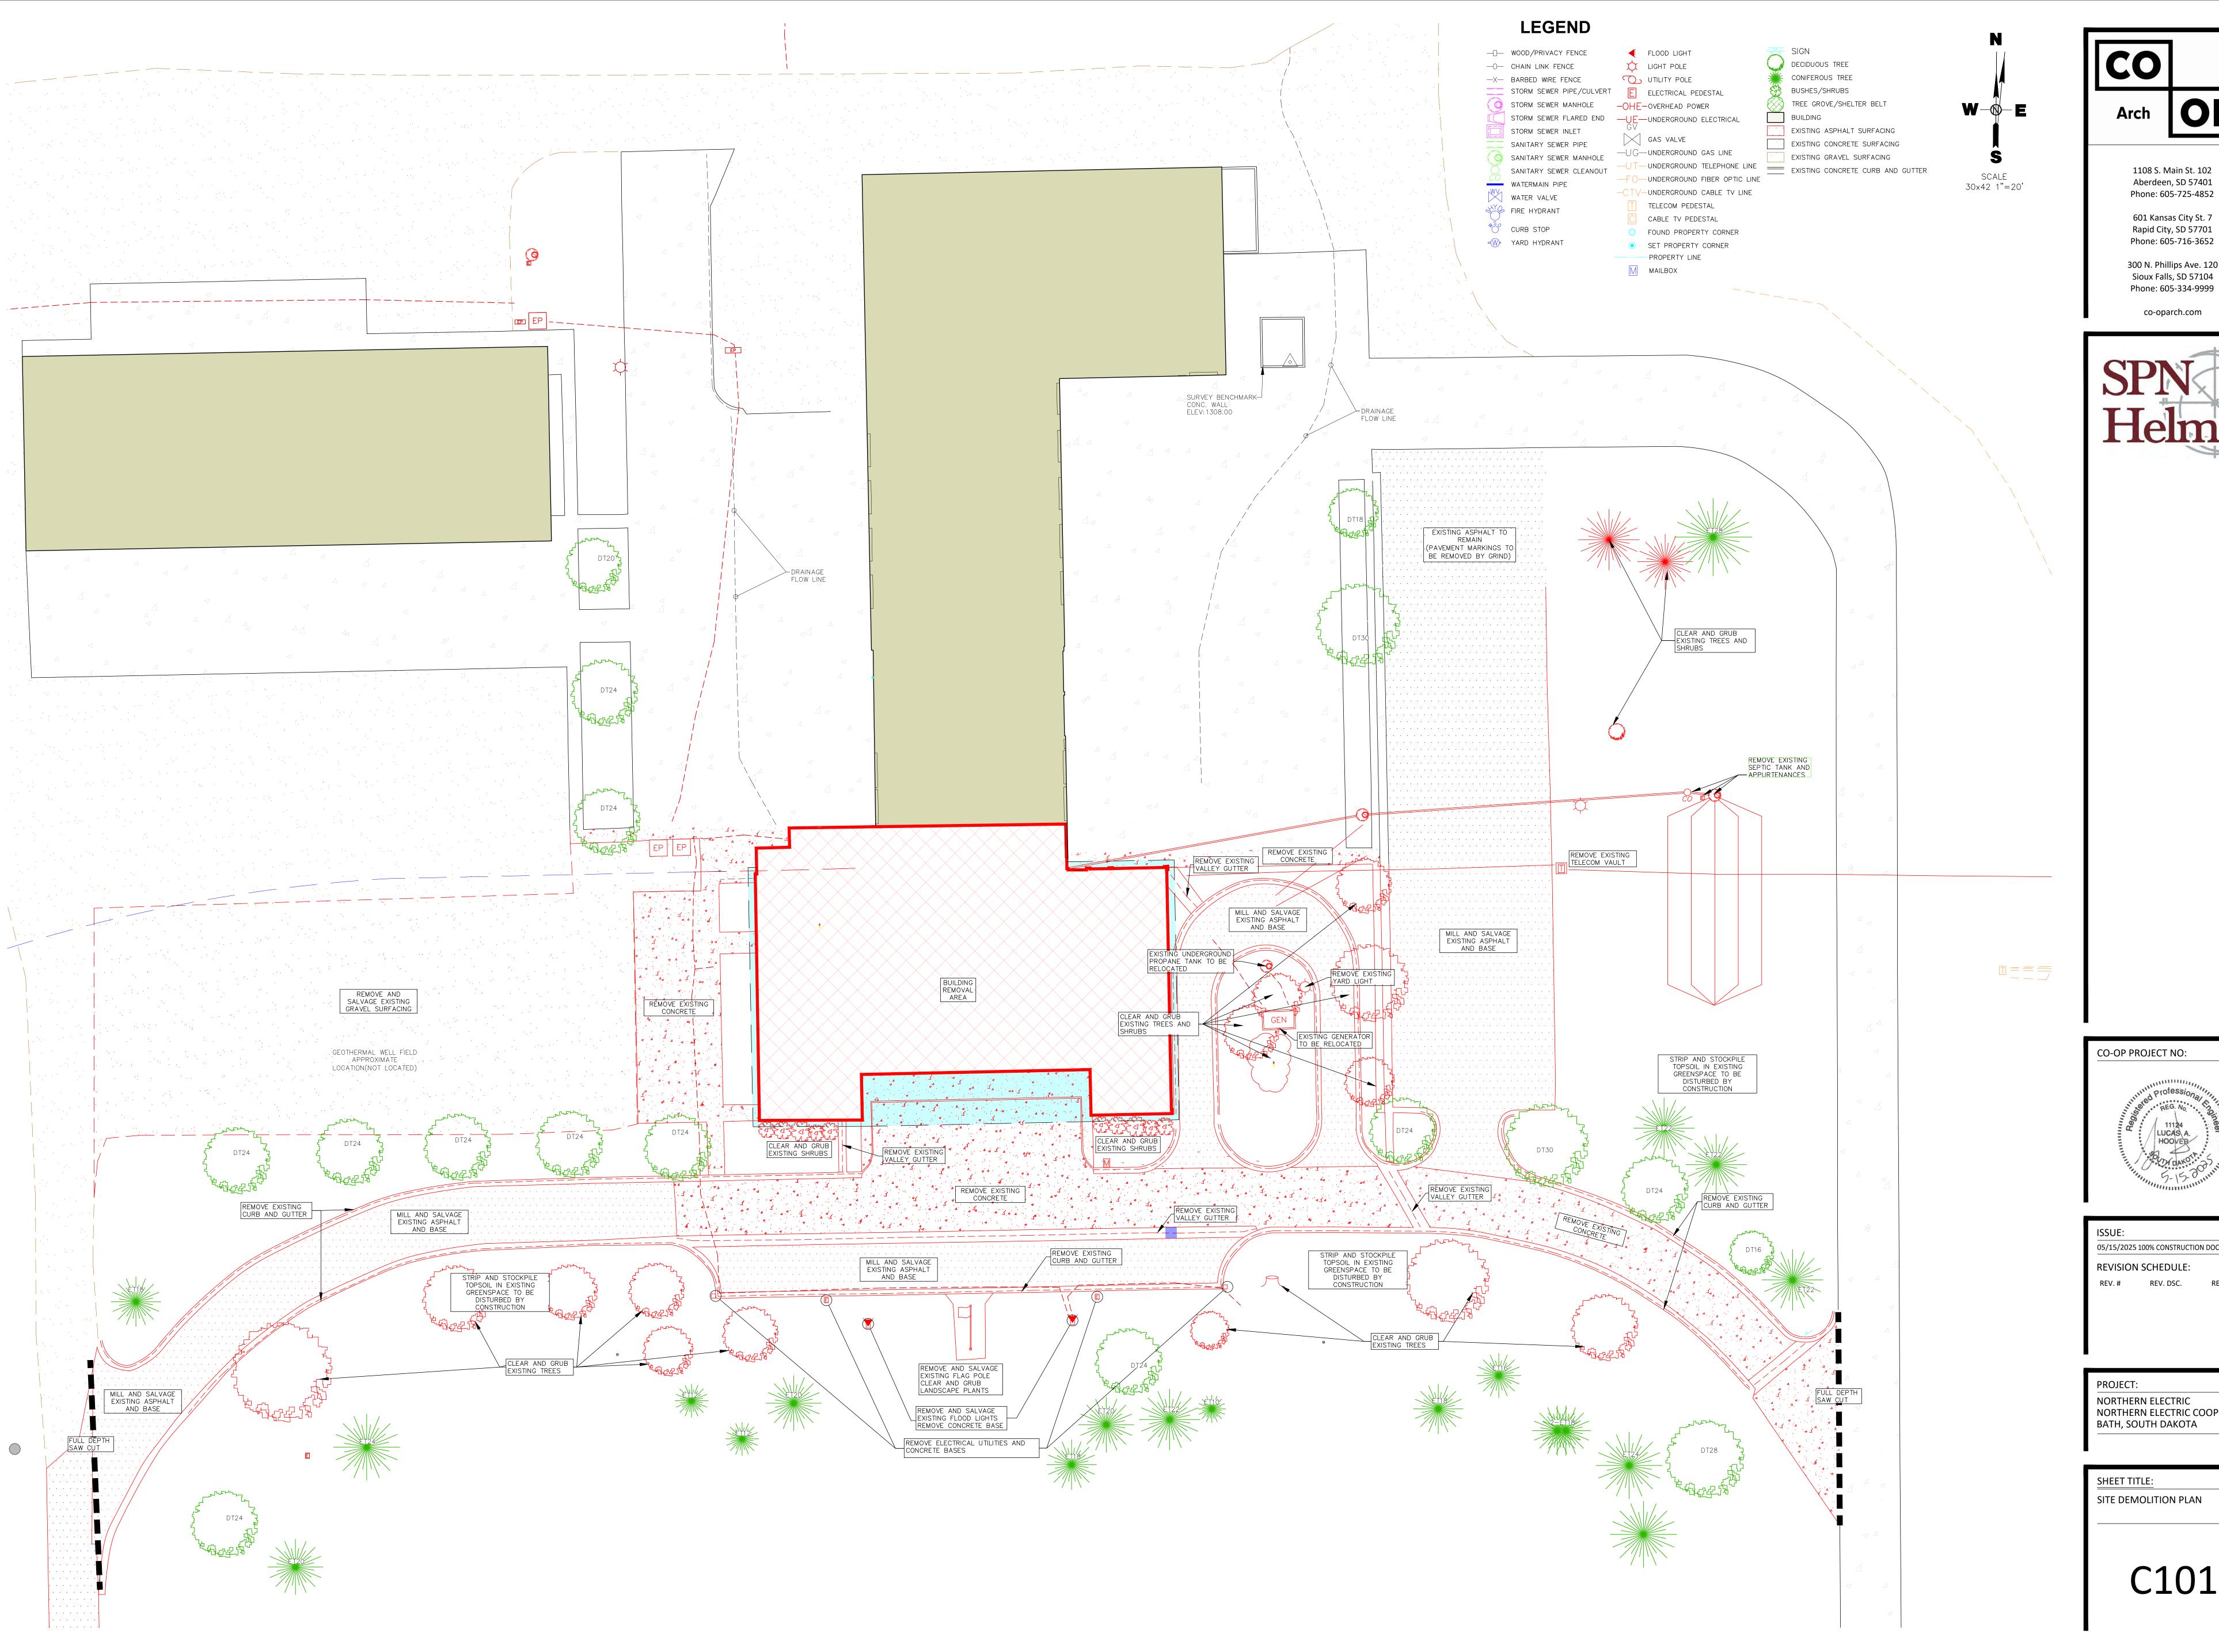
CO-OP PROJECT NO:

05/15/2025 100% CONSTRUCTION DOCUMENTS **REVISION SCHEDULE:** REV. # REV. DSC.

PROJECT: NORTHERN ELECTRIC NORTHERN ELECTRIC COOPERATIVE BATH, SOUTH DAKOTA

SHEET TITLE: TOPOGRAPHIC SURVEY

/ N INV ELEV: 1299.86 / S INV ELEV: 1299.33



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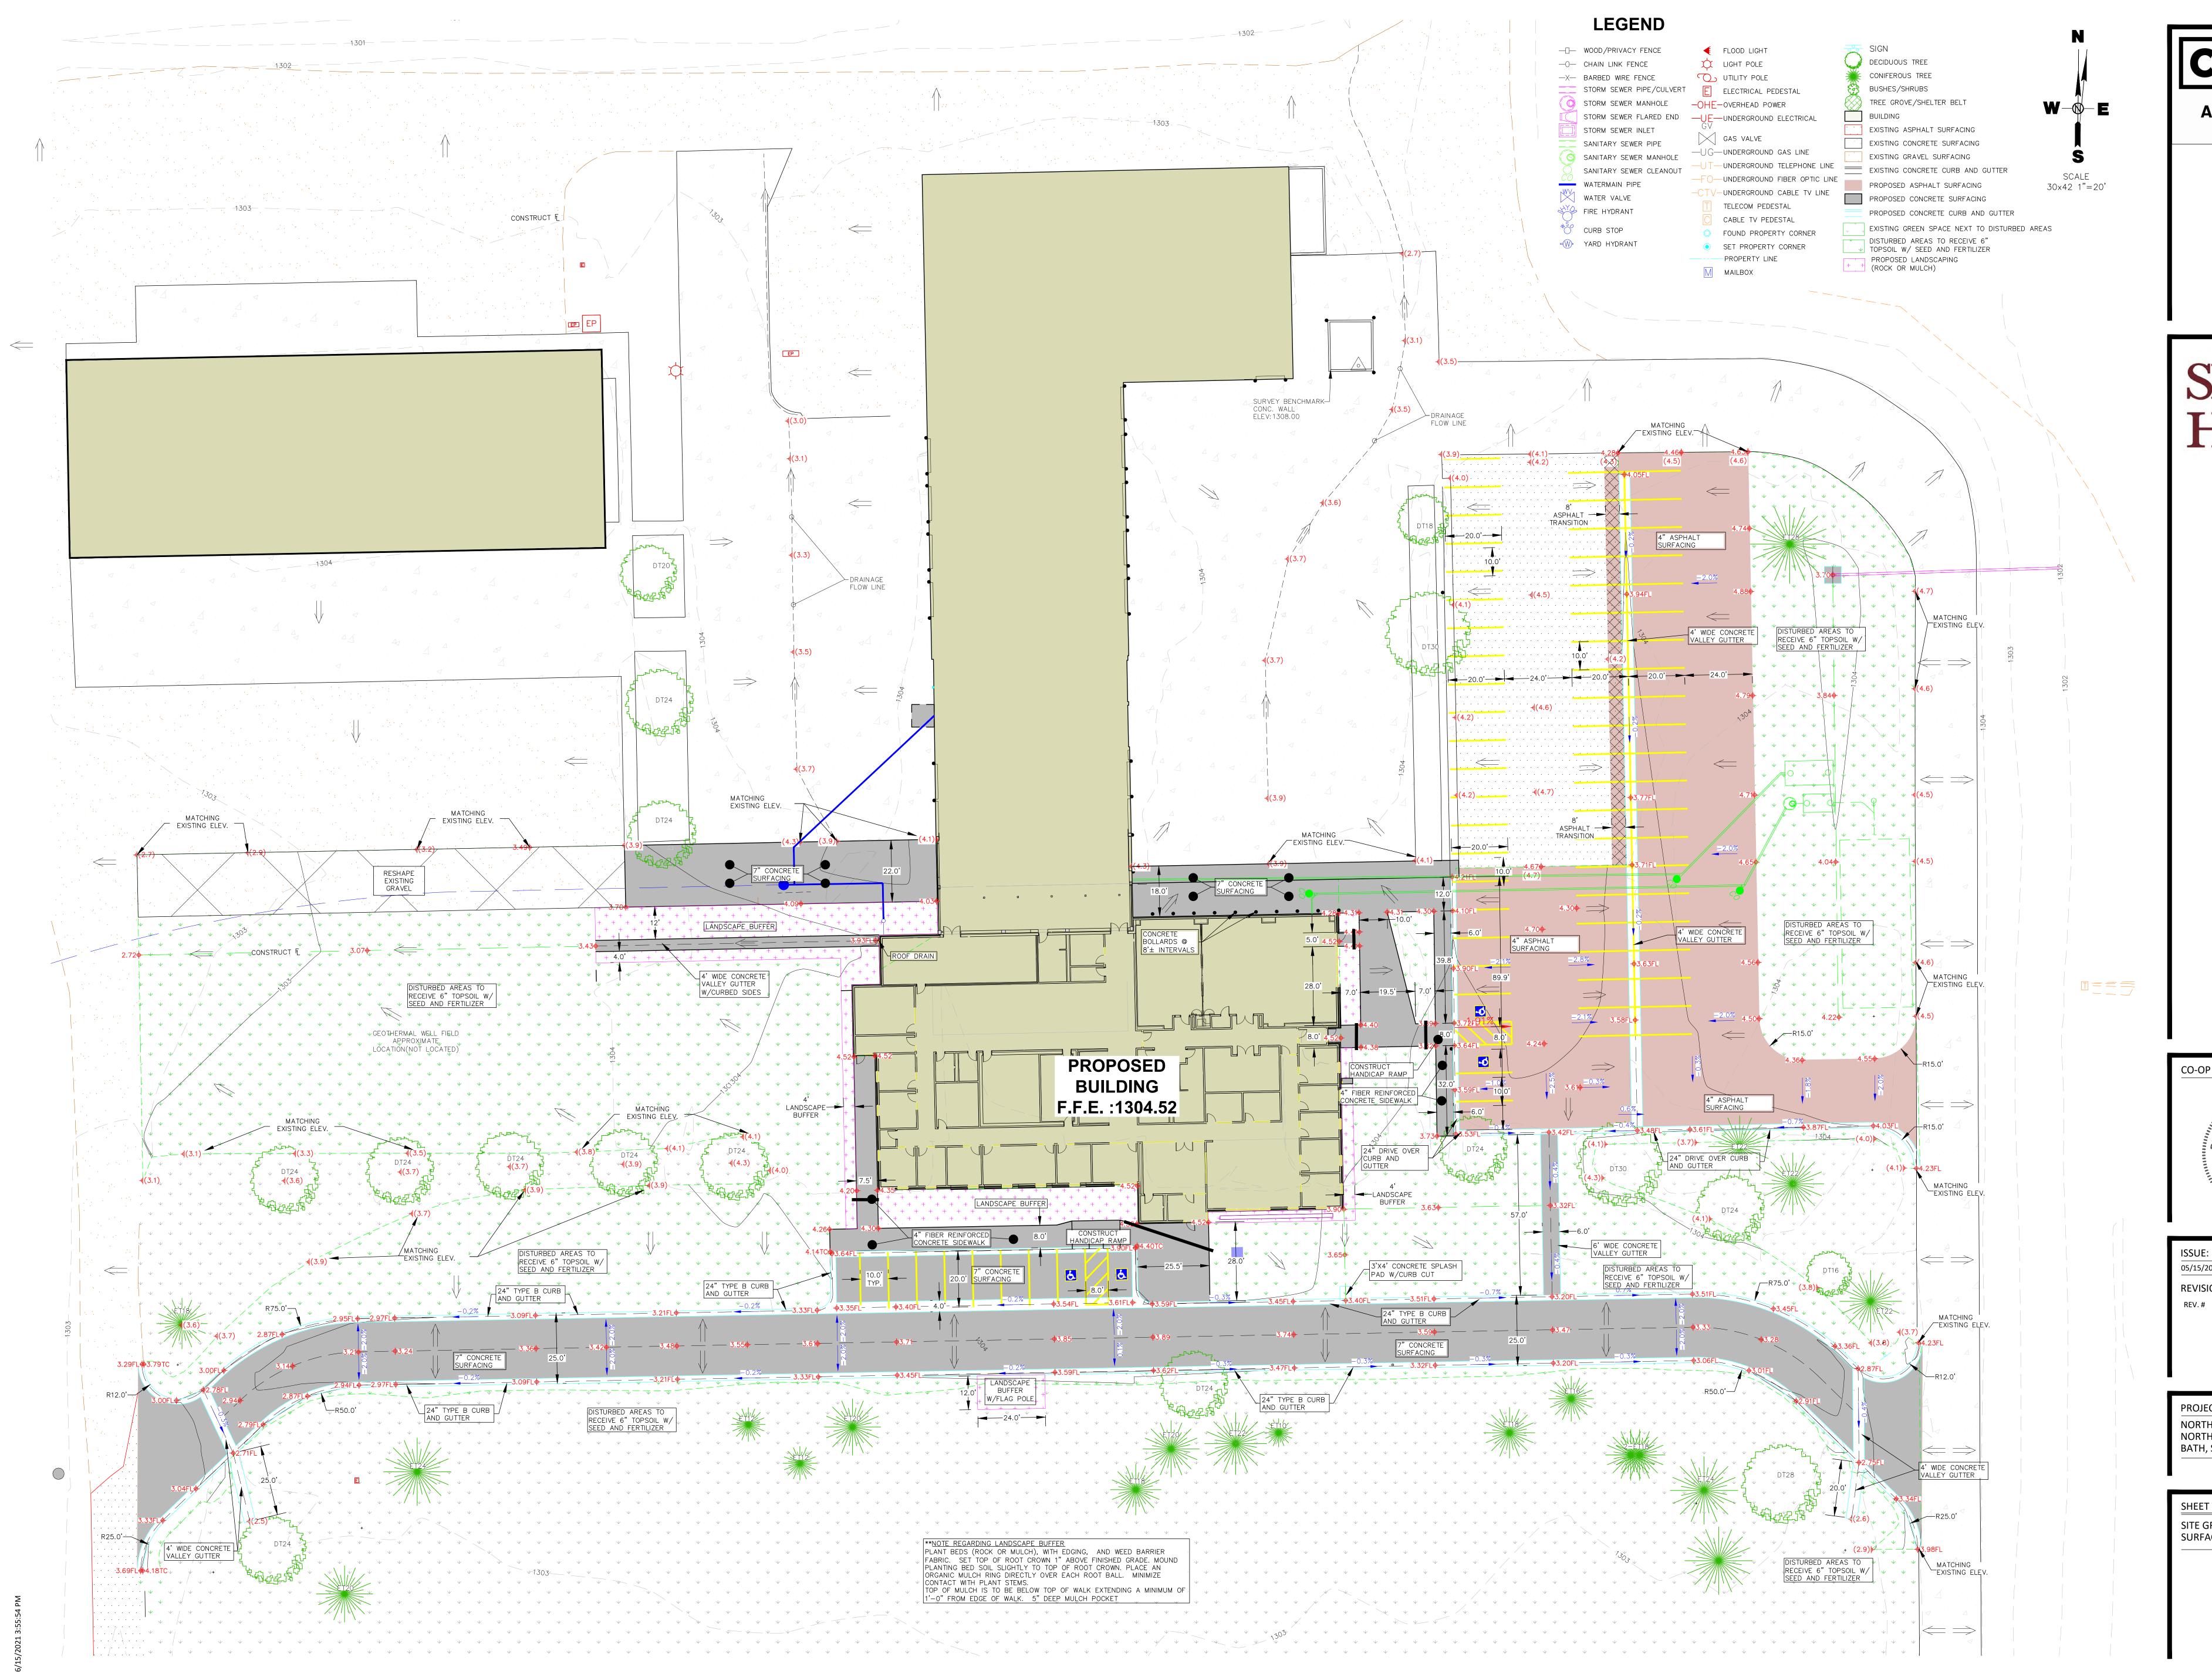
CO-OP PROJECT NO:

05/15/2025 100% CONSTRUCTION DOCUMENTS **REVISION SCHEDULE:** REV. # REV. DSC.

NORTHERN ELECTRIC
NORTHERN ELECTRIC COOPERATIVE
BATH, SOUTH DAKOTA

SITE DEMOLITION PLAN

C101



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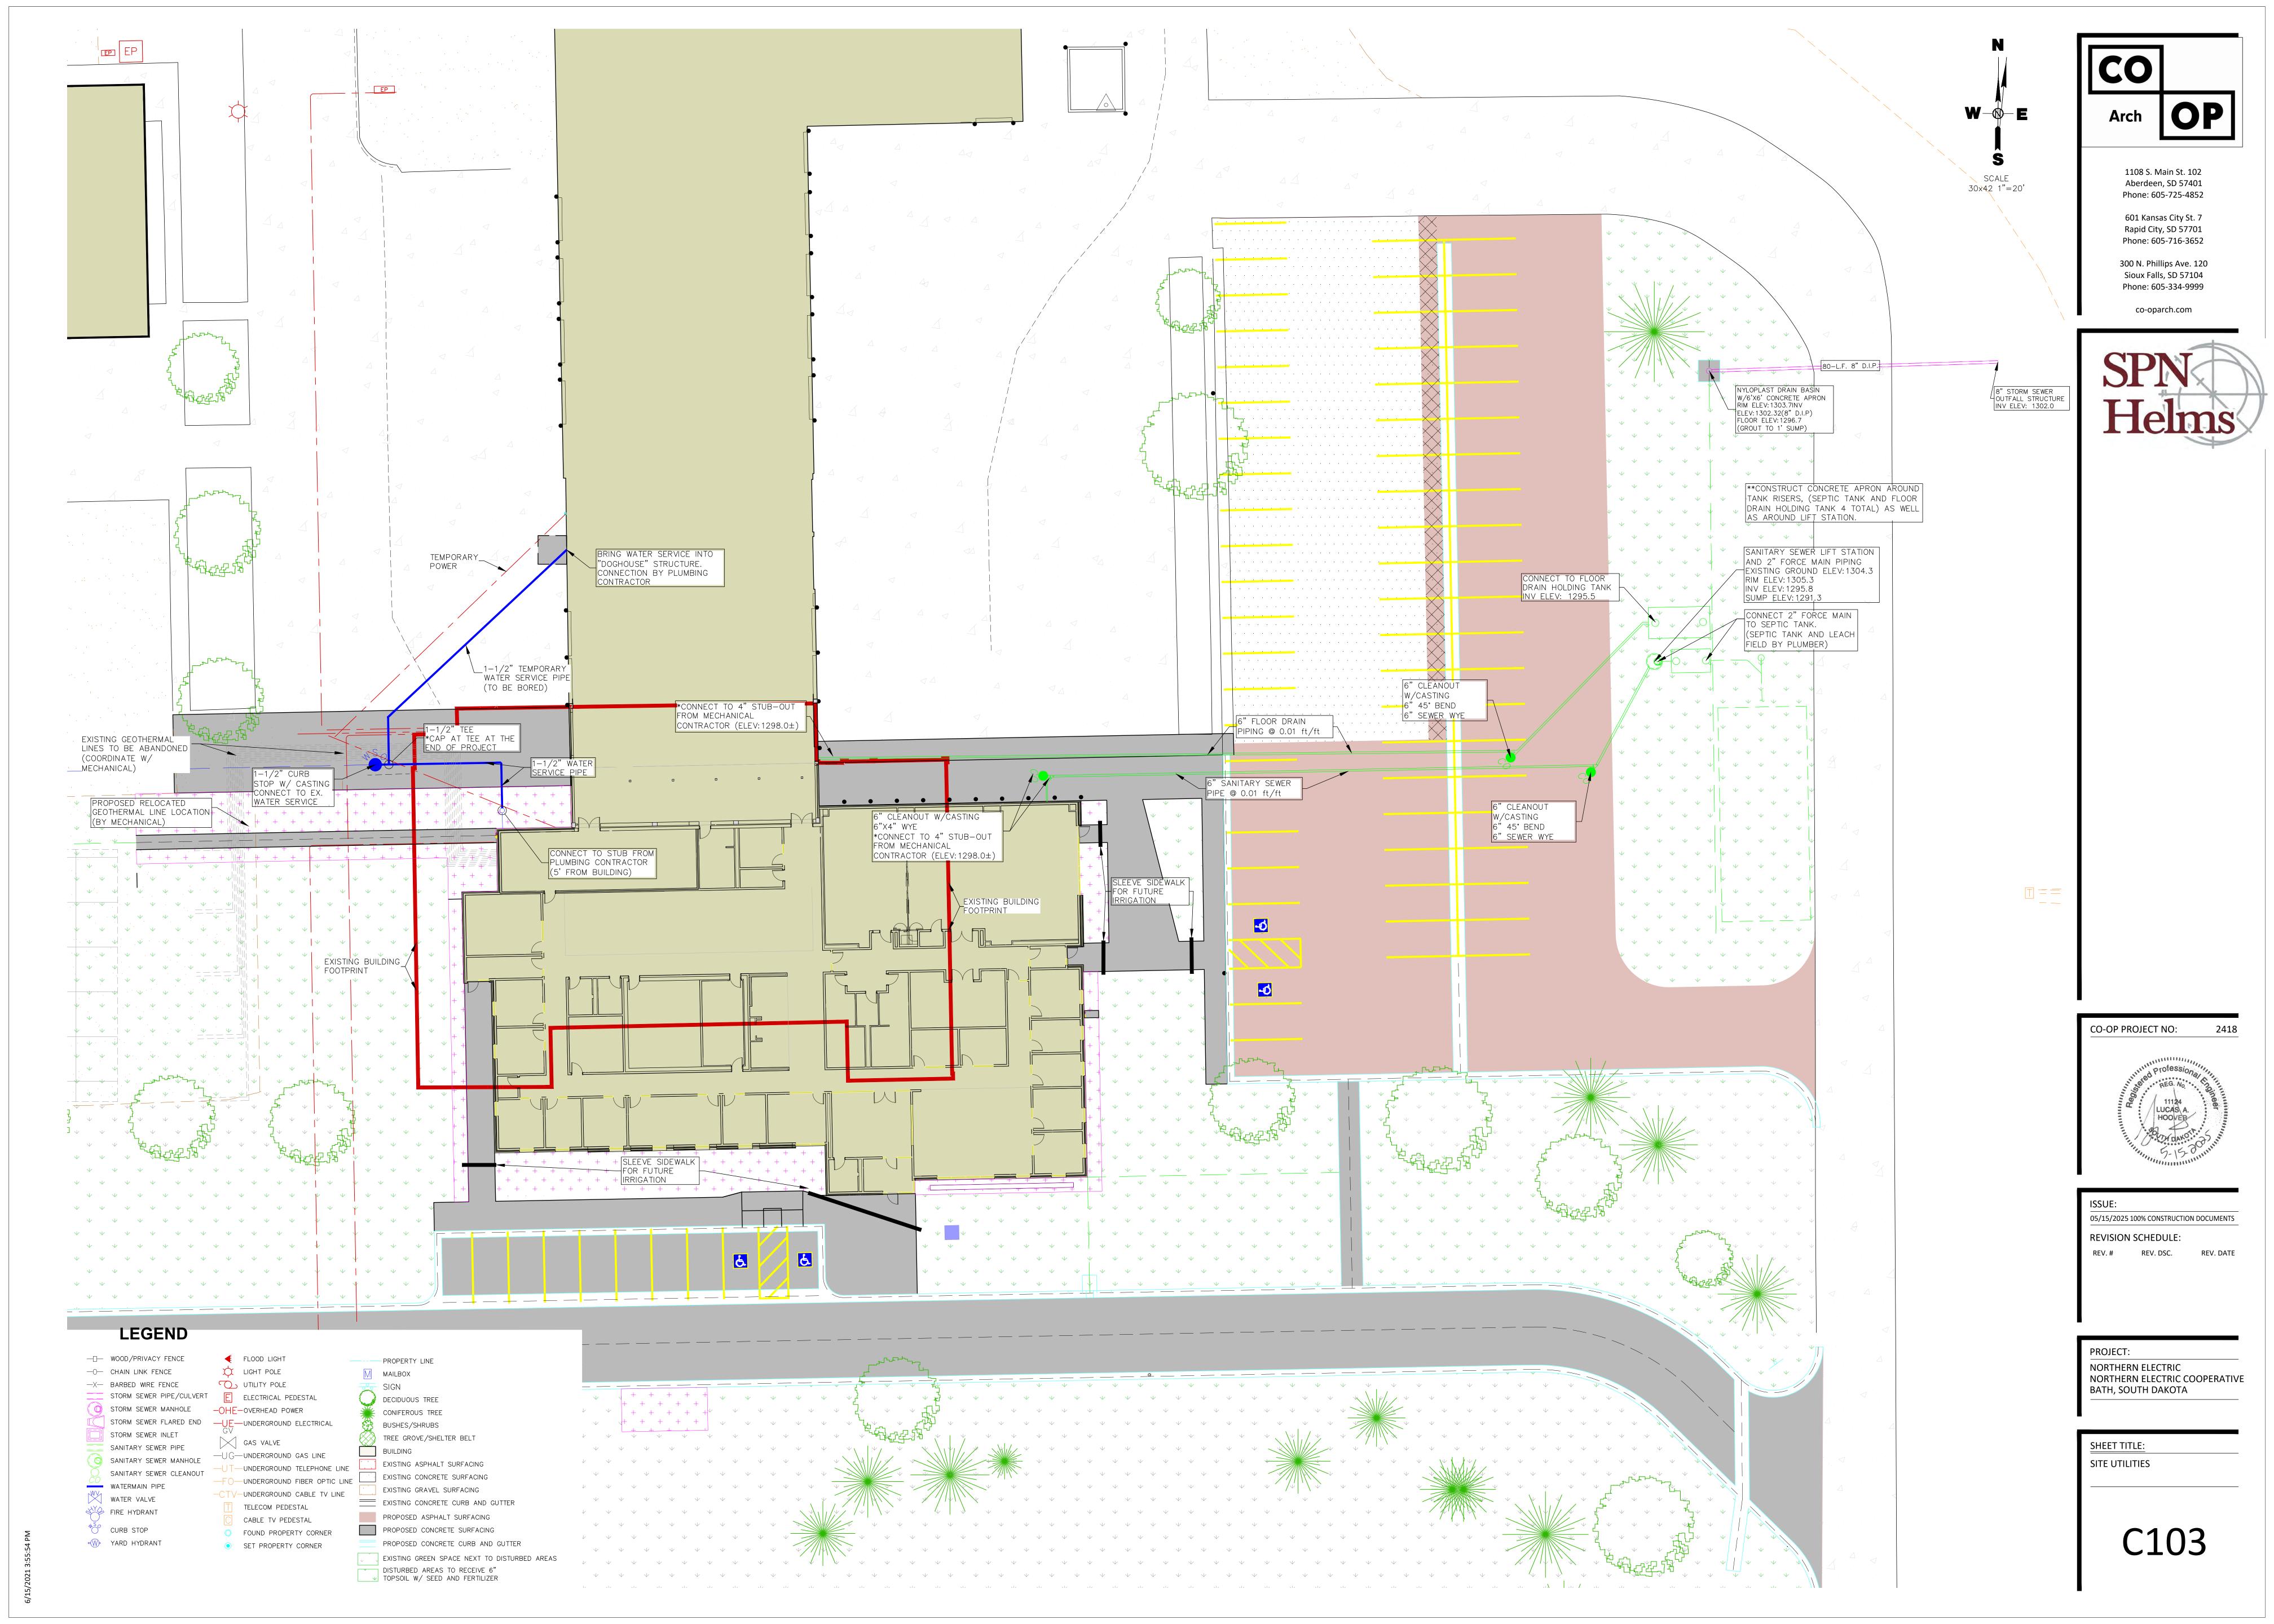
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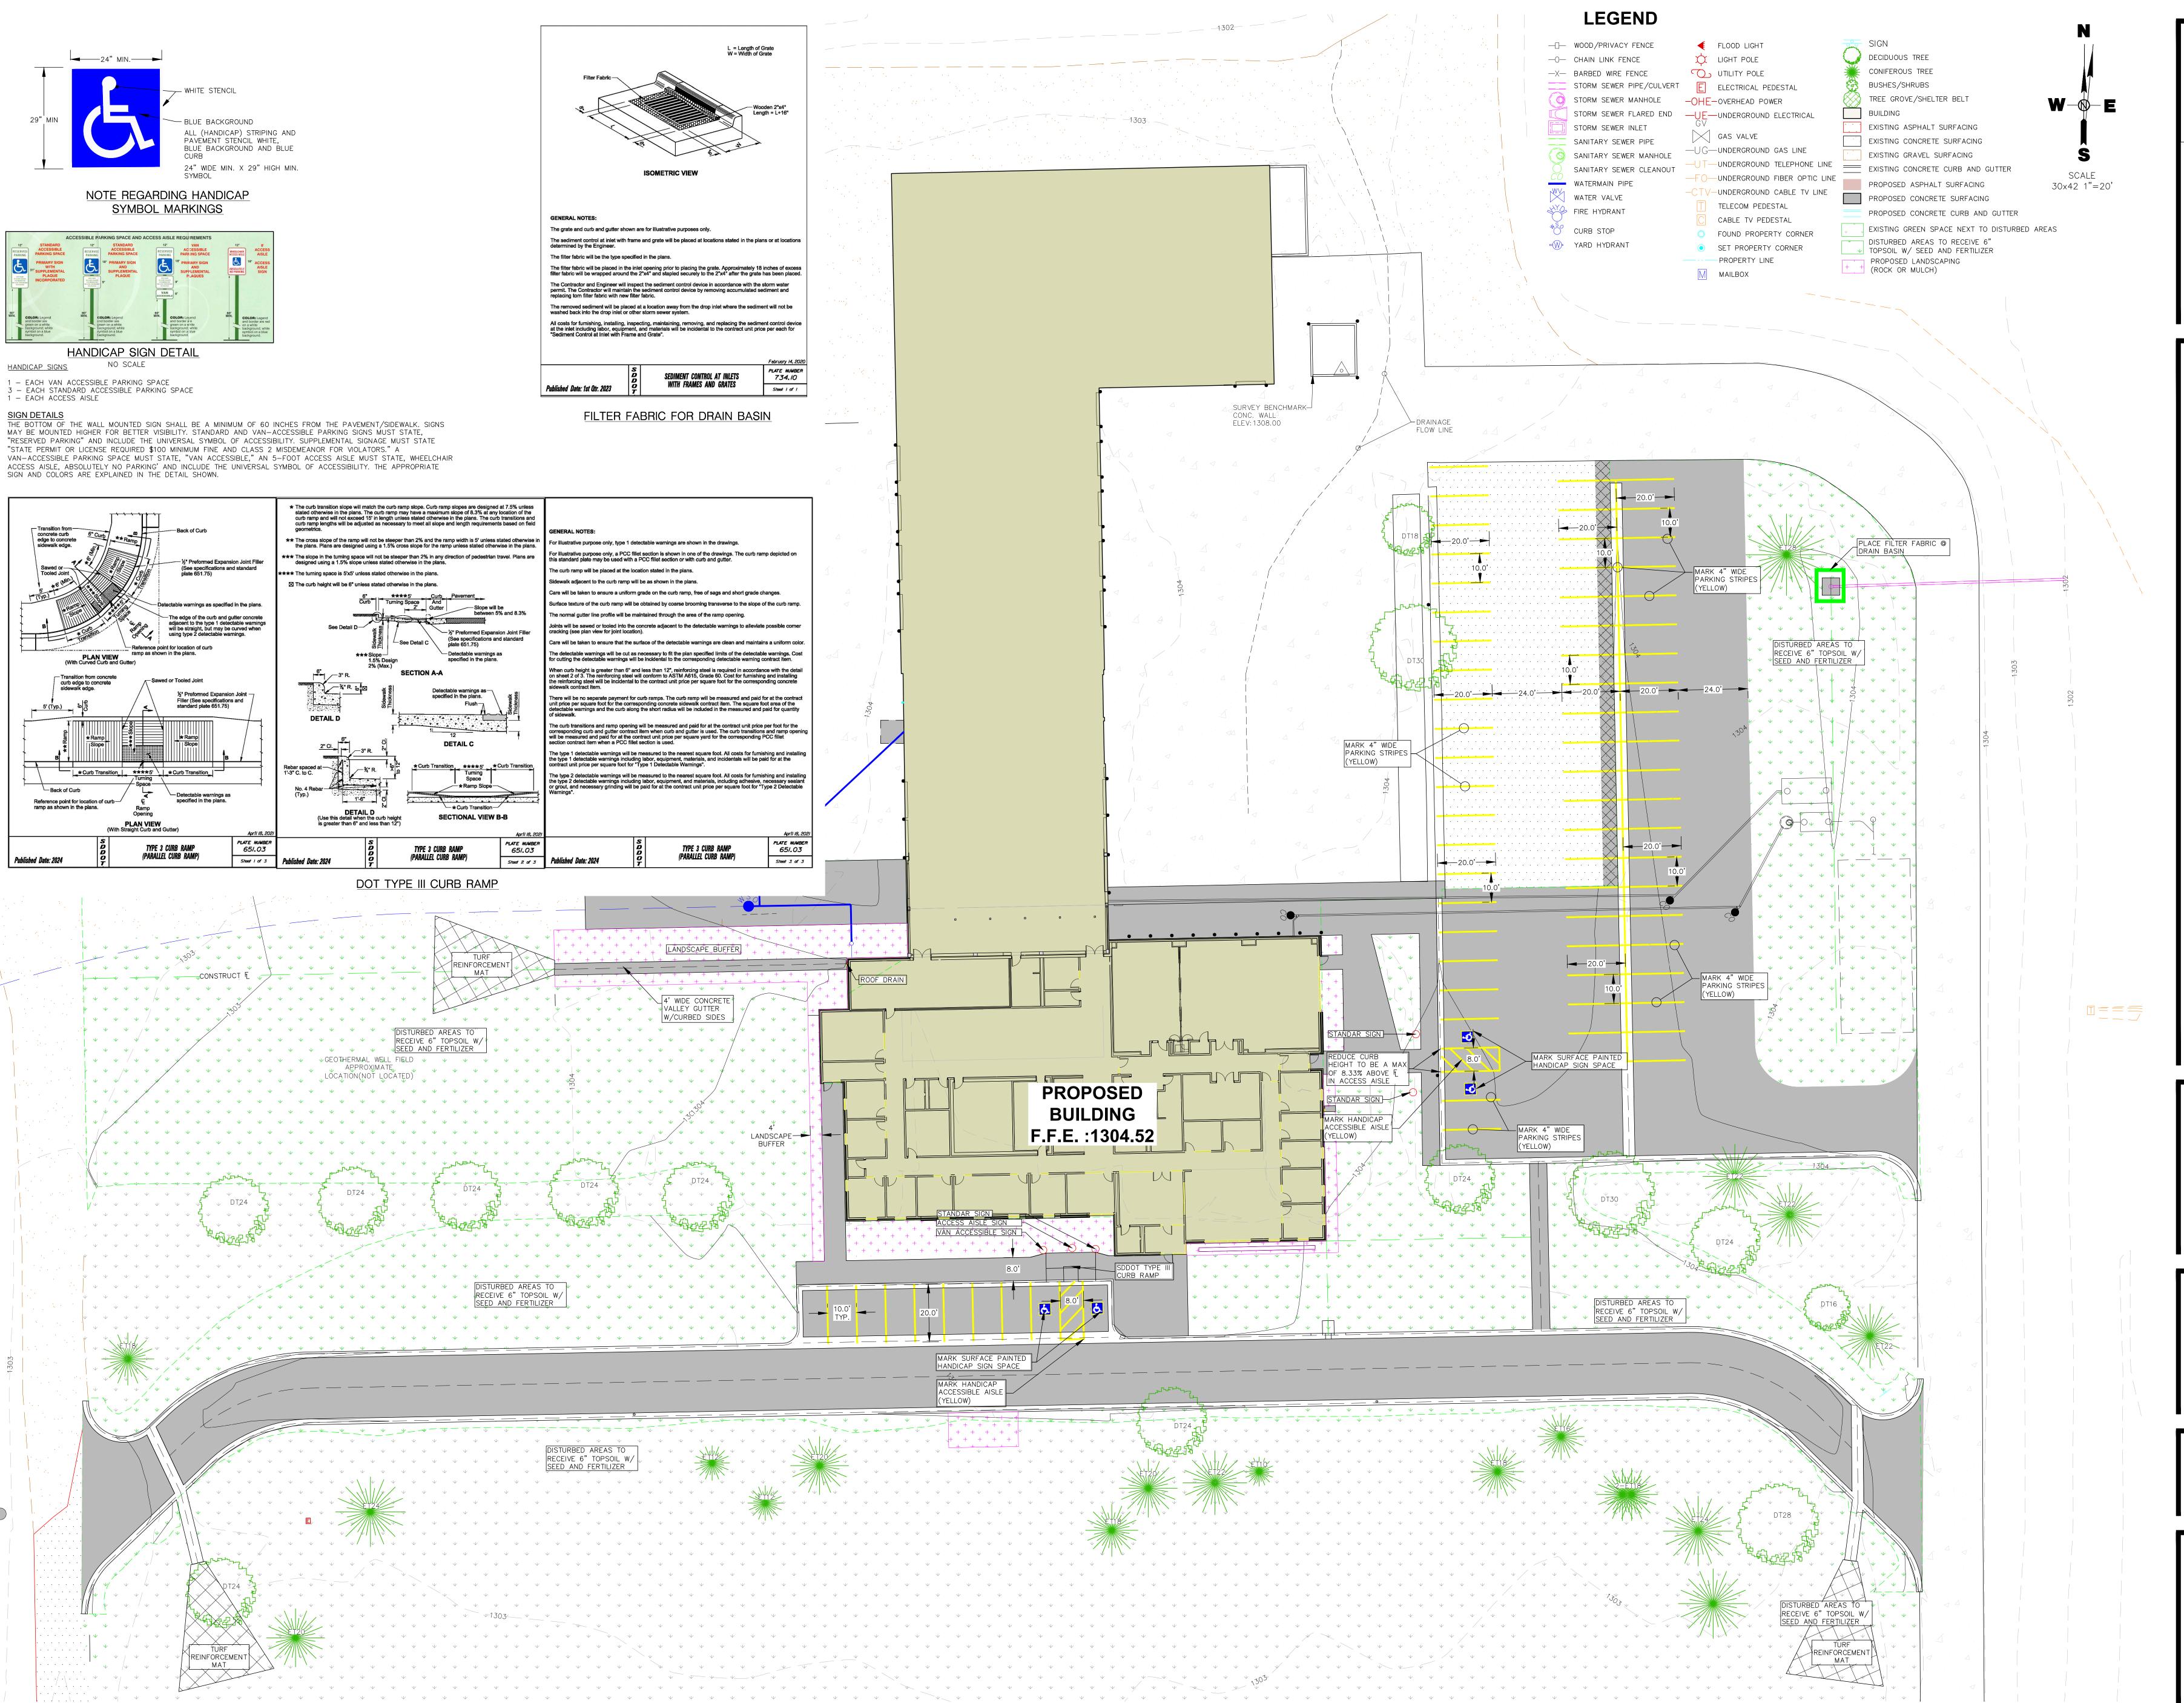
05/15/2025 100% CONSTRUCTION DOCUMENTS **REVISION SCHEDULE:**

PROJECT: NORTHERN ELECTRIC NORTHERN ELECTRIC COOPERATIVE BATH, SOUTH DAKOTA

SHEET TITLE: SITE GRADING AND

SURFACING PLAN






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05/15/2025 100% CONSTRUCTION DOCUMENTS
REVISION SCHEDULE:

PROJECT:

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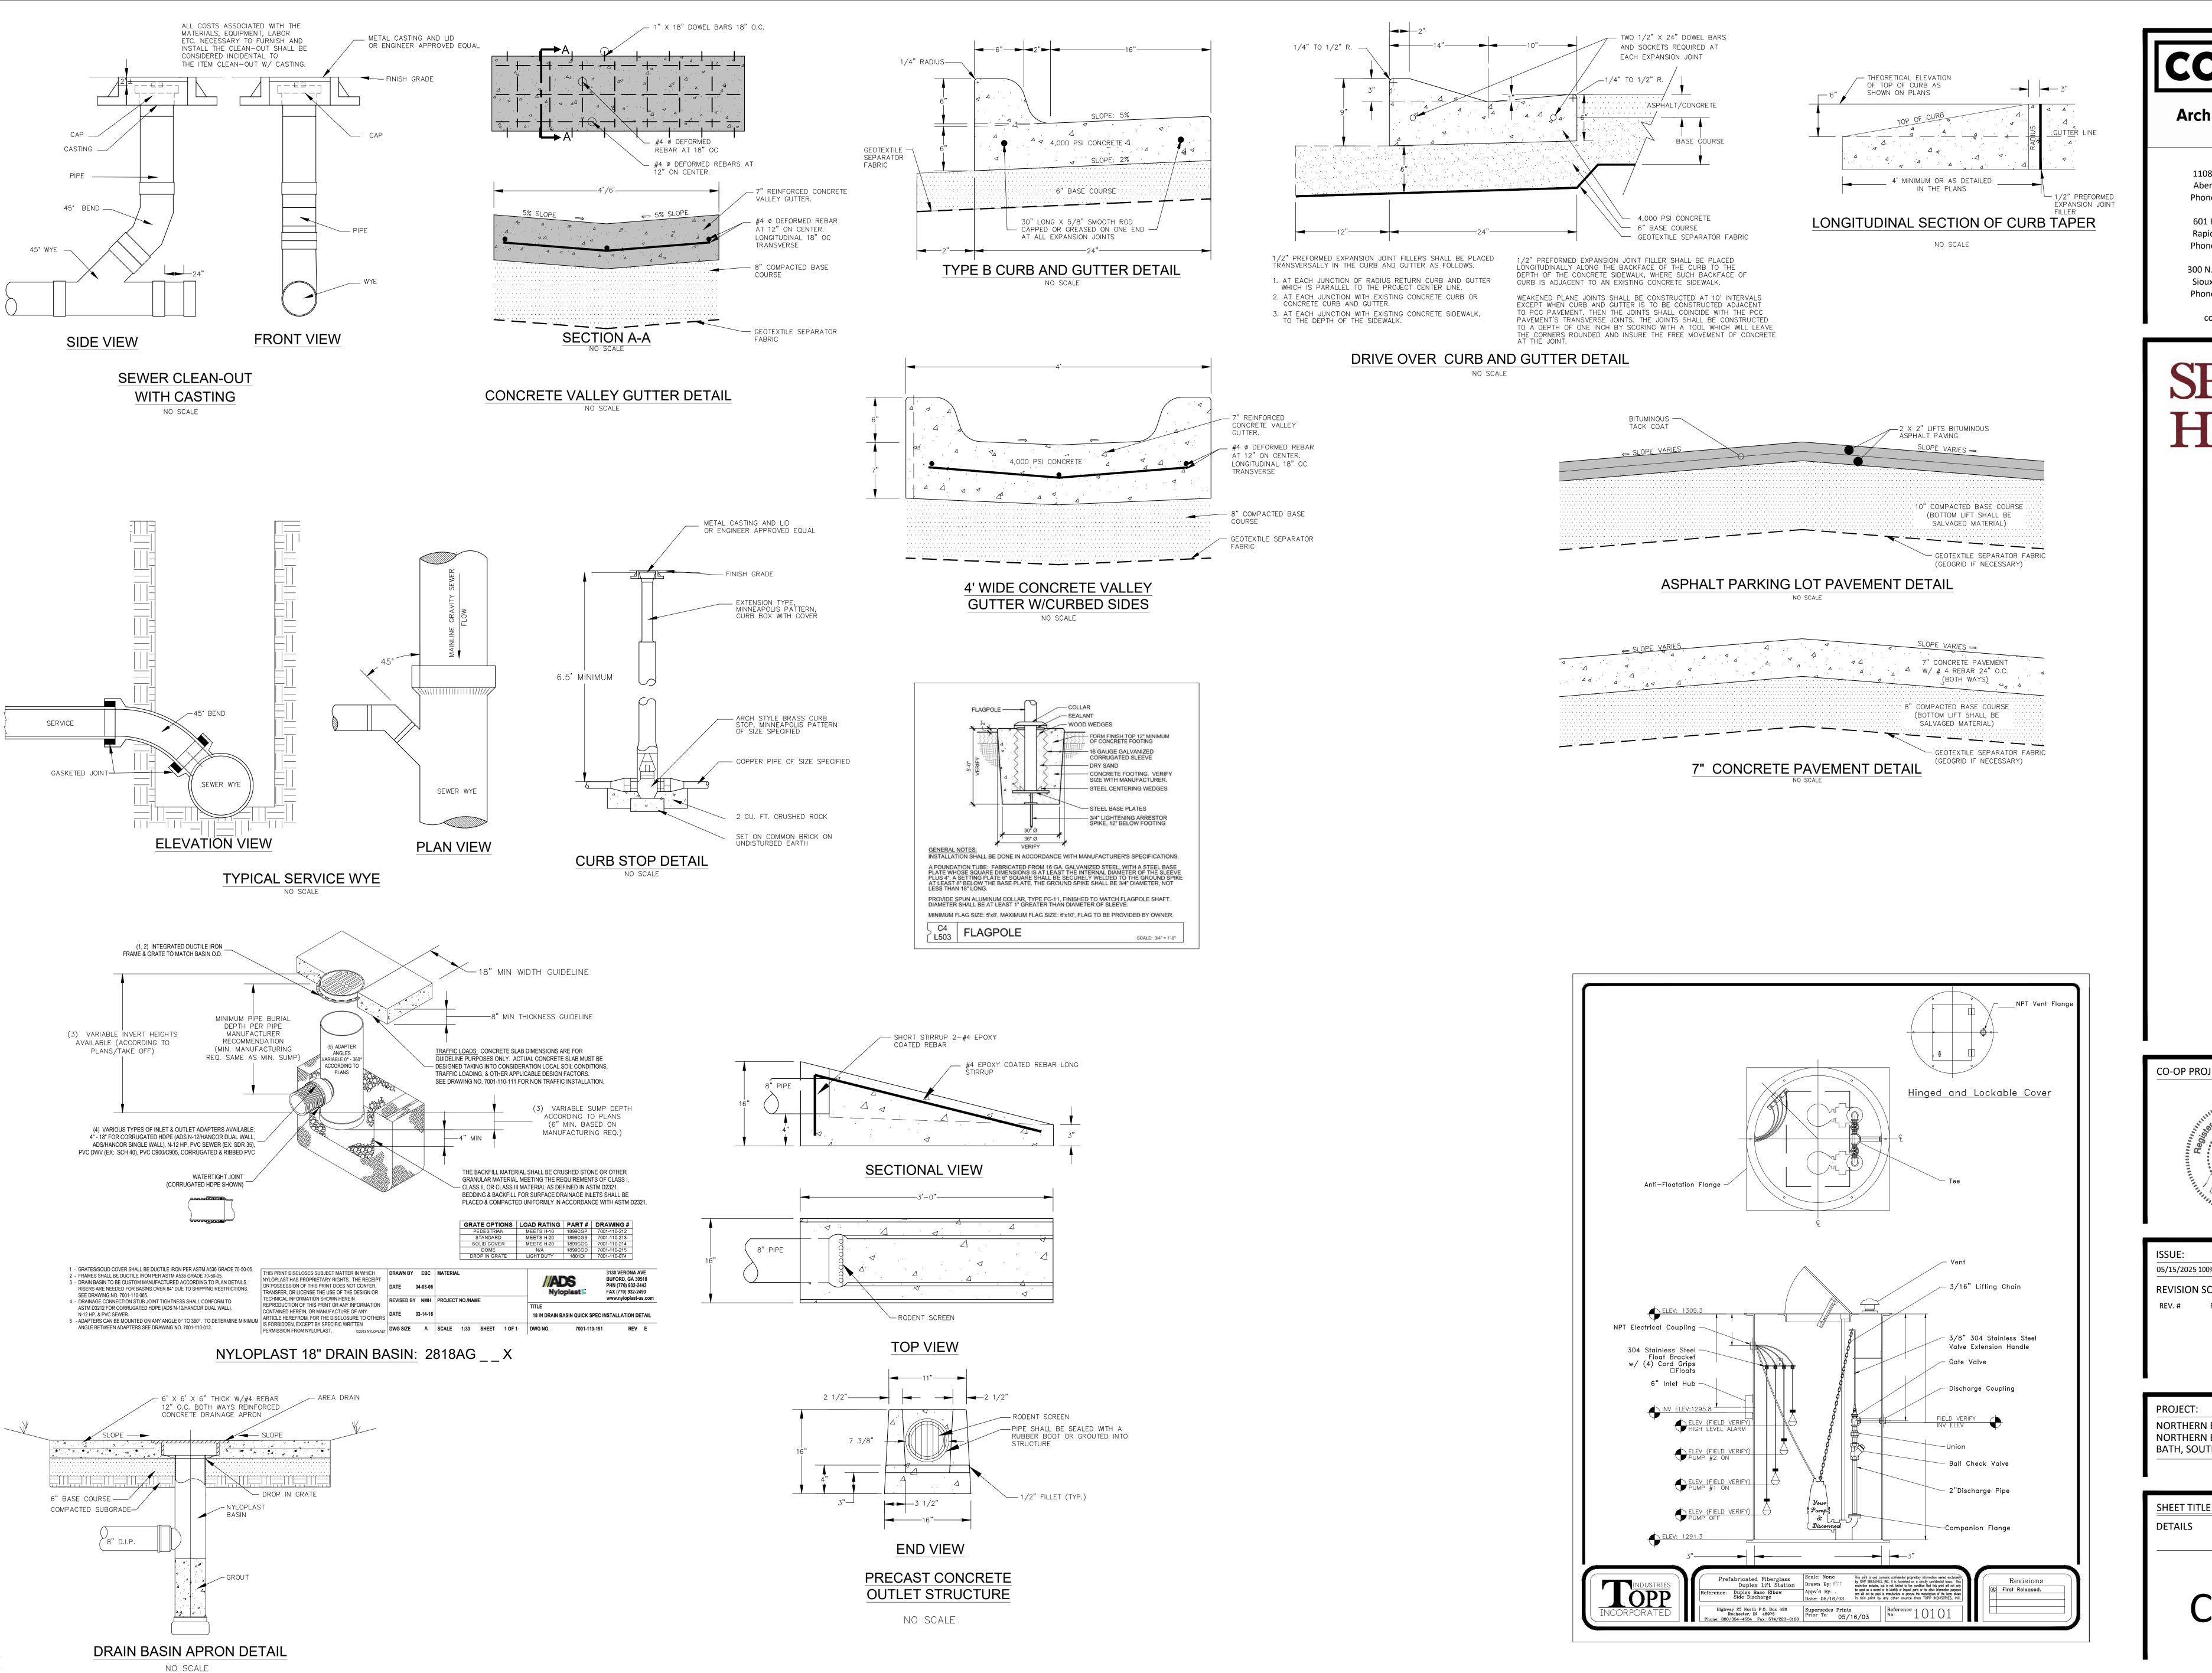
NORTHERN ELECTRIC COOPERATIVE


BATH, SOUTH DAKOTA

HEET TITLE:

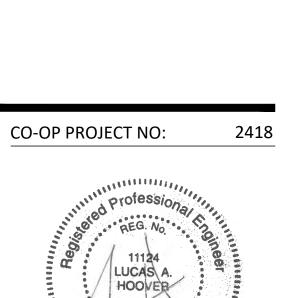
PAVEMENT MARKING AND SWPPP

104



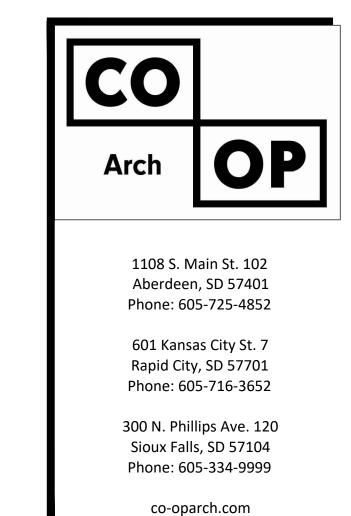



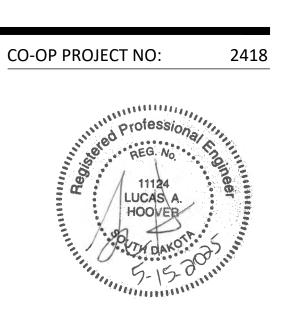


05/15/2025 100% CONSTRUCTION DOCUMENTS **REVISION SCHEDULE:** REV. # REV. DSC.

NORTHERN ELECTRIC

NORTHERN ELECTRIC COOPERATIVE BATH, SOUTH DAKOTA

C105

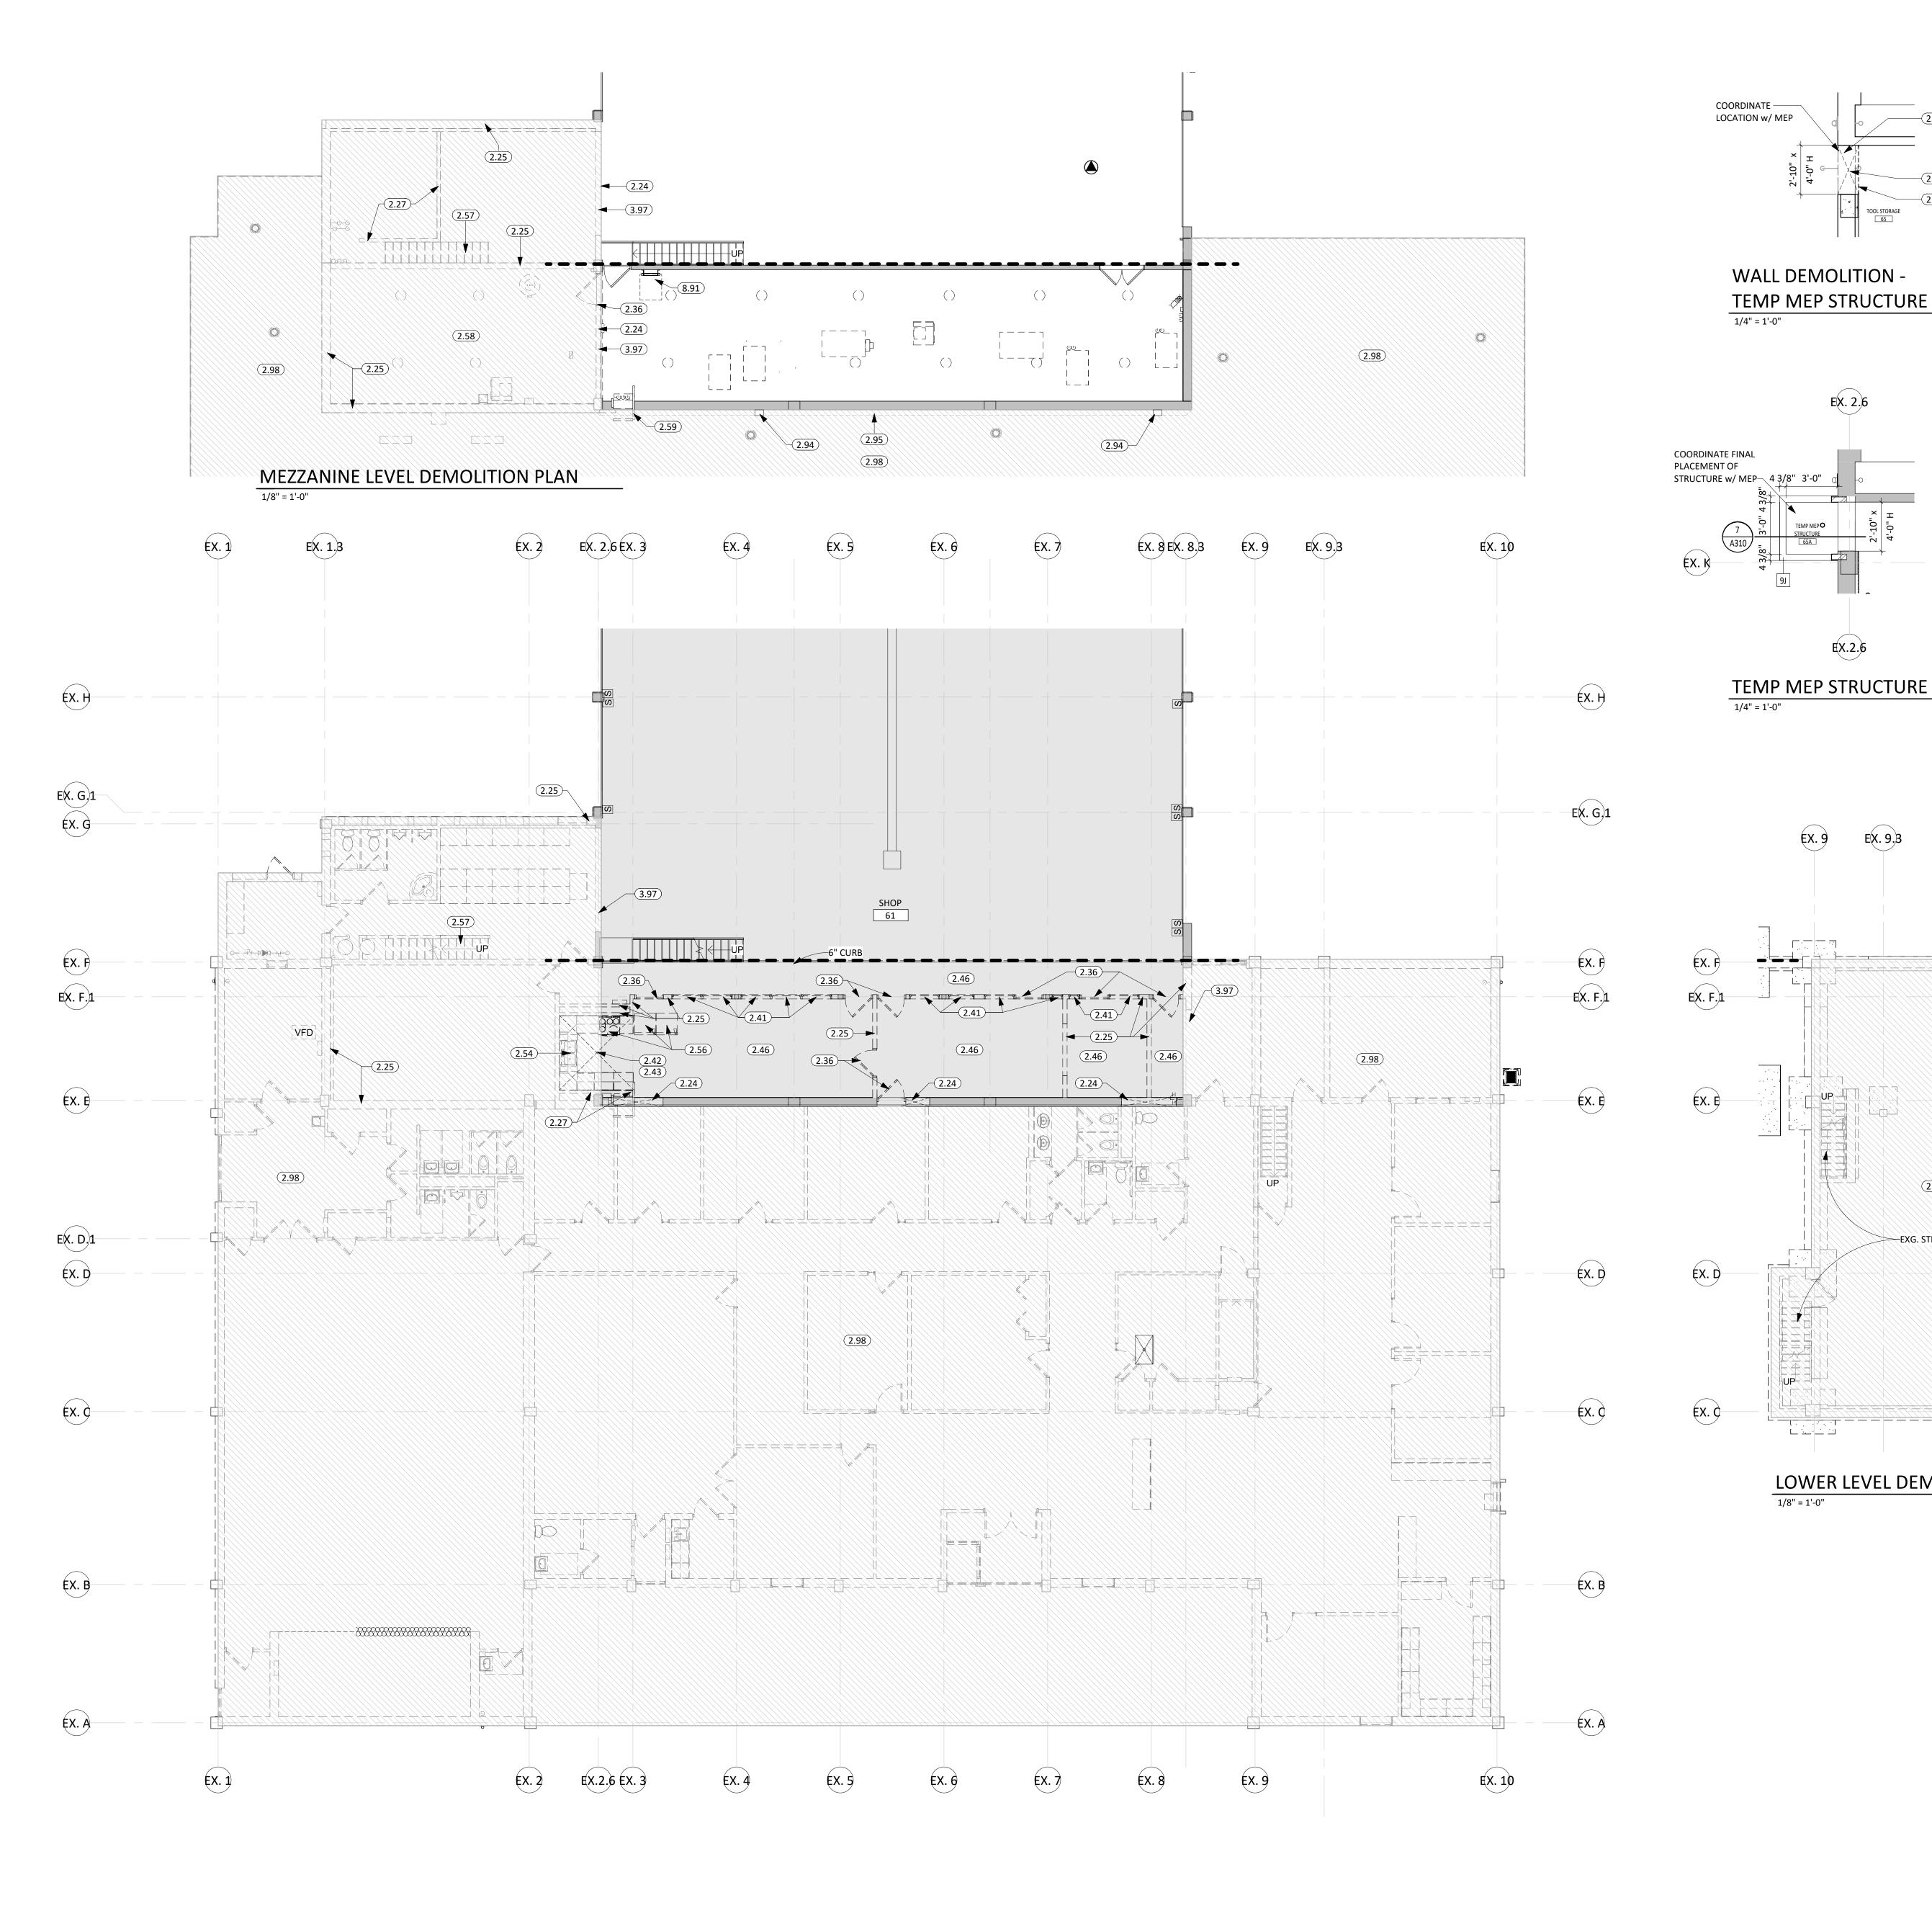

- CONTRACTOR IS RESPONSIBLE FOR ALL DEMOLITION NECESSARY TO ALLOW FOR COMPLETION OF THE WORK AS DESCRIBED IN THE CONSTRUCTION DOCUMENTS. DEMOLITION SHALL INCLUDE ALL ITEMS KEYNOTED HERE, BUT ARE NOT LIMITED TO THESE ITEMS. COORDINATE DEMOLITION DURING OFFICE HOURS WITH OWNER AS NECESSARY. DASHED LINES INDICATE ITEMS TO BE DEMOLISHED, AND ALL SHADED WALLS REPRESENT
- EXISTING WALLS TO REMAIN. GENERAL CONTRACTOR TO FIELD VERIFY ALL DIMENSIONS, & COORDINATE SCOPE OF
- DEMOLITION WITH EACH DISCIPLINE.
- DEMOLITION OF WALLS INCLUDES ALL ITEMS ATTACHED TO THE WALL, UNLESS NOTED TO BE
- ALL ITEMS MOUNTED TO THE WALLS IN EXISTING ARE TO BE REMOVED AND PROTECTED FOR REINSTALLATION.
- REFER TO DRAWING SHEET A401 & MECHANICAL DRAWINGS FOR ADDITIONAL NOTES REGARDING ROOF DEMOLITION ITEMS. CONTRACTOR TO PROTECT EXISTING MATERIALS AND SPACES WHICH ARE TO REMAIN OR BE
- REUSED. ALL SURFACES DAMAGED DURING DEMOLITION SHALL BE REPAIRED FOR APPLICATION OF NEW FINISHES OR REPAIRED/PATCHED TO MATCH EXISTING. ALL INDEPENDENT TRADES ARE RESPONSIBLE FOR THEIR OWN PATCHING.
- CONTACT ARCHITECT WITH ANY DISCREPANCIES. SEE CIVIL, MECHANICAL, AND ELECTRICAL DRAWINGS FOR ADDITIONAL INFORMATION RELEVANT TO DEMOLITION & PATCHING.
- 0. COORDINATE WITH OWNER AND DEMO ITEMS TO BE SALVAGED FOR THE OWNERS REUSE. 1. IN ACCORDANCE WITH STATE REGULATIONS, ALL PUBLIC AND COMMERCIAL BUILDINGS, REGARDLESS OF AGE OR CONSTRUCTOIN TYPE, MUST BE INSPECTED FOR ASBESTOS BEFORE ANY RENOVATION OR DEMOLITION BEGINS. THE CONTRACTOR SHALL CONTACT THE SD DANR AND COMPLY WITH APPLICABLE ASBESTOS GUIDELINES IMMEDIATELY AFTER RECEIPT OF
- NOTICE TO PROCEED. CONTACT SD DANR AT 605-773-3153 OR REFERENCE SDDANR ASBESTOS INFORMATION BROCHURE TO REVIEW GUIDELINES AND REQUIREMENTS.


EX. 2.6

EX.2.6

LOWER LEVEL DEMOLITION PLAN

1/8" = 1'-0"

	KEYNOTE SCHEDULE
2.24	REMOVE PORTION OF MASONRY WALL - PATCH HEAD, JAMBS, & SILL IF APPLICABLE
2.25	REMOVE MASONRY WALL
2.27	REMOVE STUD FRAMED WALL
2.36	REMOVE DOOR & H.M. FRAME
2.41	REMOVE WINDOW UNIT
2.42	REMOVE BASE CABINET
2.43	REMOVE WALL CABINET
2.46	REMOVE CARPET (INCLUDING ALL ADHESIVES)
2.54	REMOVE SINK
2.56	REMOVE EXISTING APPLIANCES. COORDINATE WITH OWNER FOR SALVAGABLE ITEMS (TYP)
2.57	REMOVE WOOD STAIRS
2.58	REMOVE PRECAST CONCRETE FLOOR & CONCRETE TOPPING
2.59	REMOVE EXISTING ROOF ACCESS LADDER
2.94	REMOVE EXISTING SCUPPER, CONDUCTOR HEAD, AND DOWNSPOUT IN PREPARATION FOR NEW WALL
2.95	REMOVE PORTION OF METAL PANEL
2.96	REMOVE PORTION OF MASONRY WALL & SPRAY FOAM COATING FOR TEMPORARY ENCLOSURE
2.97	REMOVE EXISTING PLYWOOD SHEATHING FROM WALL & REINSTALL AFTER WORL IS COMPLETED.
2.98	REMOVE SINGLE STORY MASONRY BUILING IN IT'S ENTIRETY
2.99	REMOVE BASEMENT IN IT'S ENTIRETY AND INFILL
3.97	EXISTING PRECAST STRUCTURAL BEAM TO REMAIN (SEE STRUCTURAL PLANS)
8.91	EXISTING ROOF ACCESS HATCH & LADDER

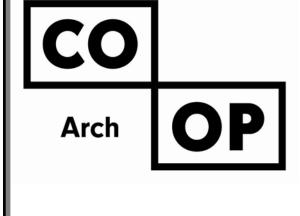

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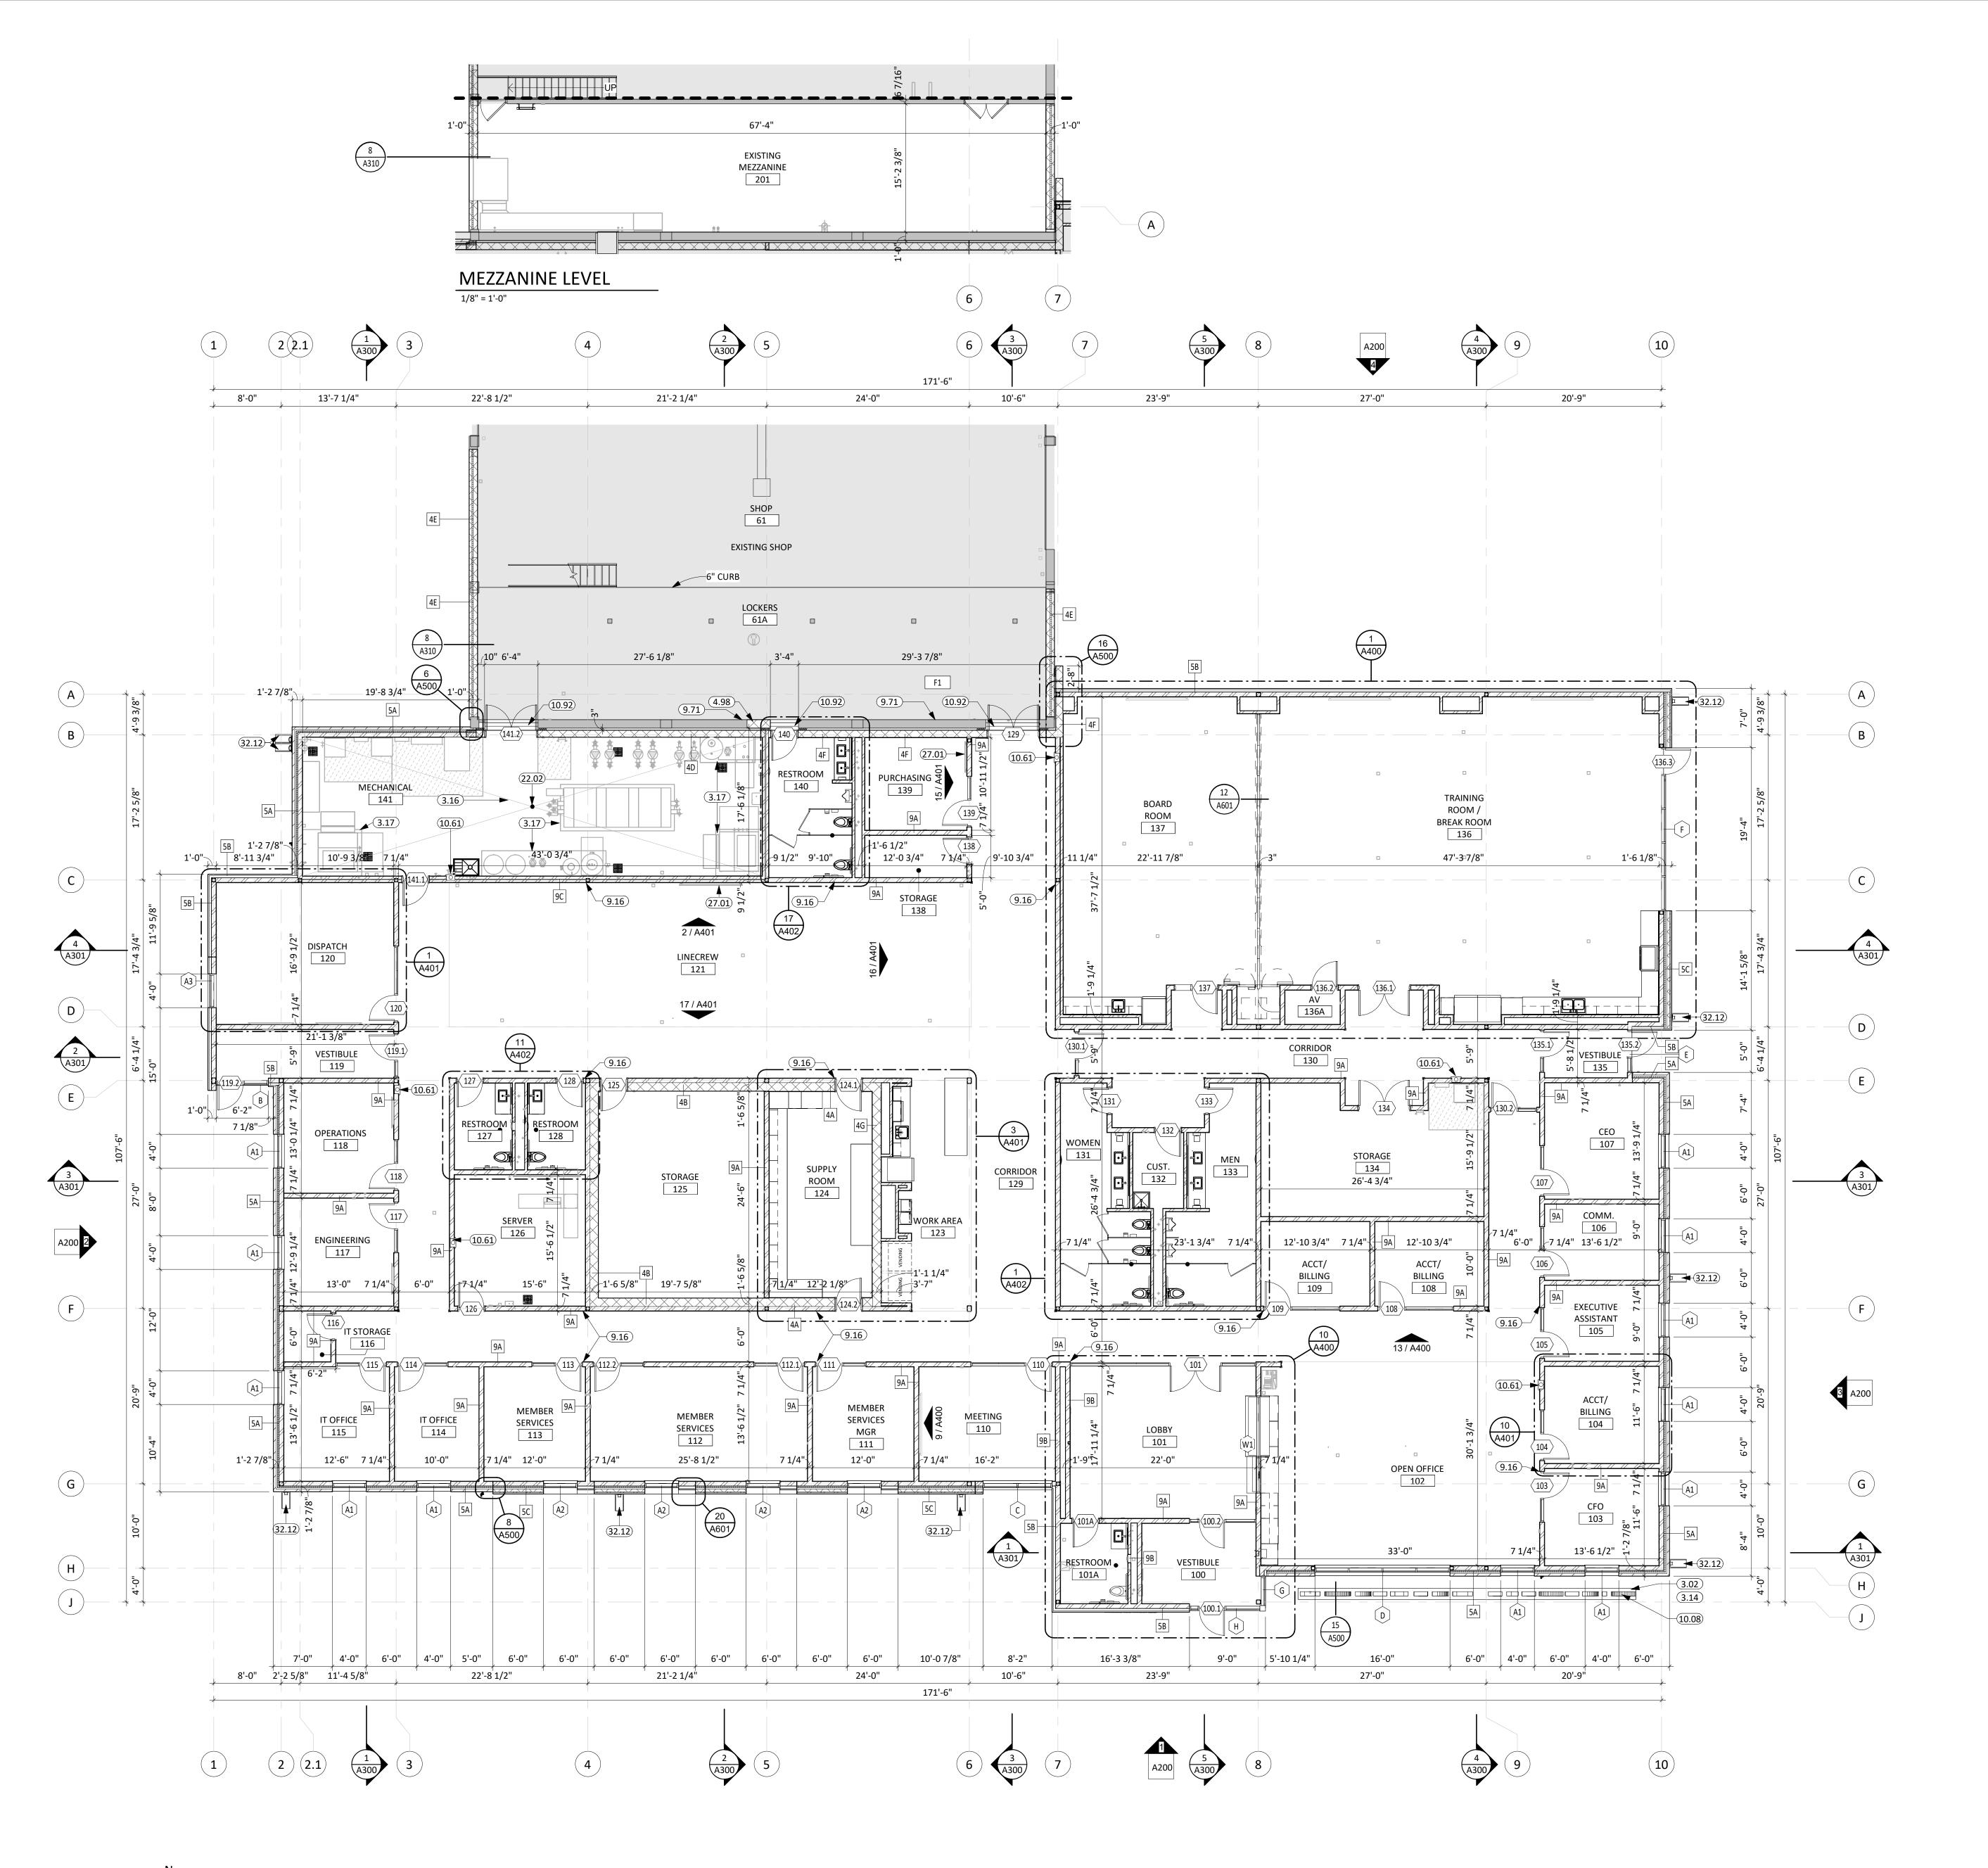
Sioux Falls, SD 57103

CO-OP PROJECT NO:

5/15/2025 100% CONSTRUCTION DOCUMENTS **REVISION SCHEDULE:**

PROJECT: NORTHERN ELECTRIC NORTHERN ELECTRIC COOPERATIVE BATH, SOUTH DAKOTA

SHEET TITLE: OVERALL DEMOLITION FLOOR



- FIRE RATED WALL ARE INDICATED ON THE CODE PLANS. SQUARE FOOTAGES LISTED ARE FOR CODE REVIEW PURPOSES ONLY AND SHOULD NOT BE USED FOR ANY OTHER PURPOSES. PROVIDE FIRE EXTINGUISHERS AND CABINETS AS SHOWN ON THE CODE PLAN(S). CONTRACTOR TO VERIFY ALL EXISTING CONDITIONS, ELEVATIONS AND DIMENSIONS.
- ALL WORK SHALL BE IN ACCORDANCE WITH OSHA CODES AND STANDARDS. NOTHING INDICATED ON THESE DRAWINGS SHALL RELIEVE THE CONTRACTOR FROM COMPLYING WITH ANY APPROPORIATE SAFETY REGULATIONS.
- THE CONTRACTOR SHALL CONSTRUCT ALL ITEMS WITHIN THIS CONTRACT IN ACCORDANCE
- WITH THE STATE AND LOCAL REGULATIONS AND CODES. REFER TO SHEET <u>**G001</u>** FOR ADA STANDARDS.</u>
- INTERIOR DIMENSIONS ARE FROM FACE OF GWB/CMU TO FACE OF GWB/CMU UNLESS


REFER TO SHEET <u>G001</u> FOR WALL, ROOF, AND FLOOR TYPES.

MAXIMUM SLOPE OF 1/4" PER FOOT.

- ALL WALLS TO BE TYPE 9A, AND ALL WALL TYPES TO EXTEND TO DECK UNLESS OTHERWISE NOTED ON PLANS.
- 0. EXTERIOR DIMENSIONS ARE FROM FACE OF BRICK/SHEATHING UNLESS OTHERWISE NOTED. 1. COORDINATE WORK DONE BY OTHERS AS INDICATED ON THE DRAWINGS. 2. INCREASE WALL THICKNESS OF METAL STUD AND CONCRETE BLOCK WALLS AS REQUIRED TO ACCOMODATE MECHANICAL AND ELECTRICAL DEVICES - VERIFY w/ ARCHITECT PRIOR TO
- 3. SEE MECHANICAL FOR ALL FLOOR DRAIN SIZES AND LOCATIONS U.N.O. SET FLOOR DRAINS MINIMUM ¾" BELOW FINISHED FLOOR. PROVIDE EVEN SLOPE FROM WALL TO DRAIN W/ A
- 4. VERIFY DRYWALL CONTROL JOINT LOCATIONS w/ ARCHITECT ON SITE PRIOR TO INSTALLATION. THIS INCLUDES, BUT IS NOT LIMITED TO, CONTROL JOINTS AT 30'-0" O.C. MAX. IN LONG WALL EXPANSES. CONTROL JOINTS AT DOOR JAMBS EXTENDING FROM DOOR HEAD TO CEILING. CONSIDERATION SHALL ALSO BE GIVEN TO LOCATING CONTROL JOINTS FROM FLOOR TO
- CEILING AT EITHER EDGE OF LARGE WINDOW OPENINGS. 5. COORDINATE ALL CHASE SIZES AND LOCATIONS W/ MECHANICAL. PROVIDE CHASES AT ALL
- EXPOSED MECHANICAL & ELECTRICAL WITH ADJACENT WALL MATERIAL AS REQUIRED. .6. COORDINATE ALL SHEAR WALL LOCATIONS W/ STRUCTURAL PLANS. 7. THE AIR & MOISTURE WEATHER BARRIER IS TO BE CONTINUOUS FROM THE BASE OF THE

WALLS UP TO & TYING INTO THE ROOF BARRIER SYSTEM.


R REQ. W/
CT SIZE ANI PLANS)
INISH AFTE ATCH
RE WALL

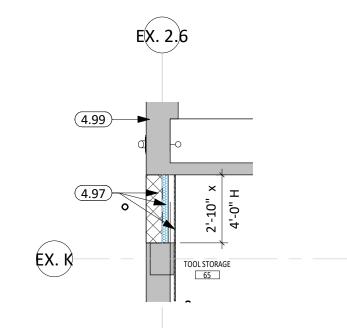

VIDEO DISPLAY UNIT, OFCI (SEE ELECTRICAL)

SPLASH BLOCK

TEMP MEP STRUCTURE PATCHING

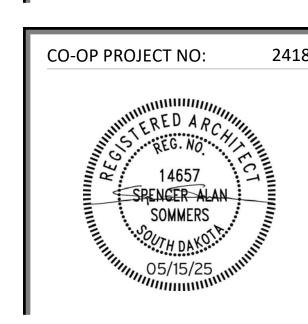

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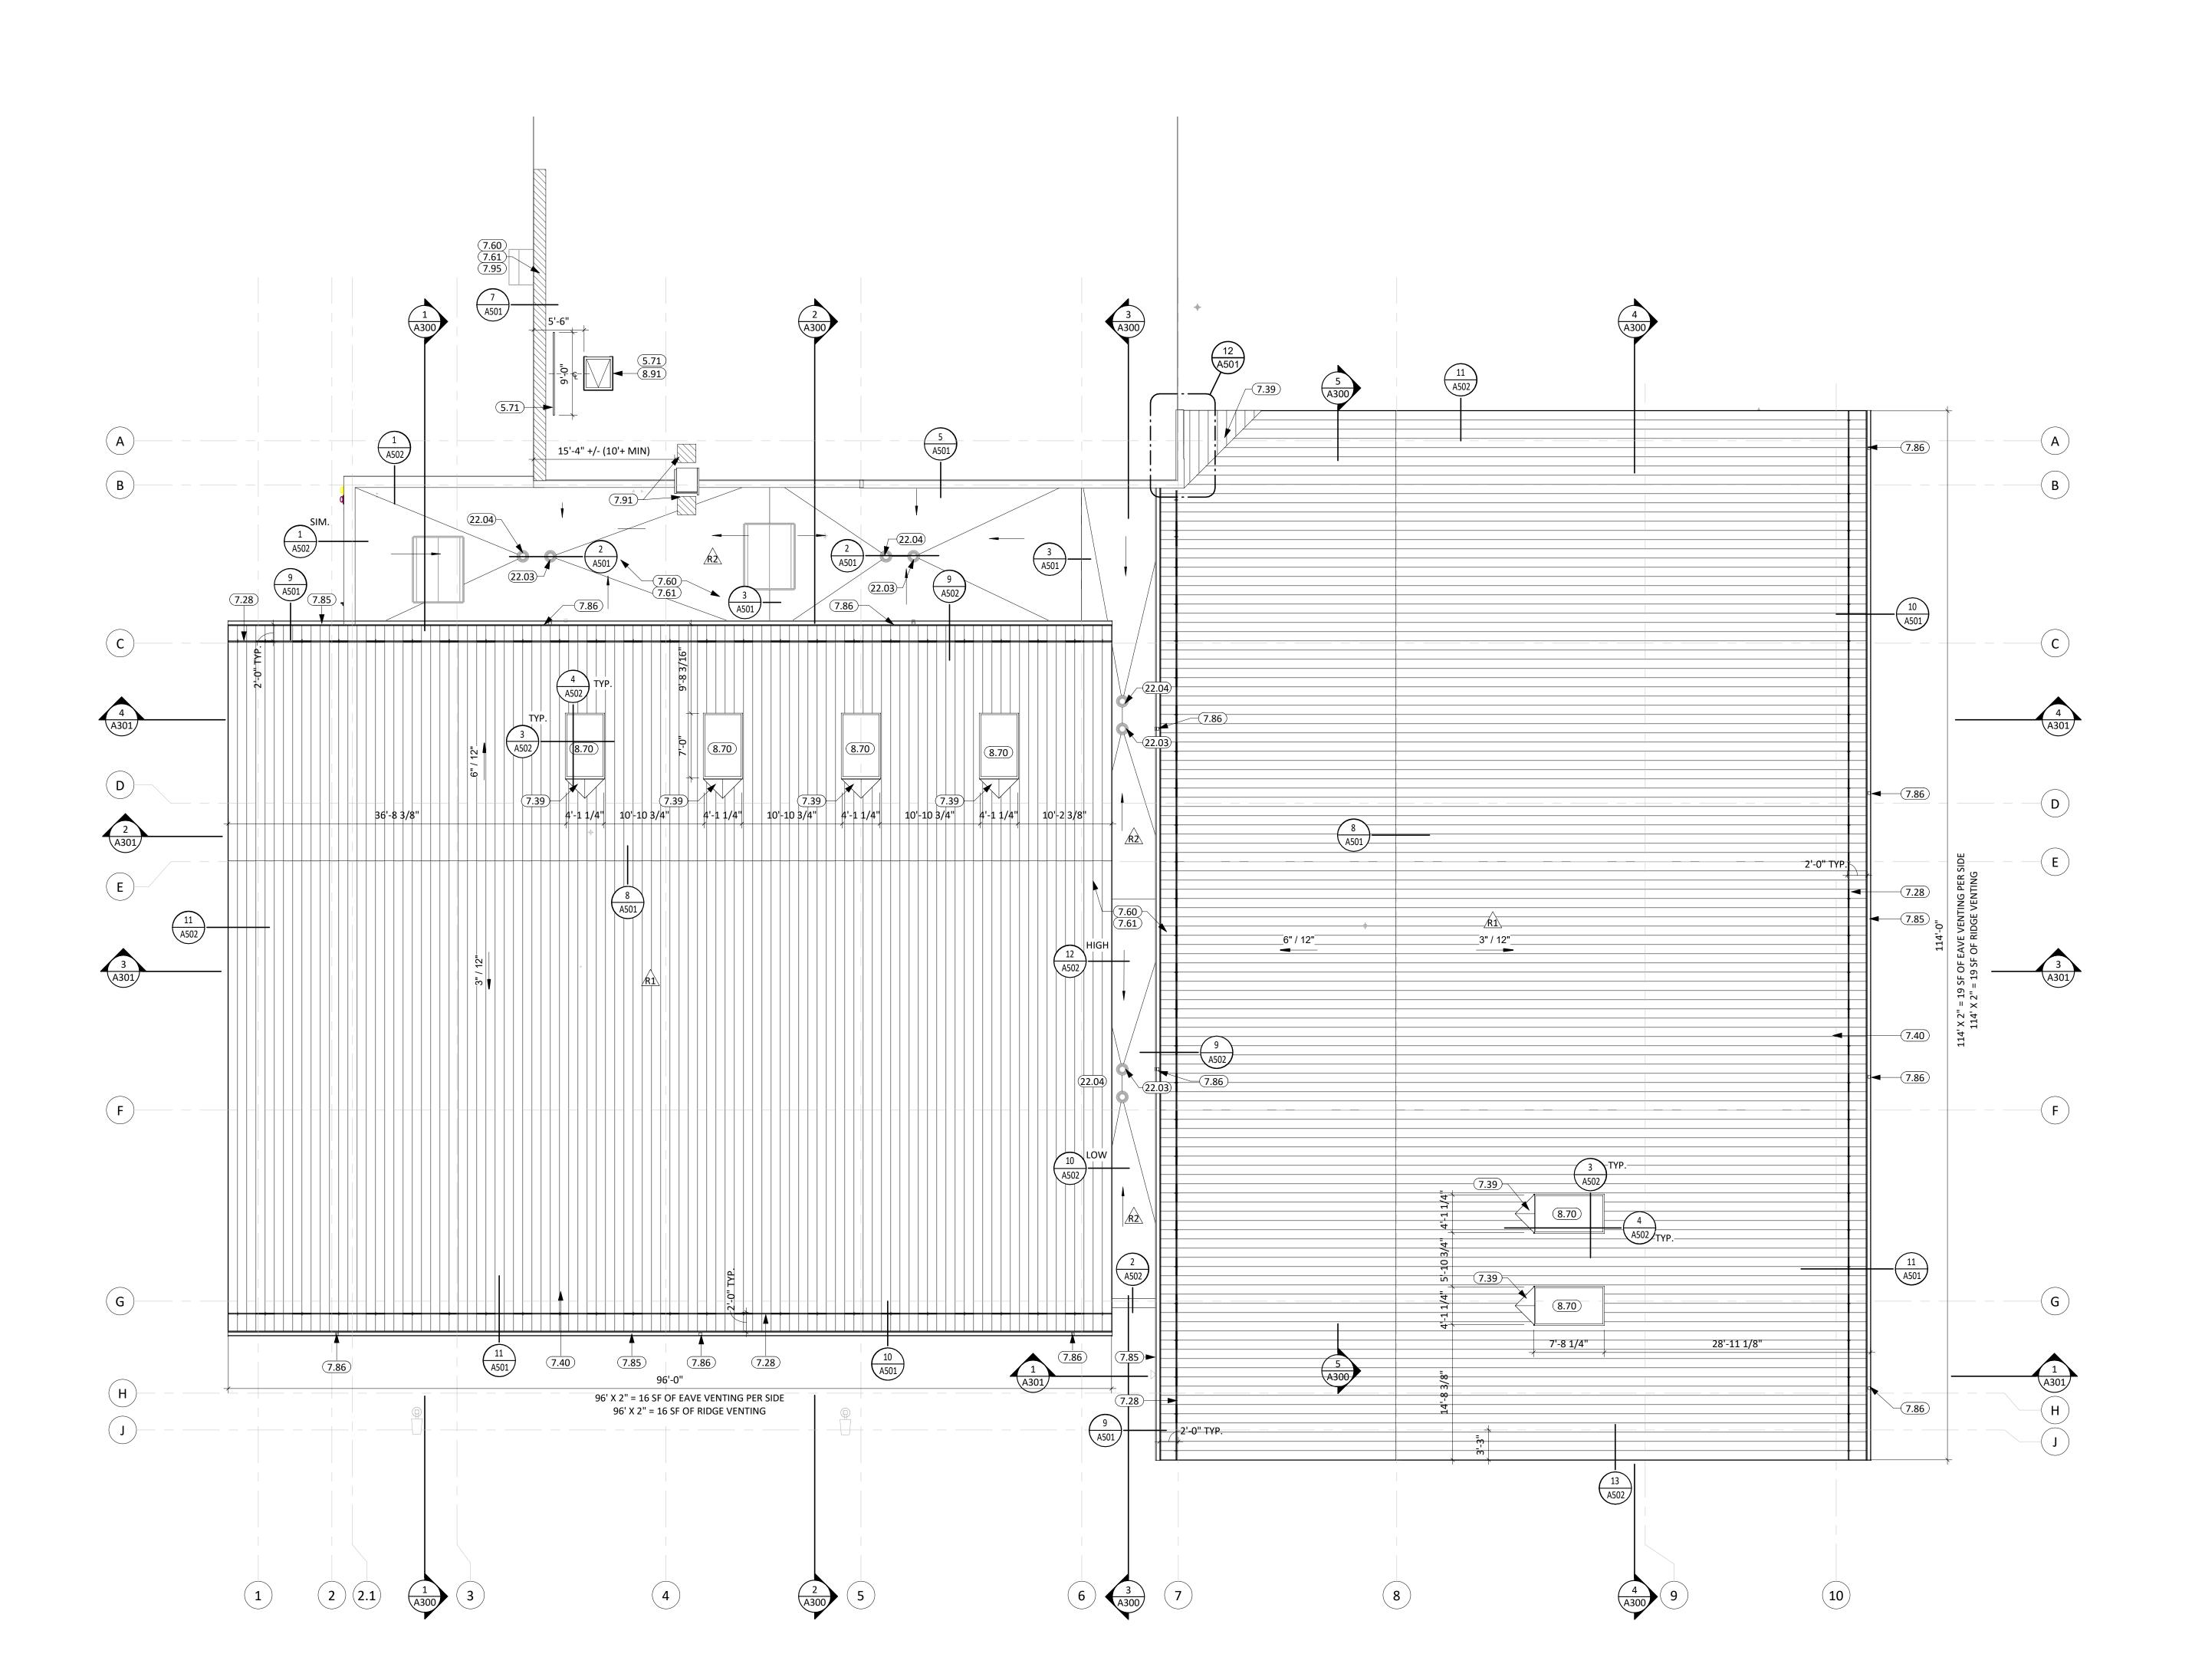
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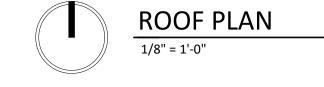
REV. # REV. DSC. REV. DATE

PROJECT: NORTHERN ELECTRIC NORTHERN ELECTRIC COOPERATIVE BATH, SOUTH DAKOTA

SHEET TITLE:

FIRST FLOOR PLAN





- SEE CIVIL, STRUCTURAL, MECHANICAL, AND ELECTRICAL FOR ADDITIONAL INFORMATION AND COORDINATION.
- ALL TAPERED ROOF SYSTEM SLOPES ARE 1/4" PER FOOT UNLESS OTHERWISE NOTED. ALL THRU ROOF PENETRATION BOOTS IN ROOF SYSTEM ARE TO BE PROVIDED. THE AIR & MOISTURE WEATHER BARRIER IS TO BE CONTINUOUS FROM THE BASE OF THE
- WALLS UP TO & TYING INTO THE ROOF BARRIER SYSTEM. COORDINATE ROOF PENETRATIONS WITH MECHANICAL, ELECTRICAL, AND PLUMBING
- CONTRACTORS. ALL ROOF SADDLES SHALL HAVE A MINIMUM OF 1/2" PER FOOT SLOPE. PROVIDE ROOF CURBS FOR ALL EQUIPMENT SCHEDULED TO BE ON THE ROOF. COORDINATE
- SIZE AND LOCATION WITH APPLICABLE TRADES. PROVIDE CRICKETS AT ALL ROOF TOP EQUIPEMENT & SKYLIGHT UNITS TO ALLOW FOR
- UNIMPEDED WATER FLOW. DIMENSIONS AND LOCATIONS OF EQUIPMENT ON THE ROOF ARE APPROX., DO NOT SCALE THE
- DRAWINGS. VERIFY WITH APPLICABLE TRADES. 0. TAPERED INSULATION SHALL HAVE A MINIMUM OF 1/4" PER FOOT SLOPE. PROVIDE TAPERED INSULATION AS REQUIRED TO ACHIEVE 1/4" PER FOOT SLOPE.
- 1. PROVIDE R-30 MINIMUM ROOF INSULATION AT ROOF DRAINS. 2. PROVIDE ROOF WALKING PADS AS SHOWN.

KEYNOTE SCHEDULE
ROUND STEEL GUARDRAIL SECTION (SEE ARCH. & STRUCT.)
STANDING SEAM ICE & SNOW GUARDS (SEE PROJECT MANUAL)
STANDING SEAM ROOF CRICKET W/ MATCHING VALLEY FLASHING
STANDING SEAM METAL ROOFING
FULLY ADHERED EPDM SINGLE MEMBRANE ROOF (WRAP PARAPET WHERE OCCURS)
POLYISOCYANURATE INSULATION SYSTEM (R-40 MIN.)
PRE-FINSIHED METAL GUTTER & EAVE TRIM (W/ ALL REQ'D FLASHING & SUPPORTS).
PRE-FINISHED METAL DOWNSPOUTS (W/ ALL REQ'D FLASHING & SUPPORTS). PROVIDE SPLASH PAD AT EACH DOWNSPOUT THAT RETURNS TO GRADE.
WALK WAY PAD
WORK TO BE DONE TO MATCH EXISTING CONDITIONS. MAINTAIN EXISTING WARRANTY.
SKYLIGHT UNIT


ATTIC VENTILATION REQUIREMENTS

EXISTING ROOF ACCESS HATCH & LADDER

ROOF DRAIN

OVERFLOW ROOF DRAIN

Ī		VENTING CALCULA	TION PER IBC 1202.2.1	
	WEST ROOF		EAST ROOF	
	ATTIC AREA =	5,685 SF	ATTIC AREA =	9,205 SF
	REQ. VENTING	= 5,685 / 300 = 18.95	REQ. VENTING =	9,205 / 300 = 30.68
	HIGH VENT =	9.5 SF REQUIRED	HIGH VENT =	15.5 SF REQUIRED
	LOW VENT =	9.5 SF REQUIRED	LOW VENT =	15.5 SF REQUIRED
	HIGH VENT =	12 SF PROVIDED	HIGH VENT =	19 SF PROVIDED
	LOW VENT =	32 SF PROVIDED	LOW VENT =	38 SF PROVIDED

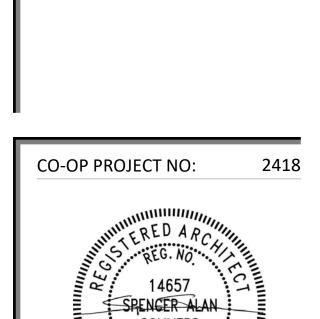

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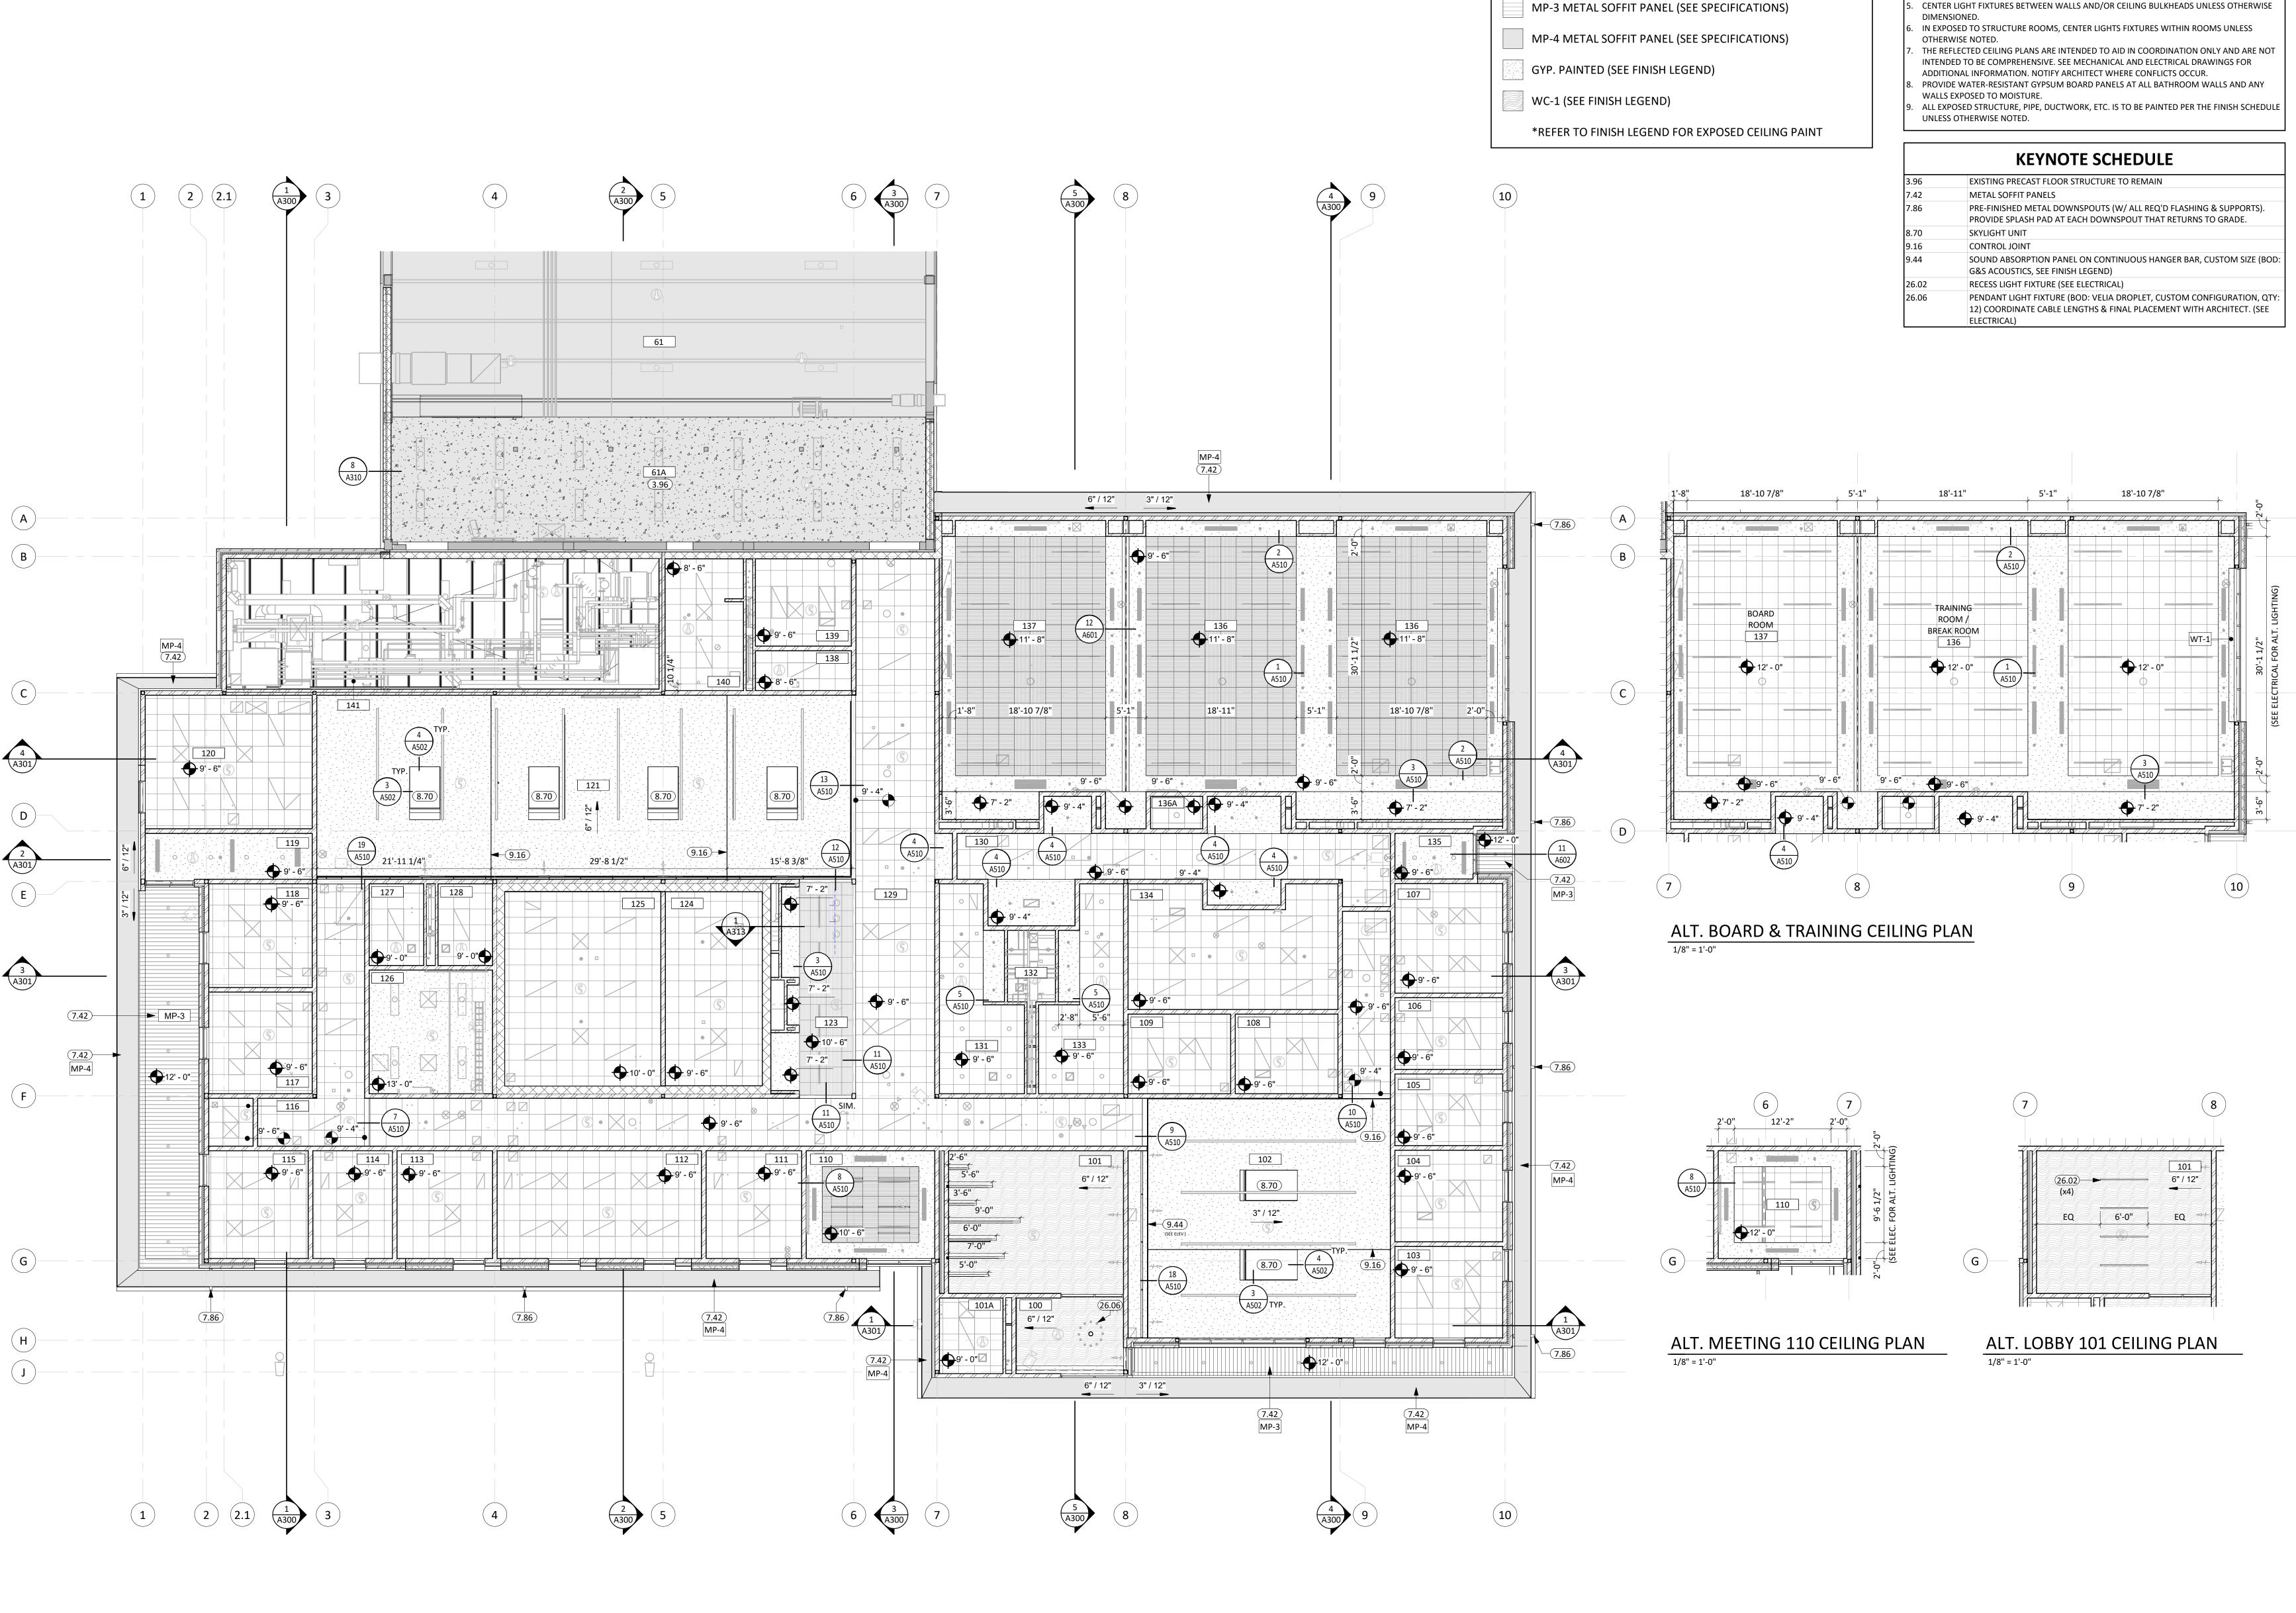
5/15/2025 100% CONSTRUCTION DOCUMENTS

REVISION SCHEDULE:

PROJECT: NORTHERN ELECTRIC NORTHERN ELECTRIC COOPERATIVE BATH, SOUTH DAKOTA

SHEET TITLE:

ROOF PLAN



PROVIDE ACCESS DOORS AT MECHANICAL UNIT LOCATIONS ABOVE CEILING. COORDINATE CENTER CEILING GRID IN AREAS SUCH THAT THERE WILL BE NO CEILING TILE LESS THAN 6" IN

GENERAL NOTES

ALL DIMENSIONS ARE FROM FACE OF FINISH MATERIAL UNLESS OTHERWISE NOTED.

REFER TO SPECIFICATIONS FOR CEILING AND FIXTURE SUSPENSION REQUIREMENTS.

NUMBER REQUIRED AND LOCATIONS WITH MECHANICAL SHEETS.

THE SMALLEST DIMENSION, UNLESS OTHERWISE NOTED.

CEILING LEGEND

ACT-1 (SEE FINISH LEGEND)

ACT-2 (SEE FINISH LEGEND)

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5/15/2025 100% CONSTRUCTION DOCUMENTS **REVISION SCHEDULE:**

PROJECT: NORTHERN ELECTRIC NORTHERN ELECTRIC COOPERATIVE BATH, SOUTH DAKOTA

SHEET TITLE:

REFLECTED CEILING PLANS

FIRST LEVEL REFLECTED CEILING PLAN





- REFER TO SHEET <u>A125</u> FOR ROOM FINISH SCHEDULE AND LEGEND.
- INTERIOR WALLS FINISHES ARE FULL HEIGHT, UNLESS OTHERWISE NOTED. PROVIDE WATER-RESISTANT GYPSUM BOARD PANELS AT ALL BATHROOM WALLS AND ANY
- WALLS EXPOSED TO MOISTURE.
- . SEE FLOOR PLAN(S) AND INTERIOR ELEVATIONS FOR CASEWORK INFORMATION. FIELD VERIFY DIMENSIONS OF CASEWORK OPENINGS.
- . FINISH FLOORS TO EXTEND UNDER ALL CASEWORK.
- . USE SCHLUTER DITRA UNDERLAYMENT UNDER ALL FLOOR TILE.
- . ALL WALLS TO BE P-1 AND RECIEVE VB-1, U.N.O. . ALL EXPOSED STRUCTURE AND BEAMS TO BE PAINTED P-3. U.N.O.

FINISH LEGEND

————— INDICATES WALL TILE PT-2

----- INDICATES WALL TILE PT-3

•••••• INDICATES WALL TILE PT-4

— — INDICATES WALL COVERING

----- INDICATES ACCENT PAINT

*REFER TO ELEVATIONS, FINISH SCHEDULE AND LEGEND FOR TYPES, DIMENSIONS AND ADDITIONAL DETAILS.

KEYNOTE SCHEDULE

CORNER GUARDS

MANUAL ROLLER WINDOW SHADES

AUTOMATED ROLLER WINDOW SHADES (SEE ELECTRICAL)


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5/15/2025 100% CONSTRUCTION DOCUMENTS

REVISION SCHEDULE:

PROJECT: NORTHERN ELECTRIC NORTHERN ELECTRIC COOPERATIVE

BATH, SOUTH DAKOTA

SHEET TITLE:

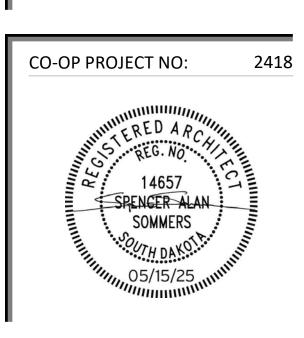FINISH PLANS

		POO!	/ EINIICI	ח ככחבטווו		
		T	T	H SCHEDUL	Ti .	
RM#	NAME	FLR FIN.	BASE FIN.	WALL FIN.	CLG FIN.	NOTES
100	VESTIBULE	WOC-1	VB-1	P-1	WC-1	
101	LOBBY	SC-1	VB-2	P-1 / WC-1	WC-1	
101A	RESTROOM	PT-1	TB-1	P-1 / PT-2	ACT-1	
102	OPEN OFFICE	CPT-1	VB-2	P-1 / P-2	P-4	
103	CFO	CPT-2	VB-1	P-1	ACT-1	
104	ACCT/ BILLING	CPT-2	VB-1	P-1	ACT-1	
105	EXECUTIVE ASSISTANT	CPT-2	VB-1	P-1	ACT-1	
106	COMM.	CPT-2	VB-1	P-1	ACT-1	
107	CEO	CPT-2	VB-1	P-1	ACT-1	
108	ACCT/ BILLING	CPT-2	VB-1	P-1	ACT-1	
109	ACCT/ BILLING	CPT-2	VB-1	P-1	ACT-1	
110	MEETING	CPT-1	VB-2	P-1 / P-2	ACT-2	
111	MEMBER SERVICES MGR	CPT-2	VB-1	P-1	ACT-1	
112	MEMBER SERVICES	CPT-2	VB-1	P-1	ACT-1	
113	MEMBER SERVICES	CPT-2	VB-1	P-1	ACT-1	
114	IT OFFICE	CPT-2	VB-1	P-1	ACT-1	
115	IT OFFICE	CPT-2	VB-1	P-1	ACT-1	
116	IT STORAGE	SC-1	VB-1	P-1	ACT-1	
117	ENGINEERING	CPT-2	VB-1	P-1	ACT-1	
118	OPERATIONS	CPT-2	VB-1	P-1	ACT-1	
119	VESTIBULE	WOC-1	VB-1	P-1	P-4	
120	DISPATCH	CPT-1	VB-1	P-1	ACT-1	
121	LINECREW	SC-1	VB-1	P-1 / P-2 / P-3	P-4	
123	WORK AREA	LVP-1	VB-1	P-1 / PT-3	ACT-2	
124	SUPPLY ROOM	CPT-1	VB-1	P-1	ACT-1	
125	STORAGE	SC-1	VB-1	P-1	ACT-1	
126	SERVER	SC-2	VB-1	P-1	P-4	
127	RESTROOM	PT-1	TB-1	P-1 / PT-2	ACT-1	
128	RESTROOM	PT-1	TB-1	P-1 / PT-2	ACT-1	
129	CORRIDOR	SC-1	VB-1	P-1 / WC-2	ACT-1	
130	CORRIDOR	SC-1	VB-1	P-1	ACT-1	
131	WOMEN	PT-1	TB-1	P-1 / PT-2 / PT-3	ACT-1	
132	CUST.	SC-1	VB-1	P-1	P-5	
133	MEN	PT-1	TB-1	P-1 / PT-2 / PT-3	ACT-1	
134	STORAGE	SC-1	VB-1	P-1	ACT-1	
135	VESTIBULE	WOC-1	VB-1	P-1	P-4	
136	TRAINING ROOM / BREAK ROOM	CPT-3 / LVP-1	VB-2	P-1 / PT-4	ACT-2 / P-4	
136A	AV	LVP-1	VB-1	P-1	ACT-1	
137	BOARD ROOM	CPT-3 / LVP-1	VB-2	P-1 / PT-4	ACT-2 / P-4	
138	STORAGE	SC-1	VB-1	P-1	ACT-1	
139	PURCHASING	CPT-2	VB-1	P-1	ACT-1	
140	RESTROOM	PT-1	TB-1	P-1 / PT-2	ACT-1	
141	MECHANICAL	SC-1	VB-1	P-1	P-5	

6.14

TYP. 5 DRAWER BASE CABINET

MICROWAVE CASEWORK

1" = 1'-0"

6.15

9.19

6.14

TYP. CABINET DETAILS


1" = 1'-0"

					F	INISH LEGEND			
TYPE	MARK	SPEC DIV.	MANUFACTURER	STYLE	COLOR/ NUMBER	SIZE	INSTALL	REP CONTACT	NOTES
EILINGS									
ACOUSTICAL	ACT-1	095100	USG	MARS FINELINE BEVEL	86985	24" X 24"	T - GRID	ANNA.GRIMES@GOLDENCVALLEYSUPPLY.COM	TYPICAL
CEILING	ACT-2	095100	ACOUFELT	SOFTENUP RIDGE	MOCHA LENGO (WQ25)	24" X 24"	INSTALL WITH 15/16/" T-GRID (BLACK)		MEETING ROOMS TYPICAL
LOORING &			7.000.22						
LOOMING	CPT-1	096813	SHAWCONTRACT	VISUALIZE (5T666)	SAND (62111)	24" X 24"	1/4 TURN	JESSICA.DRISCOLL@SHAWCONTRACT.COM	OPEN OFFICE / MEETING
	CPT-2	096813	SHAWCONTRACT	BREATHE (5T669)	SAND (62111)	24" X 24"	1/4 TURN	JESSICA.DRISCOLL@SHAWCONTRACT.COM	TYP OFFICE
CARPET	CPT-3	096813	SHAWCONTRACT	DAYDREAMER (5T593)	PEPTALK (93760)	24" X 24"	1/4 TURN	JESSICA.DRISCOLL@SHAWCONTRACT.COM	BOARD ROOM
	WOC-1	096813	SHAWCONTRACT	DIVVY TILE (5T411)	TRAVERSE (12557)	24" X 24"	1/4 TURN	JESSICA.DRISCOLL@SHAWCONTRACT.COM	WALK OFF TILE
VINYL	LVP-1	096500	SHAWCONTRACT	BRANCHING OUT - CORETEC 12MIL (4308V)	FOREST WALNUT (56703)	7" X 48"	STAGGER GLUE DOWN	JESSICA.DRISCOLL@SHAWCONTRACT.COM	
	PT-1	093000	DALTILE	CHORD	BARITONE BROWN (CH24) MATTE	24" X 24"		KATIE.WHEELER@DALTILE.COM	TYP BATHROOM FLOOR
CERAMIC &	PT-2	093000	DALTILE	CHORD	SONATA WHITE (CH20) MATTE	24" X 48"	1/3 OFFSET	KATIE.WHEELER@DALTILE.COM	TYP BATHROOM WALL
PORCELAIN	PT-3	093000	DALTILE	CHORD	SONATA WHITE (CH20) MATTE	3" TRIANGLE MOSAIC	•	KATIE.WHEELER@DALTILE.COM	TYP BATHROOM SINK WALL / WORK AREA SINK WAL
	PT-4	093000	WALKER ZANGER	BERA&BEREN SAW TEXTURED	LIGHT GREY	12" X 36" SHEET	STRAIGHT STACK	NANCY.PEARSON@VIRGINIATILE.COM	BOARD ROOM
	SC-1	555555	PER CONTRACTOR	SEALED CONCRETE	POLISHED		3110 H3111 3171CK	Li moorie vinditii tileliooivi	SEALED
CONCRETE	SC-2		PER CONTRACTOR	DISSAPATIVE	2				DISSAPATIVE SERVER ROOM
AINT & WA		RINGS							
TIVI & VVA		,	DENIA MARIA	1014/1/00/1477/170	CULVED CATTAL OF C		LICHT OBANGE BEEN AS ISSUED	CHARLECTECHONINARY	EFILD DAINT CUEDIMINATURE CO. CO. CO.
	P-1	099000	BENJAMMIN MOORE	LOW VOC LATEX EG-SHEL	SILVER SATIN 856		LIGHT ORANGE PEEL, LEVEL 4 FINISH.	CHARLES.J.SCHONHARDT@SHERWIN.COM	FEILD PAINT. SHERWIN WILLIAMS COLOR MATCH.
	P-2	099000	SHERWIN WILLIAMS	LOW VOC LATEX SATIN	KEYSTONE GRAY SW7504		LIGHT ORANGE PEEL, LEVEL & FINISH.	CHARLES J.SCHONHARDT@SHERWIN.COM	ACCENT PAINT.
	P-3 P-4	099000	BENJAMMIN MOORE	PRE-CAT EPOXY SATIN	SILVER SATIN 856		LIGHT ORANGE PEEL. LEVEL 5 FINISH.	CHARLES.J.SCHONHARDT@SHERWIN.COM	LINEMAN WALL. SHERWIN WILLAMS COLOR MATCH
PAINT	P-4	099000	SHERWIN WILLIAMS	LOW VOC LATEX FLAT	PURE WHITE SW7005			CHARLES.J.SCHONHARDT@SHERWIN.COM	GYP CEILINGS, U.N.O.
	P-5	099000	SHERWIN WILLIAMS	LATEX DRY FALL FLAT	KEYSTONE GRAY SW7504			CHARLES.J.SCHONHARDT@SHERWIN.COM	ALL EXPOSED DUCT WORK AND STRUCTURE IN MECHANICAL 141 & CUSTODIAN 132. CLEAN ALL DUC WORK PRIOR TO PAINTING.
	WC-1	097200	KOROSEAL	TIMBERLAND II	SADDIE T123-05			KCOATS@KOROSEAL.COM	WOOD LOOK - TO MATCH EXTERIOR LUX
ALL COVERING	WC-2	097200	KOROSEAL	DIGITAL PRINT	CUSTOM GRAPHIC			KCOATS@KOROSEAL.COM	BASE BID: COLLAGE GRAPHIC (SEE ALTERNATES, IF DEDUCT ACCEPTED: P-1)
TALL COVERING	WC-3	097200	COMBINED BUILDING SPECIALITIES	LEGACY PANEL - MAHARAM FABRIC	STANDARD FABRIC - STYLE AND COLOR TBD			TONY@COMBINEDBUILDING.COM	OPERABLE WALL FINISH
	SAP-1	098433	G&S ACOUSTICS	ACAPELLA FLUTES	FOG			ANNA.GRIMES@GOLDENCVALLEYSUPPLY.COM	BOARD / TRAINING ROOM ACOUSTIC PANELS
CDECLALIEN/	SAP-2	098433	G&S ACOUSTICS	PINTRA-PANELS	BRAINSTONE BRONZE SW7033			ANNA.GRIMES@GOLDENCVALLEYSUPPLY.COM	LINEMAN ACOUSTIC PANELS
SPECIALITY	WP-1	068316	CRANE COMPOSITES	GLASBORD	SMOOTH WHITE			JTOLLE@CRANECOMPOSITES.COM	MOP SINKS, USE WITH COORDINATED TRIMS
	CG-1	102613	INPRO	130 HIGH IMPACT	TBD				CORNER GAURDS
ALL BASE.	TRANSI	TIONS & MIS	C. TRIMS						
•	VB-1	096500	TARKETT	JOHNSONITE TV TOELESS	BLACK BROWN	4"		CLIFF.GUSTAFSON@TARKETT.COM	TYP BASE. 1/8"
VINYL BASE	VB-2	096500	TARKETT	LEDGE (MW-XX-X62)	BLACK BROWN	6"		CLIFF.GUSTAFSON@TARKETT.COM	LOBBY / BOARD + TRAINING / MEETING
TILE BASE	TB-1	093000	DALTILE	CHORD	BARITONE BROWN	6"	STRAIGHT	KATIE.WHEELER@DALTILE.COM	BATHROOM BASE
SCHLUTER	10 1	093000	SCHLUTER	MULTIPLE / VARIES	FINISH TBD	5	STIVATOTT	KKEENAN@SCHLUTER.COM	PROFILES REQ'D PER GENERAL TRANISITIONS LEGENI
IILLWORK		055000	SCHLOTER	WOLLII LE / VAINES	ם פון וועוטוו			INCLIA IN COURT	- HOLLES REQUEEN GENERAL HARMSHOUS LEGEN
LLVV ONK	DI _1	064100	FORMICA	PLANKED URBAN OAK 9312	NATURAL GRAIN			JILL.PELTIER@WURTHBSC.COM	BOARD ROOM / TRAINING / WORK AREA
LAMINATE	PL-1 PL-2	064100	FORMICA	ESPRESSO PEAR 5489	OILED WOOD			JILL.PELTIER@WURTHBSC.COM JILL.PELTIER@WURTHBSC.COM	OPEN OFFICE / LOBBY / SUPPLY ROOM / BATHROOM
TONE 2 22::-	rL-Z	004100	rukiviica	ESPNESSU PEAK 5489	OILED WOOD			JILL.FELTIER@WORTHBSC.COIVI	OF LIN OFFICE / LODDI / SUPPLI KUUIVI / BATHKUUIVI
TONE & SOLID SURFACE	SS-1	123661	CORIAN	SOLID SURFACE	LINEN			KIM@HLLMARK.COM	BOARD ROOM / TRAINING / WORK AREA
WOOD DOOR	WDD-1	081400	VT INDUSTRIES	WHITE MAPLE	STAINED TO MATCH PL-1				REFER TO DOOR SCHEDULE FOR DOOR TYPES, SIZES, SPECIFICATIONS
IISCELLANE	ous								
PARTITIONS	TP-1		SCRANTON HINY HIDERS	HINY HIDERS	TBD				
WINDOW	WT-1		LUTRON	MOTORIZED	BASKETWEAVE 27 1% - COLOR TBD				CONFIRM REMOTE LOCATION AND OPTIONS WITH OWNER
TREATMENTS	\				DAGUETIA/FAN/FATAA				O VVIIVE!!
	WT-2		LUTRON	MANUAL	BASKETWEAVE 27 1% - COLOR TBD				
WINDOW FILM	WF-1		LEVEL	FROSTED	CUSTOM TBD			MASSINA.BLOEMKE@NATIONALSOLUTIONS.COM	ALL OFFICE GLAZING, CUSTOM GRAPHIC TBD

1'-9"

TYP. SINGLE TALL CABINET

1" = 1'-0"

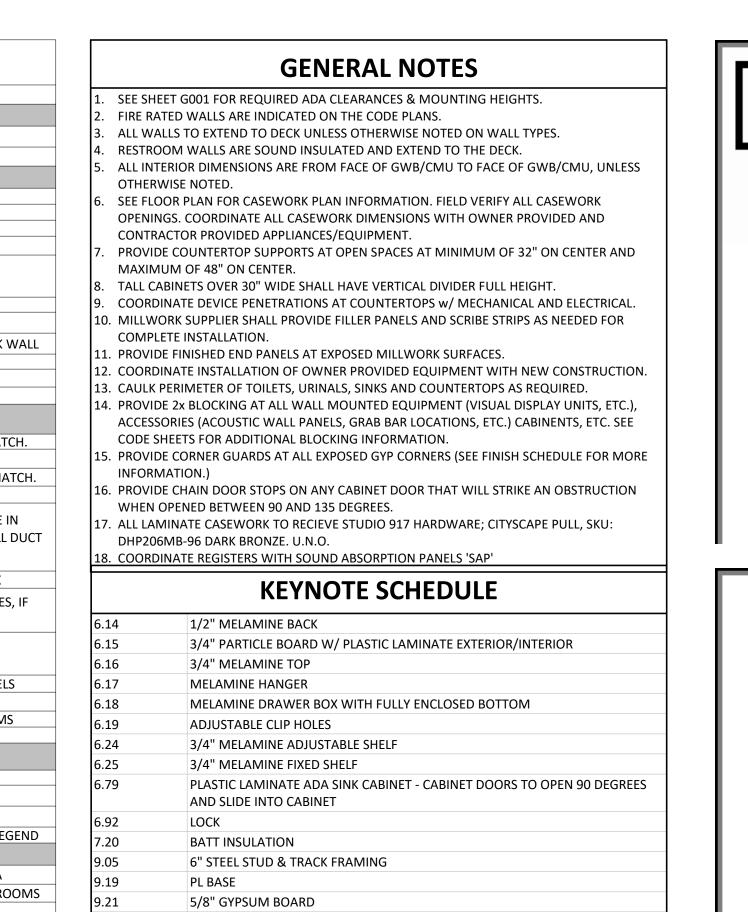

HEAVY DUTY COMMERCIAL GRADE SOFT CLOSE DRAWER HARDWARE

ENVELOPE DEPOSITORY UNIT (BASIS OF DESIGN: AMERICAN SECURITY


PL ON INTERIOR
CERAMIC TILE

LAVATORY

1'-4"


DROP BOX CASEWORK

CABINENTS, 24" STANDARD SLOT)

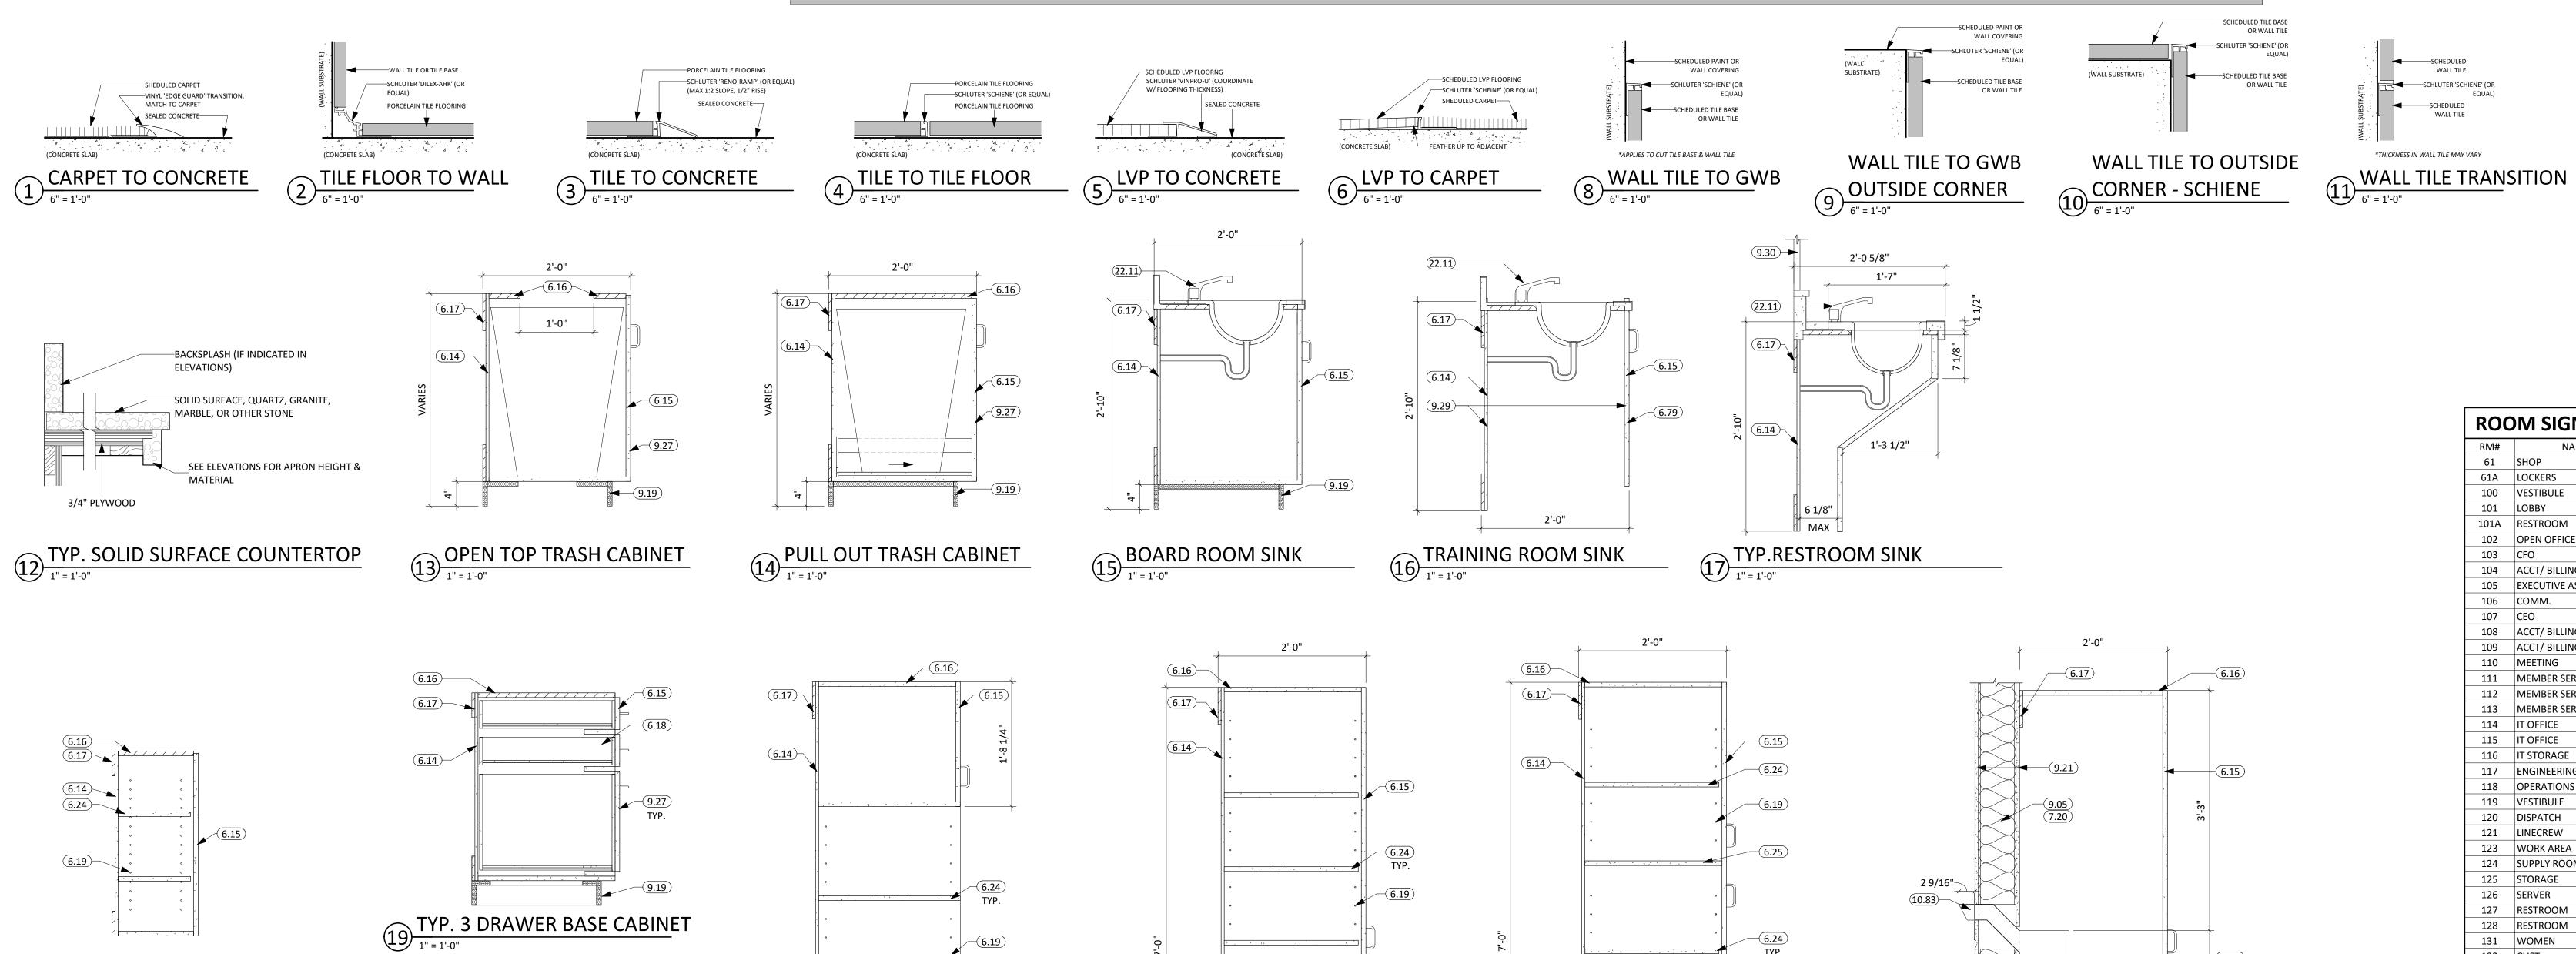


TYP. TALL CABINET

1" = 1'-0"

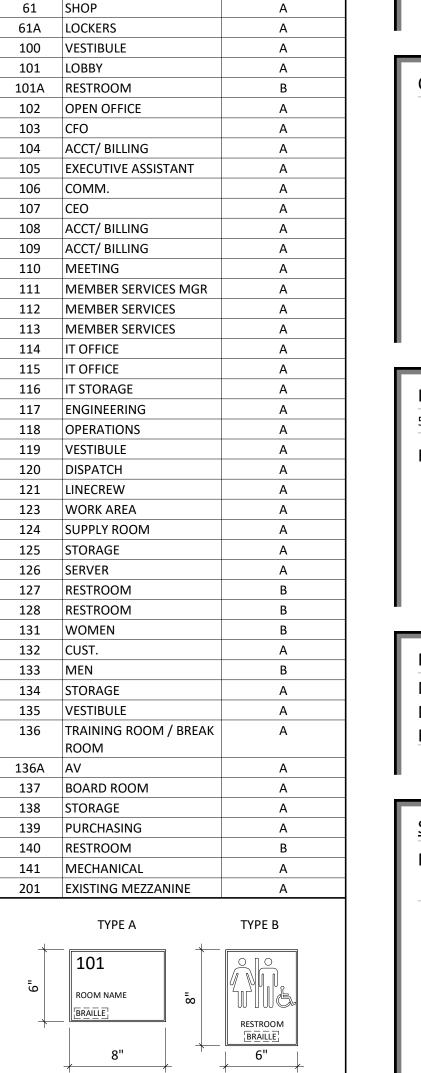

ROOM SIGNAGE SCHEDULE

SIGN TYPE

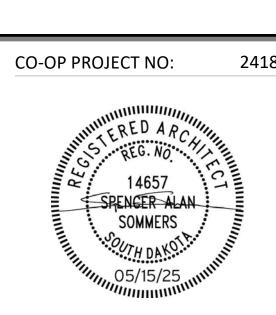

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Aberdeen, SD 57401

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440 E. 8th St. 221

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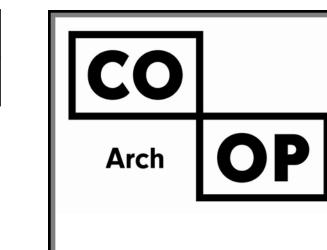
PROJECT:

NORTHERN ELECTRIC

NORTHERN ELECTRIC COOPERATIVE
BATH, SOUTH DAKOTA

SHEET TITLE:
FINISH SCHEDULE & LEGENDS

DRAWING SHEET A130 PROVIDED FOR REFERENCE ONLY.
ALL FURNITURE OWNER FURNISHED AND OWNER INSTALLED.





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600 Kansas City St. #1 Rapid City, SD 57701 Phone: 605-716-3652


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ENLARGED PLAN - BOARD & TRAINING -



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PROJECT:

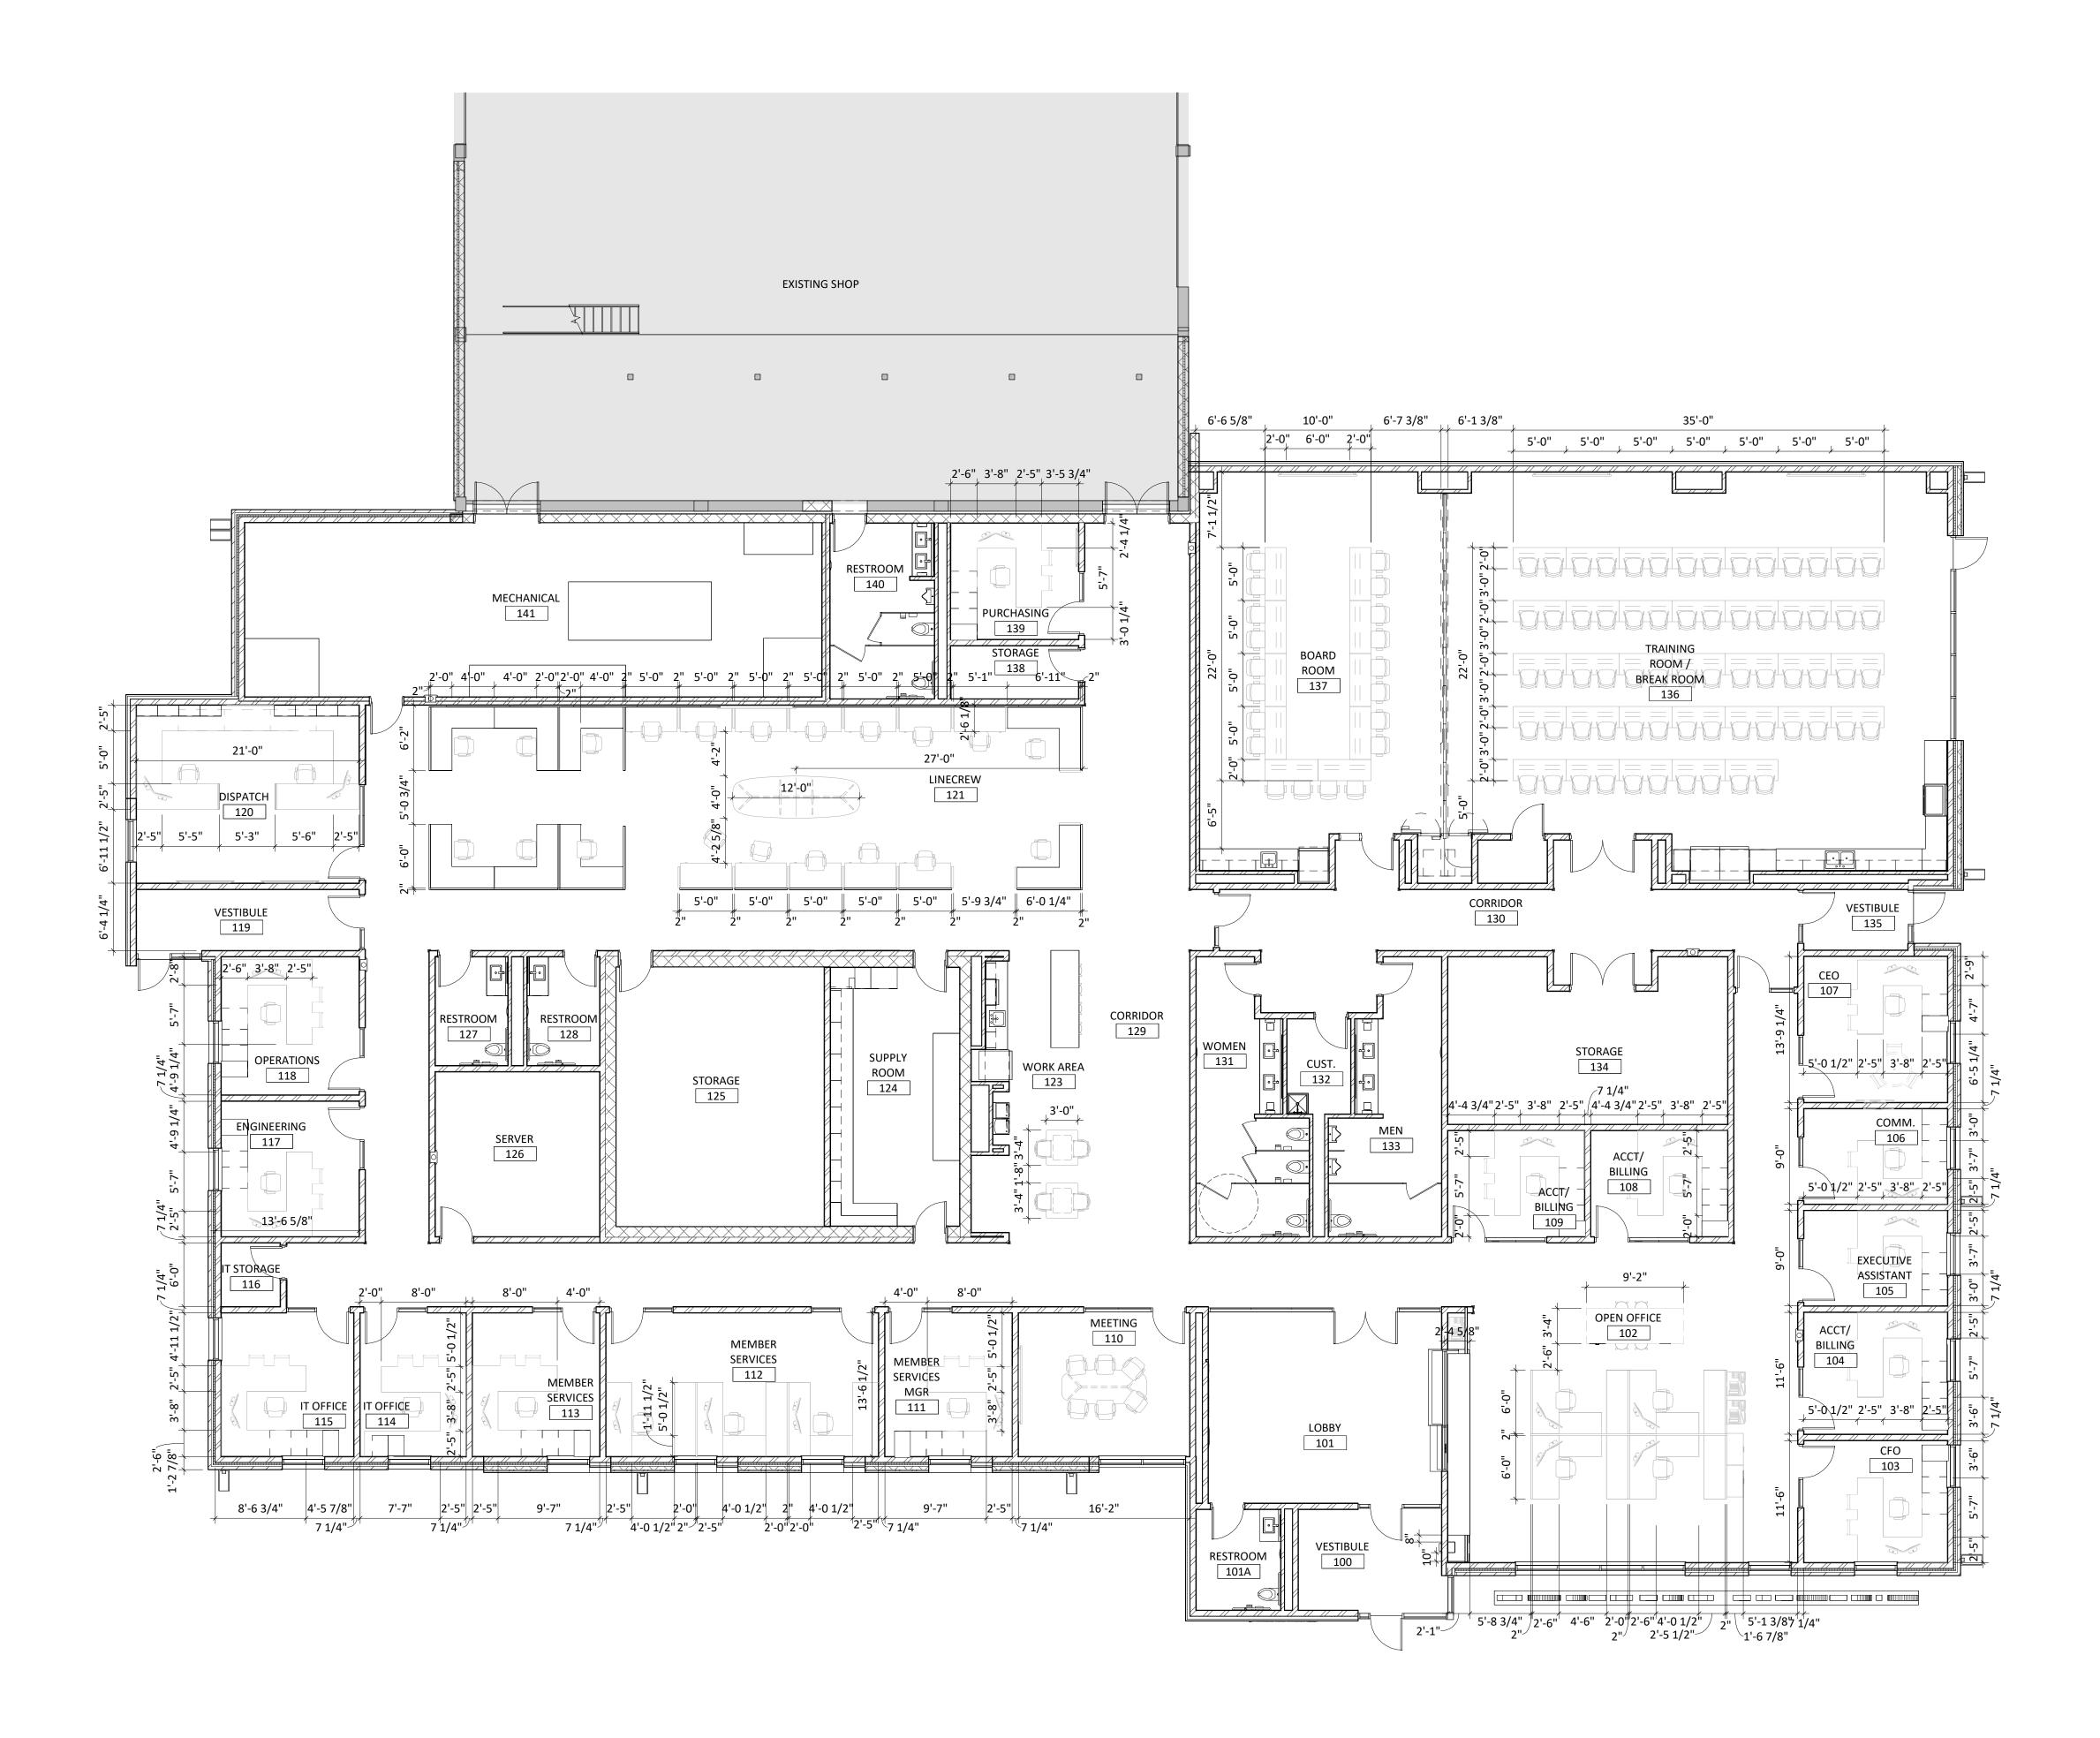
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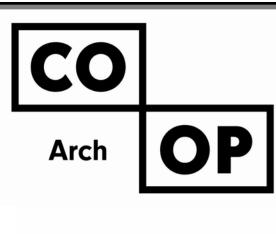
BATH, SOUTH DAKOTA

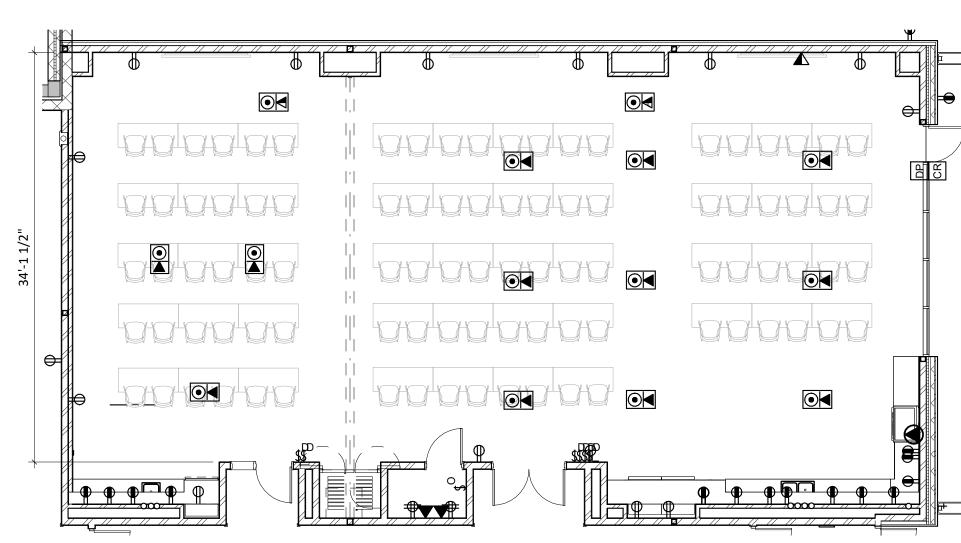SHEET TITLE: FF&E PLANS

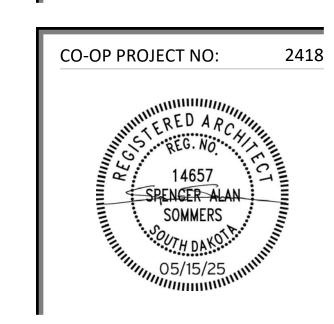117



	VEVALOTE COLLEDIUE
	KEYNOTE SCHEDULE
3.02	CONT. CONC. FOOTING (SEE STRUCTURAL PLANS)
3.14	SIGNAGE ANCHORS EMBEDDED IN CONC. (COORD. SIGNAGE ANCHOR REQ. W/SUPPLIER)
4.07	BRICK STACK BOND COURSING
4.10	CMU MASONRY UNIT
5.71	ROUND STEEL GUARDRAIL SECTION (SEE ARCH. & STRUCT.)
7.06	PREFINISHED FOAM EXPANSION JOINT MATERIAL
7.28	STANDING SEAM ICE & SNOW GUARDS (SEE PROJECT MANUAL)
7.39	STANDING SEAM ROOF CRICKET W/ MATCHING VALLEY FLASHING
7.40	STANDING SEAM METAL ROOFING
7.41	METAL WALL PANEL (PROVIDE ALL REQ. TRIM & FLASHING)
7.70	PRE-FINISHED SHEET METAL FLASHING
7.73	PRE-FINISHED METAL FASCIA
7.85	PRE-FINSIHED METAL GUTTER & EAVE TRIM (W/ ALL REQ'D FLASHING & SUPPORTS).
7.86	PRE-FINISHED METAL DOWNSPOUTS (W/ ALL REQ'D FLASHING & SUPPORTS). PROVIDE SPLASH PAD AT EACH DOWNSPOUT THAT RETURNS TO GRADE.
8.70	SKYLIGHT UNIT
9.73	FINISH MATERIAL TO MATCH FASCIA
10.06	CAST ALUMINUM DIMENSIONAL LOGO & LETTER SIGNAGE, CUSTOM FONT STYLE
10.08	INTERNALLY ILLUMINATED PANEL SIGNAGE
22.03	ROOF DRAIN
23.12	LOUVER (SEE MECHANICAL)
32.12	SPLASH BLOCK

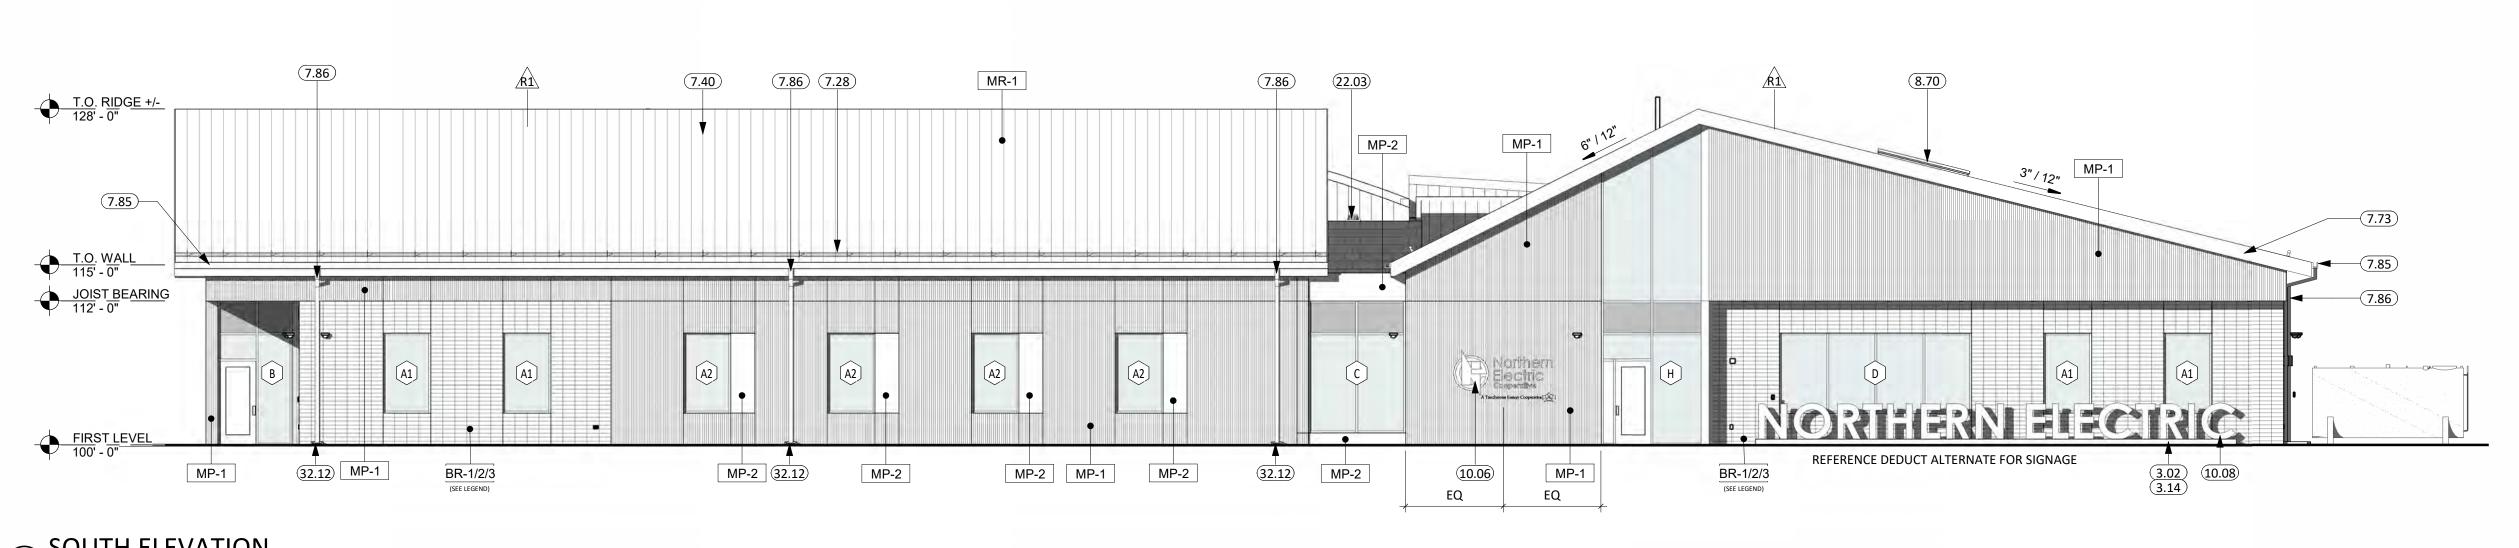


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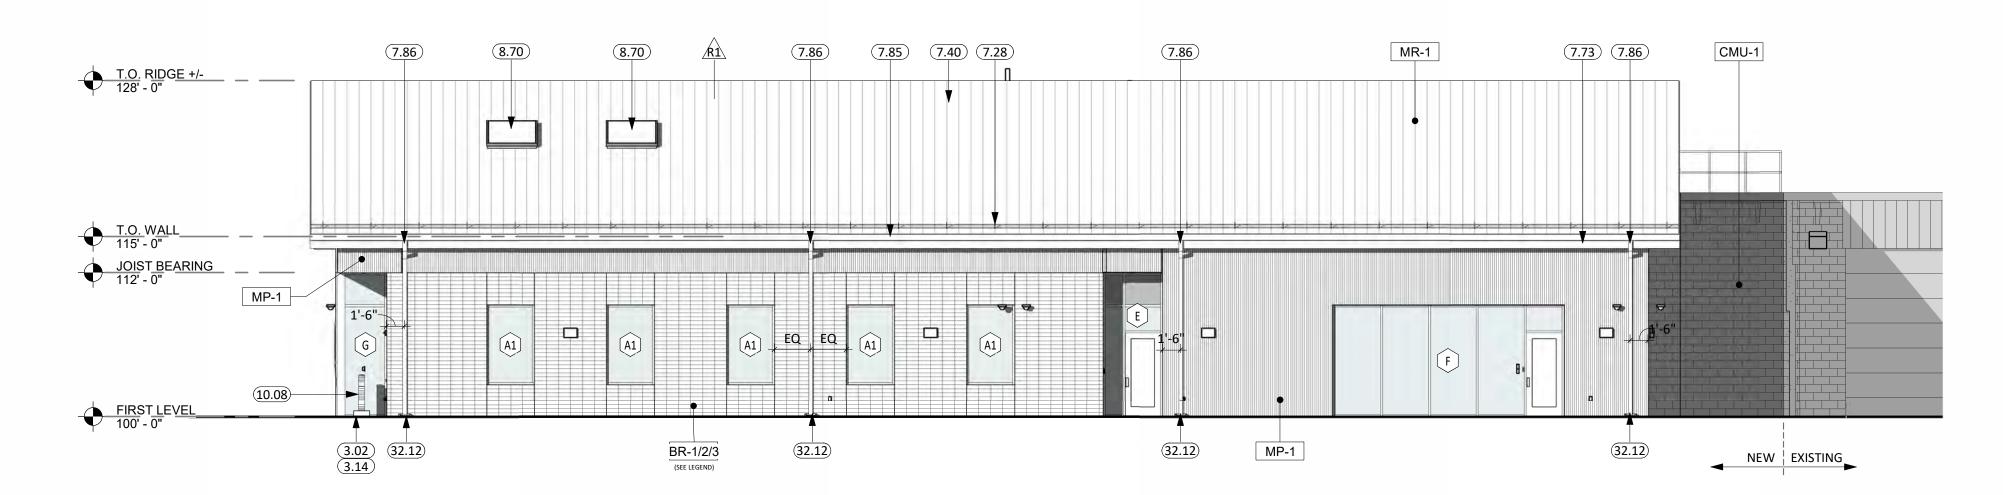
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SOUTH ELEVATION 1/8" = 1'-0"





TYPE	MARK	MANUFACTURER	STYLE	COLOR/ FINISH	SIZE	NOTES
	MP-1	LUX ARCHITECTURAL PRODUCTS	METAL CRAFT SERIES	TEXTURED COFFEE	VARIABLE PROFILE	
CLADDING	MP-2	PAC-CLAD	KYNAR 500 OR HYLAR 5000	ANTIQUE BRONZE		METAL PANEL @ 'A2' & 'A3' WINDOWS (SEE EXTERIOR ELEVATIONS)
	BR-1	ENDICOTT	EXTRUDED, STACK BOND	DESERT IRONSPOT LIGHT / SMOOTH	NORMAN	33% (RANDOM INSTALL)
	BR-2	ENDICOTT	EXTRUDED, STACK BOND	GOLDEN BUFF / SMOOTH	NORMAN	33% (RANDOM INSTALL)
	BR-3	BOWERSTON	EXTRUDED, STACK BOND	8515 / SMOOTH	NORMAN	33% (RANDOM INSTALL)
INFILL	CMU-1	SEE SPECIFICATIONS				MATCH EXISTING
SOFFIT	MP-3	LUX ARCHITECTURAL PRODUCTS	LUXLAP V-GROOVE	KNOTTY DESERT OAK	6" V-GROOVE	SOFFIT PANEL (SEE RCP)
SOFFIT	MP-4	PAC-CLAD	KYNAR 500 OR HYLAR 5000	ANTIQUE BRONZE		ROOF SOFFIT PANEL, FASCIA (SEE RCP)
METAL ROOF	MR-1	METAL SALES MANUFACTURING CORP.	MAGNA-LOC ROOF PANEL	DARK BRONZE	24 GA., 18" PANEL COVERAGE	STANDING SEAM

WEST ELEVATION 1/8" = 1'-0"

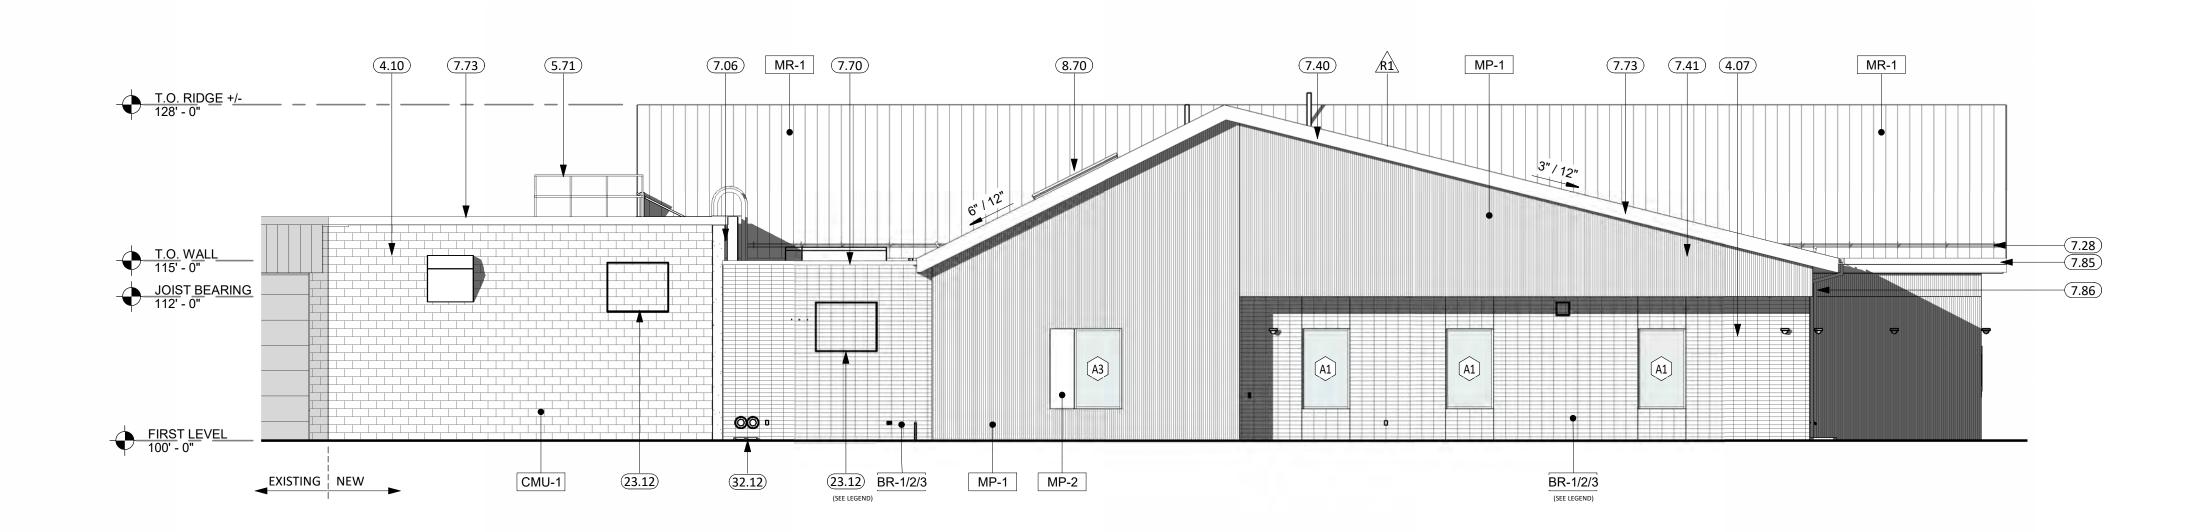

3 EAST ELEVATION 1/8" = 1'-0"

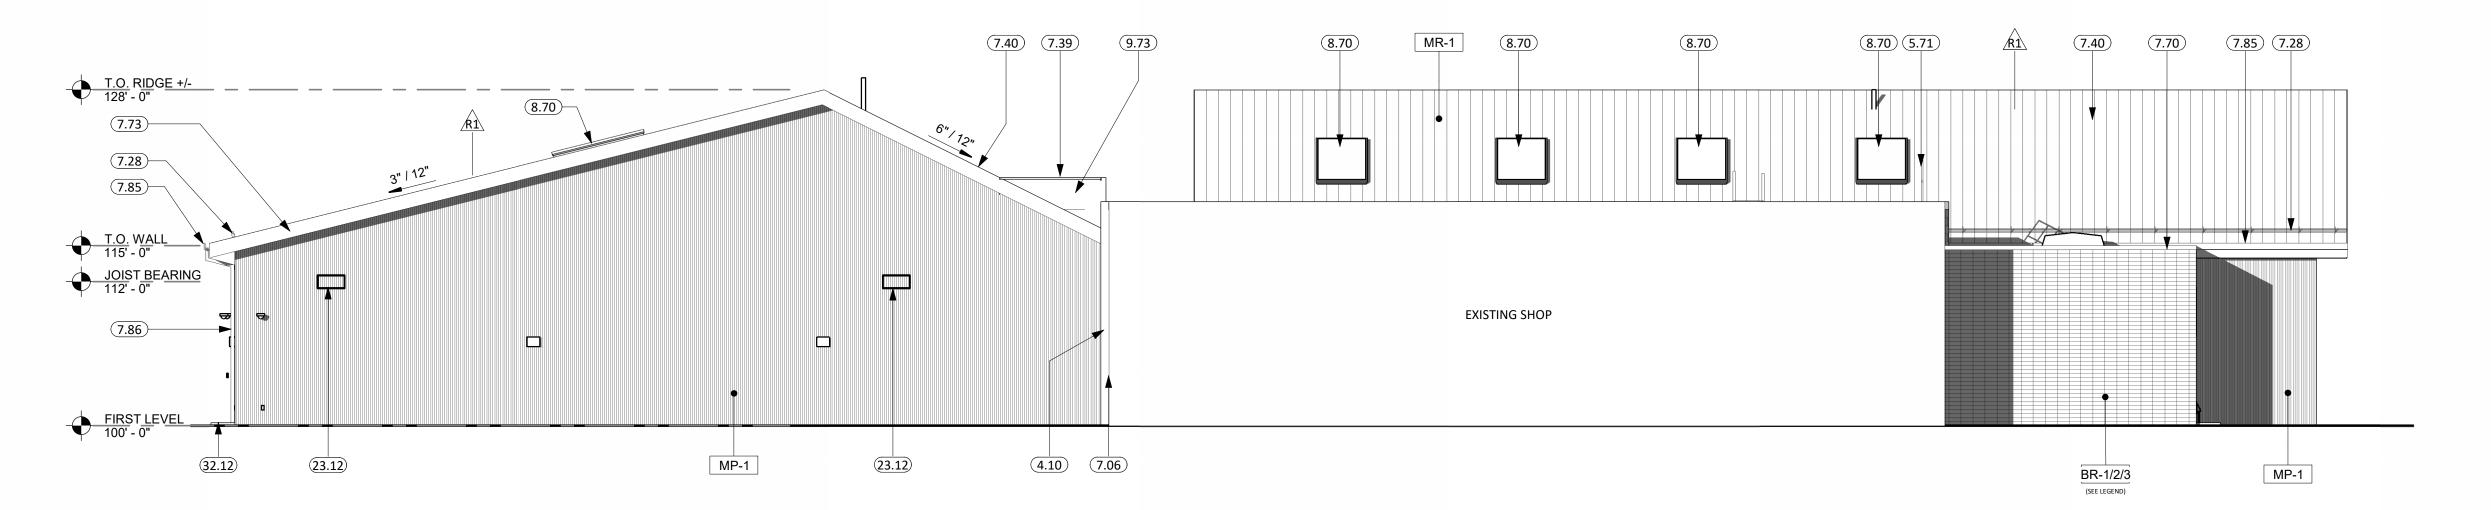

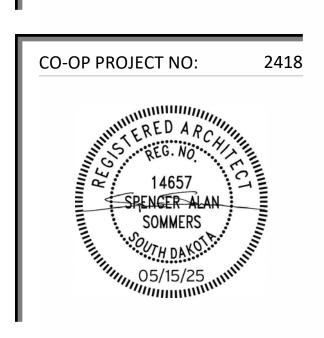

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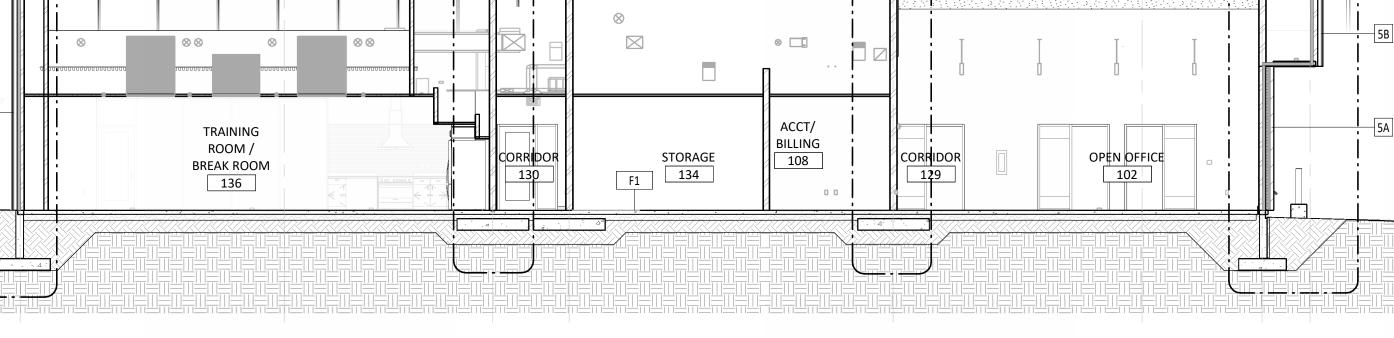
NORTHERN ELECTRIC COOPERATIVE


BATH, SOUTH DAKOTA

SHEET TITLE:
EXTERIOR ELEVATIONS

4 BUILDING SECTION


1/8" = 1'-0"



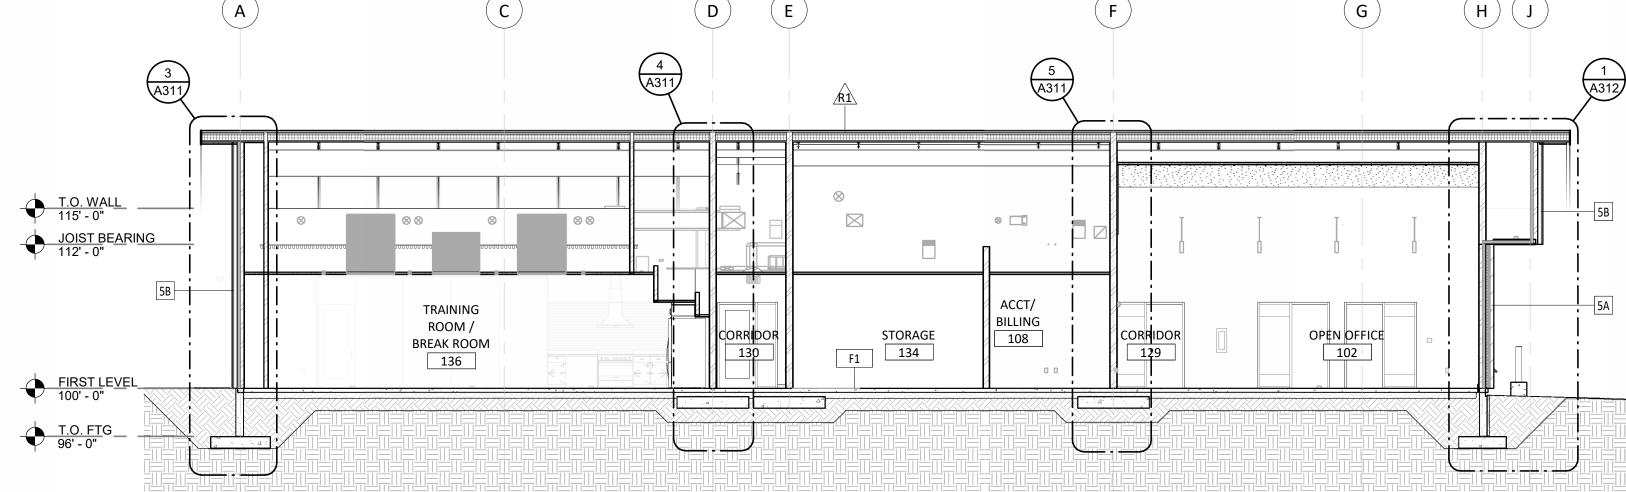


2 BUILDING SECTION

1/8" = 1'-0"

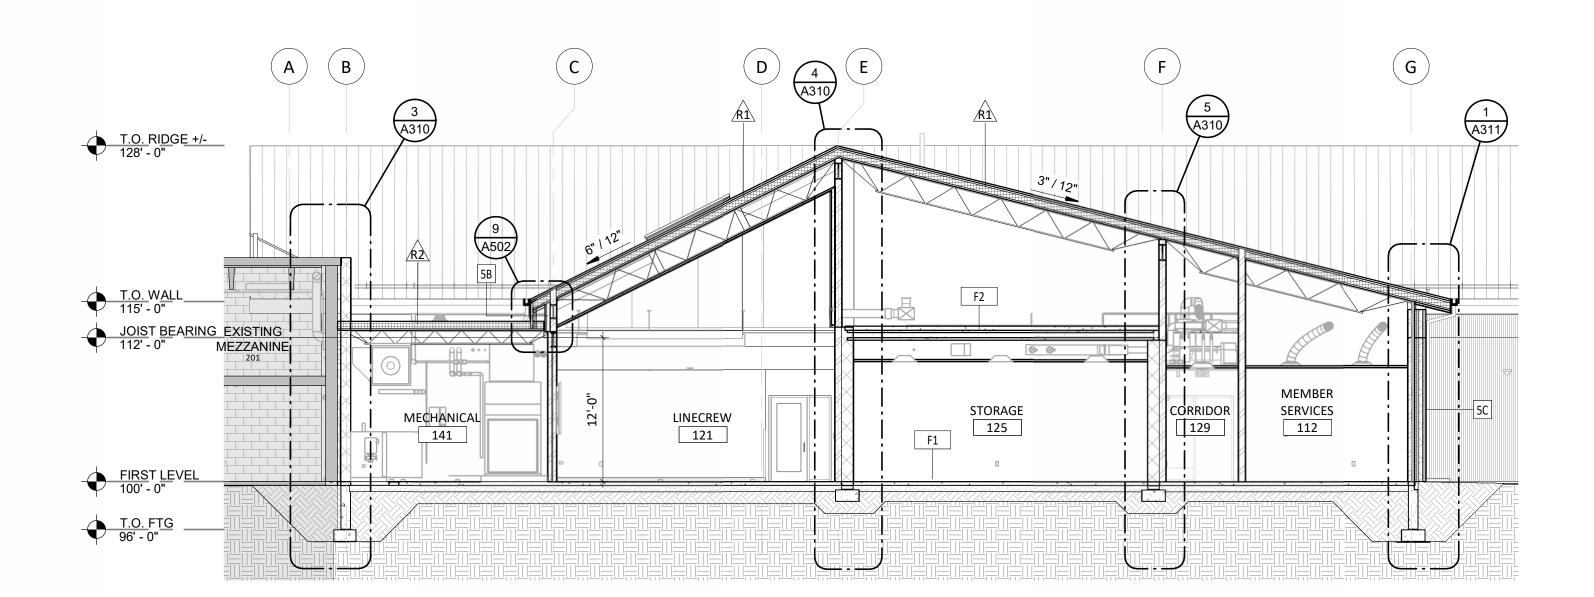


1) BUILDING SECTION

1/8" = 1'-0"

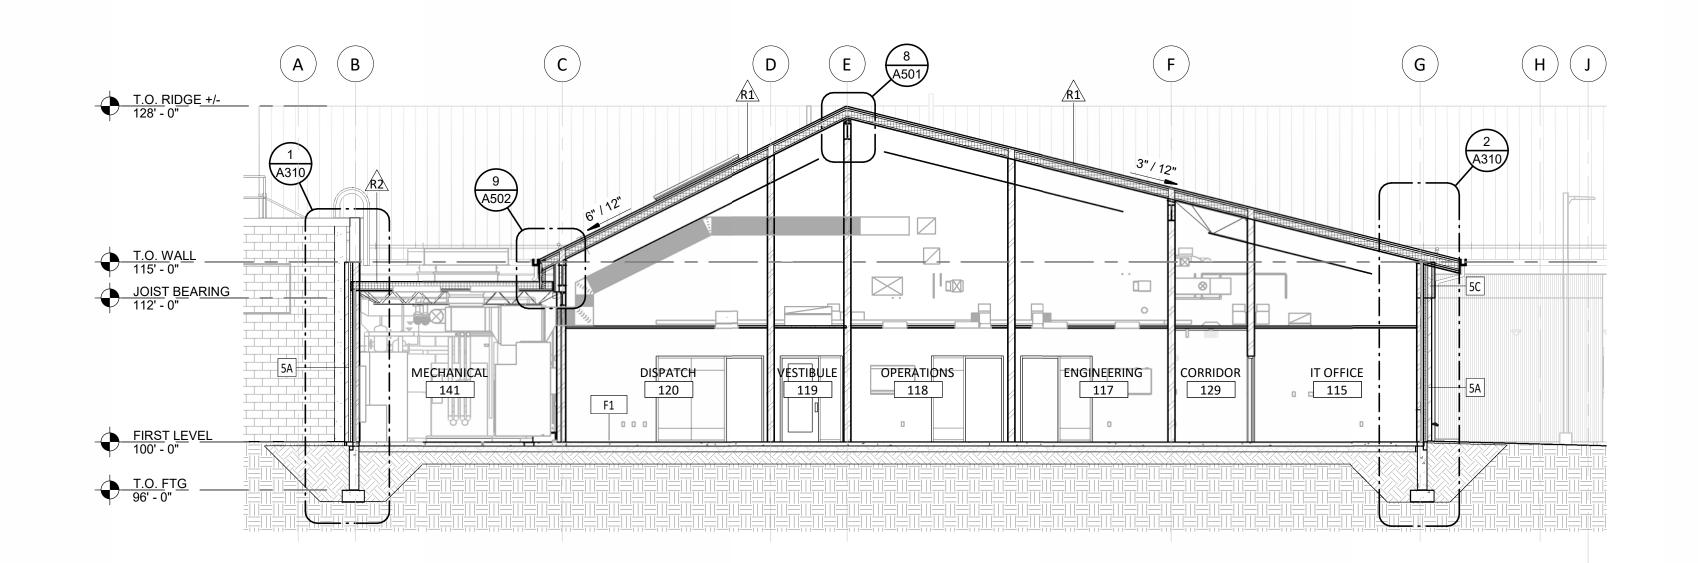


5 BUILDING SECTION

1/8" = 1'-0"

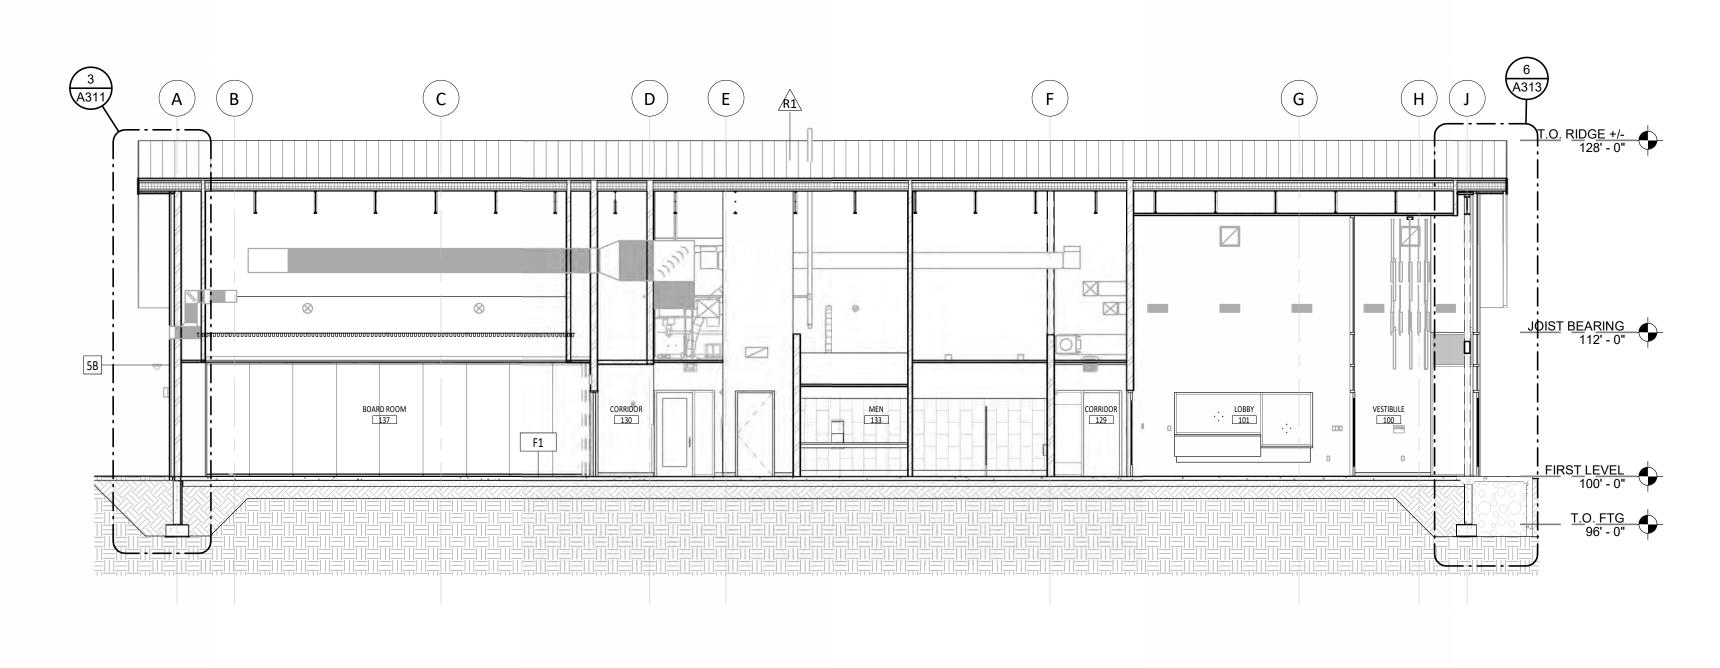

BUILDING SECTION

1/8" = 1'-0"

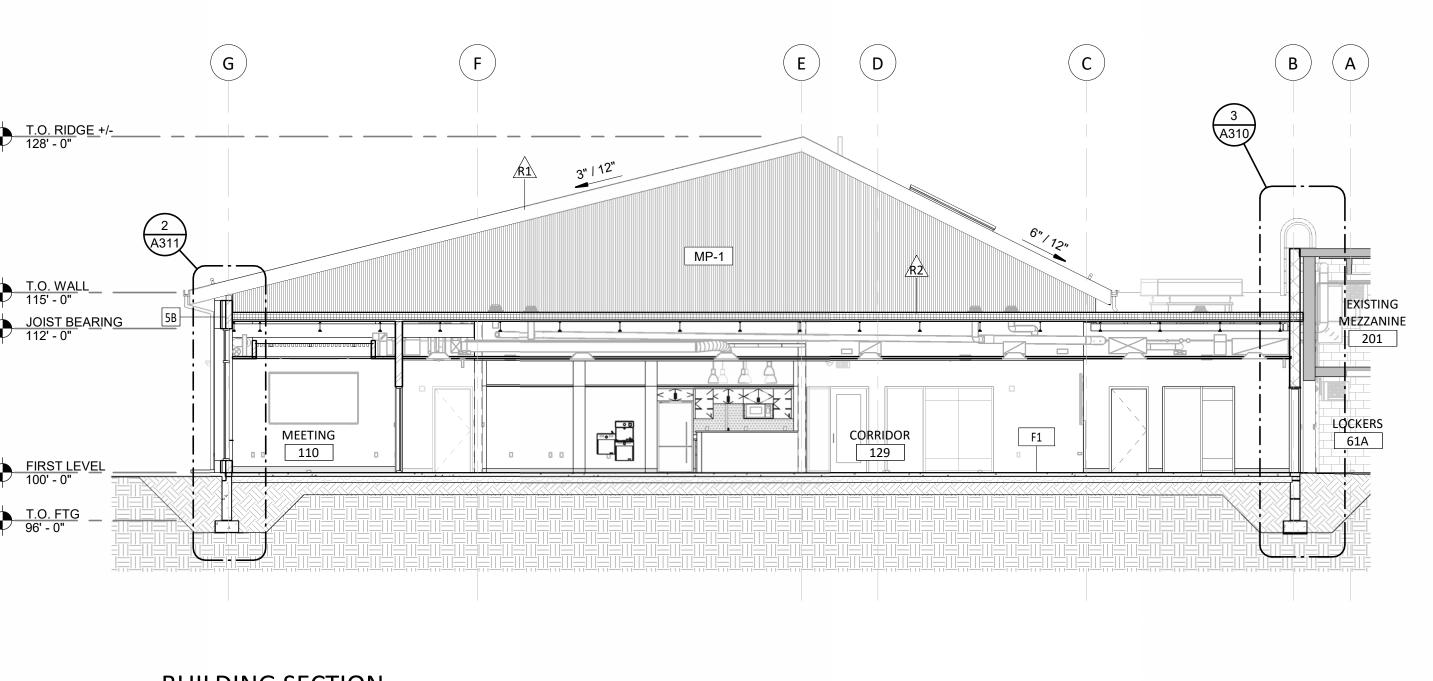

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A300

CO-OP PROJECT NO:

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NORTHERN ELECTRIC

BATH, SOUTH DAKOTA


BUILDING SECTIONS

NORTHERN ELECTRIC COOPERATIVE


PROJECT:

SHEET TITLE:

4 BUILDING SECTION 1/8" = 1'-0"

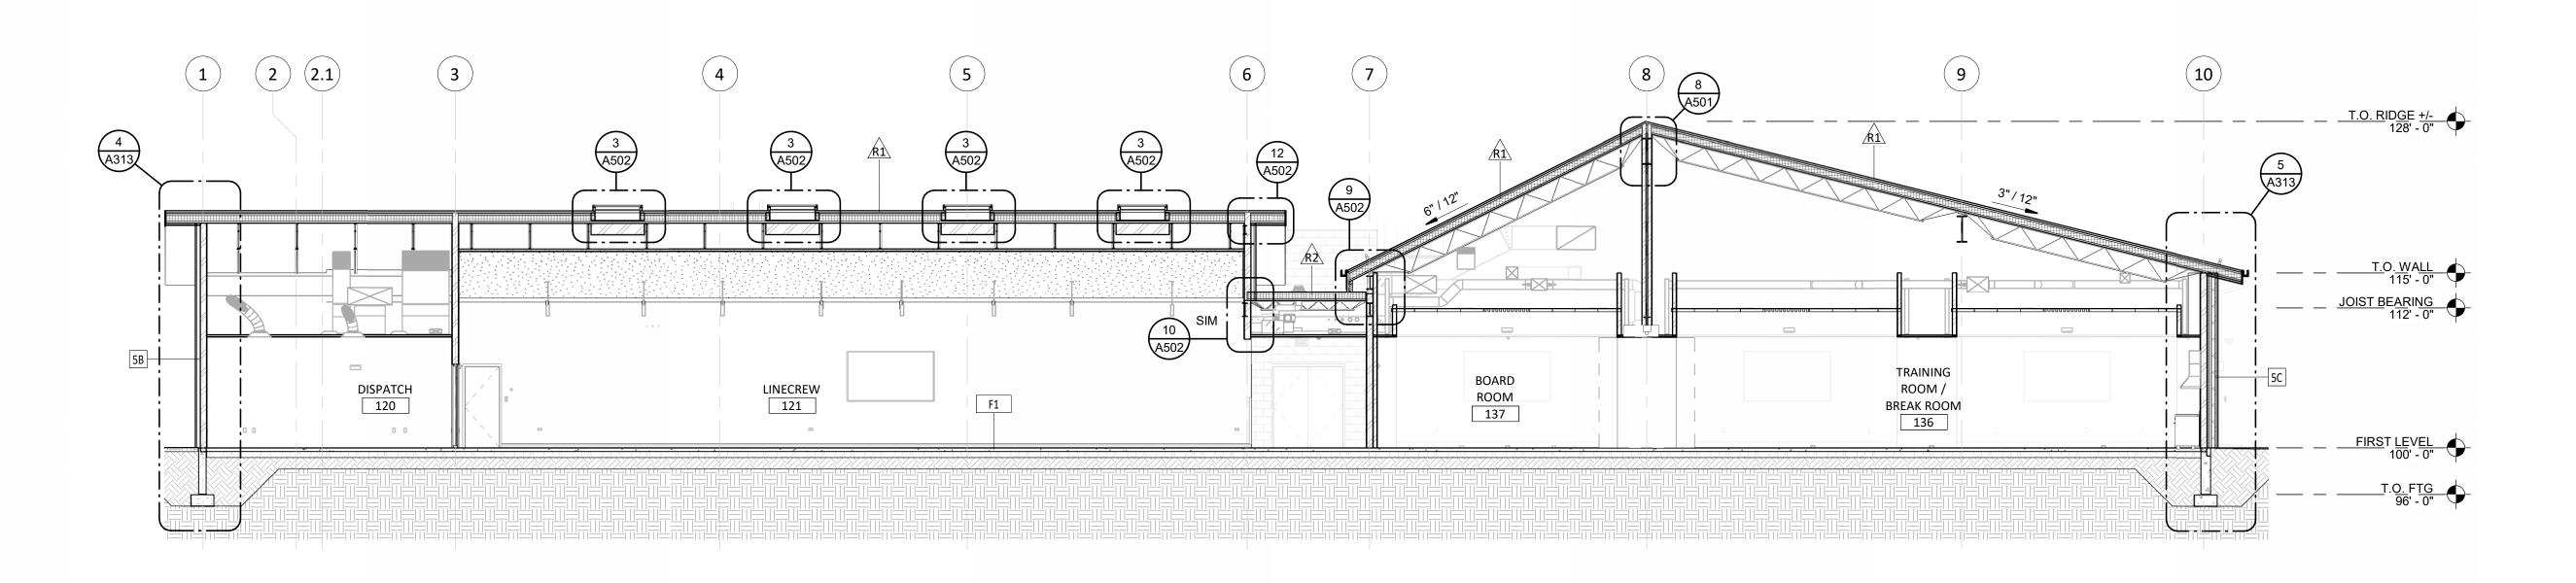



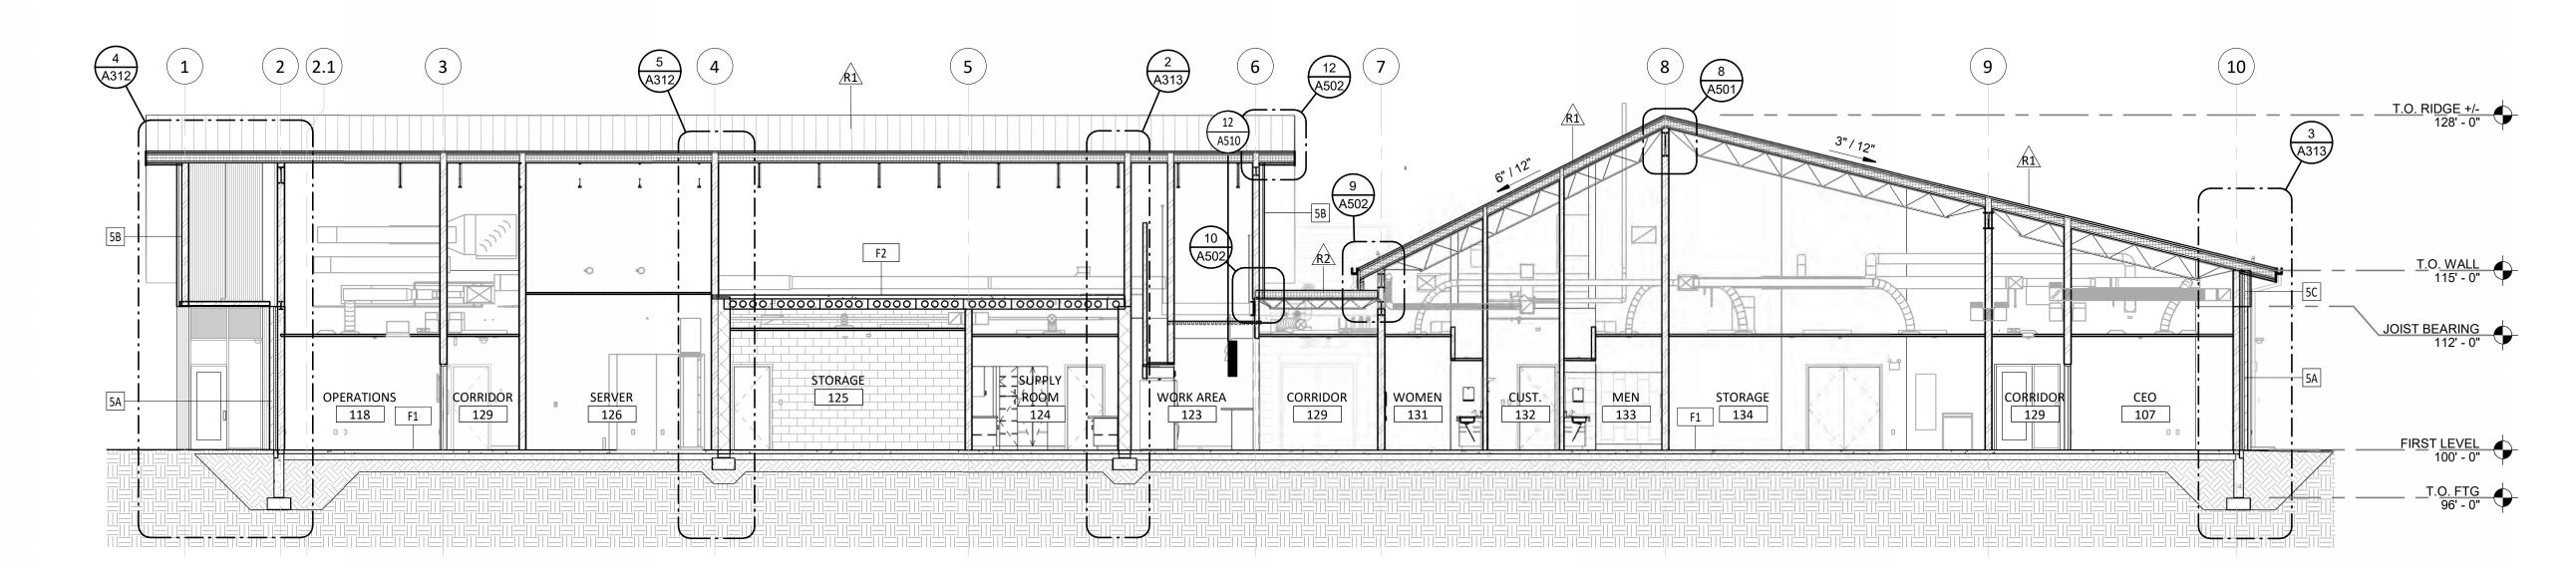

JOIST BEARING 112' - 0"

10

CFO 103

9




RESTROOM

VESTIBULE


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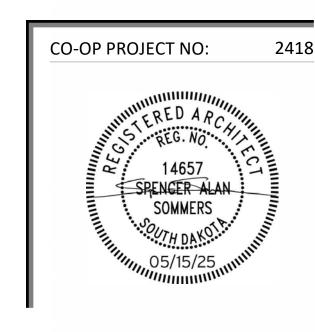
7

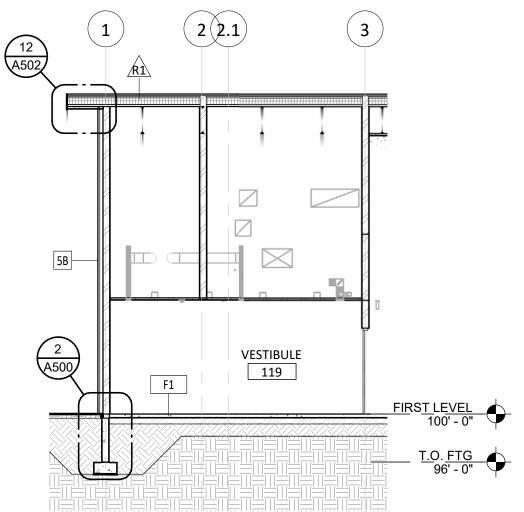

SECTION THRU VESTIBULE 119

1/8" = 1'-0"



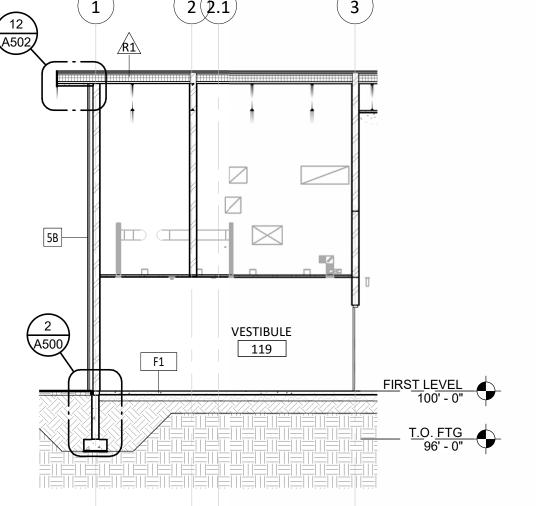

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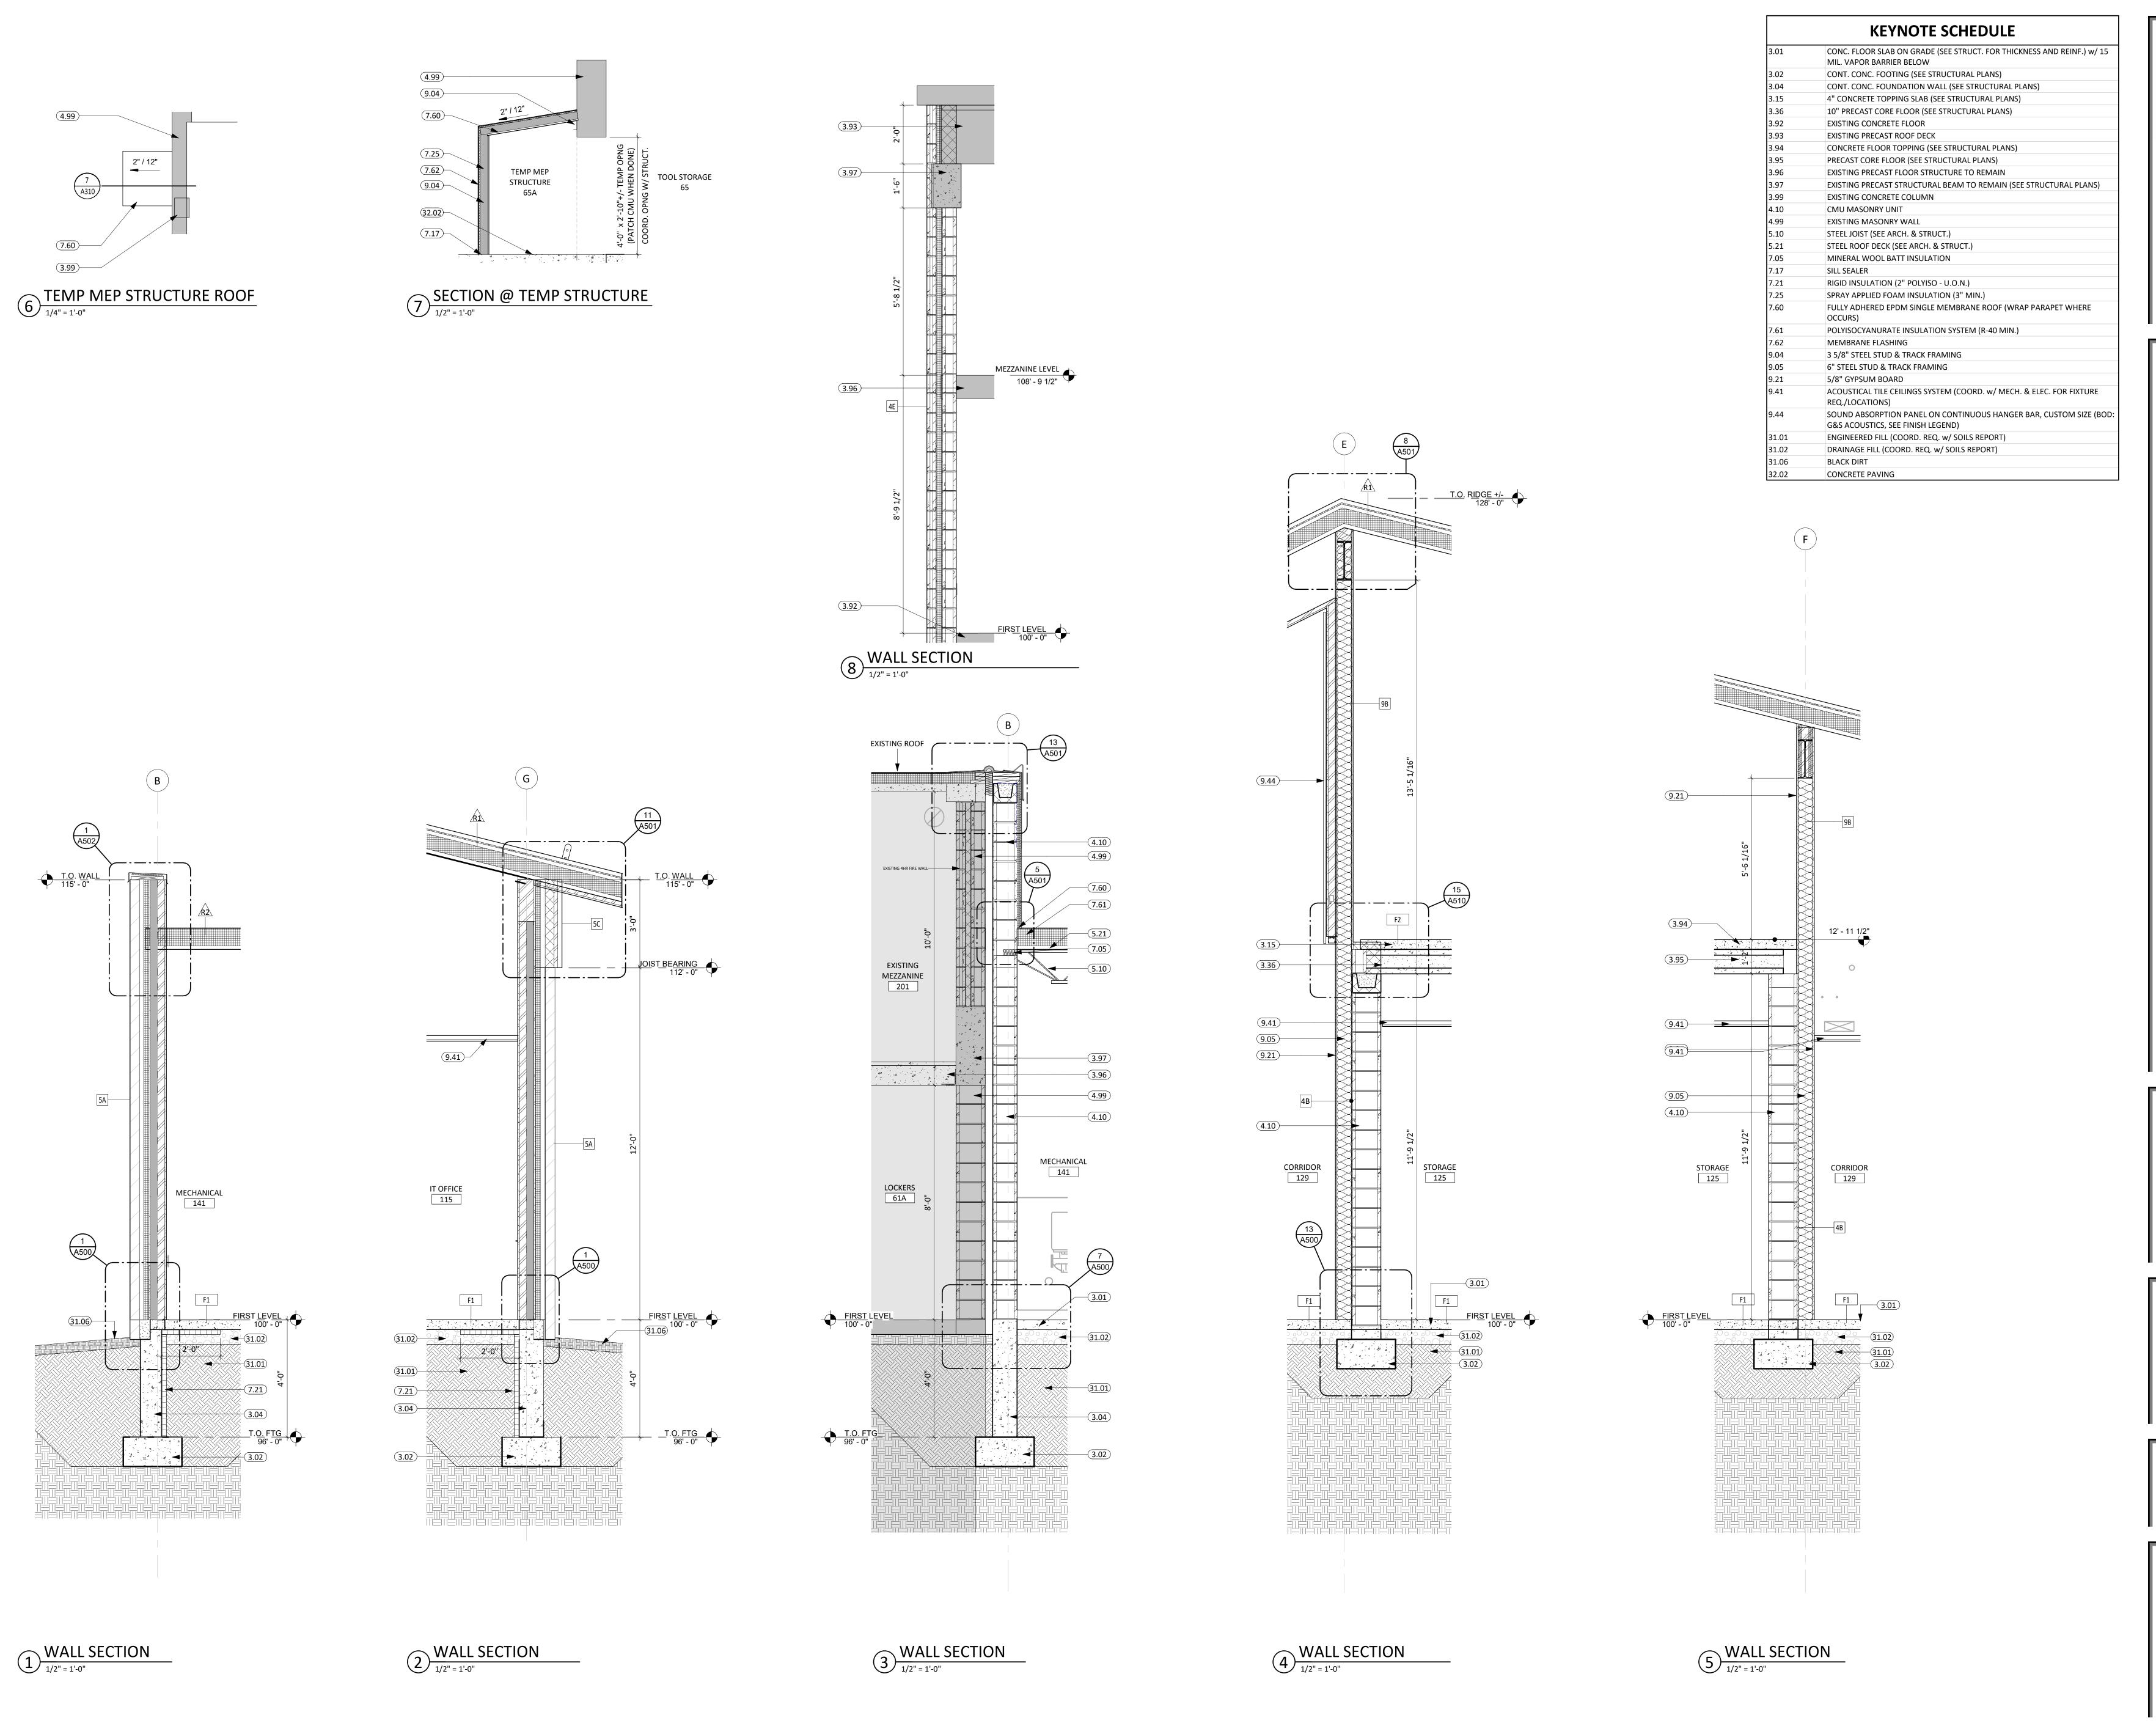
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PROJECT: NORTHERN ELECTRIC NORTHERN ELECTRIC COOPERATIVE BATH, SOUTH DAKOTA

SHEET TITLE: BUILDING SECTIONS



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CO-OP PROJECT NO: 2

14657
SPENCER ALAN
SOMMERS
O5/15/25

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REV. # REV. DSC.

PROJECT:

NORTHERN ELECTRIC
NORTHERN ELECTRIC COOPERATIVE
BATH, SOUTH DAKOTA

SHEET TITLE:

WALL SECTIONS

	KEYNOTE SCHEDULE
3.01	CONC. FLOOR SLAB ON GRADE (SEE STRUCT. FOR THICKNESS AND REINF.) w MIL. VAPOR BARRIER BELOW
3.02	CONT. CONC. FOOTING (SEE STRUCTURAL PLANS)
3.03	CONC. FOOTING PAD (SEE STRUCTURAL PLANS)
3.04	CONT. CONC. FOUNDATION WALL (SEE STRUCTURAL PLANS)
7.21	RIGID INSULATION (2" POLYISO - U.O.N.)
9.41	ACOUSTICAL TILE CEILINGS SYSTEM (COORD. w/ MECH. & ELEC. FOR FIXTUR REQ./LOCATIONS)
31.01	ENGINEERED FILL (COORD. REQ. w/ SOILS REPORT)
31.02	DRAINAGE FILL (COORD. REQ. w/ SOILS REPORT)
31.06	BLACK DIRT


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CO-OP PROJECT NO: 2418

CO-OP PROJECT NO: 2418

14657

SPENCER ALAN
SOMMERS

05/15/25

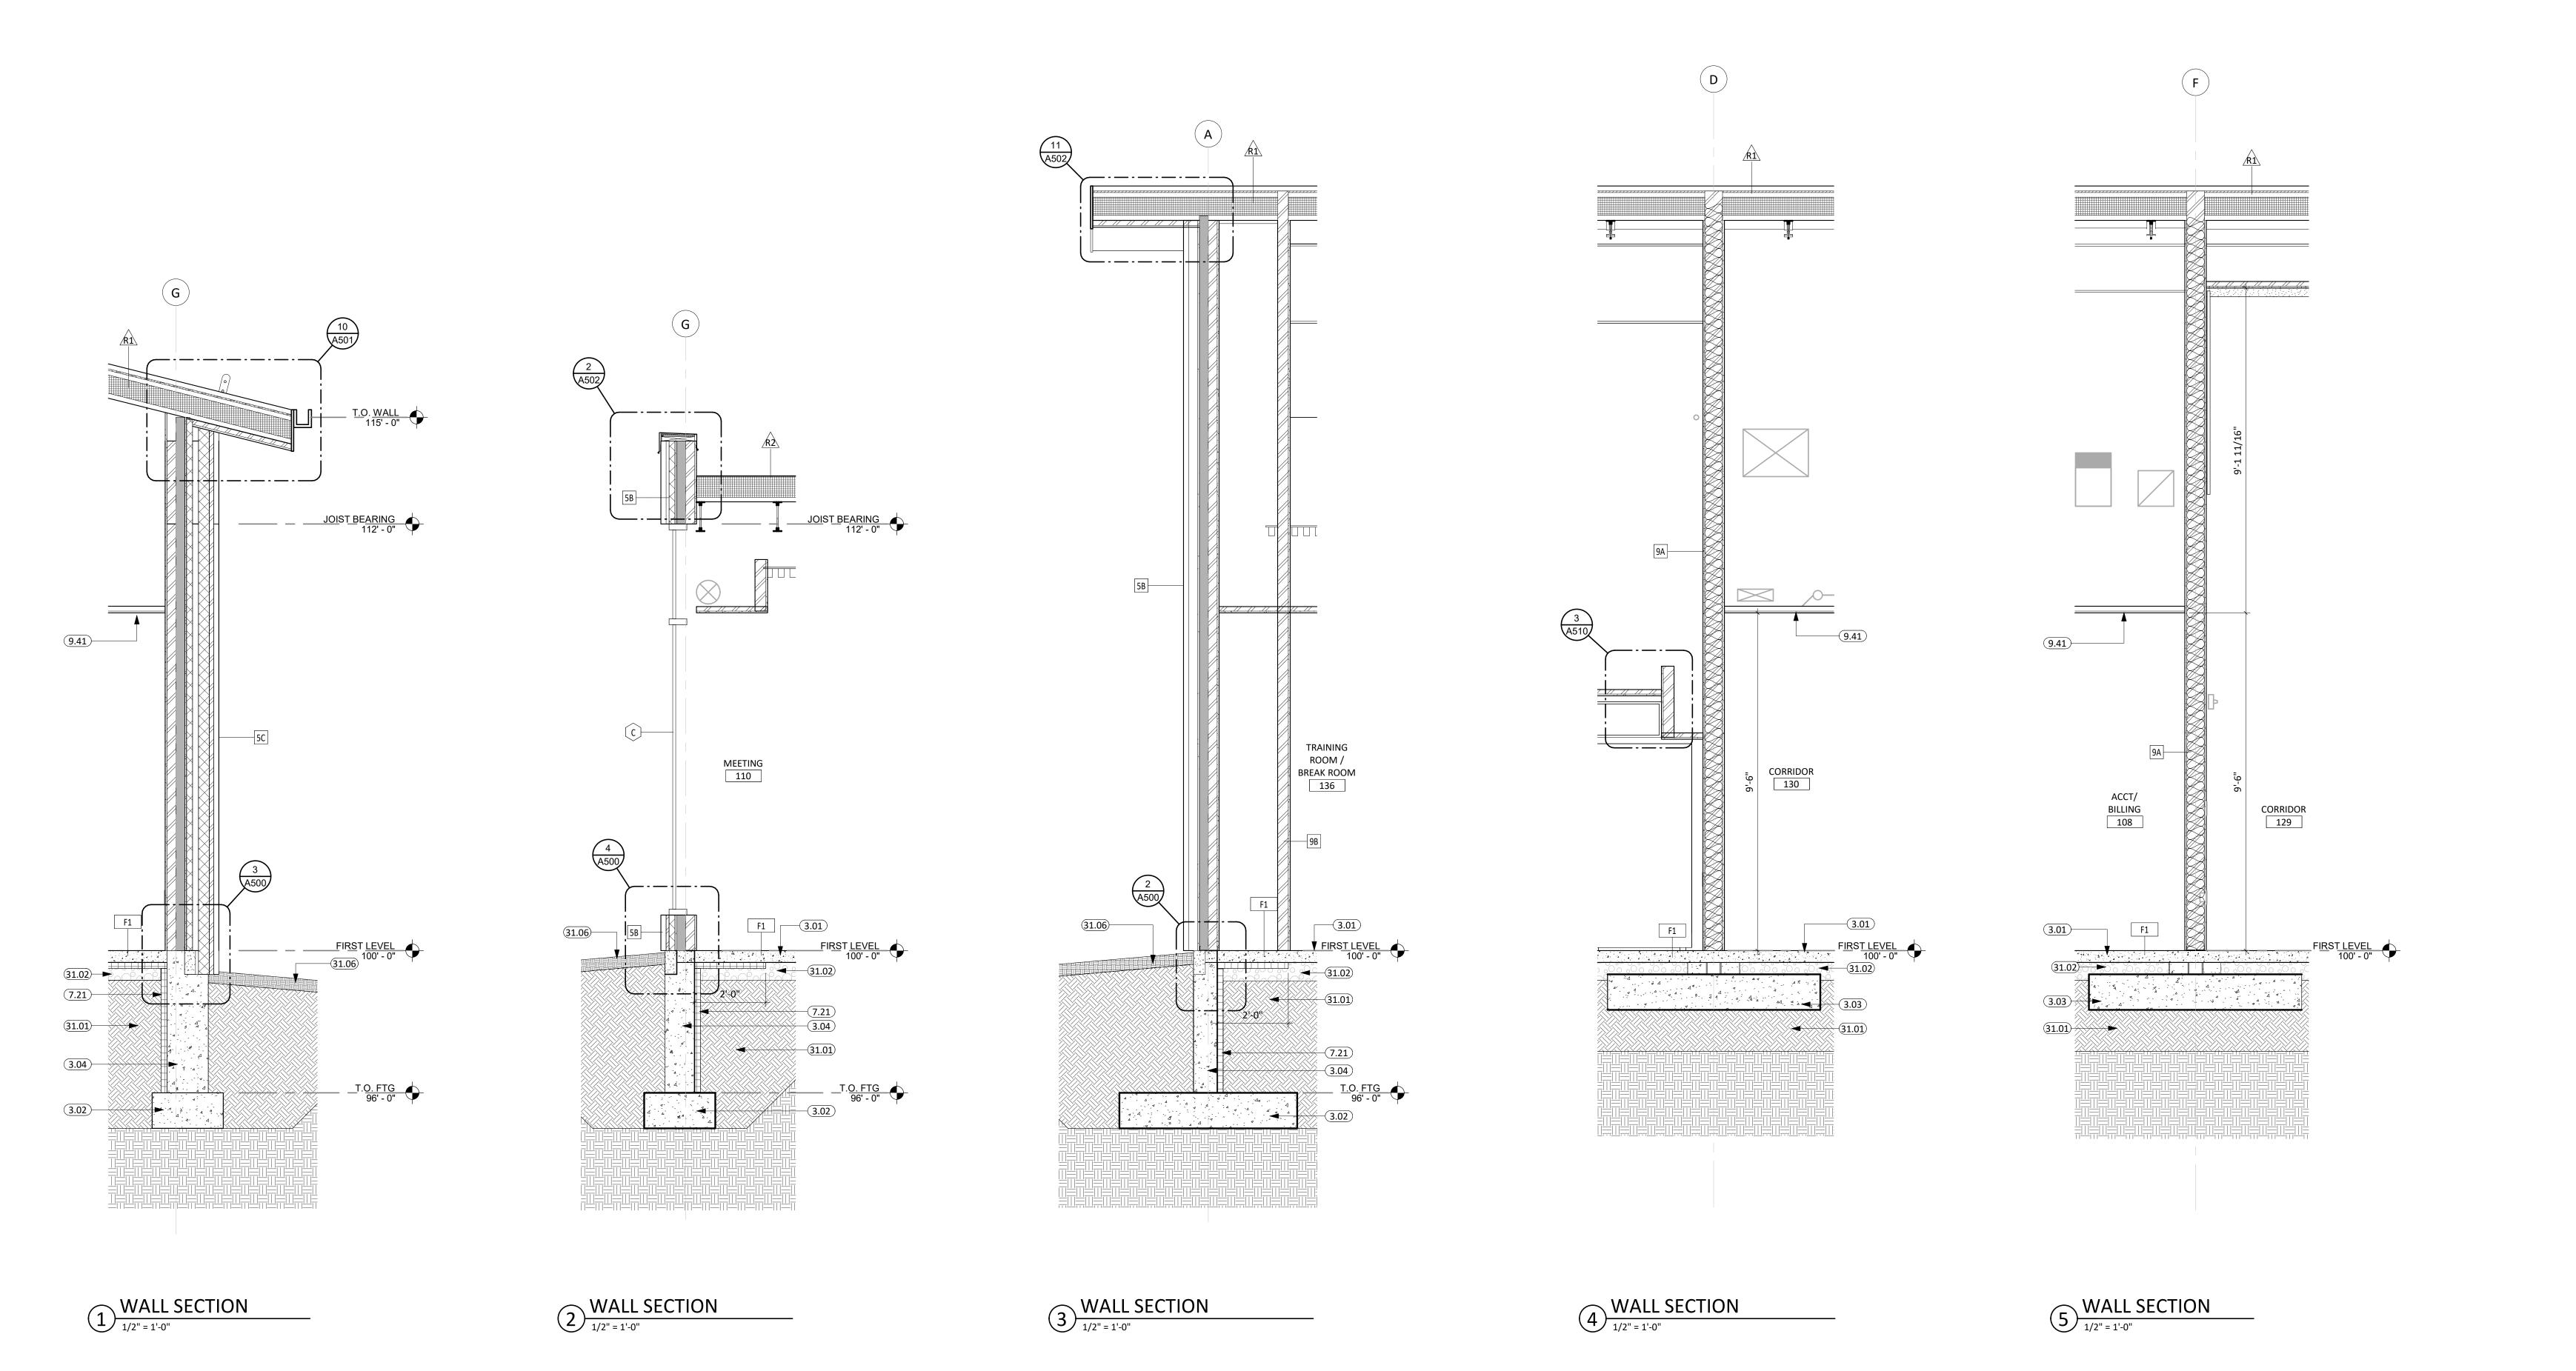MILLIAN
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MILLIAN
OS/15/25

ISSUE:
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REVISION SCHEDULE:
REV. # REV. DSC. REV. DATE

PROJECT:


NORTHERN ELECTRIC

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BATH, SOUTH DAKOTA

SHEET TITLE:
WALL SECTIONS


	KEYNOTE SCHEDULE
3.01	CONC. FLOOR SLAB ON GRADE (SEE STRUCT. FOR THICKNESS AND REINF.) w/ 1 MIL. VAPOR BARRIER BELOW
3.02	CONT. CONC. FOOTING (SEE STRUCTURAL PLANS)
3.04	CONT. CONC. FOUNDATION WALL (SEE STRUCTURAL PLANS)
3.14	SIGNAGE ANCHORS EMBEDDED IN CONC. (COORD. SIGNAGE ANCHOR REQ. W SUPPLIER)
7.21	RIGID INSULATION (2" POLYISO - U.O.N.)
9.41	ACOUSTICAL TILE CEILINGS SYSTEM (COORD. w/ MECH. & ELEC. FOR FIXTURE REQ./LOCATIONS)
9.47	5/8" GYPSUM BOARD ON 1 1/2" METAL FURRING CHANNEL. PROVIDE METAL FURRING CHANNEL AT 16" O.C., PERPENDICULAR TO ROOF FRAMING.
9.48	5/8" GYPSUM BOARD ON METAL SUSPENSION SYSTEM (COORD. w/ MECH. & ELEC. FOR FIXTURE REQ./LOCATIONS)
31.01	ENGINEERED FILL (COORD. REQ. w/ SOILS REPORT)
31.02	DRAINAGE FILL (COORD. REQ. w/ SOILS REPORT)
31.06	BLACK DIRT

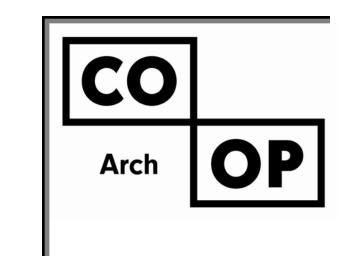



600 Kansas City St. #1 Rapid City, SD 57701 Phone: 605-716-3652

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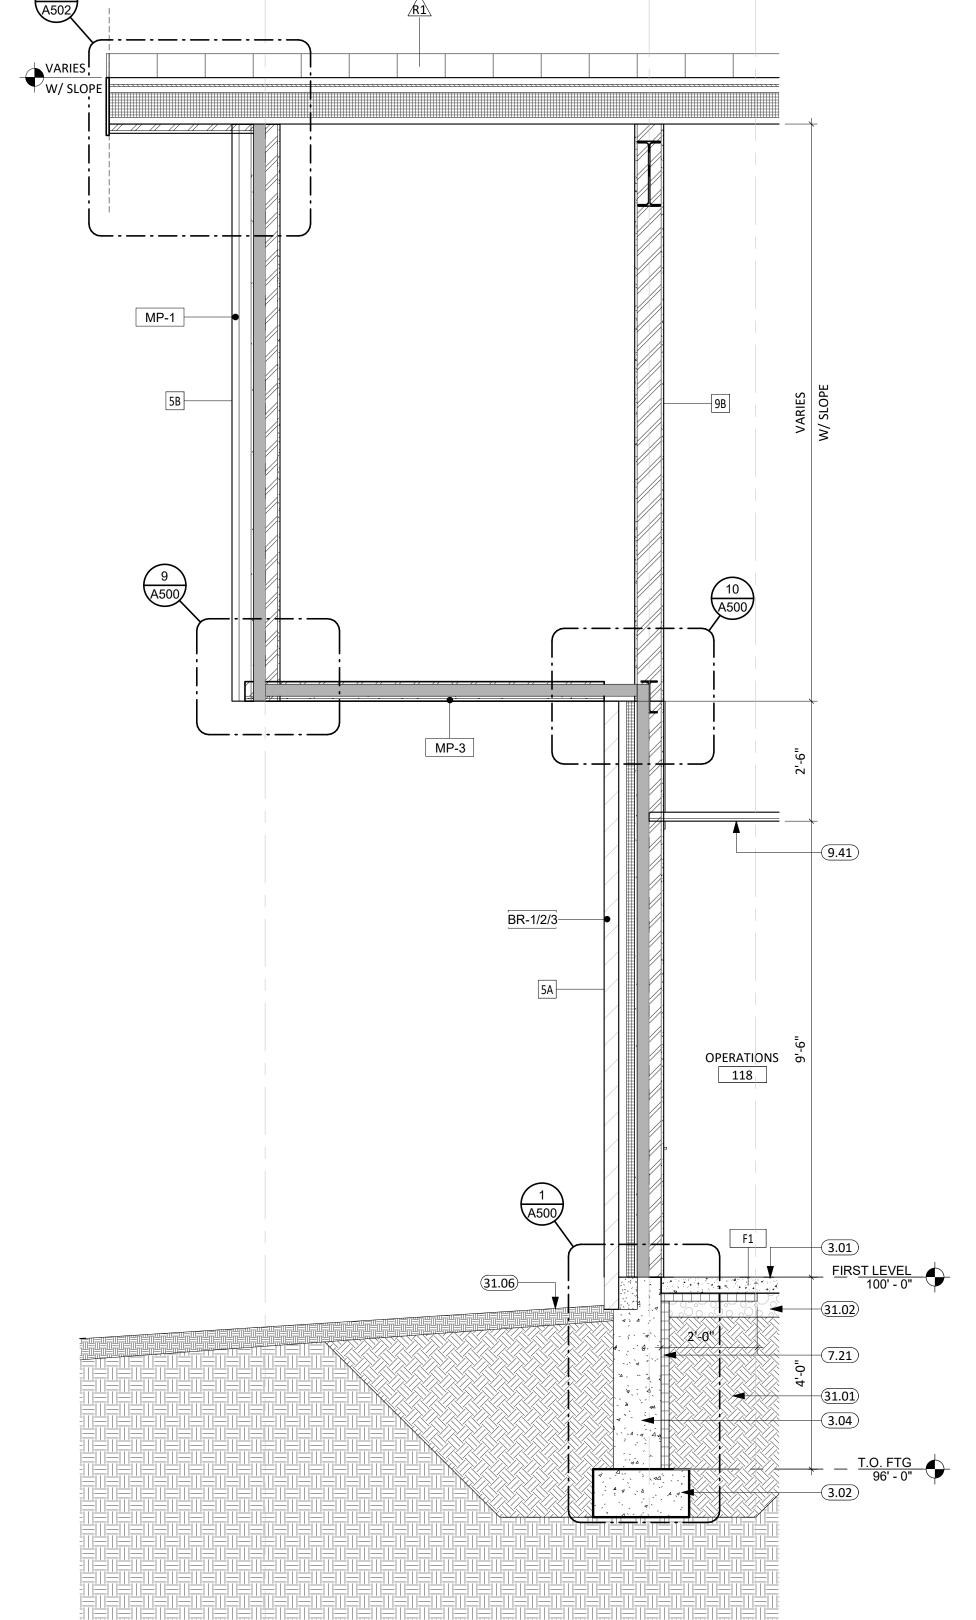


WALL SECTION

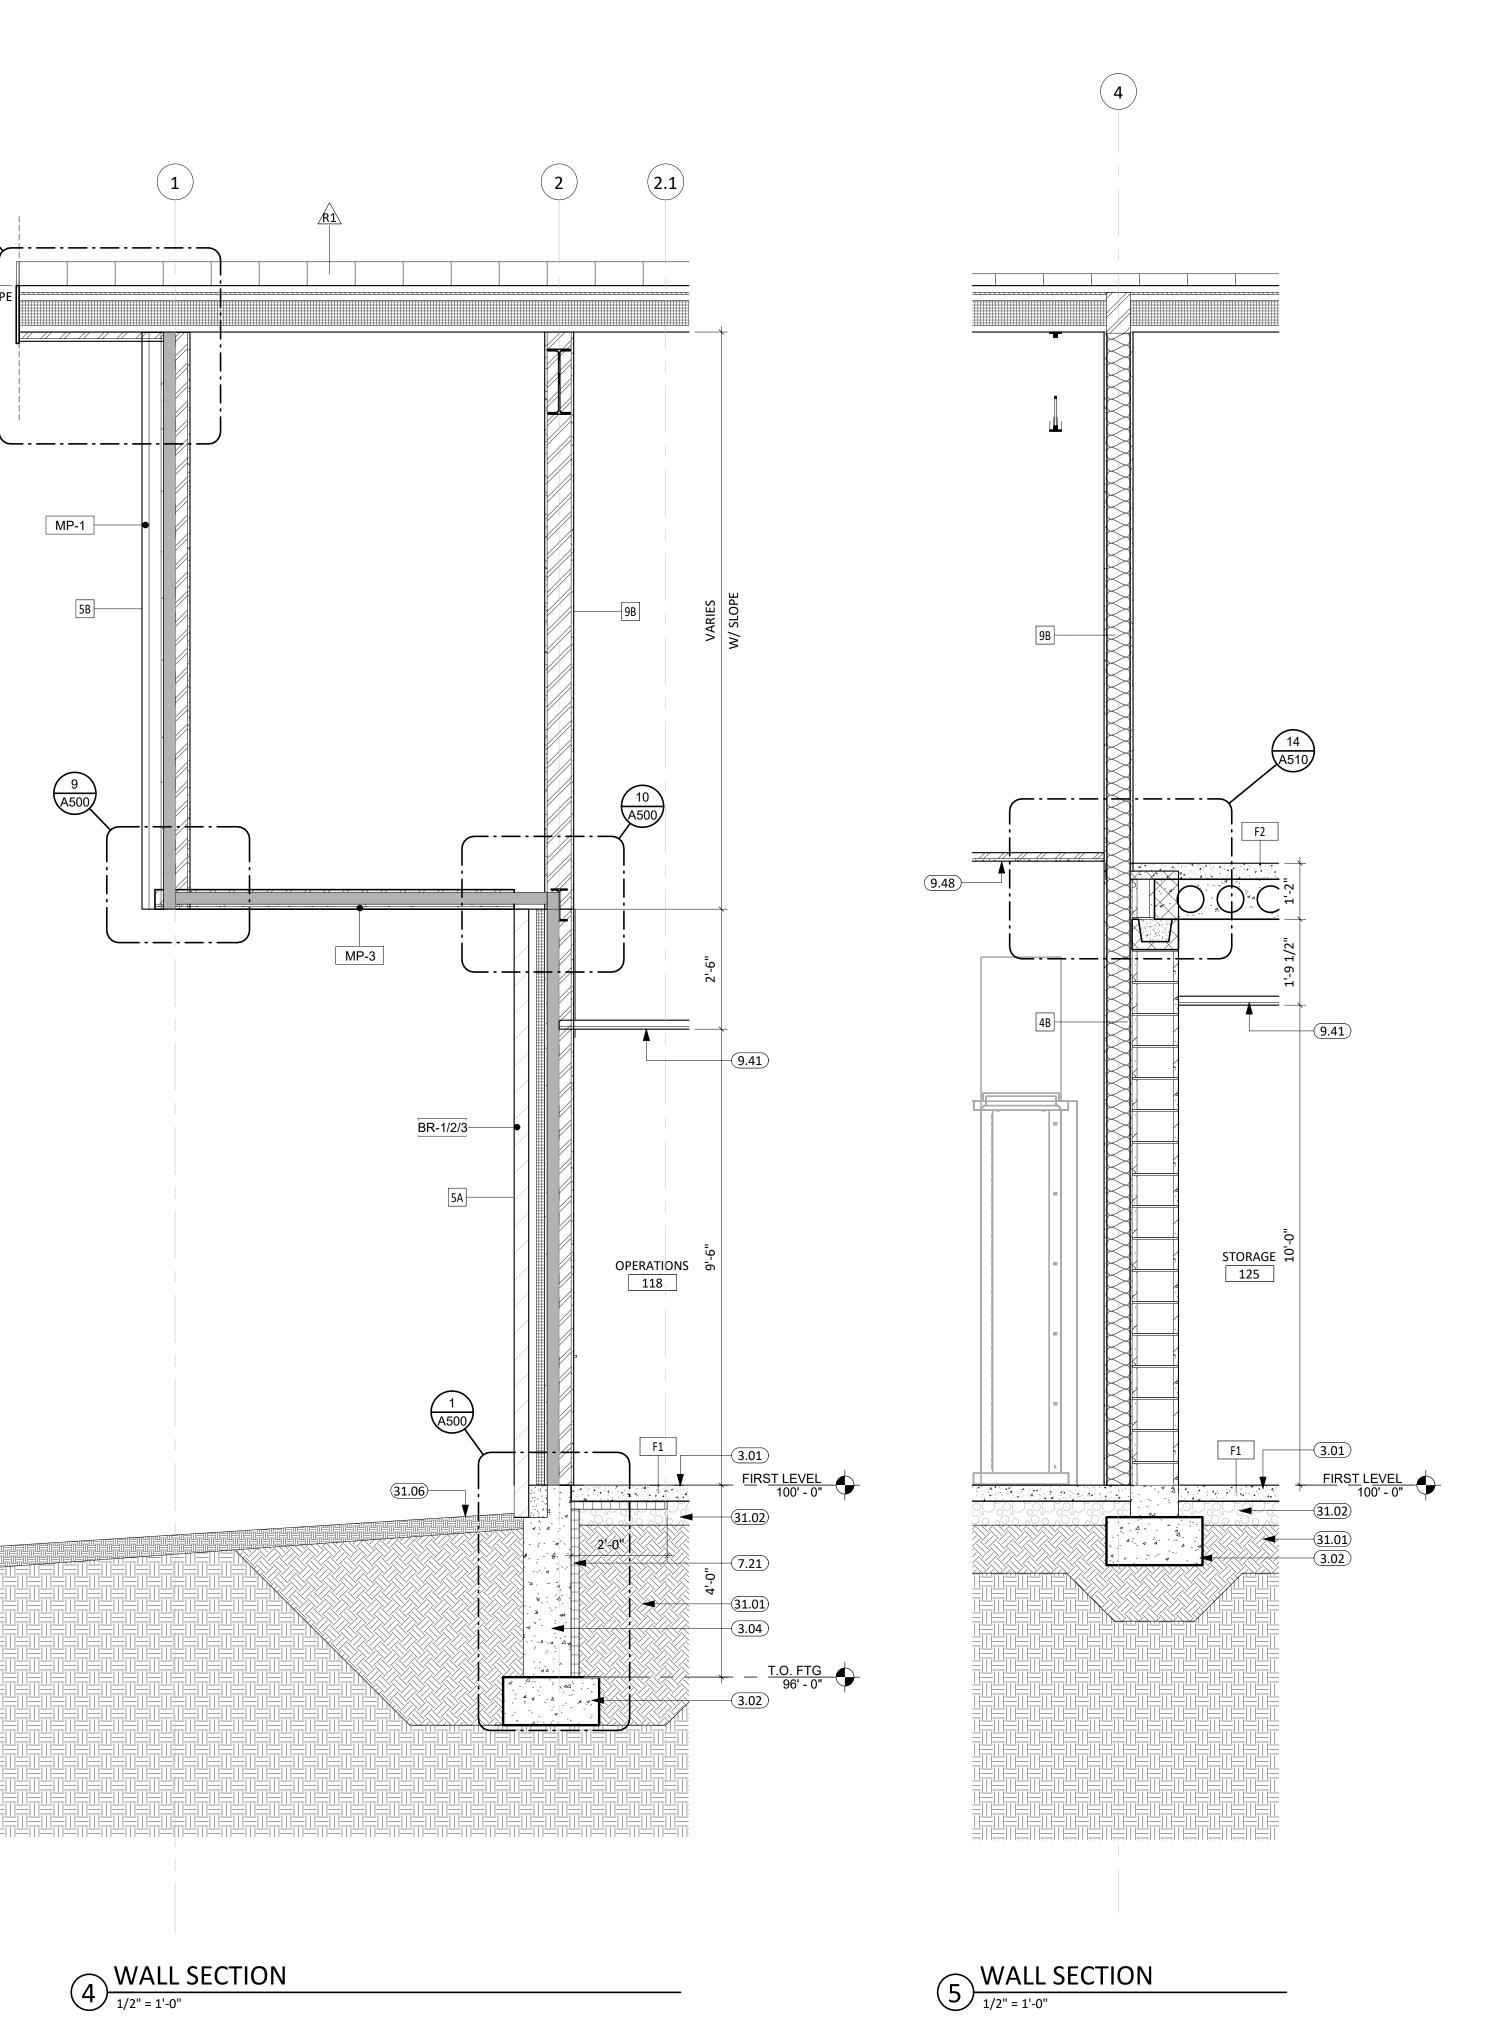1/2" = 1'-0"

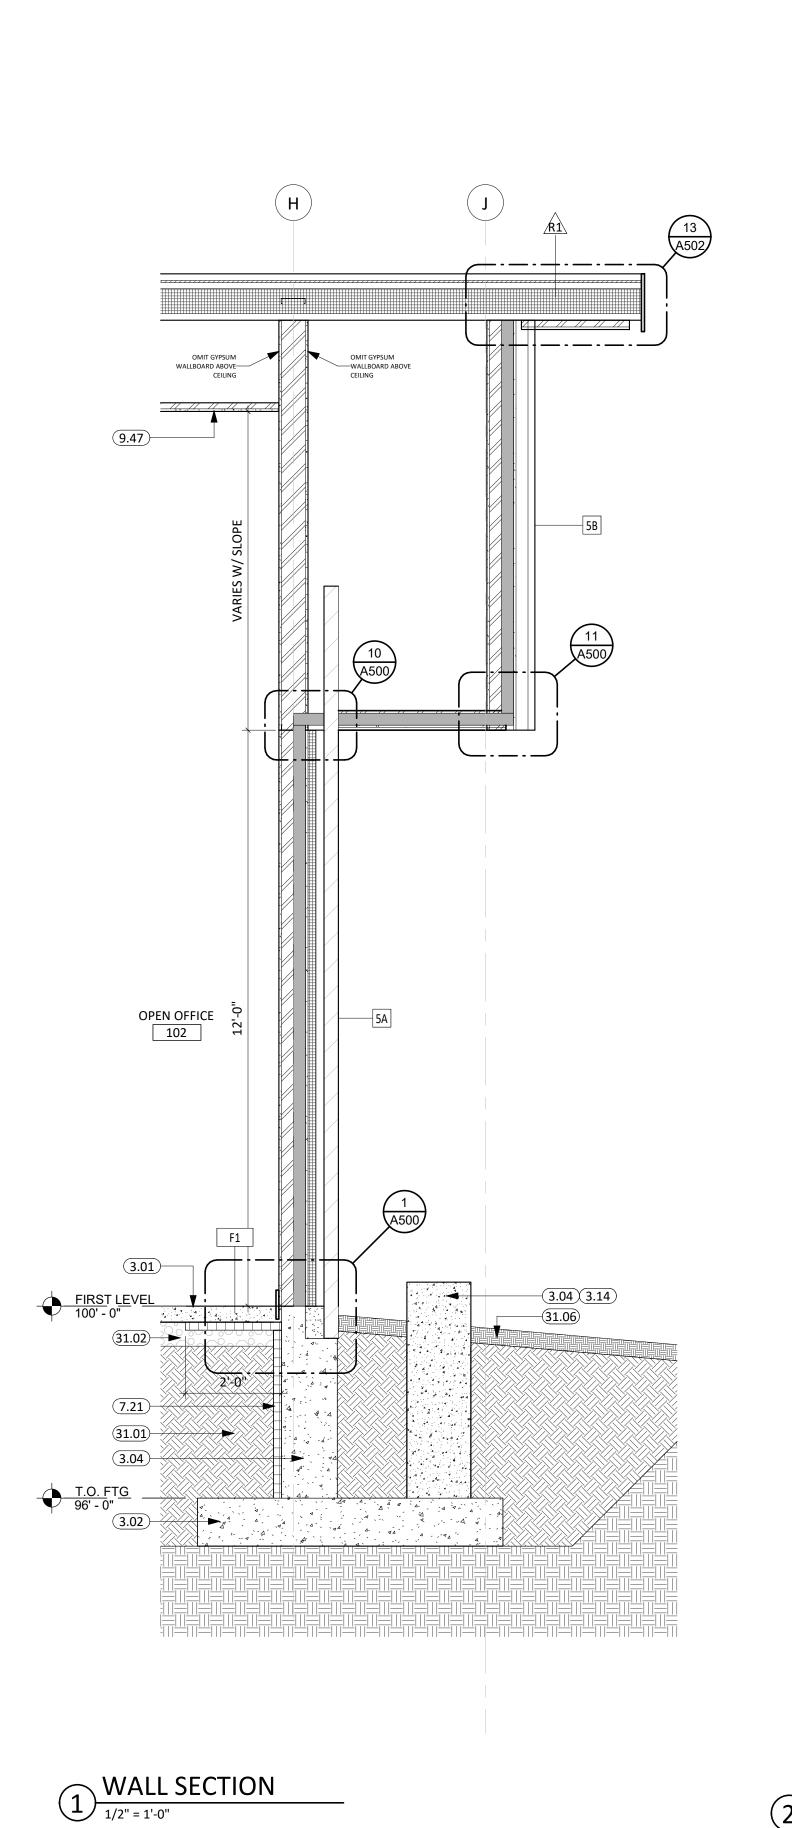WALL SECTION

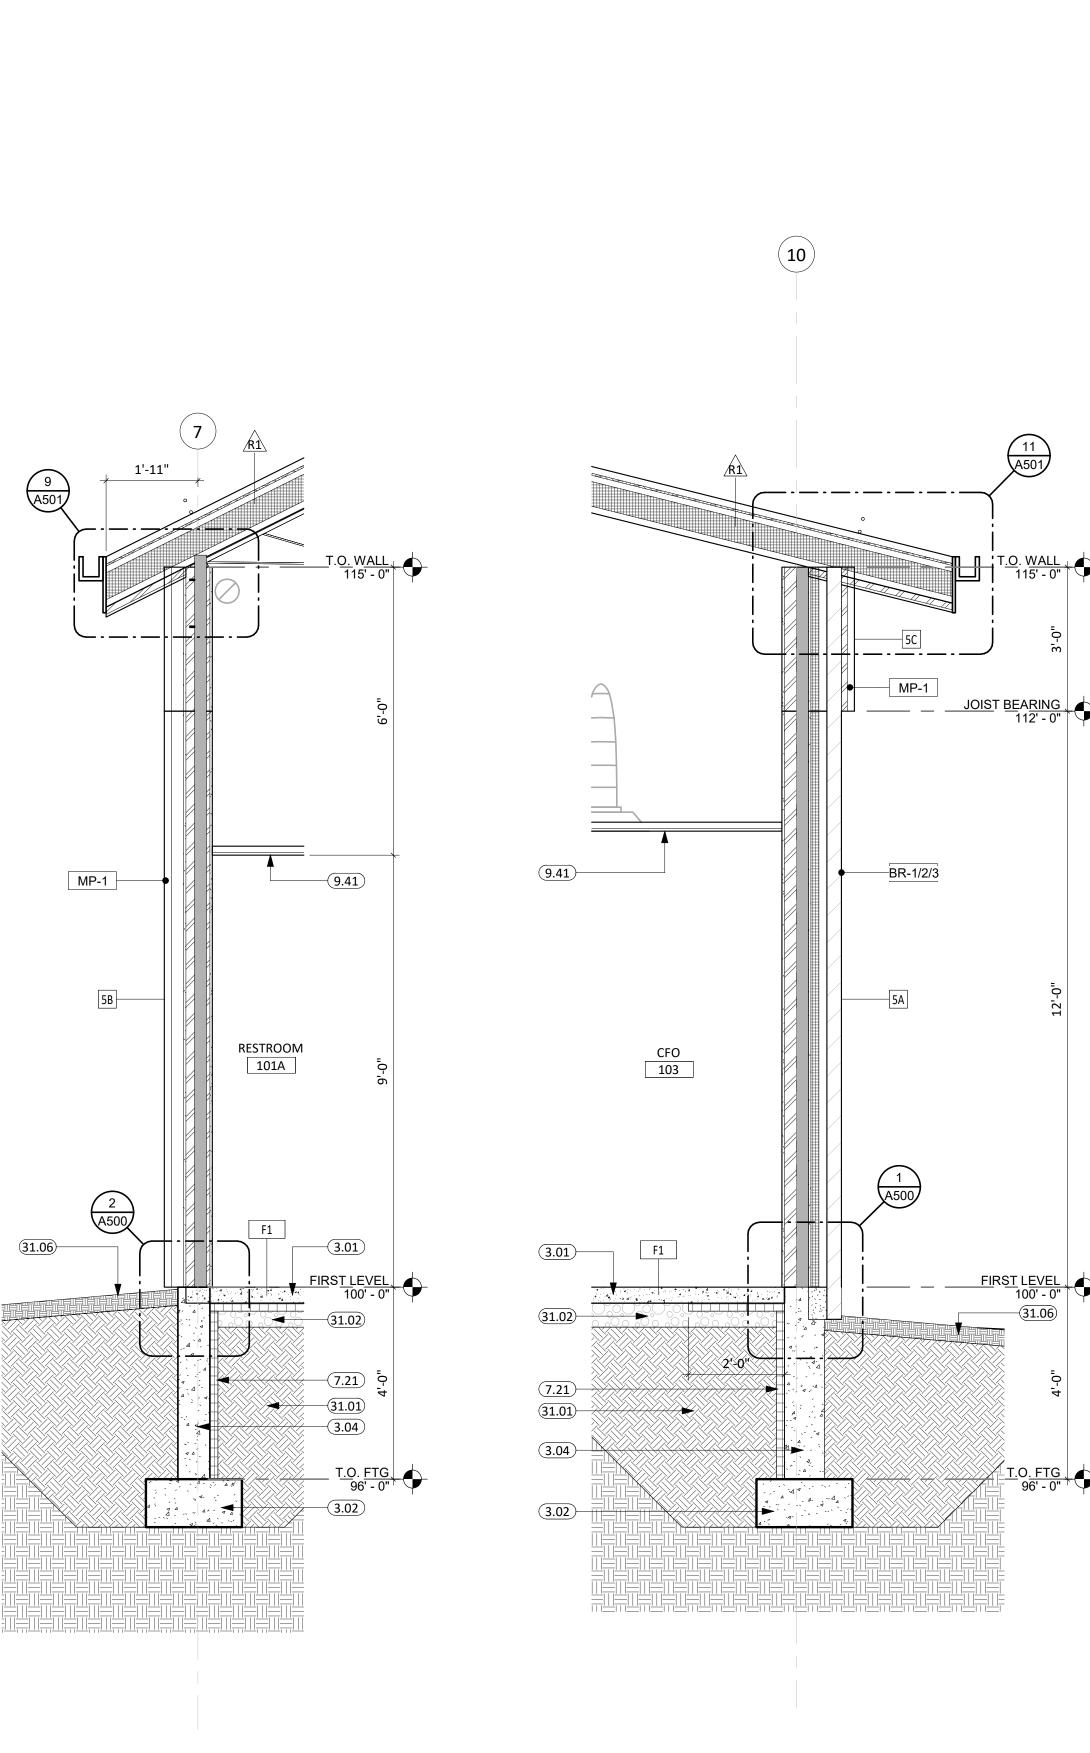1/2" = 1'-0"





5/15/2025 100% CONSTRUCTION DOCUMENTS

CO-OP PROJECT NO:

PROJECT: NORTHERN ELECTRIC NORTHERN ELECTRIC COOPERATIVE BATH, SOUTH DAKOTA


SHEET TITLE: WALL SECTIONS

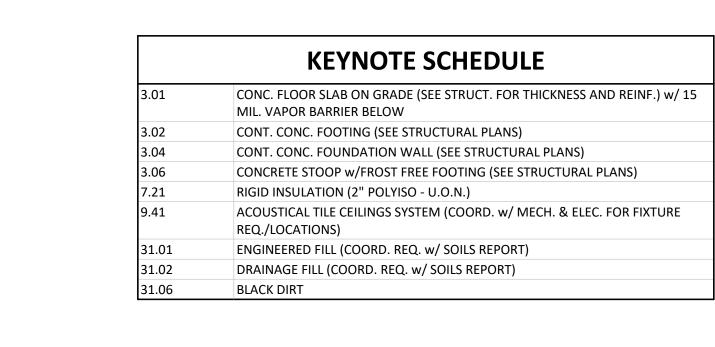


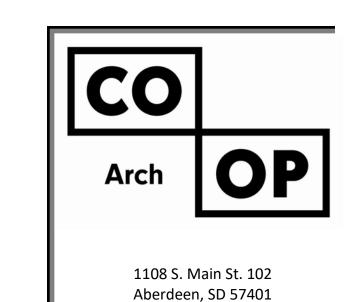



Phone: 605-725-4852

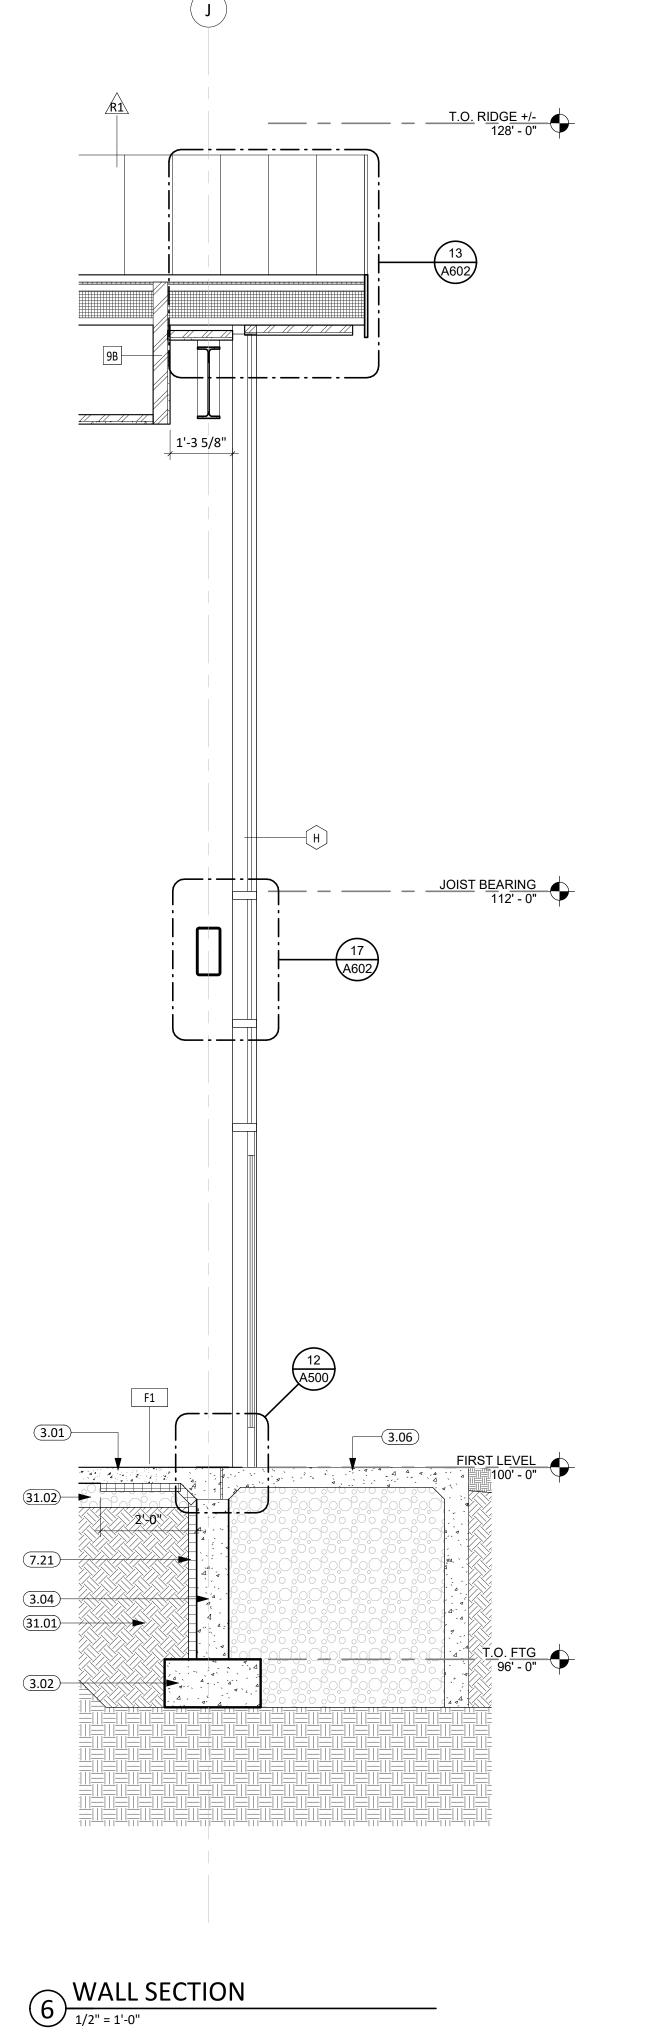


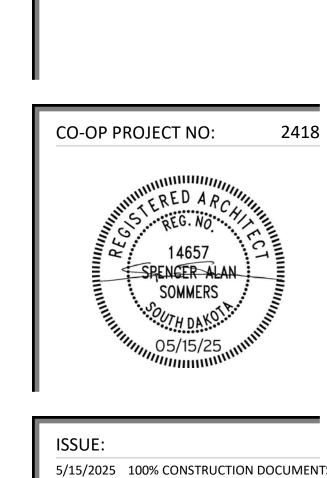


5/15/2025 100% CONSTRUCTION DOCUMENTS

PROJECT: NORTHERN ELECTRIC NORTHERN ELECTRIC COOPERATIVE BATH, SOUTH DAKOTA

SHEET TITLE: WALL SECTIONS

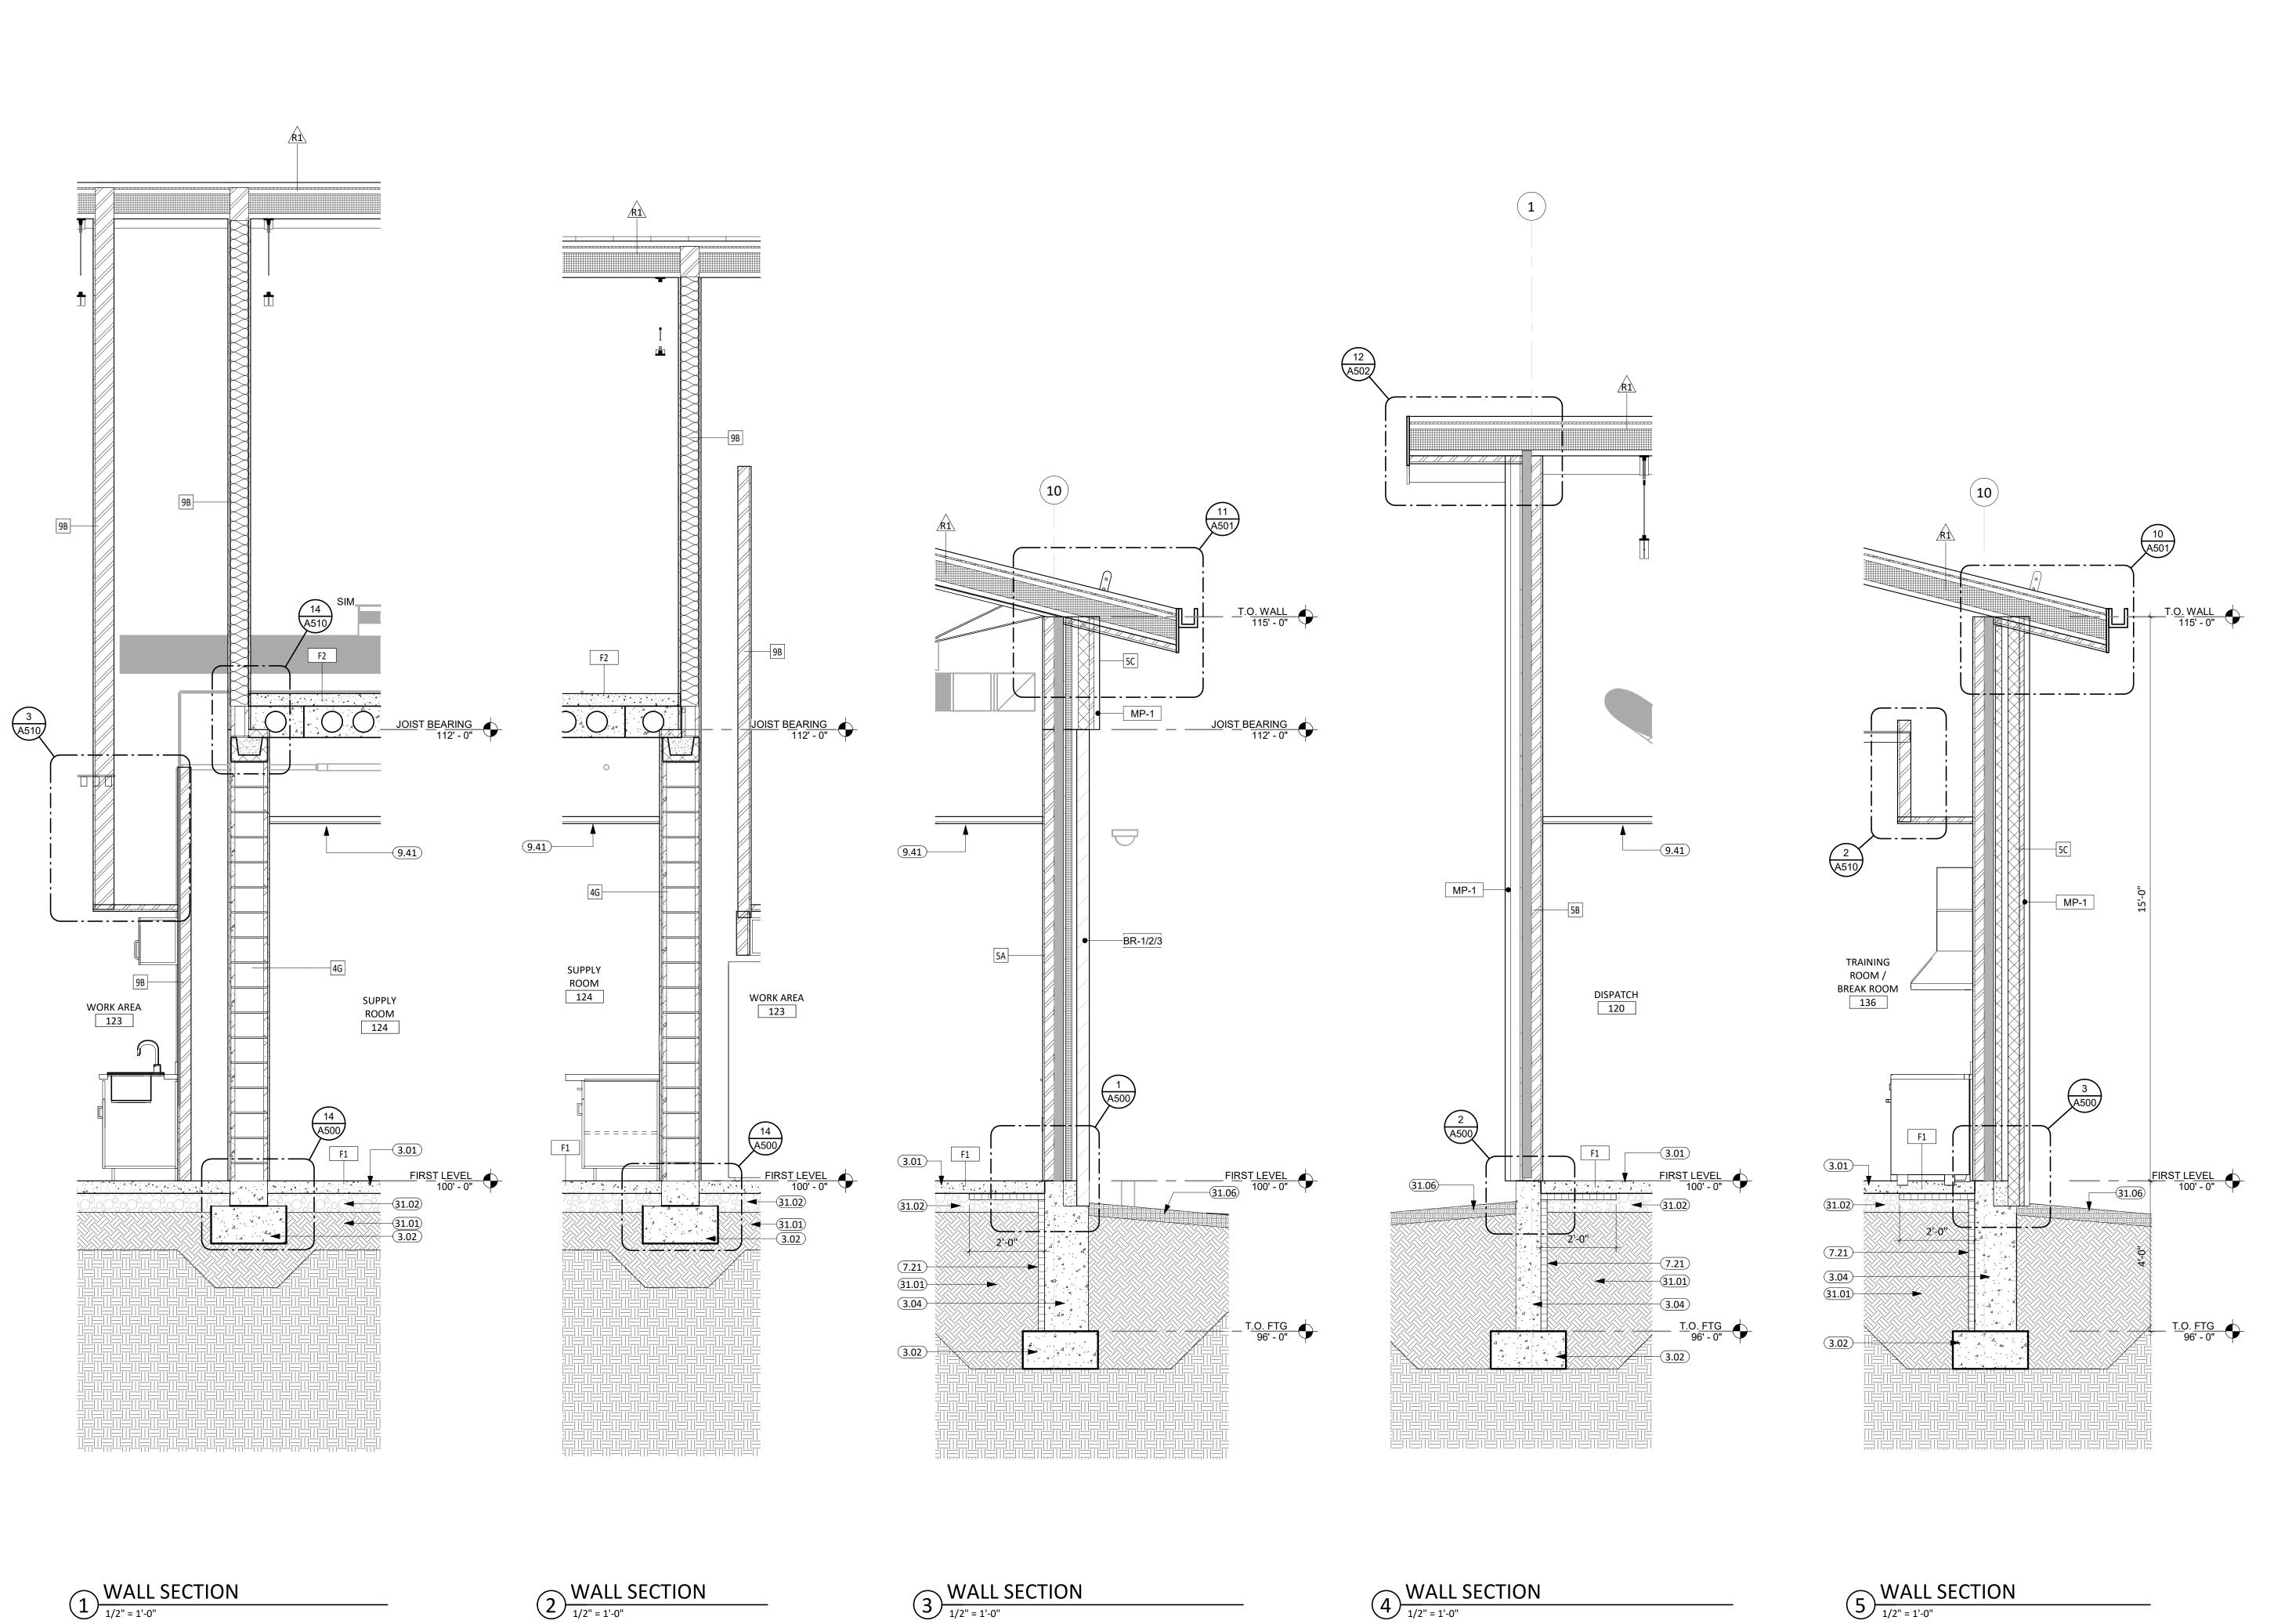

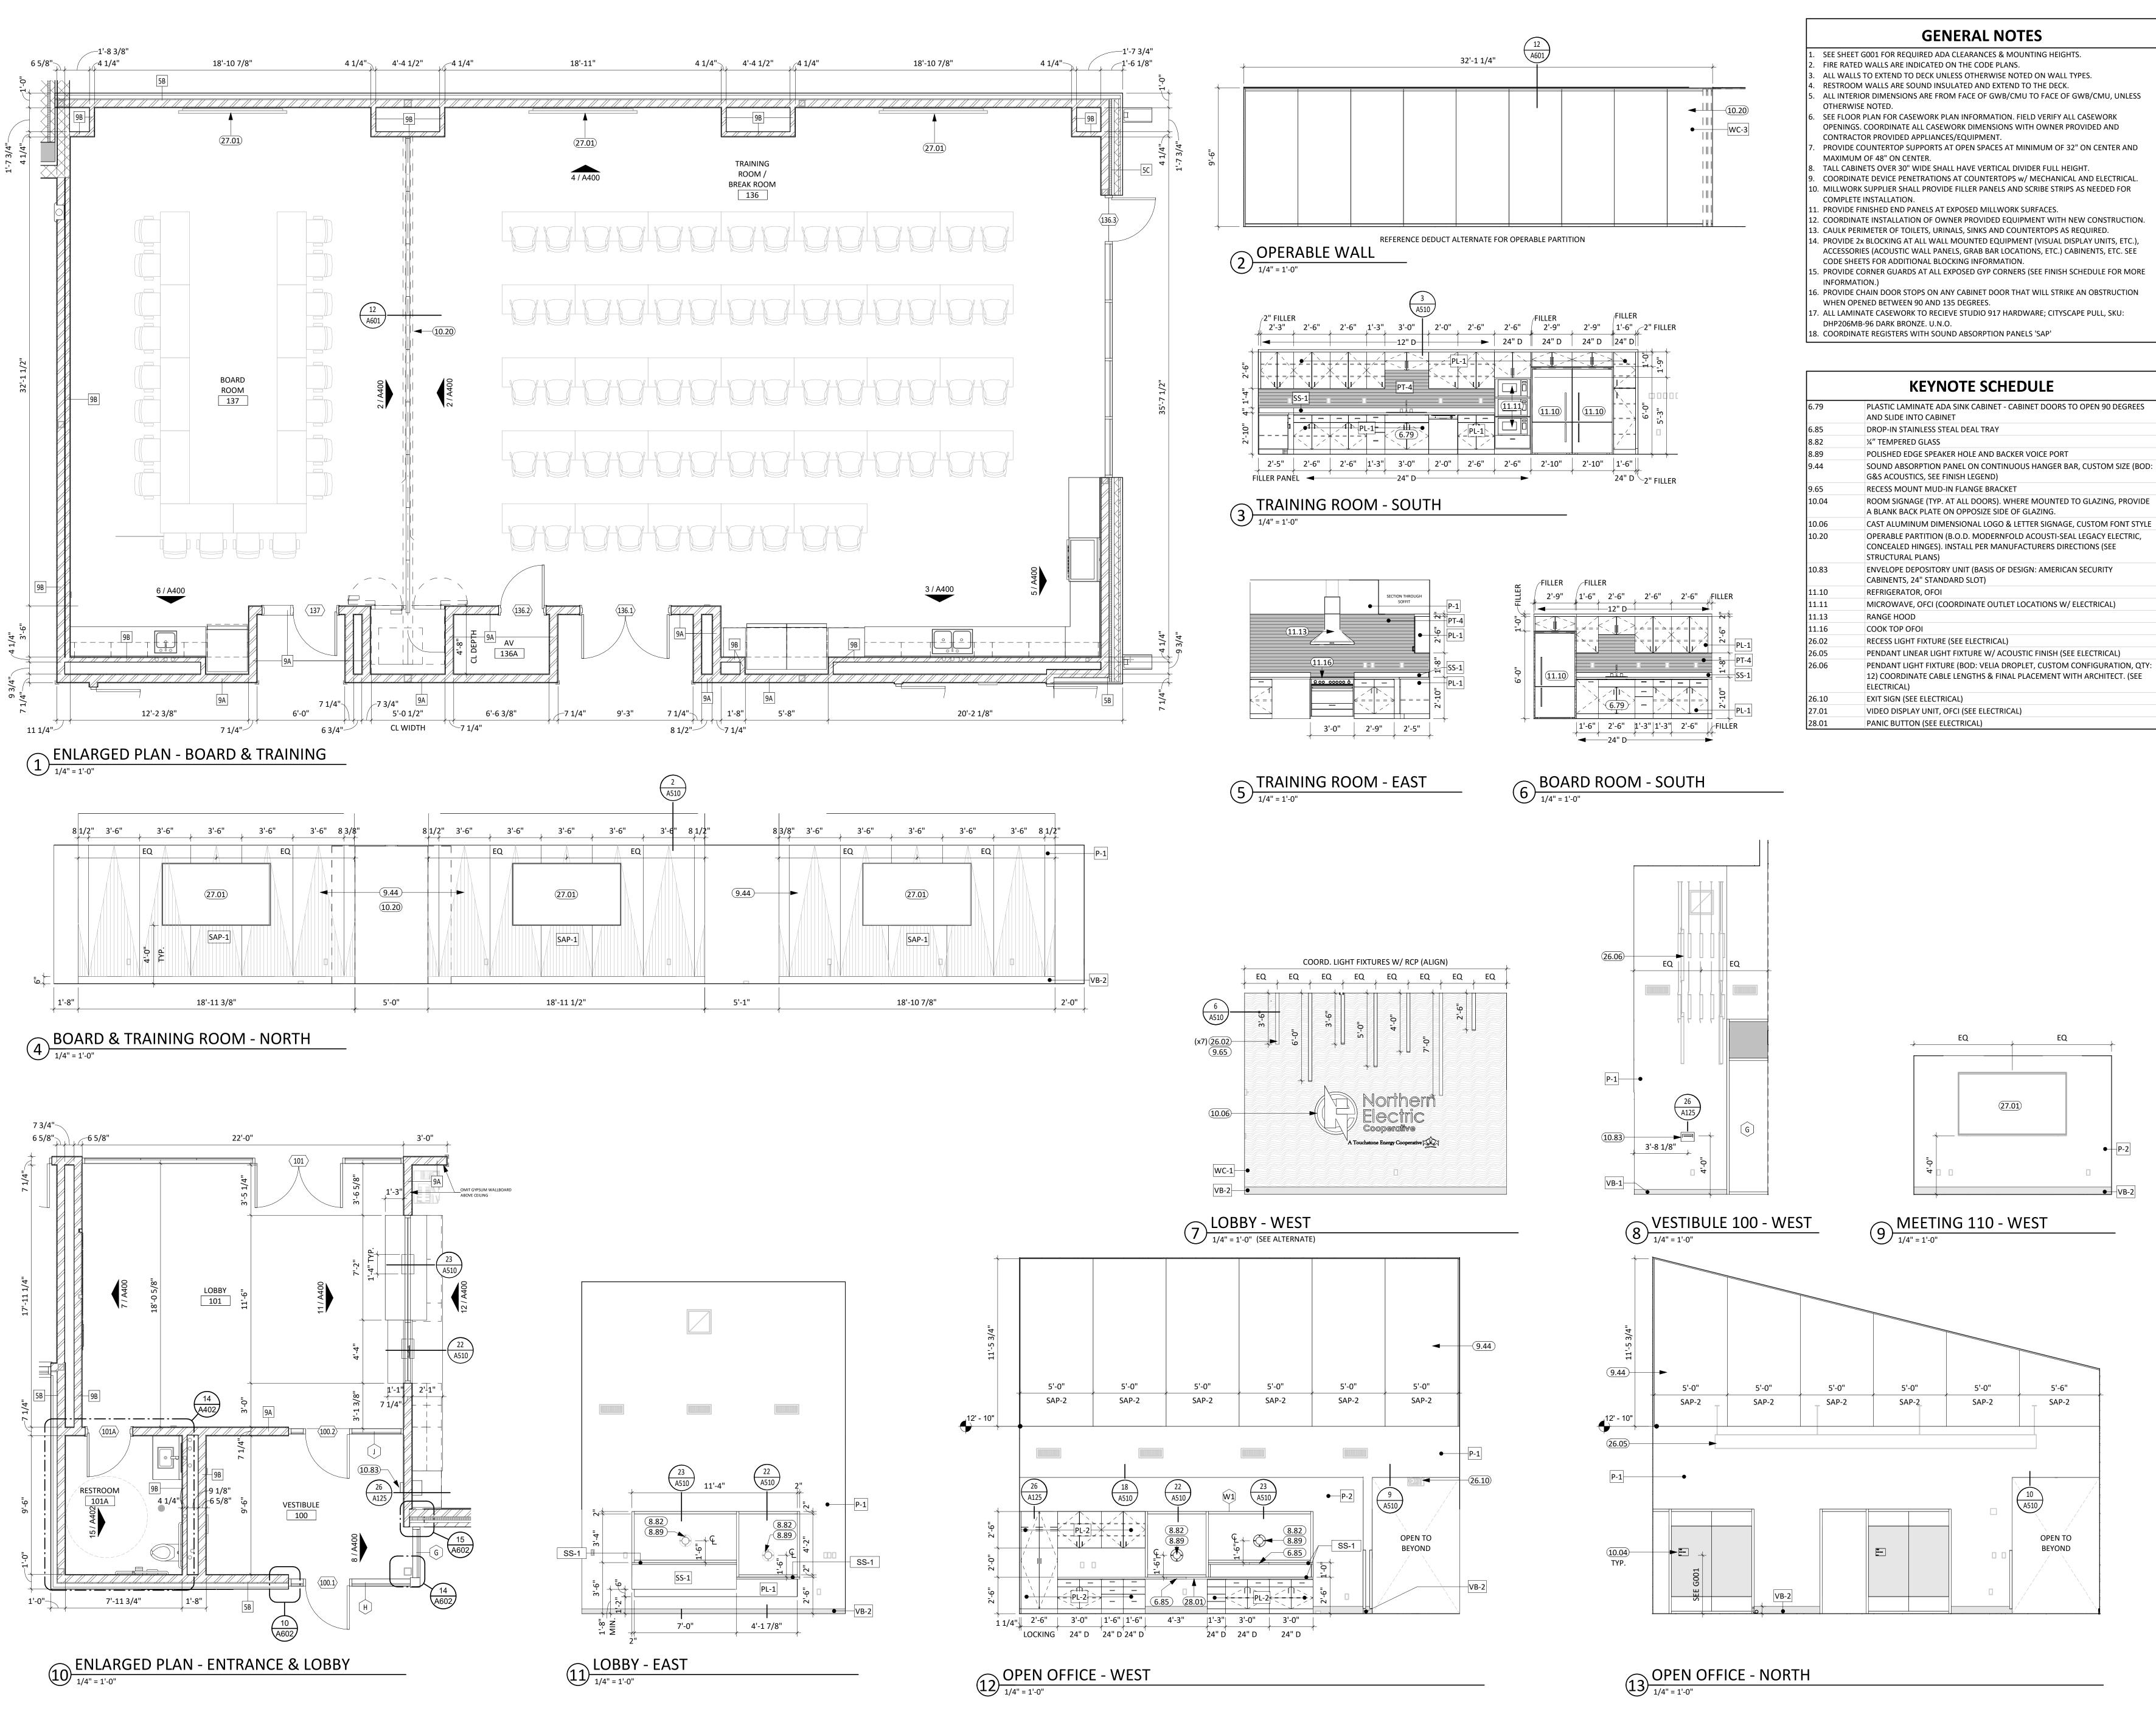


1108 S. Main St. 102 Aberdeen, SD 57401

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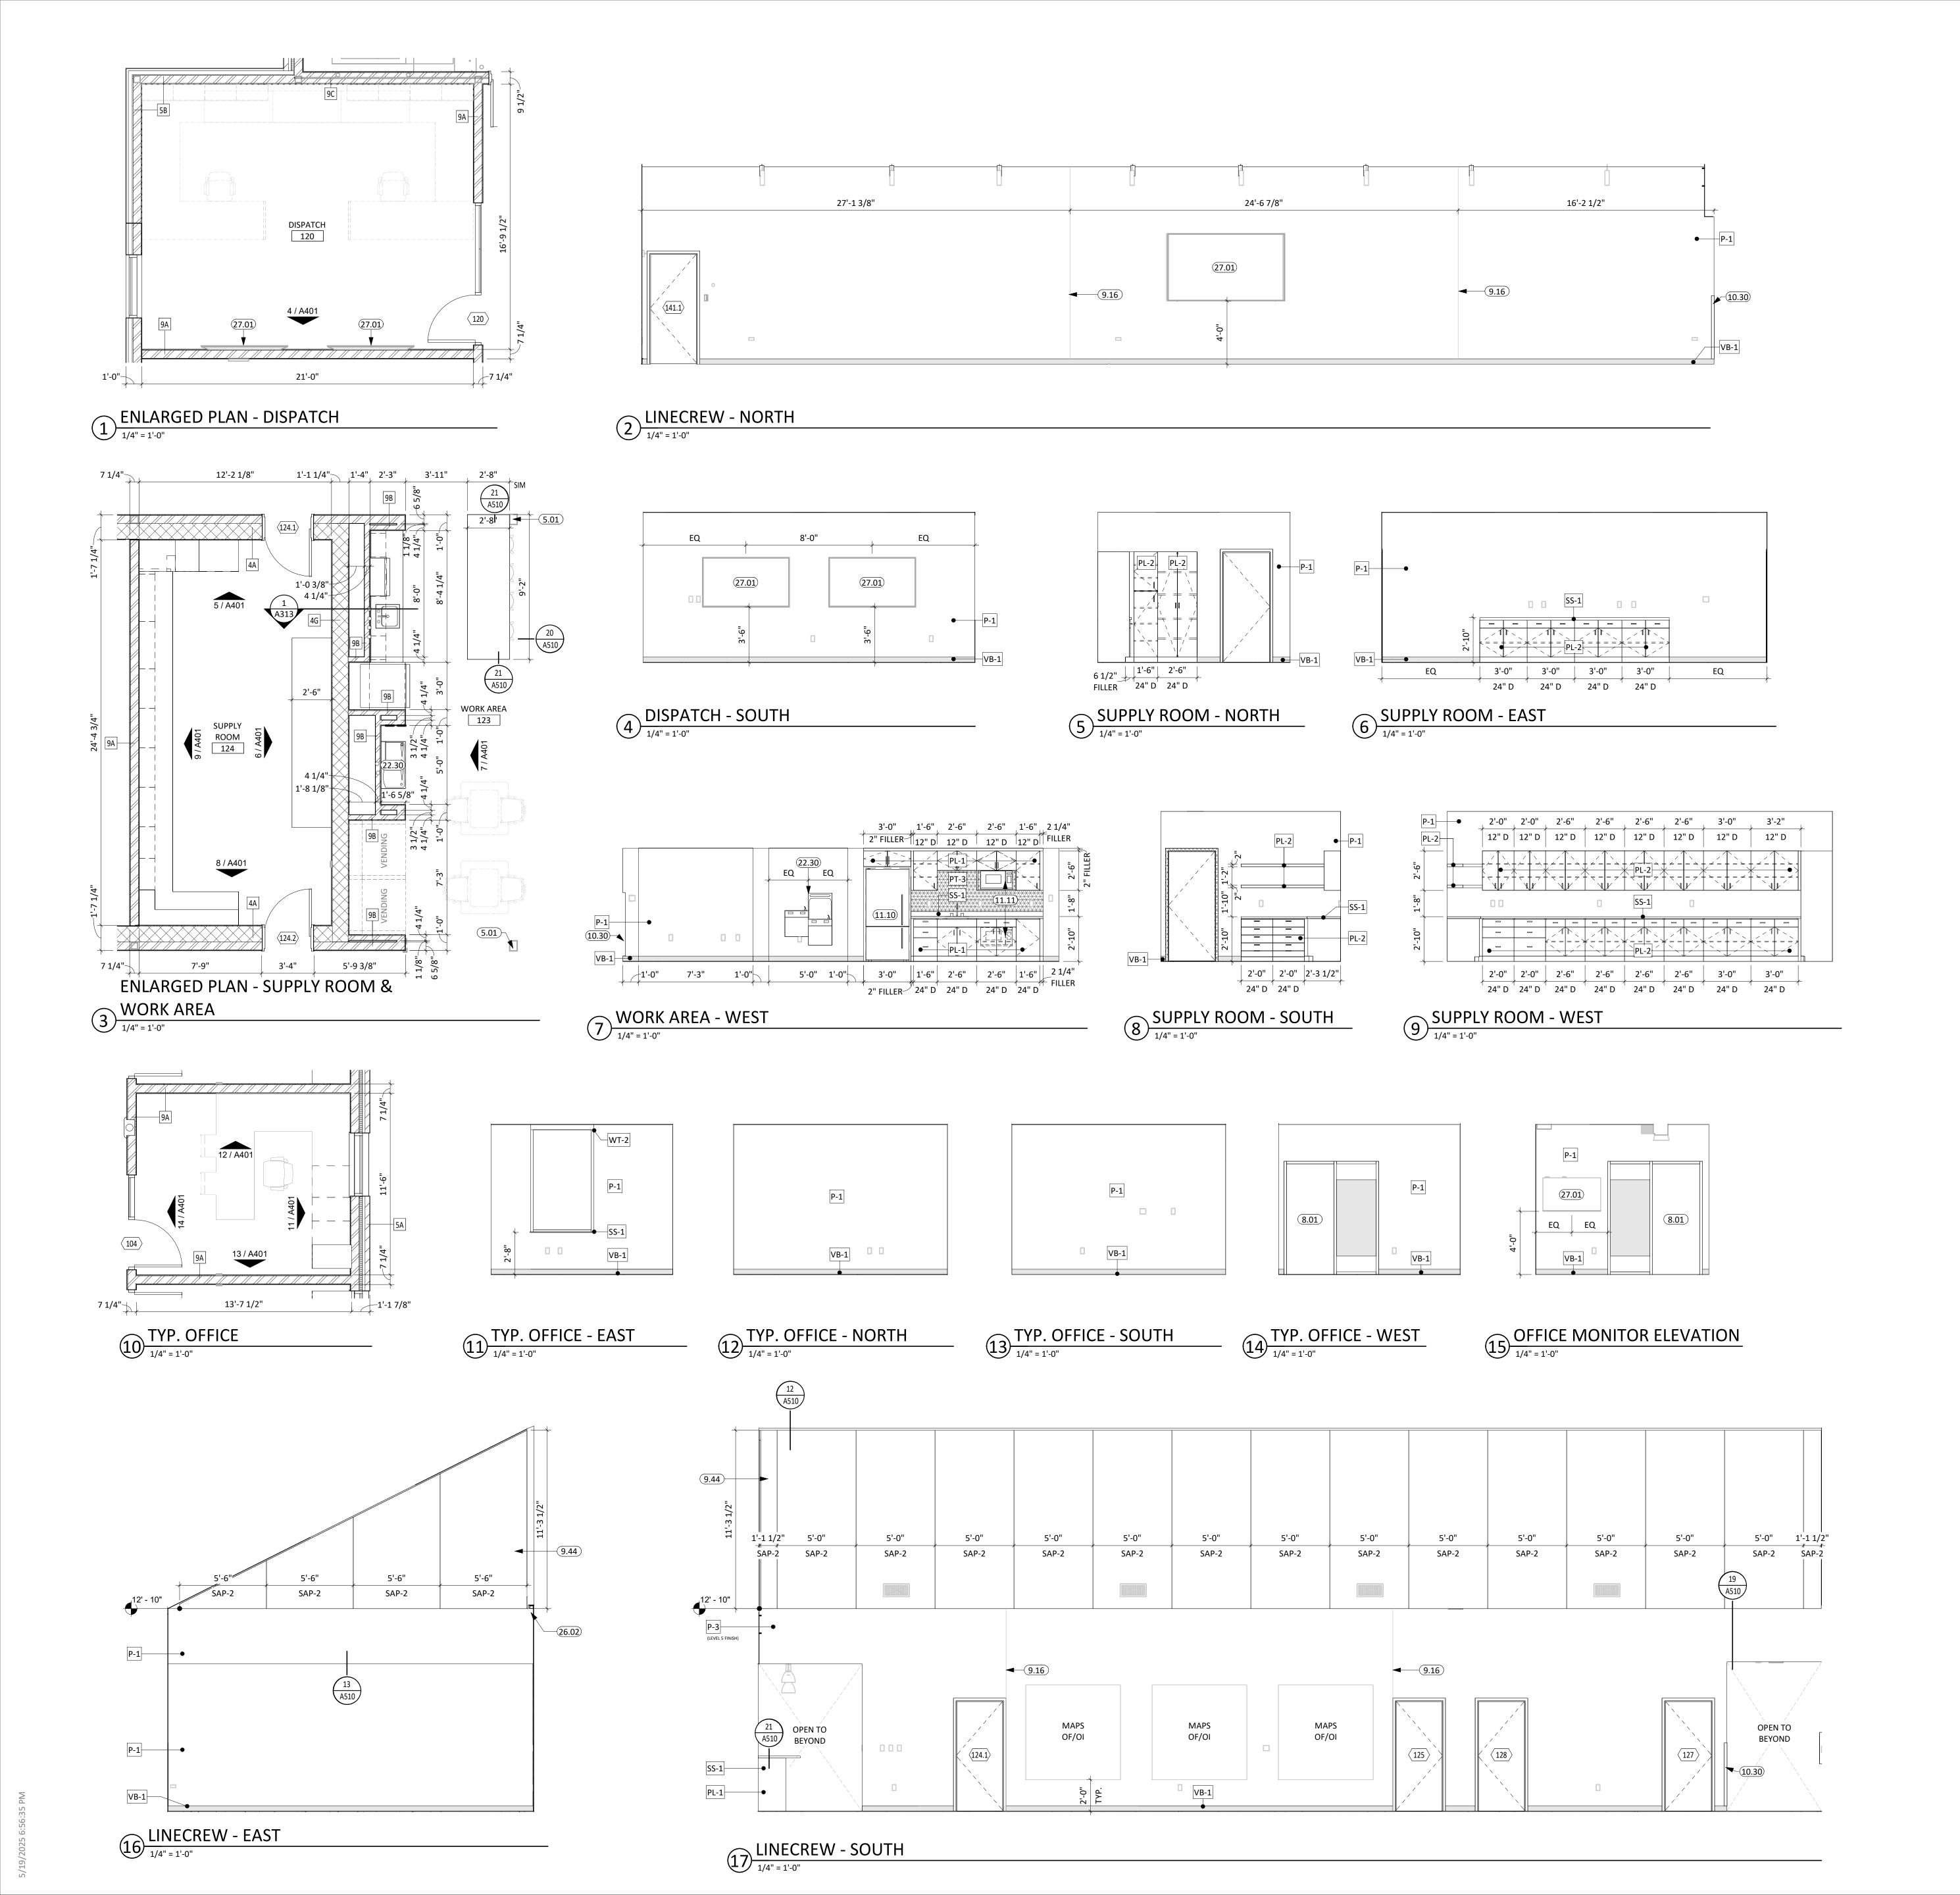


CO-OP PROJECT NO: SPENCER ALAN

5/15/2025 100% CONSTRUCTION DOCUMENTS **REVISION SCHEDULE:** REV. # REV. DSC.

PROJECT: NORTHERN ELECTRIC NORTHERN ELECTRIC COOPERATIVE BATH, SOUTH DAKOTA

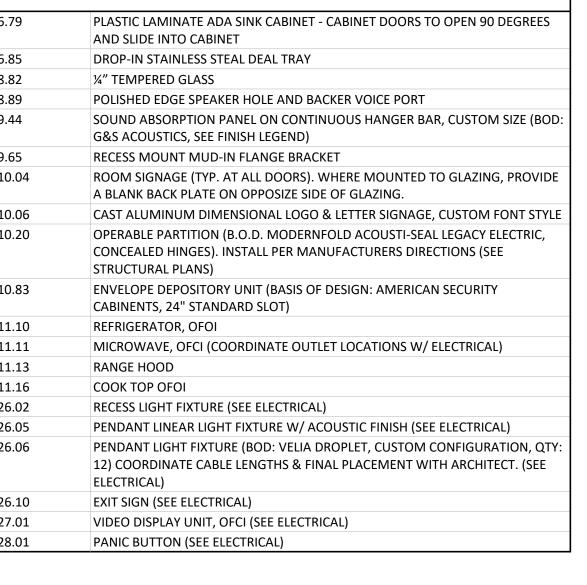SHEET TITLE: ENLARGED PLANS & ELEVATIONS



- . SEE SHEET G001 FOR REQUIRED ADA CLEARANCES & MOUNTING HEIGHTS. FIRE RATED WALLS ARE INDICATED ON THE CODE PLANS.
- ALL WALLS TO EXTEND TO DECK UNLESS OTHERWISE NOTED ON WALL TYPES. RESTROOM WALLS ARE SOUND INSULATED AND EXTEND TO THE DECK.
- ALL INTERIOR DIMENSIONS ARE FROM FACE OF GWB/CMU TO FACE OF GWB/CMU, UNLESS OTHERWISE NOTED.
- SEE FLOOR PLAN FOR CASEWORK PLAN INFORMATION. FIELD VERIFY ALL CASEWORK OPENINGS. COORDINATE ALL CASEWORK DIMENSIONS WITH OWNER PROVIDED AND
- CONTRACTOR PROVIDED APPLIANCES/EQUIPMENT. PROVIDE COUNTERTOP SUPPORTS AT OPEN SPACES AT MINIMUM OF 32" ON CENTER AND MAXIMUM OF 48" ON CENTER.
- TALL CABINETS OVER 30" WIDE SHALL HAVE VERTICAL DIVIDER FULL HEIGHT. COORDINATE DEVICE PENETRATIONS AT COUNTERTOPS w/ MECHANICAL AND ELECTRICAL. D. MILLWORK SUPPLIER SHALL PROVIDE FILLER PANELS AND SCRIBE STRIPS AS NEEDED FOR
- COMPLETE INSTALLATION. 11. PROVIDE FINISHED END PANELS AT EXPOSED MILLWORK SURFACES.
- 12. COORDINATE INSTALLATION OF OWNER PROVIDED EQUIPMENT WITH NEW CONSTRUCTION. 13. CAULK PERIMETER OF TOILETS, URINALS, SINKS AND COUNTERTOPS AS REQUIRED. 14. PROVIDE 2x BLOCKING AT ALL WALL MOUNTED EQUIPMENT (VISUAL DISPLAY UNITS, ETC.),
- ACCESSORIES (ACOUSTIC WALL PANELS, GRAB BAR LOCATIONS, ETC.) CABINENTS, ETC. SEE CODE SHEETS FOR ADDITIONAL BLOCKING INFORMATION. 5. PROVIDE CORNER GUARDS AT ALL EXPOSED GYP CORNERS (SEE FINISH SCHEDULE FOR MORE
- 16. PROVIDE CHAIN DOOR STOPS ON ANY CABINET DOOR THAT WILL STRIKE AN OBSTRUCTION WHEN OPENED BETWEEN 90 AND 135 DEGREES.
- 17. ALL LAMINATE CASEWORK TO RECIEVE STUDIO 917 HARDWARE; CITYSCAPE PULL, SKU: DHP206MB-96 DARK BRONZE. U.N.O.
- 18. COORDINATE REGISTERS WITH SOUND ABSORPTION PANELS 'SAP'

KEYNOTE SCHEDULE

STRUCTURAL STEEL COLUMN (SEE ARCH. & STRUCT.) DOOR (SEE SCHED.)

SOUND ABSORPTION PANEL ON CONTINUOUS HANGER BAR, CUSTOM SIZE (BOD G&S ACOUSTICS, SEE FINISH LEGEND) **CORNER GUARDS**

INFORMATION.)

REFRIGERATOR, OFOI MICROWAVE, OFCI (COORDINATE OUTLET LOCATIONS W/ ELECTRICAL)

VIDEO DISPLAY UNIT, OFCI (SEE ELECTRICAL)

ELECTRIC WATER COOLER

CONTROL JOINT

RECESS LIGHT FIXTURE (SEE ELECTRICAL)

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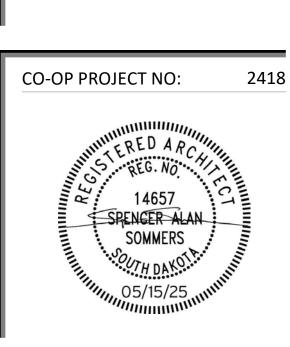
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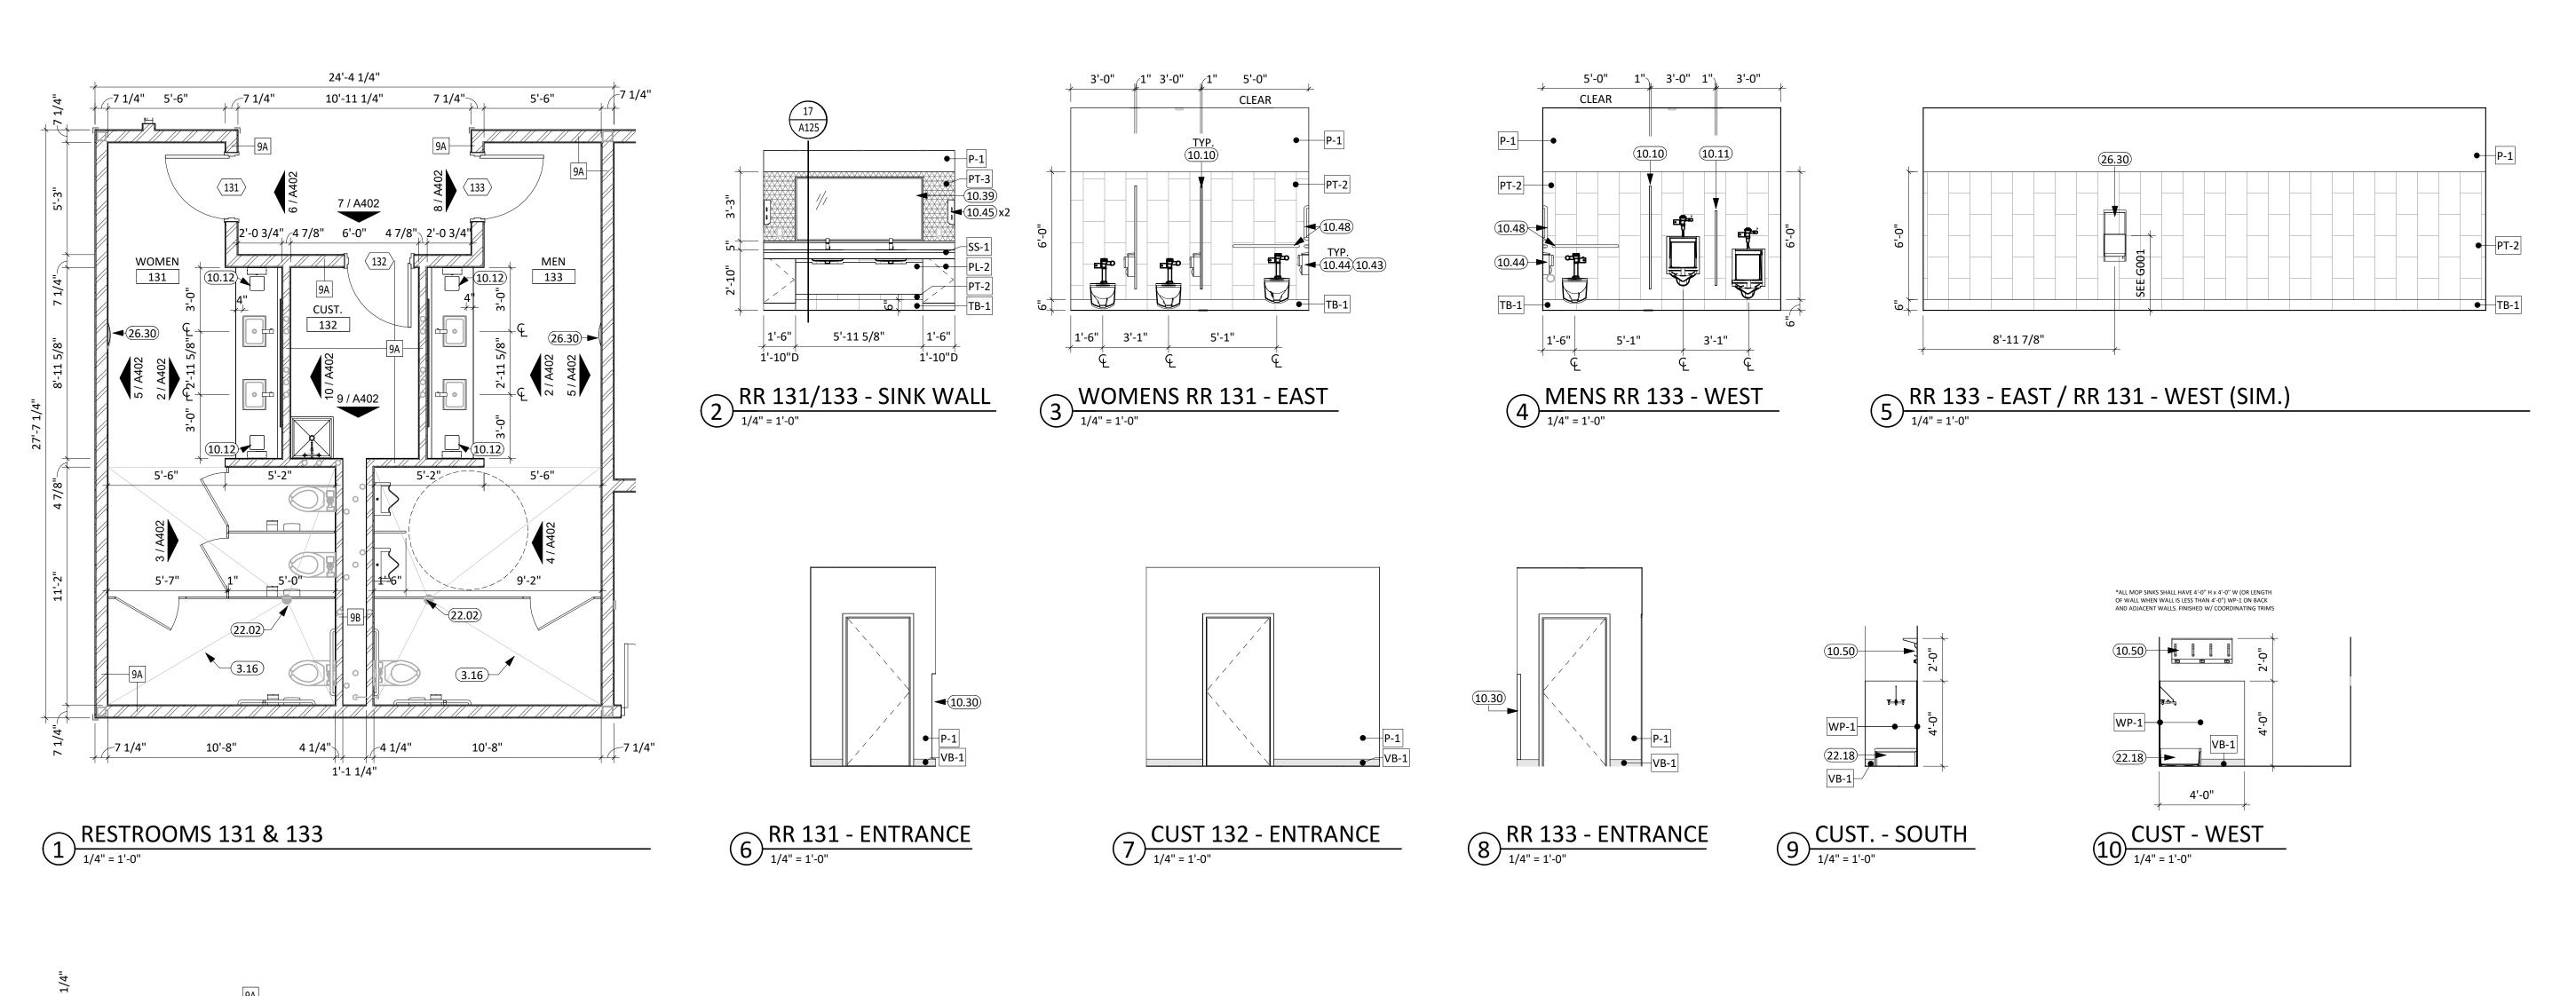
REV. # REV. DSC.


PROJECT: NORTHERN ELECTRIC NORTHERN ELECTRIC COOPERATIVE


SHEET TITLE:

BATH, SOUTH DAKOTA

ENLARGED PLANS & ELEVATIONS



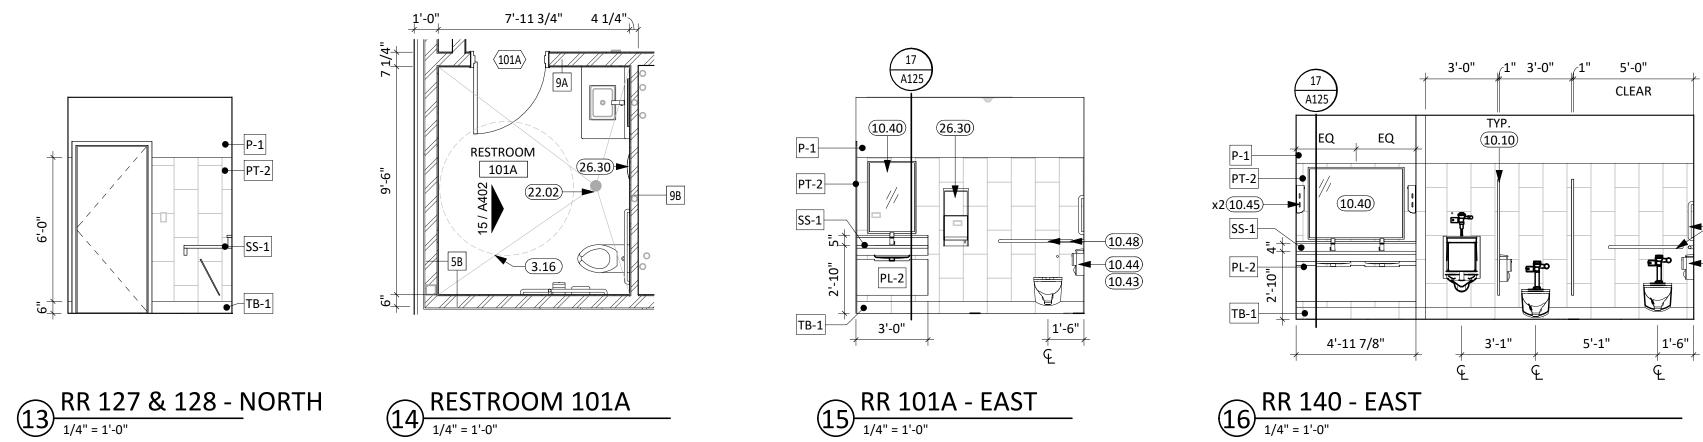


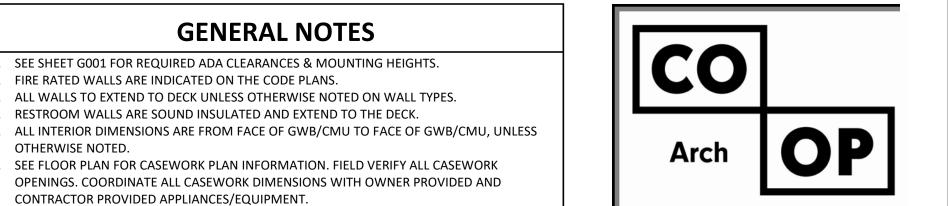

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PROVIDE COUNTERTOP SUPPORTS AT OPEN SPACES AT MINIMUM OF 32" ON CENTER AND

COORDINATE DEVICE PENETRATIONS AT COUNTERTOPS w/ MECHANICAL AND ELECTRICAL.

D. MILLWORK SUPPLIER SHALL PROVIDE FILLER PANELS AND SCRIBE STRIPS AS NEEDED FOR

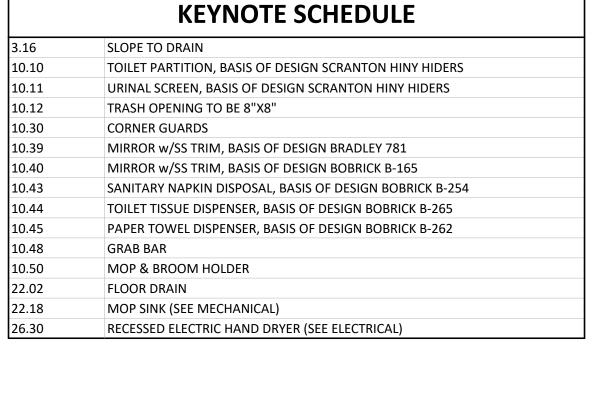12. COORDINATE INSTALLATION OF OWNER PROVIDED EQUIPMENT WITH NEW CONSTRUCTION.

14. PROVIDE 2x BLOCKING AT ALL WALL MOUNTED EQUIPMENT (VISUAL DISPLAY UNITS, ETC.),

ACCESSORIES (ACOUSTIC WALL PANELS, GRAB BAR LOCATIONS, ETC.) CABINENTS, ETC. SEE

5. PROVIDE CORNER GUARDS AT ALL EXPOSED GYP CORNERS (SEE FINISH SCHEDULE FOR MORE

16. PROVIDE CHAIN DOOR STOPS ON ANY CABINET DOOR THAT WILL STRIKE AN OBSTRUCTION

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11. PROVIDE FINISHED END PANELS AT EXPOSED MILLWORK SURFACES.

CODE SHEETS FOR ADDITIONAL BLOCKING INFORMATION.

18. COORDINATE REGISTERS WITH SOUND ABSORPTION PANELS 'SAP'

WHEN OPENED BETWEEN 90 AND 135 DEGREES.


DHP206MB-96 DARK BRONZE. U.N.O.

OTHERWISE NOTED.

MAXIMUM OF 48" ON CENTER.

COMPLETE INSTALLATION.

INFORMATION.)

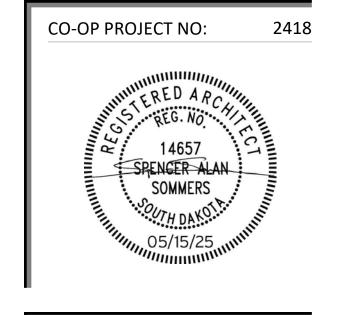


5/15/2025 100% CONSTRUCTION DOCUMENTS

REVISION SCHEDULE:

PROJECT: NORTHERN ELECTRIC NORTHERN ELECTRIC COOPERATIVE BATH, SOUTH DAKOTA

SHEET TITLE:

ENLARGED PLANS & ELEVATIONS

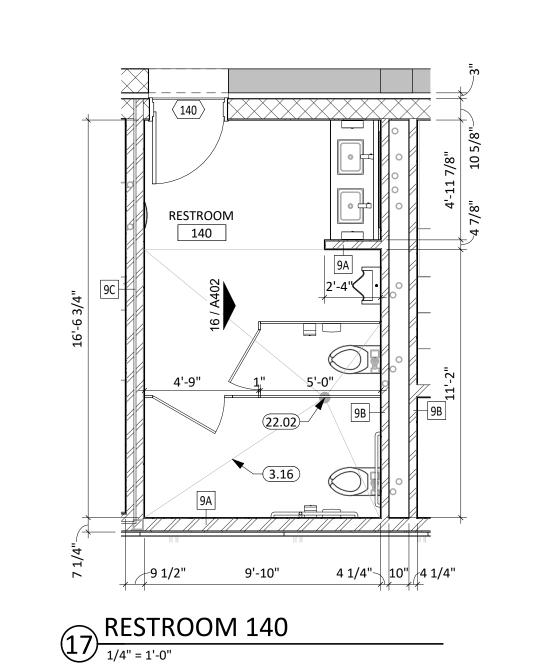


4 1/4" 1'-1 1/2" 4 1/4"

RR 127 & 128 SINK WALL

1/4" = 1'-0"

RESTROOMS 127 &128

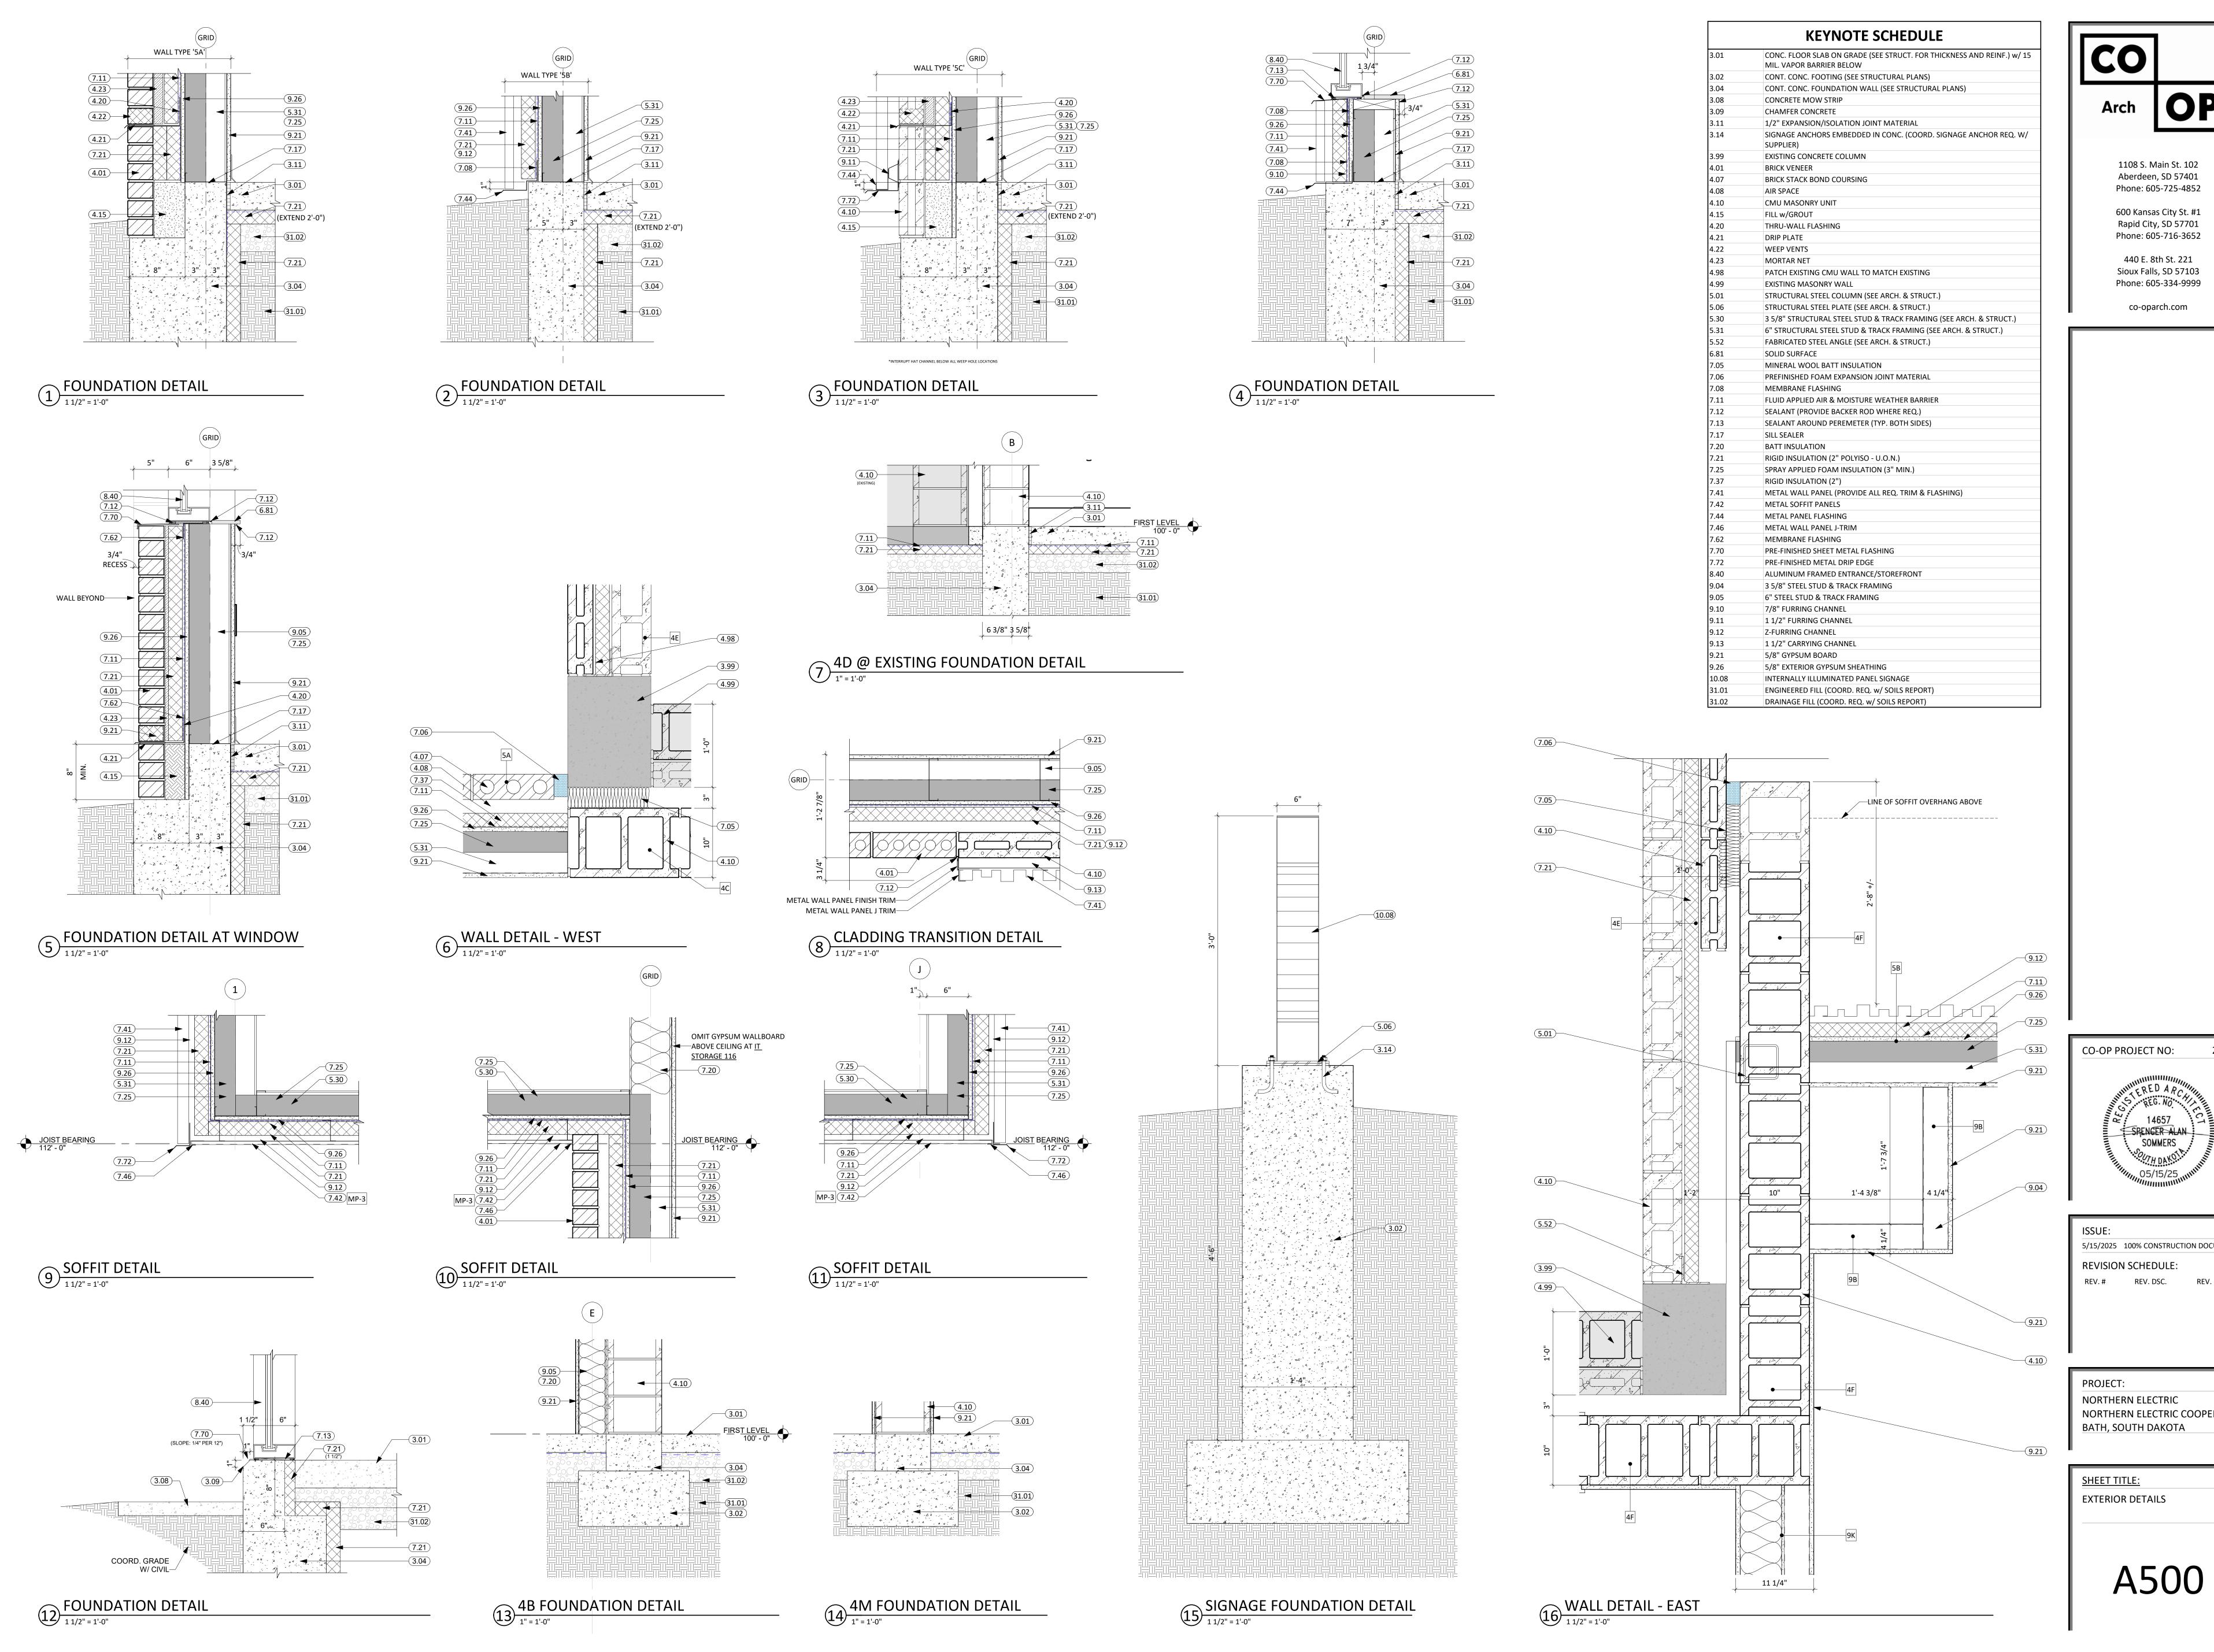

600 Kansas City St. #1


440 E. 8th St. 221 Sioux Falls, SD 57103 Phone: 605-334-9999


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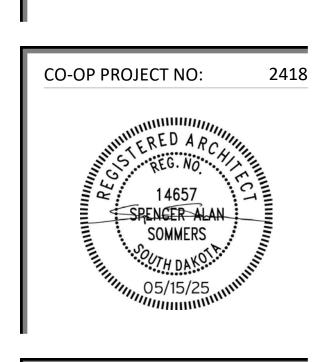
SPENCER ALAN

5/15/2025 100% CONSTRUCTION DOCUMENTS REV. DATE

NORTHERN ELECTRIC NORTHERN ELECTRIC COOPERATIVE



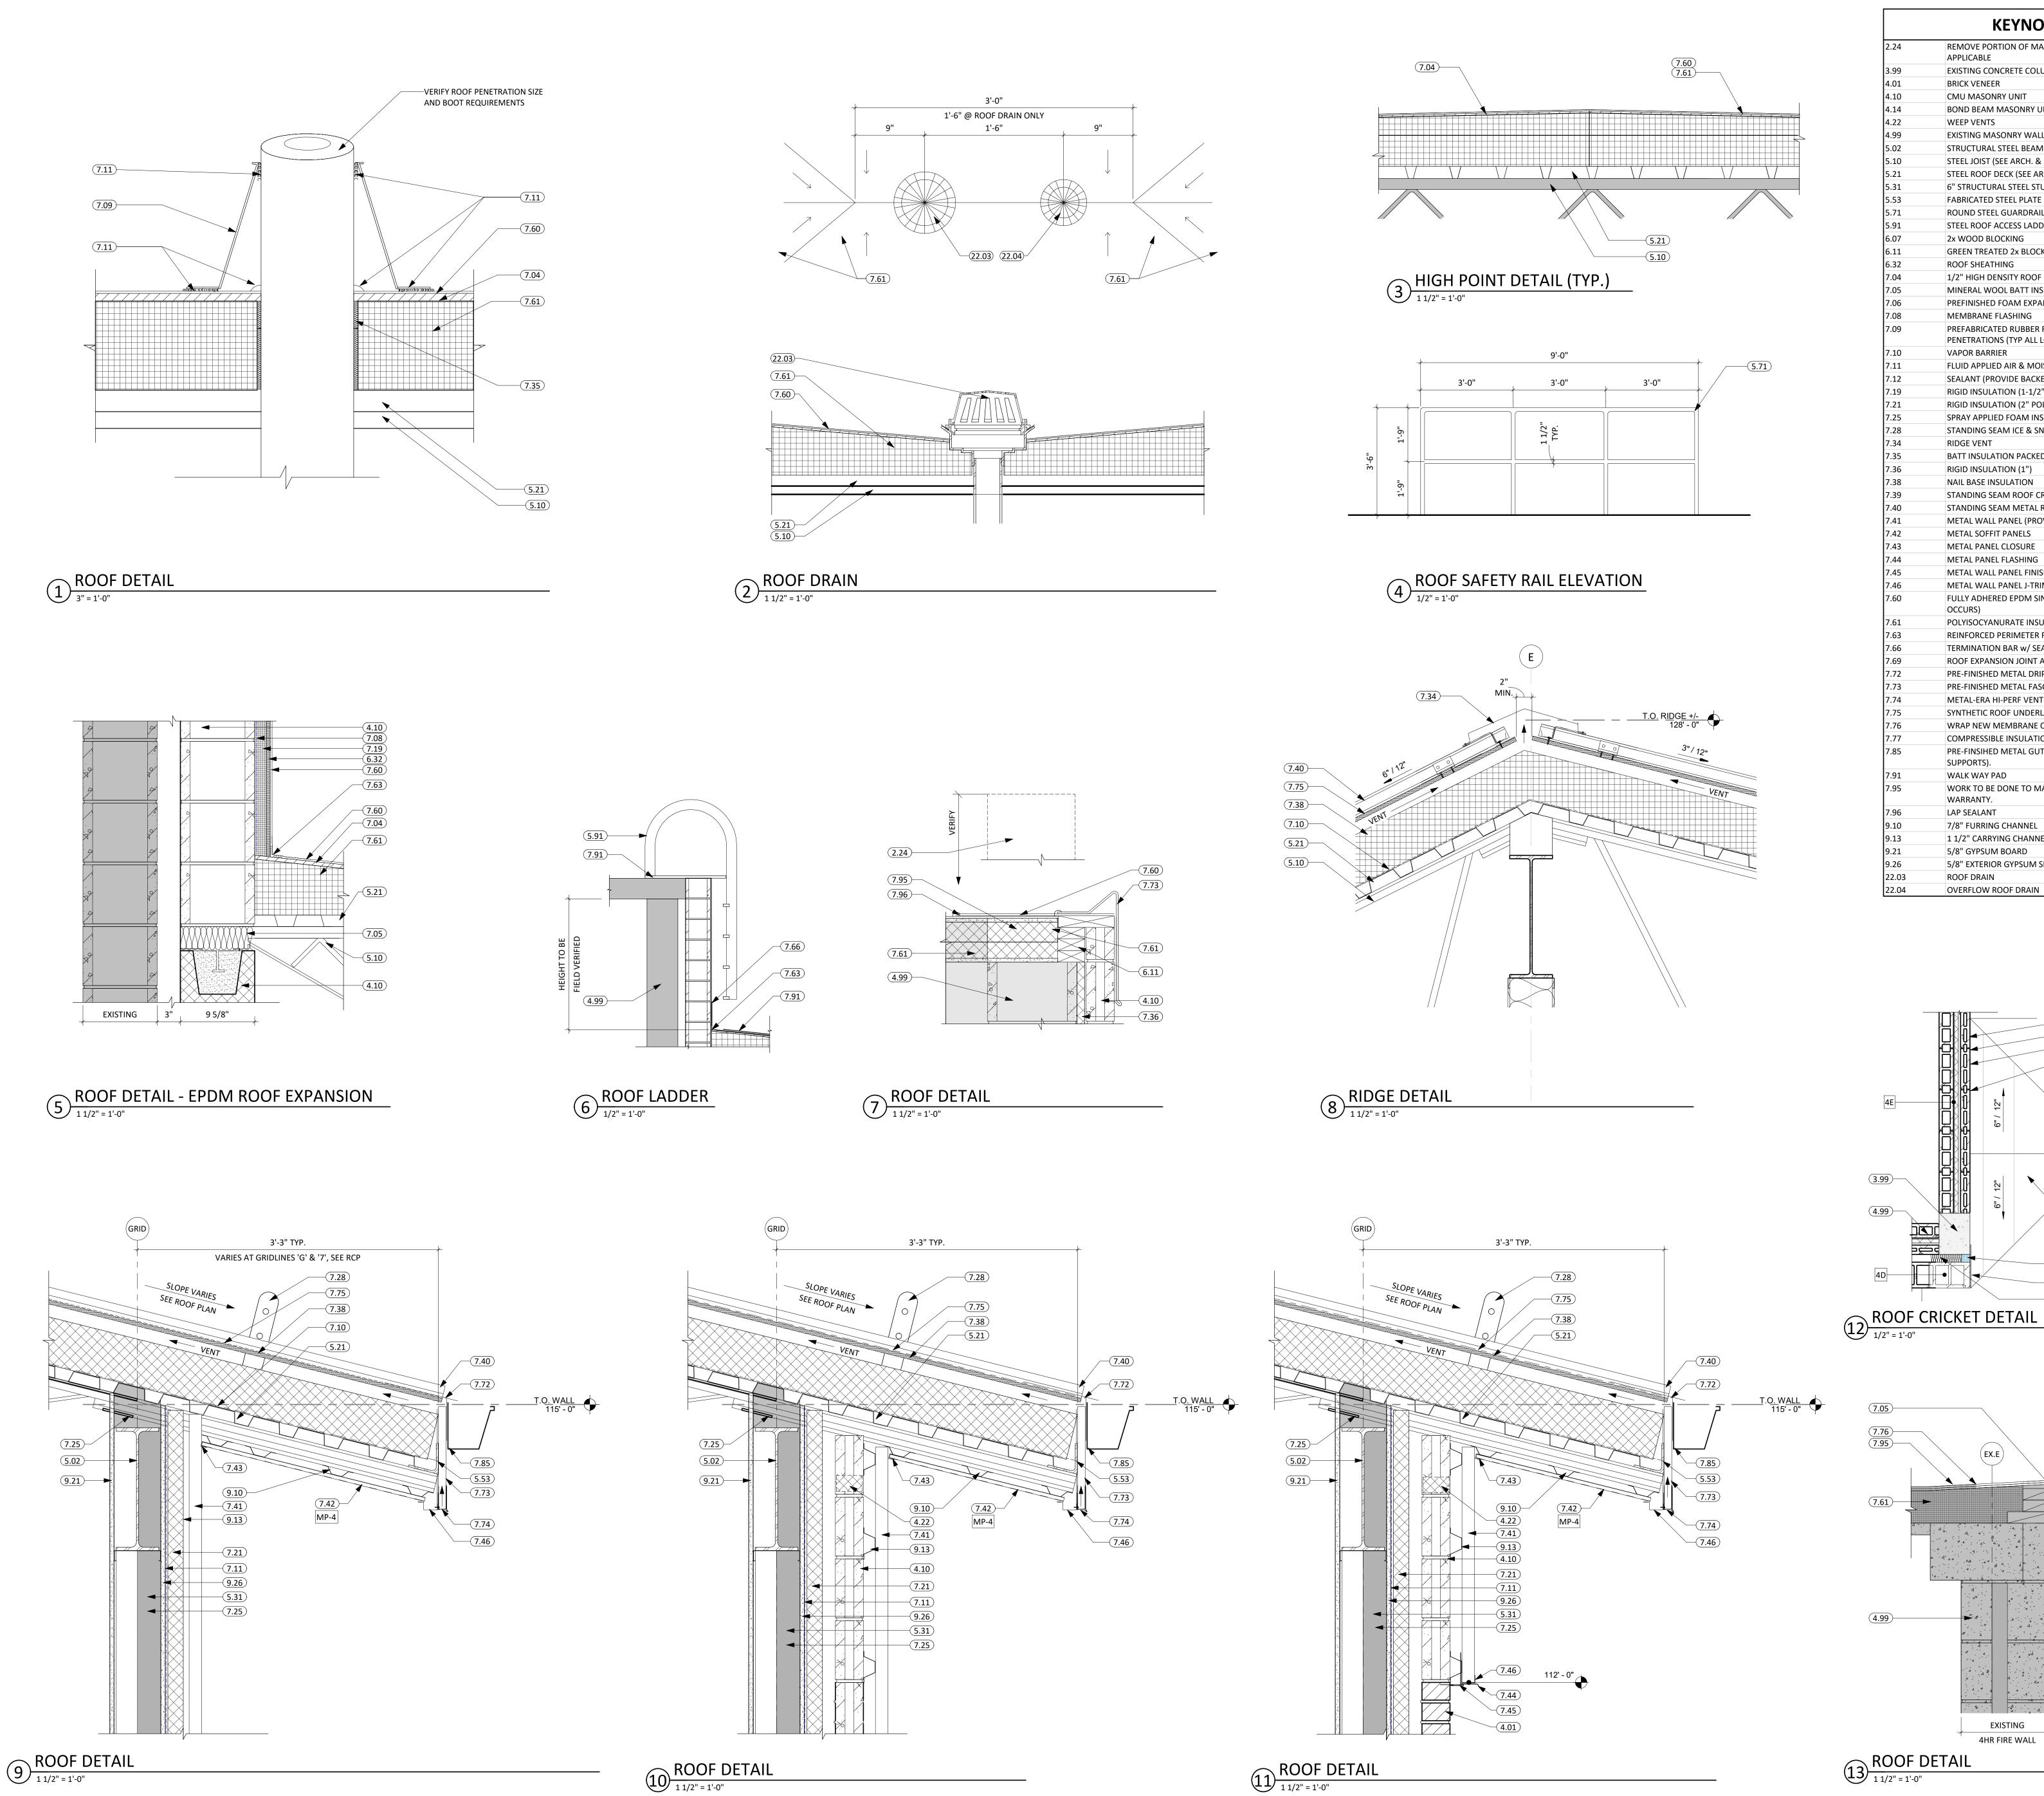

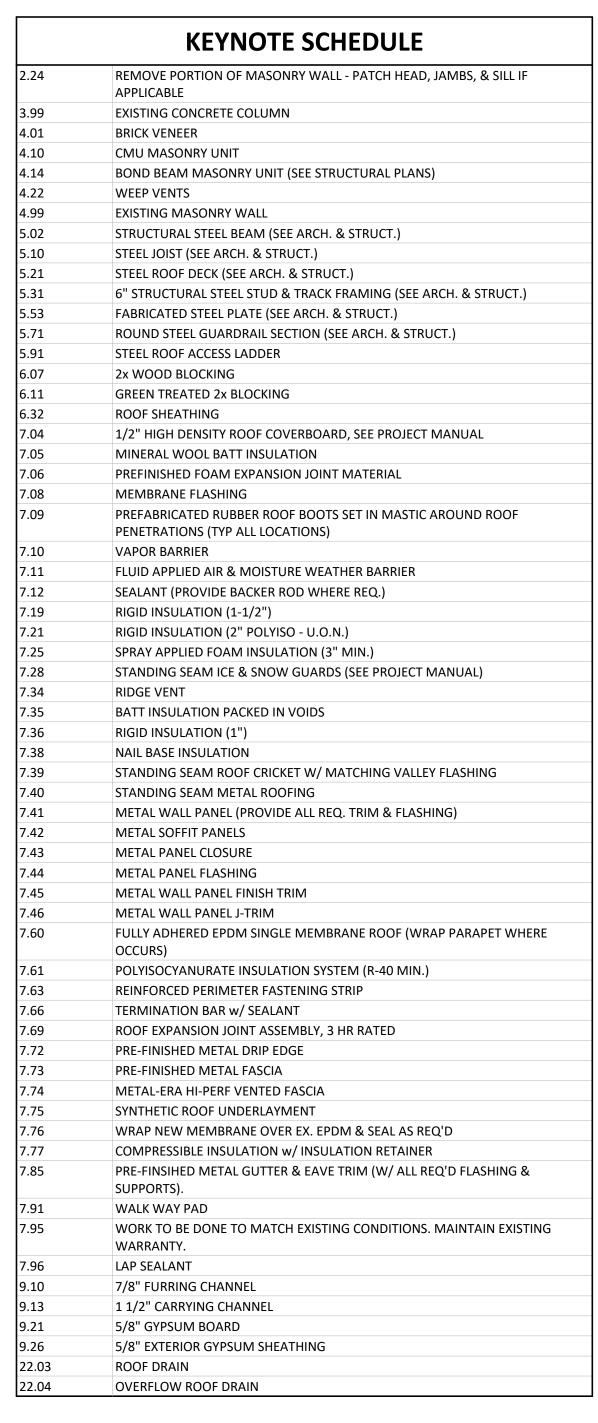

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5/15/2025 100% CONSTRUCTION DOCUMENTS **REVISION SCHEDULE:** REV. DATE REV. # REV. DSC.


PROJECT: NORTHERN ELECTRIC NORTHERN ELECTRIC COOPERATIVE BATH, SOUTH DAKOTA


SHEET TITLE: **ROOF DETAILS**


3" 9 5/8" 2 1/4" WALL TYPE '4D'

EXISTING

4HR FIRE WALL

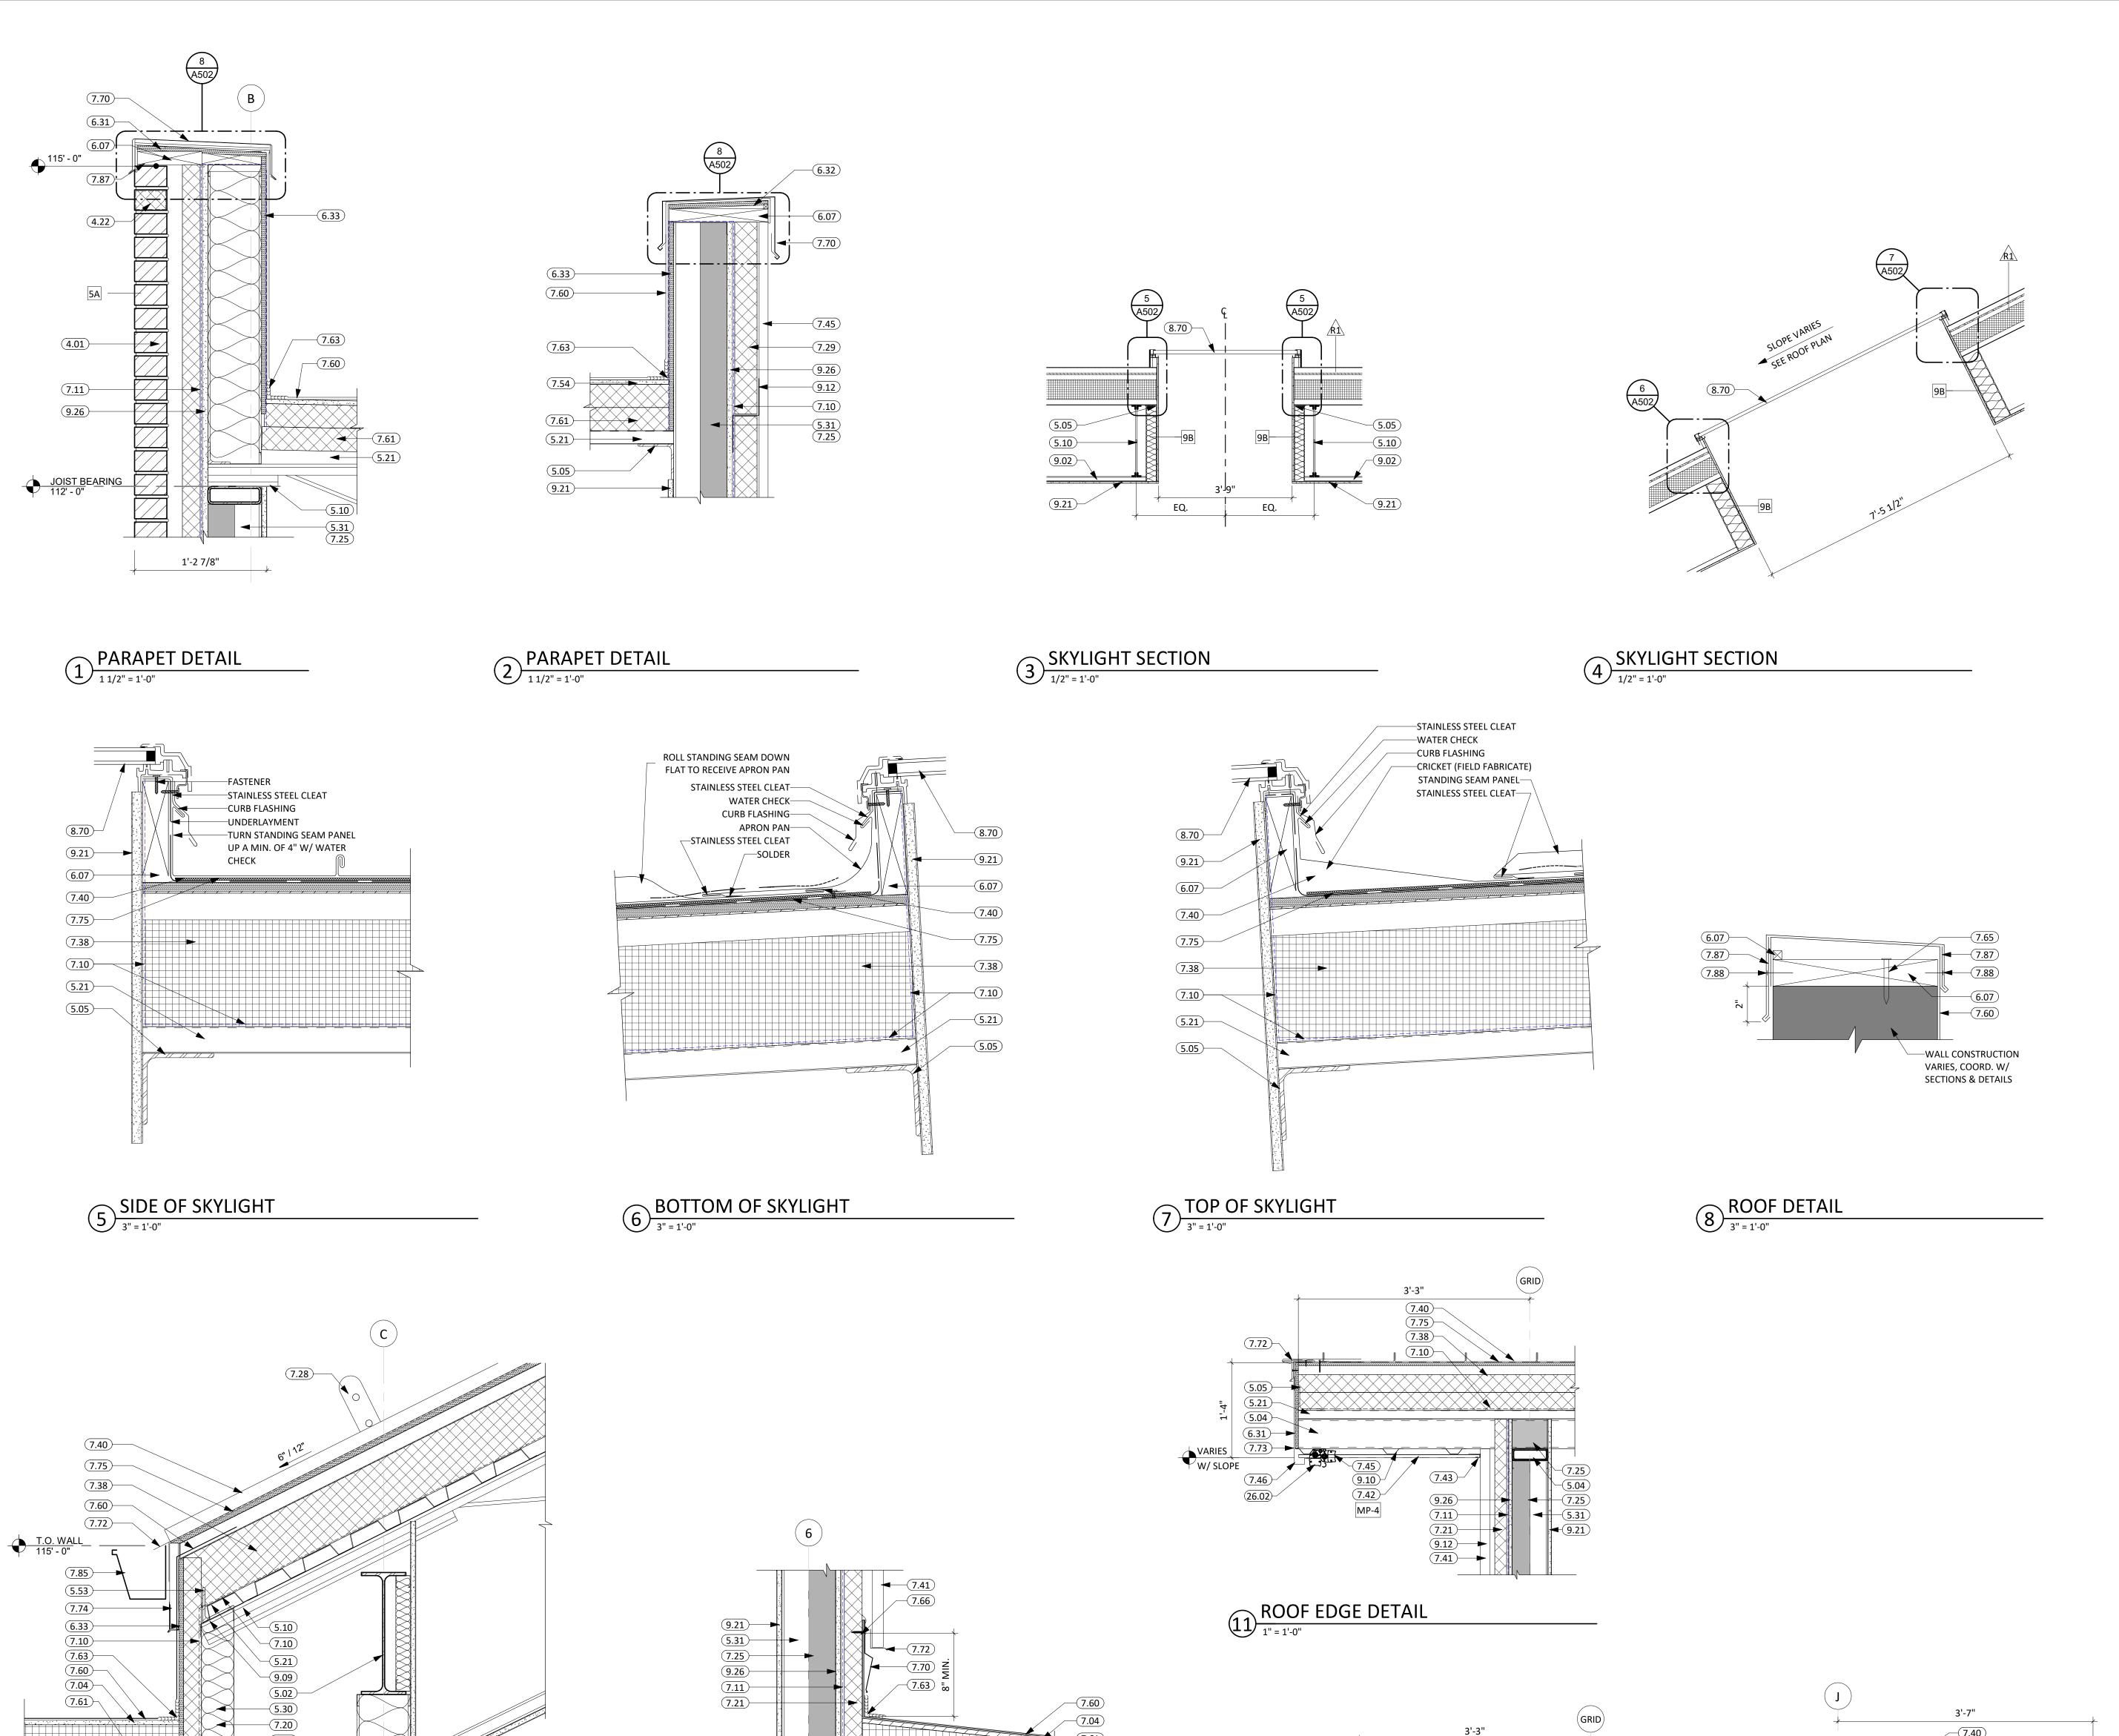

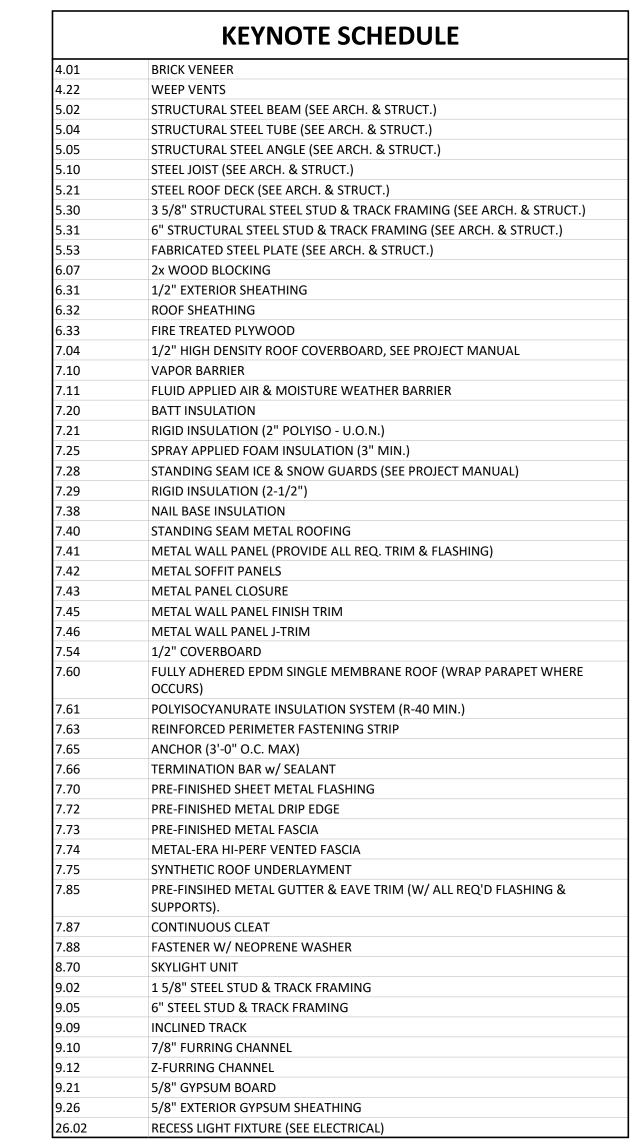

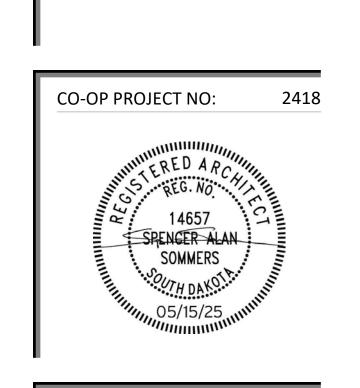

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5/15/2025 100% CONSTRUCTION DOCUMENTS **REVISION SCHEDULE:** REV. DATE

PROJECT: NORTHERN ELECTRIC NORTHERN ELECTRIC COOPERATIVE BATH, SOUTH DAKOTA

SHEET TITLE: **ROOF DETAILS**

A502

9 ROOF DETAIL

1 1/2" = 1'-0"

WALL CONDITION VARIES, SEE PLAN—

10 ROOF DETAIL

1 1/2" = 1'-0"


112' - 5"

9.02

5.02

9.02

VARIES, SEE PLAN

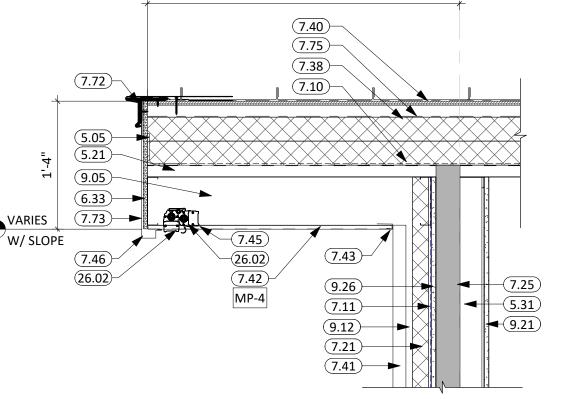


ROOF EDGE DETAIL

1" = 1'-0"

1" 6" ROOF DETAIL

1" = 1'-0"

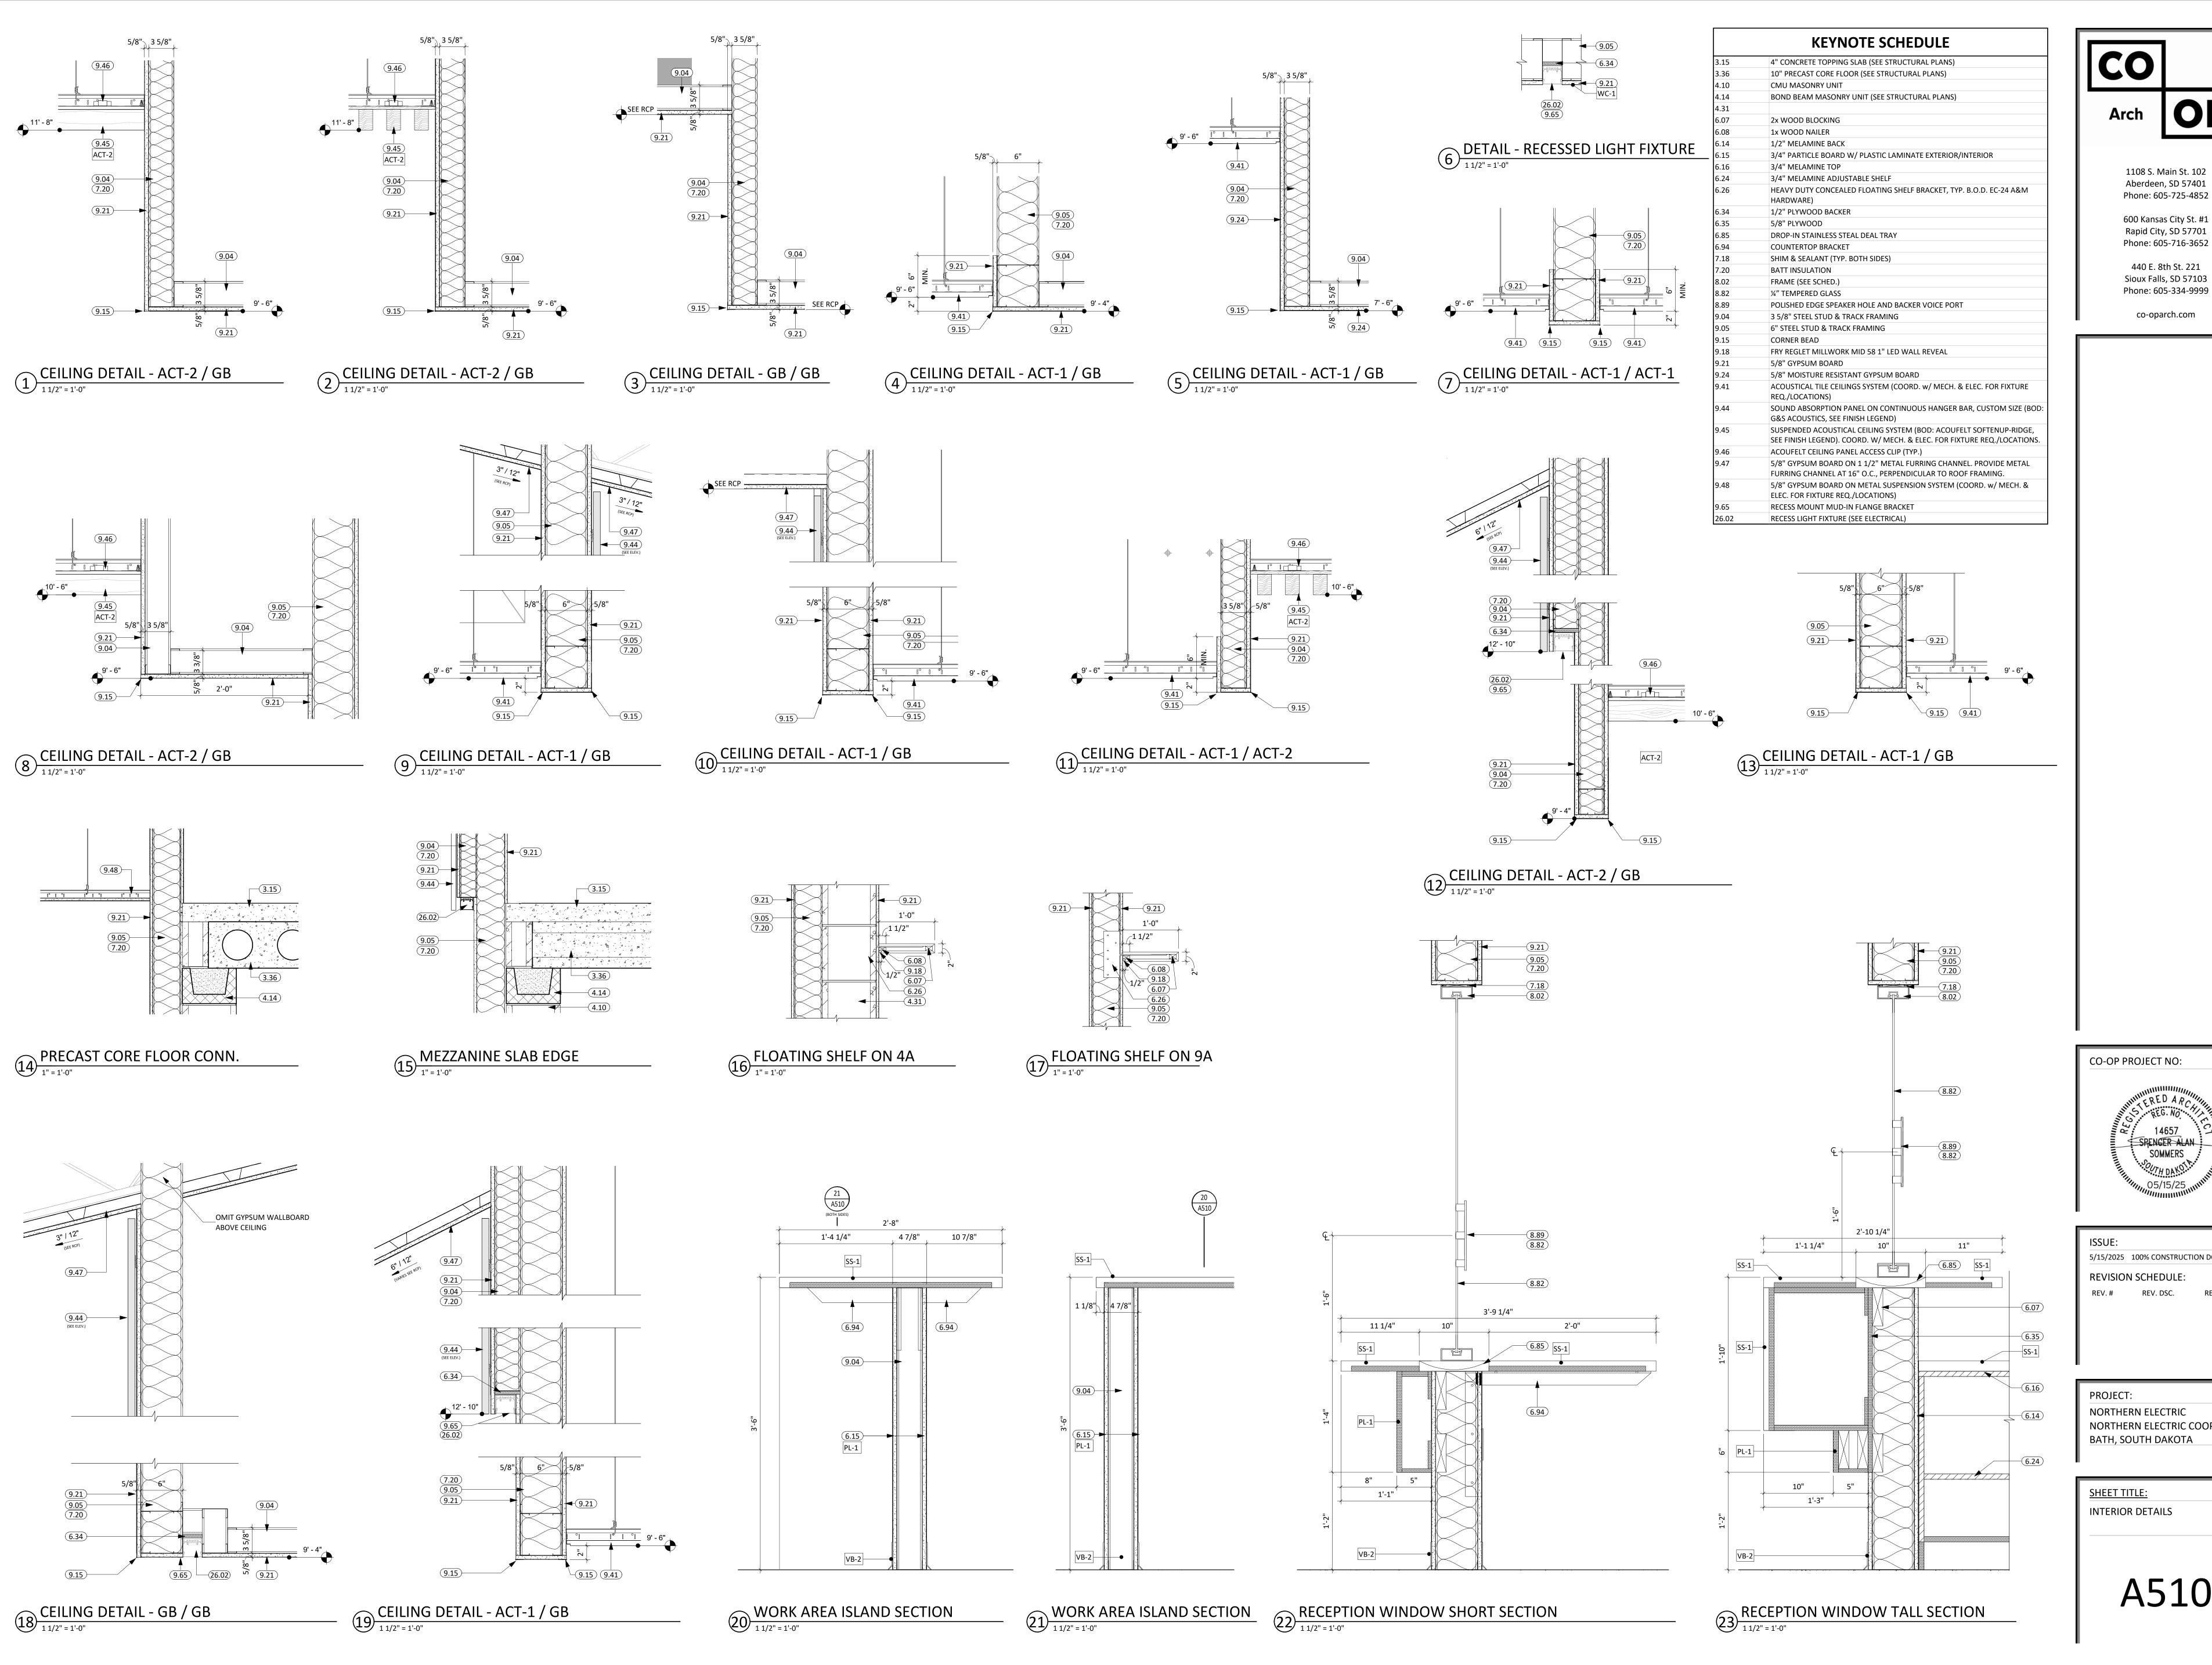

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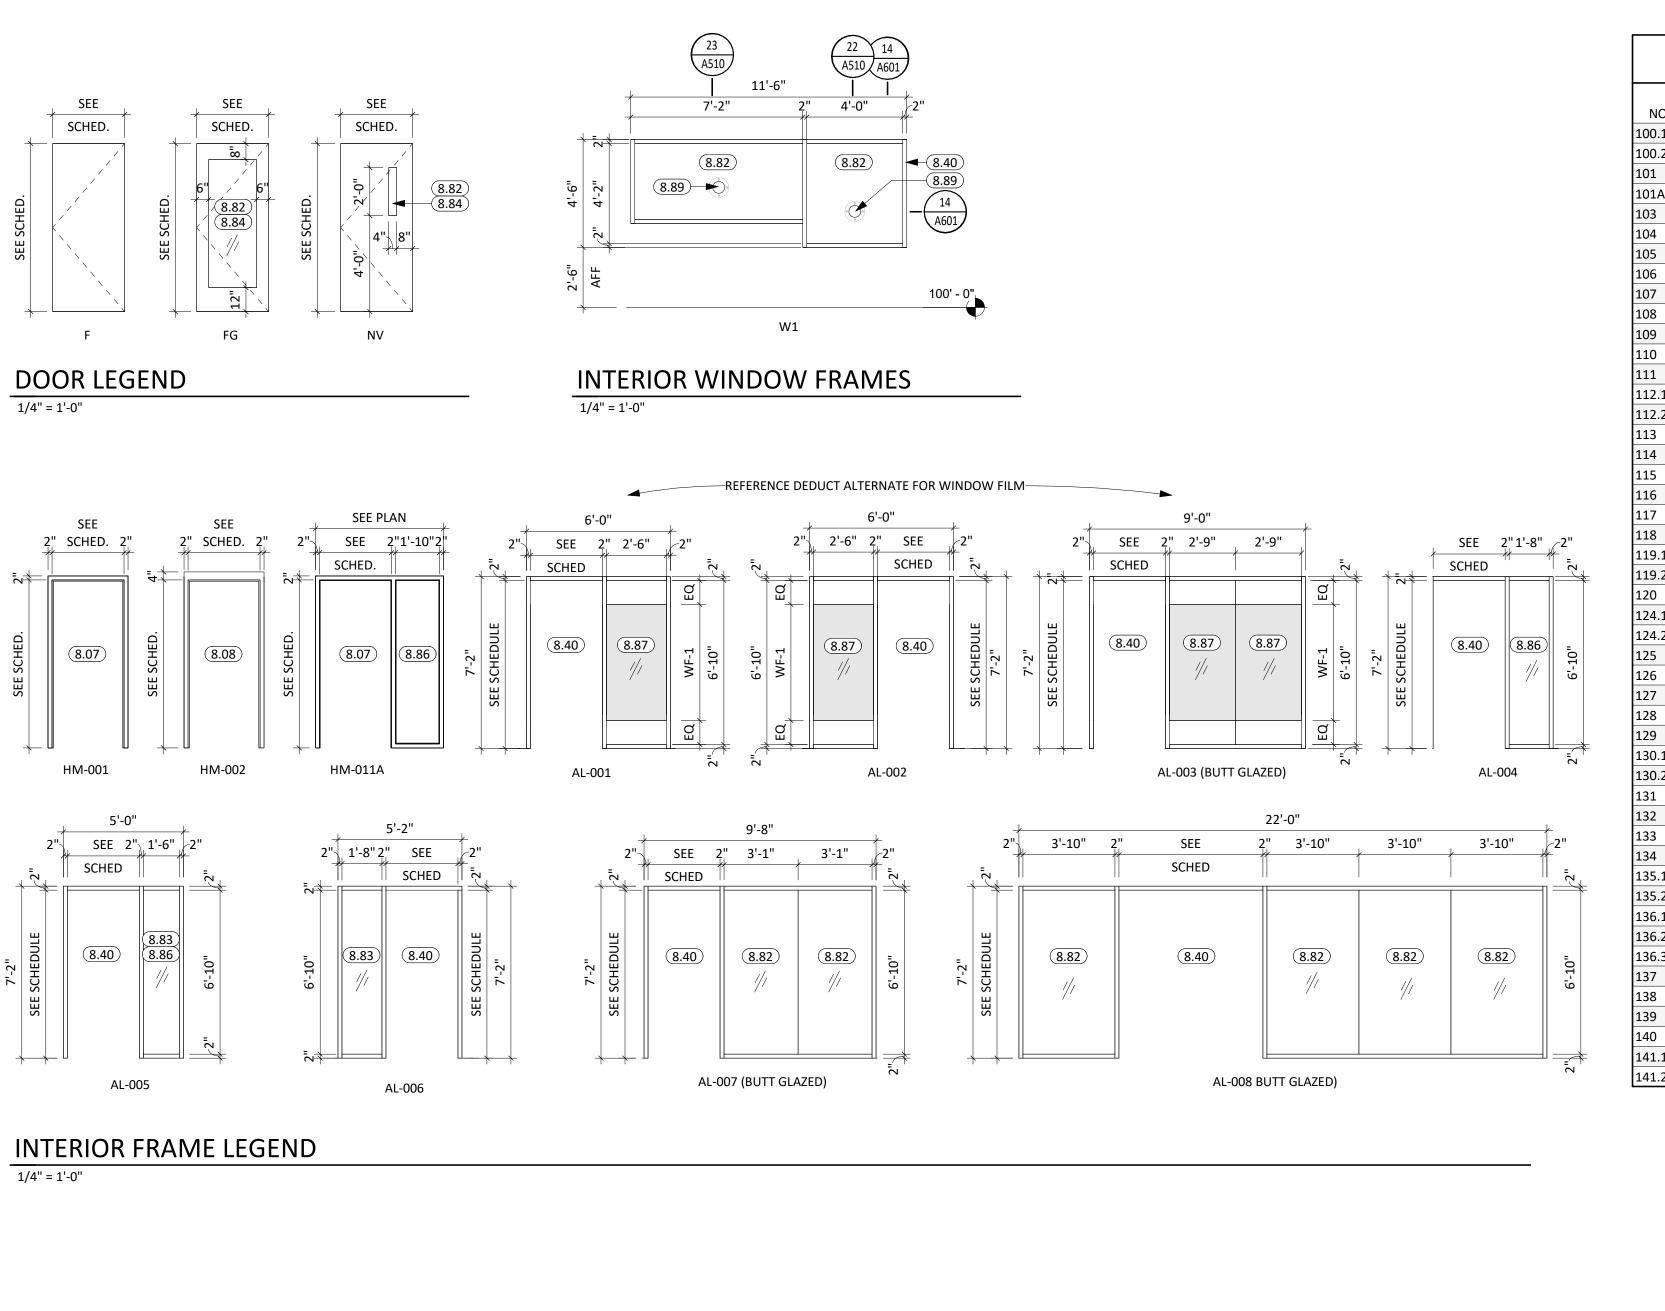
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CO-OP PROJECT NO:

5/15/2025 100% CONSTRUCTION DOCUMENTS **REVISION SCHEDULE:**

NORTHERN ELECTRIC NORTHERN ELECTRIC COOPERATIVE BATH, SOUTH DAKOTA

SHEET TITLE: INTERIOR DETAILS



							OOR	& FRA	ME SCHED	ULE			
			DOOR			FRA	ME		FRAME DETAILS		FIRE		
NO.	W	Н	Т	TYPE	MAT'L	TYPE	MAT'L	HEAD	JAMB	SILL	RATING	HDWRE SET	ADDITIONAL NOTES
00.1	3' - 0"	7' - 0"	0' - 1 3/4"	FG	AL	Н	AL	13/A602	10/A602, 14/A602	12/A500		22	
100.2	3' - 0"	7' - 0"	0' - 1 3/4"	FG	AL	J	AL	14/A601	14/A601	4/A601		01	UNIFI DOOR ACCESS (G3 READER)
.01	6' - 0"	7' - 0"	0' - 1 3/4"	FG	AL	AL-008	AL	14/A601	14/A601	4/A601		23	UNIFI DOOR ACCESS (G3 READER)
L01A	3' - 0"	7' - 0"	0' - 1 3/4"	F	WD	HM-001	НМ	1/A601	1/A601 (SIM)	2/A601		24	COAT HOOK, OCCUPANCY INDICATOR
103	3' - 0"	7' - 0"	0' - 1 3/4"	F	WD	AL-001	AL	14/A601	15/A601	3/A601		12	
104	3' - 0"	7' - 0"	0' - 1 3/4"	F	WD	AL-002	AL	14/A601	15/A601	3/A601		12	
105	3' - 0"	7' - 0"	0' - 1 3/4"	F	WD	AL-002	AL	14/A601	15/A601	3/A601		12	
.06	3' - 0"	7' - 0"	0' - 1 3/4"	F	WD	AL-002	AL	14/A601	15/A601	3/A601		12	
L07	3' - 0"	7' - 0"	0' - 1 3/4"	F	WD	AL-002	AL	14/A601	15/A601	3/A601		12	
108	3' - 0"	7' - 0"	0' - 1 3/4"	F	WD	AL-003	AL	14/A601	15/A601	3/A601		12	
109	3' - 0"	7' - 0"	0' - 1 3/4"	F	WD	AL-003	AL	14/A601	15/A601	3/A601		12	
10	3' - 0"	7' - 0"	0' - 1 3/4"	FG	WD	AL-007	AL	14/A601	15/A601	3/A601		08	
11	3' - 0"	7' - 0"	0' - 1 3/4"	F	WD	AL-002	AL	14/A601	15/A601	3/A601		12	
12.1	3' - 0"	7' - 0"	0' - 1 3/4"	F	WD	AL-001	AL	14/A601	15/A601	3/A601		12	
12.2	3' - 0"	7' - 0"	0' - 1 3/4"	F	WD	AL-002	AL	14/A601	15/A601	3/A601		12	
13	3' - 0"	7' - 0"	0' - 1 3/4"	F	WD	AL-001	AL	14/A601	15/A601	3/A601		12	
14	3' - 0"	7' - 0"	0' - 1 3/4"	F	WD	AL-002	AL	14/A601	15/A601	3/A601		12	
15	3' - 0"	7' - 0"	0' - 1 3/4"	F	WD	AL-001	AL	14/A601	15/A601	3/A601		12	
16	3' - 0"	7' - 0"	0' - 1 3/4"	F	WD	HM-001	НМ	1/A601	1/A601 (SIM)	2/A601		15	
17	3' - 0"	7' - 0"	0' - 1 3/4"	F	WD	AL-002	AL	14/A601	15/A601	3/A601		12	
18	3' - 0"	7' - 0"	0' - 1 3/4"	F	WD	AL-001	AL	14/A601	15/A601	3/A601		12	
19.1	3' - 0"	7' - 0"	0' - 1 3/4"	FG	AL	AL-006	AL	14/A601	15/A601	3/A601		06	
19.2	3' - 0"	7' - 0"	0' - 1 3/4"	FG	AL	В	AL	9/A602	8/A602	6/A601		02	UNIFI DOOR ACCESS (G3 READER)
20	3' - 0"	7' - 0"	0' - 1 3/4"	F	WD	AL-003	AL	14/A601	15/A601	3/A601		12	(
24.1	3' - 0"	7' - 0"	0' - 1 3/4"	F	WD	HM-001	HM	18/A601	19/A601	2/A601 (SIM)		18	
24.2	3' - 0"	7' - 0"	0' - 1 3/4"	F	WD	HM-001	HM	18/A601	19/A601	2/A601 (SIM)		18	
125	3' - 0"	7' - 0"	0' - 1 3/4"	F	WD	HM-001	HM	16/A601	17/A601	2/A601 (SIM)		12	
26	3' - 0"	7' - 0"	0' - 1 3/4"	F	WD	HM-001	HM	1/A601	1/A601 (SIM)	2/A601		15	UNIFI DOOR ACCESS (G3 READER)
27	3' - 0"	7' - 0"	0' - 1 3/4"	F	WD	HM-001	HM	1/A601	1/A601 (SIM)	2/A601		11	COAT HOOK, OCCUPANCY INDICATOR
28	3' - 0"	7' - 0"	0' - 1 3/4"	F	WD	HM-001	HM	1/A601	1/A601 (SIM)	2/A601		11	COAT HOOK, OCCUPANCY INDICATOR
29	6' - 0"	7' - 0"	0' - 1 3/4"	NV	HM	HM-002	HM	10/A601	9/A601	11/A601	180 MIN	21	UNIFI DOOR ACCESS (G3 READER)
30.1	3' - 0"	7' - 0"	0' - 1 3/4"	FG	WD	AL-004	AL	14/A601	15/A601	3/A601	60 MIN	16	UNIFI DOOR ACCESS (G3 READER)
30.2	3' - 0"	7' - 0"	0' - 1 3/4"	FG	WD	AL-004	AL	14/A601	15/A601	3/A601	60 MIN	16	UNIFI DOOR ACCESS (G3 READER)
31	3' - 0"	7' - 0"	0' - 1 3/4"	F	WD	HM-001	HM	1/A601	1/A601 (SIM.)	2/A601	60 MIN	10	The second secon
132	3' - 0"	7' - 0"	0'-13/4"	F	WD	HM-001	HM	1/A601	1/A601 (SIM.)	2/A601	60 MIN	13	
133	3' - 0"	7' - 0"	0'-13/4"	F	WD	HM-001	HM	1/A601	1/A601 (SIM)	2/A601	60 MIN	10	
134	6' - 0"	7' - 0"	0'-13/4"	F	WD	HM-001	HM	1/A601	1/A601 (SIM)	2/A601	60 MIN	14	
135.1	3' - 0"	7' - 0"	0'-13/4"	FG	AL	AL-005	AL	14/A601	15/A601	3/A601	60 MIN	04	
135.2	3' - 0"	7' - 0"	0'-13/4"	FG	AL	F	AL	11/A602	8/A602	6/A601	60 MIN	03	UNIFI DOOR ACCESS (G3 READER)
136.1	6' - 0"	7' - 0"	0' - 1 3/4"	F	WD	HM-001	HM	1/A601	1/A601 (SIM)	2/A601	60 MIN	20	MAGNETIC HOLD OPEN
136.2	3' - 0"	7' - 0"	0'-13/4"	F	WD	HM-001	НМ	1/A601 1/A601	1/A601 (SIM)	2/A601 2/A601	JO IVIIIV	17	UNIFI DOOR ACCESS (G3 READER)
136.3	3' - 0"	7 - 0"	0'-13/4"	FG	AL	E UIAI-OOT	AL	12/A601 12/A602	4/A602	12/A500		03	UNIFI DOOR ACCESS (G3 READER)
136.3	3' - 0"	7 - 0"	0'-13/4"	FG	WD	HM-011A	HM	1/A601	1/A601 (SIM)	2/A601	60 MIN	19	MAGNETIC HOLD OPEN
137	3' - 0"	7 - 0"	0 - 1 3/4	F	WD	HM-001	HM	1/A601 1/A601		2/A601 2/A601	OU IVIIIN	19	IVIAGINE IIC HOLD OPEN
	3' - 0"	7 - 0"	-	F				-	1/A601 (SIM)	· ·			
139			0' - 1 3/4"	-	WD	AL-001	AL	14/A601	15/A601	3/A601	100 8 4181	12	
L40 L41.1	3' - 0"	7' - 0"	0' - 1 3/4"	F	HM	HM-002	HM	10/A601	9/A601	11/A601	180 MIN	10	LINUEL DOOD ACCESS (CO. DEADED)
	3' - 0"	7' - 0"	0' - 1 3/4"	F NV	WD HM	HM-001 HM-002	HM HM	13/A601 10/A601	13/A601 (SIM) 9/A601	2/A601 (SIM) 11/A601	180 MIN	07 21	UNIFI DOOR ACCESS (G3 READER) UNIFI DOOR ACCESS (G3 READER)


ALL HM FRAMES IN STUD PARTITIONS SHALL BE WRAPPED AROUND BOTH SIDES OF PARTITION UNLESS OTHERWISE NOTED. SEE FLOOR PLAN(S) FOR WALL THICKNESS. ALL EXTERIOR FRAMES & DOORS ARE TO BE THERMALLY BROKEN. CAULK ENTIRE PERIMTER OF H.M. FRAMES (BOTH SIDES).

PAINT H.M. FRAMES TO MATCH WALL. SPLIT PAINT COLOR AT DOOR GASKET AS REQUIRED. PROVIDE ROOM SIGNAGE AT ALL DOORS. WHERE MOUNTED TO GLAZING, PROVIDE A BLANK BACK PLATE ON OPPOSIZE SIDE OF GLAZING. SEE CODE STANDARDS FOR MOUNTING HEIGHTS

AND LOCATIONS. SEE SPECIFICATIONS FOR SPECIAL SIGNAGE REQUIREMENTS. REFER TO WALL TYPES FOR WALL CONSTRUCTION ELEMENTS FOR ALL DOOR AND WINDOW DETAILS. COORDINATE ALL STRUCTURAL REQ. WITH STRUCTURAL DRAWINGS. WALL MOUNTED EXIT SIGNS AND FIXTURES ARE TO BE CENTERED OVER DOOR OR DOOR OPENING WHERE APPLICABLE.

FRAME TYPES WITH SIDELITES IN A 1-HR RATED WALL ASSEMBLY REQUIRE FIRE-RATED GLAZING TO BE 45-MIN, HOSE STREAM TESTED (IBC 716.1).

	KEYNOTE SCHEDULE
8.07	HOLLOW METAL FRAME - WRAP AROUND
8.08	HOLLOW METAL FRAME - INSET
8.40	ALUMINUM FRAMED ENTRANCE/STOREFRONT
8.50	ALUMINUM CURTAIN WALL
8.60	ALUMINUM WINDOW UNIT
8.80	¼" FLOAT GLASS
8.82	¼" TEMPERED GLASS
8.83	1" INSULATED GLASS
8.84	1" INSULATED TEMPERED GLASS
8.85	1" INSULATED SPANDREL GLASS
8.86	FIRE-RATED GLASS
8.87	¼" TEMPERED GLASS WITH WF-1 WINDOW FILM
8.89	POLISHED EDGE SPEAKER HOLE AND BACKER VOICE PORT
12.04	MANUAL ROLLER WINDOW SHADES
12.05	AUTOMATED ROLLER WINDOW SHADES (SEE ELECTRICAL)

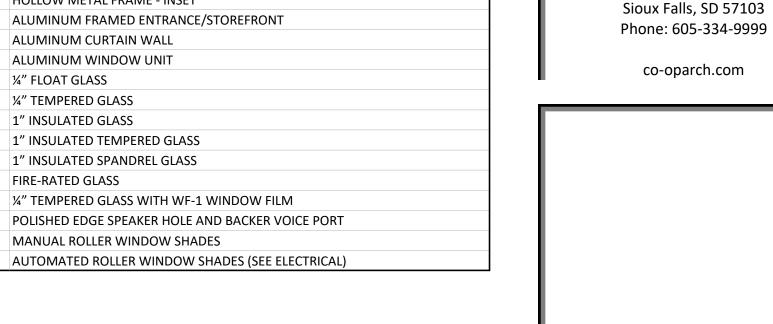

1108 S. Main St. 102


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600 Kansas City St. #1

Rapid City, SD 57701 Phone: 605-716-3652


440 E. 8th St. 221




5/15/2025 100% CONSTRUCTION DOCUMENTS **REVISION SCHEDULE:**

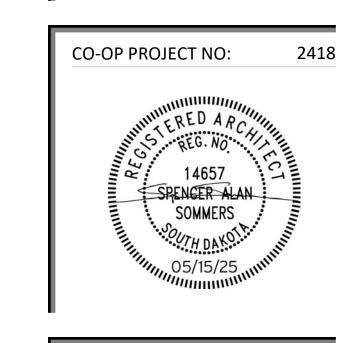PROJECT: NORTHERN ELECTRIC NORTHERN ELECTRIC COOPERATIVE BATH, SOUTH DAKOTA

SHEET TITLE: DOOR SCHEDULE, DOOR & FRAME TYPES

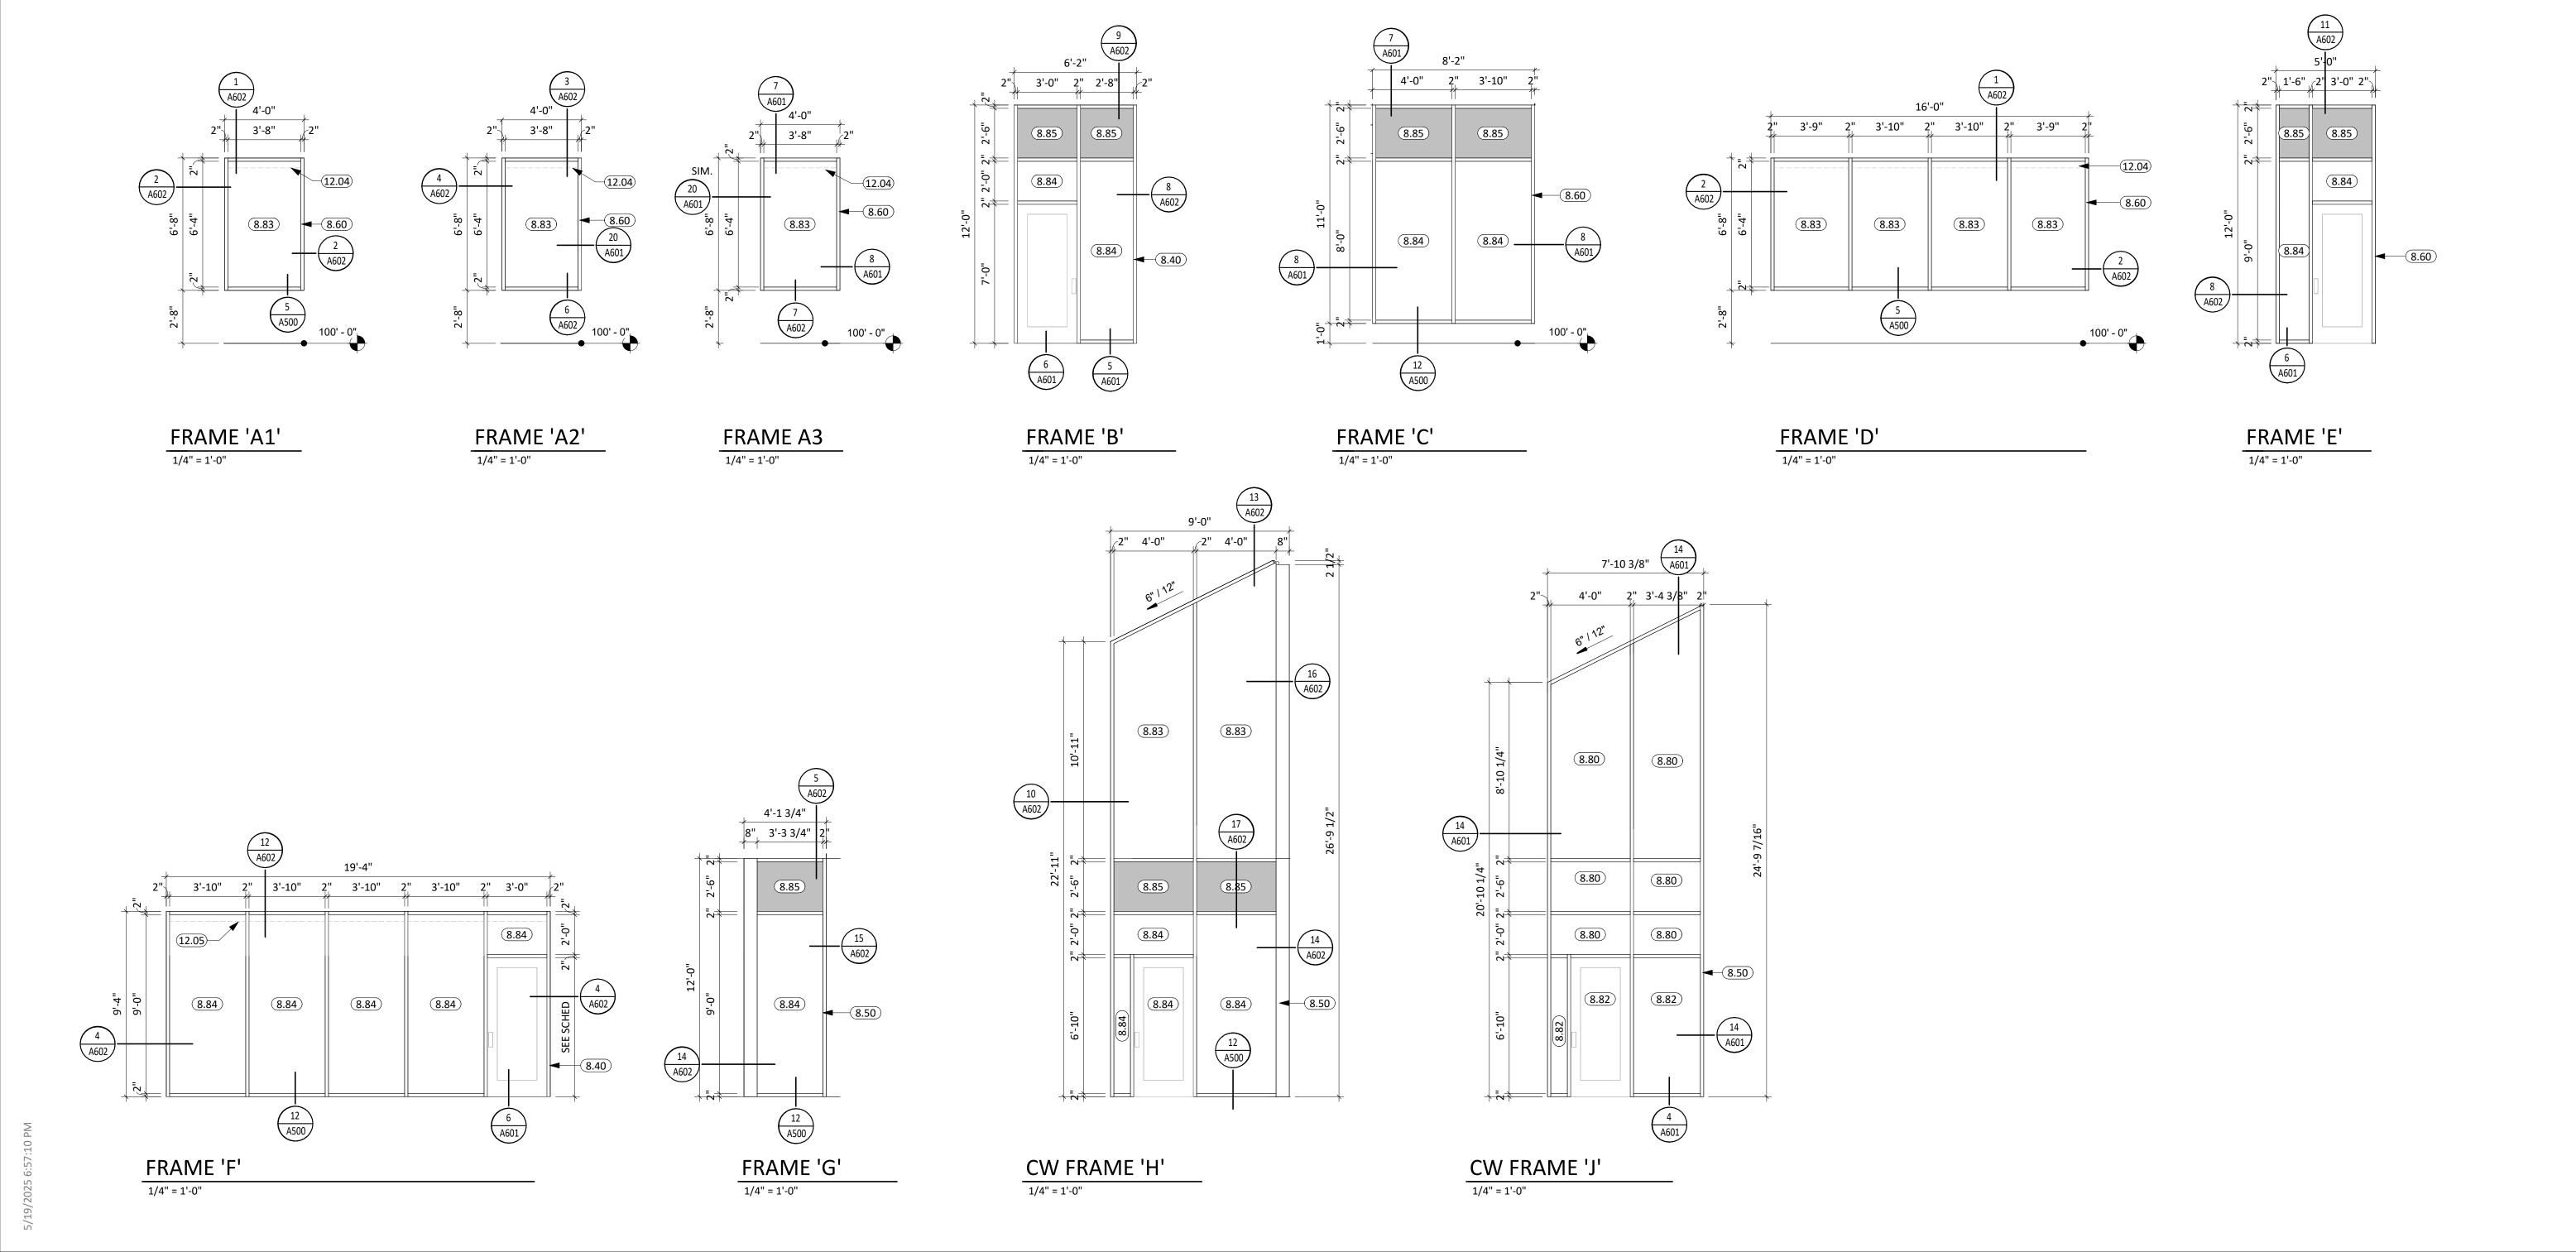

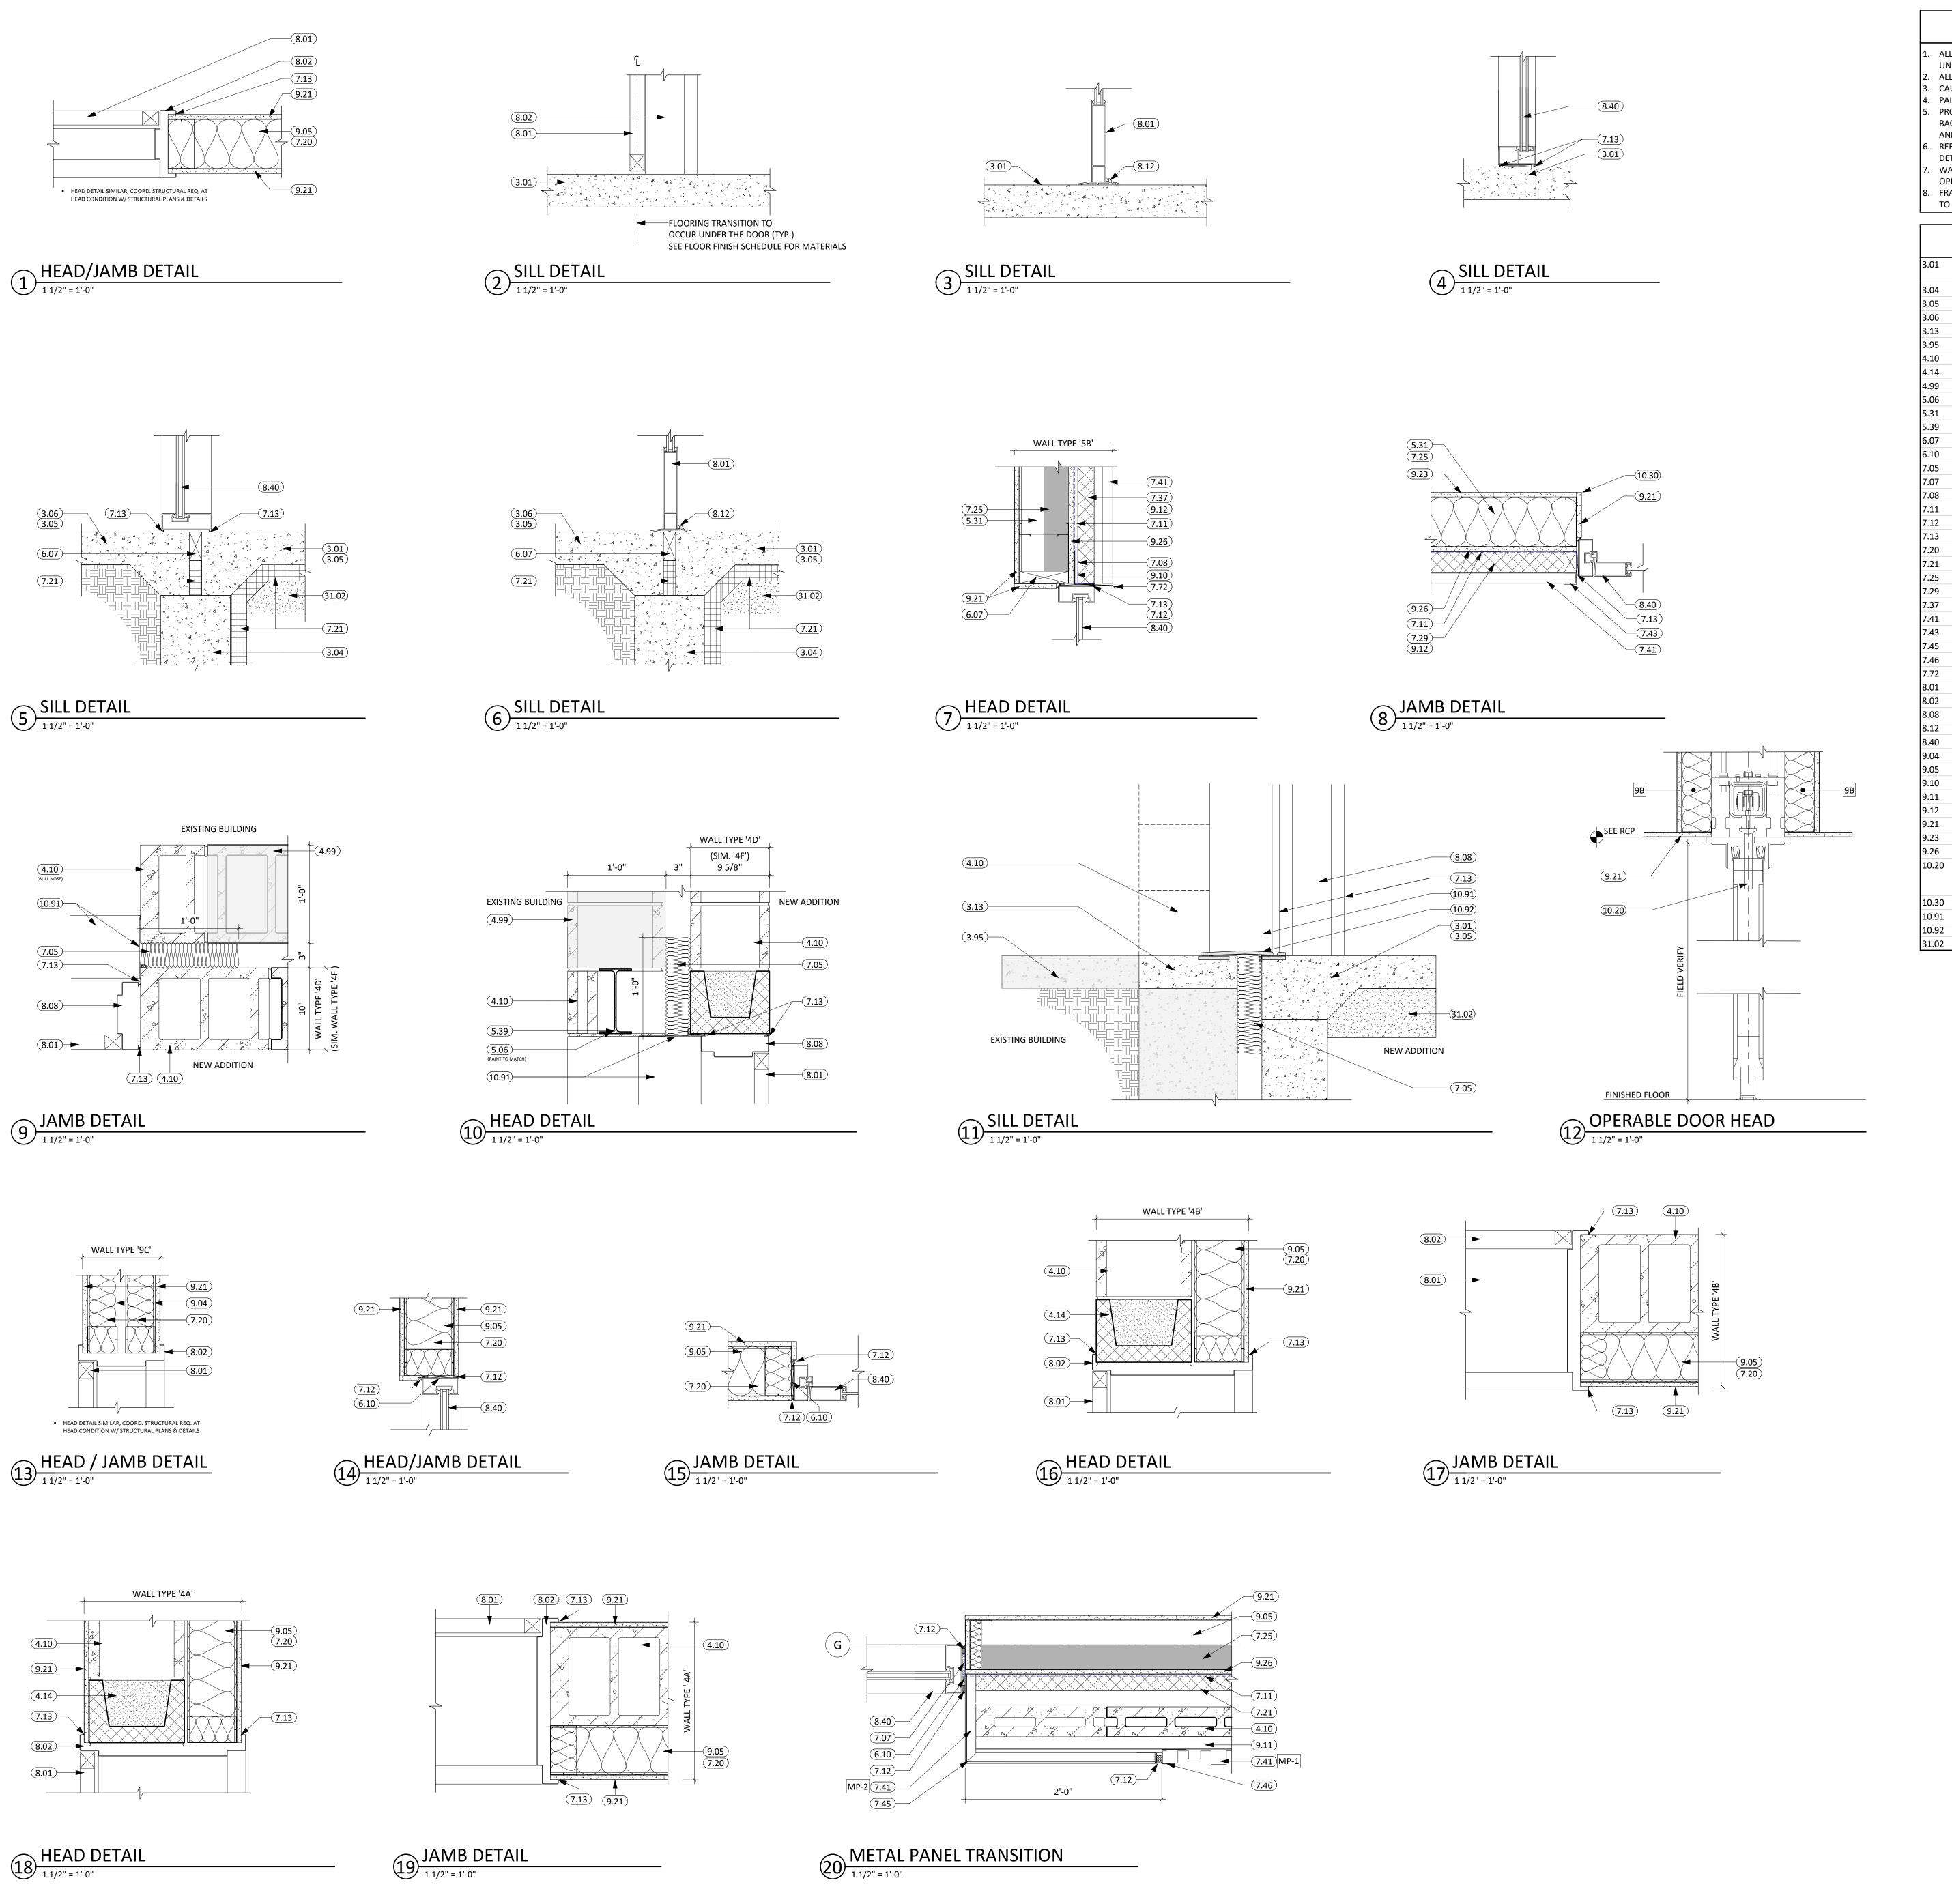

ALL HM FRAMES IN STUD PARTITIONS SHALL BE WRAPPED AROUND BOTH SIDES OF PARTITION UNLESS OTHERWISE NOTED. SEE FLOOR PLAN(S) FOR WALL THICKNESS. ALL EXTERIOR FRAMES & DOORS ARE TO BE THERMALLY BROKEN.

CAULK ENTIRE PERIMTER OF H.M. FRAMES (BOTH SIDES).

PAINT H.M. FRAMES TO MATCH WALL. SPLIT PAINT COLOR AT DOOR GASKET AS REQUIRED. PROVIDE ROOM SIGNAGE AT ALL DOORS. WHERE MOUNTED TO GLAZING, PROVIDE A BLANK BACK PLATE ON OPPOSIZE SIDE OF GLAZING. SEE CODE STANDARDS FOR MOUNTING HEIGHTS AND LOCATIONS. SEE SPECIFICATIONS FOR SPECIAL SIGNAGE REQUIREMENTS. REFER TO WALL TYPES FOR WALL CONSTRUCTION ELEMENTS FOR ALL DOOR AND WINDOW DETAILS. COORDINATE ALL STRUCTURAL REQ. WITH STRUCTURAL DRAWINGS. WALL MOUNTED EXIT SIGNS AND FIXTURES ARE TO BE CENTERED OVER DOOR OR DOOR

OPENING WHERE APPLICABLE. FRAME TYPES WITH SIDELITES IN A 1-HR RATED WALL ASSEMBLY REQUIRE FIRE-RATED GLAZING TO BE 45-MIN, HOSE STREAM TESTED (IBC 716.1).

	KEYNOTE SCHEDULE
3.01	CONC. FLOOR SLAB ON GRADE (SEE STRUCT. FOR THICKNESS AND REINF.) w/ 15 MIL. VAPOR BARRIER BELOW
3.04	CONT. CONC. FOUNDATION WALL (SEE STRUCTURAL PLANS)
3.05	THICKENED SLAB
3.06	CONCRETE STOOP w/FROST FREE FOOTING (SEE STRUCTURAL PLANS)
3.13	PATCH EXISTING CONCRETE FLOOR @ NEW OPENINGS AS DIRECTED
3.95	PRECAST CORE FLOOR (SEE STRUCTURAL PLANS)
4.10	CMU MASONRY UNIT
4.14	BOND BEAM MASONRY UNIT (SEE STRUCTURAL PLANS)
4.99	EXISTING MASONRY WALL
5.06	STRUCTURAL STEEL PLATE (SEE ARCH. & STRUCT.)
5.31	6" STRUCTURAL STEEL STUD & TRACK FRAMING (SEE ARCH. & STRUCT.)
5.39	HEADER CONDITION (SEE ARCH. & STRUCT.)
6.07	2x WOOD BLOCKING
6.10	BLOCKING (SEE STRUCT. FOR ADDITIONAL REQ.)
7.05	MINERAL WOOL BATT INSULATION
7.07	WRAP VAPOR BARRIER INTO WINDOW OPENING
7.08	MEMBRANE FLASHING
7.11	FLUID APPLIED AIR & MOISTURE WEATHER BARRIER
7.12	SEALANT (PROVIDE BACKER ROD WHERE REQ.)
7.13	SEALANT AROUND PEREMETER (TYP. BOTH SIDES)
7.20	BATT INSULATION
7.21	RIGID INSULATION (2" POLYISO - U.O.N.)
7.25	SPRAY APPLIED FOAM INSULATION (3" MIN.)
7.29	RIGID INSULATION (2-1/2")
7.37	RIGID INSULATION (2")
7.41	METAL WALL PANEL (PROVIDE ALL REQ. TRIM & FLASHING)
7.43	METAL PANEL CLOSURE
7.45	METAL WALL PANEL FINISH TRIM
7.46	METAL WALL PANEL J-TRIM
7.72	PRE-FINISHED METAL DRIP EDGE
8.01	DOOR (SEE SCHED.)
8.02	FRAME (SEE SCHED.)
8.08	HOLLOW METAL FRAME - INSET
8.12	THRESHOLD
8.40	ALUMINUM FRAMED ENTRANCE/STOREFRONT
9.04	3 5/8" STEEL STUD & TRACK FRAMING
9.05	6" STEEL STUD & TRACK FRAMING
9.10	7/8" FURRING CHANNEL
9.11	1 1/2" FURRING CHANNEL
9.12	Z-FURRING CHANNEL
9.21	5/8" GYPSUM BOARD
9.23	5/8" HIGH ABUSE GYPSUM BOARD
9.26	5/8" EXTERIOR GYPSUM SHEATHING
10.20	OPERABLE PARTITION (B.O.D. MODERNFOLD ACOUSTI-SEAL LEGACY ELECTRIC, CONCEALED HINGES). INSTALL PER MANUFACTURERS DIRECTIONS (SEE

INTERIOR FIRE-RATED WALL & CEILING EXPANSION JOINT COVER ASSEMBLY

INTERIOR FIRE-RATED FLOOR EXPANSION JOINT COVER ASSEMBLY

DRAINAGE FILL (COORD. REQ. w/ SOILS REPORT)

STRUCTURAL PLANS)

CORNER GUARDS

1108 S. Main St. 102 Aberdeen, SD 57401 Phone: 605-725-4852


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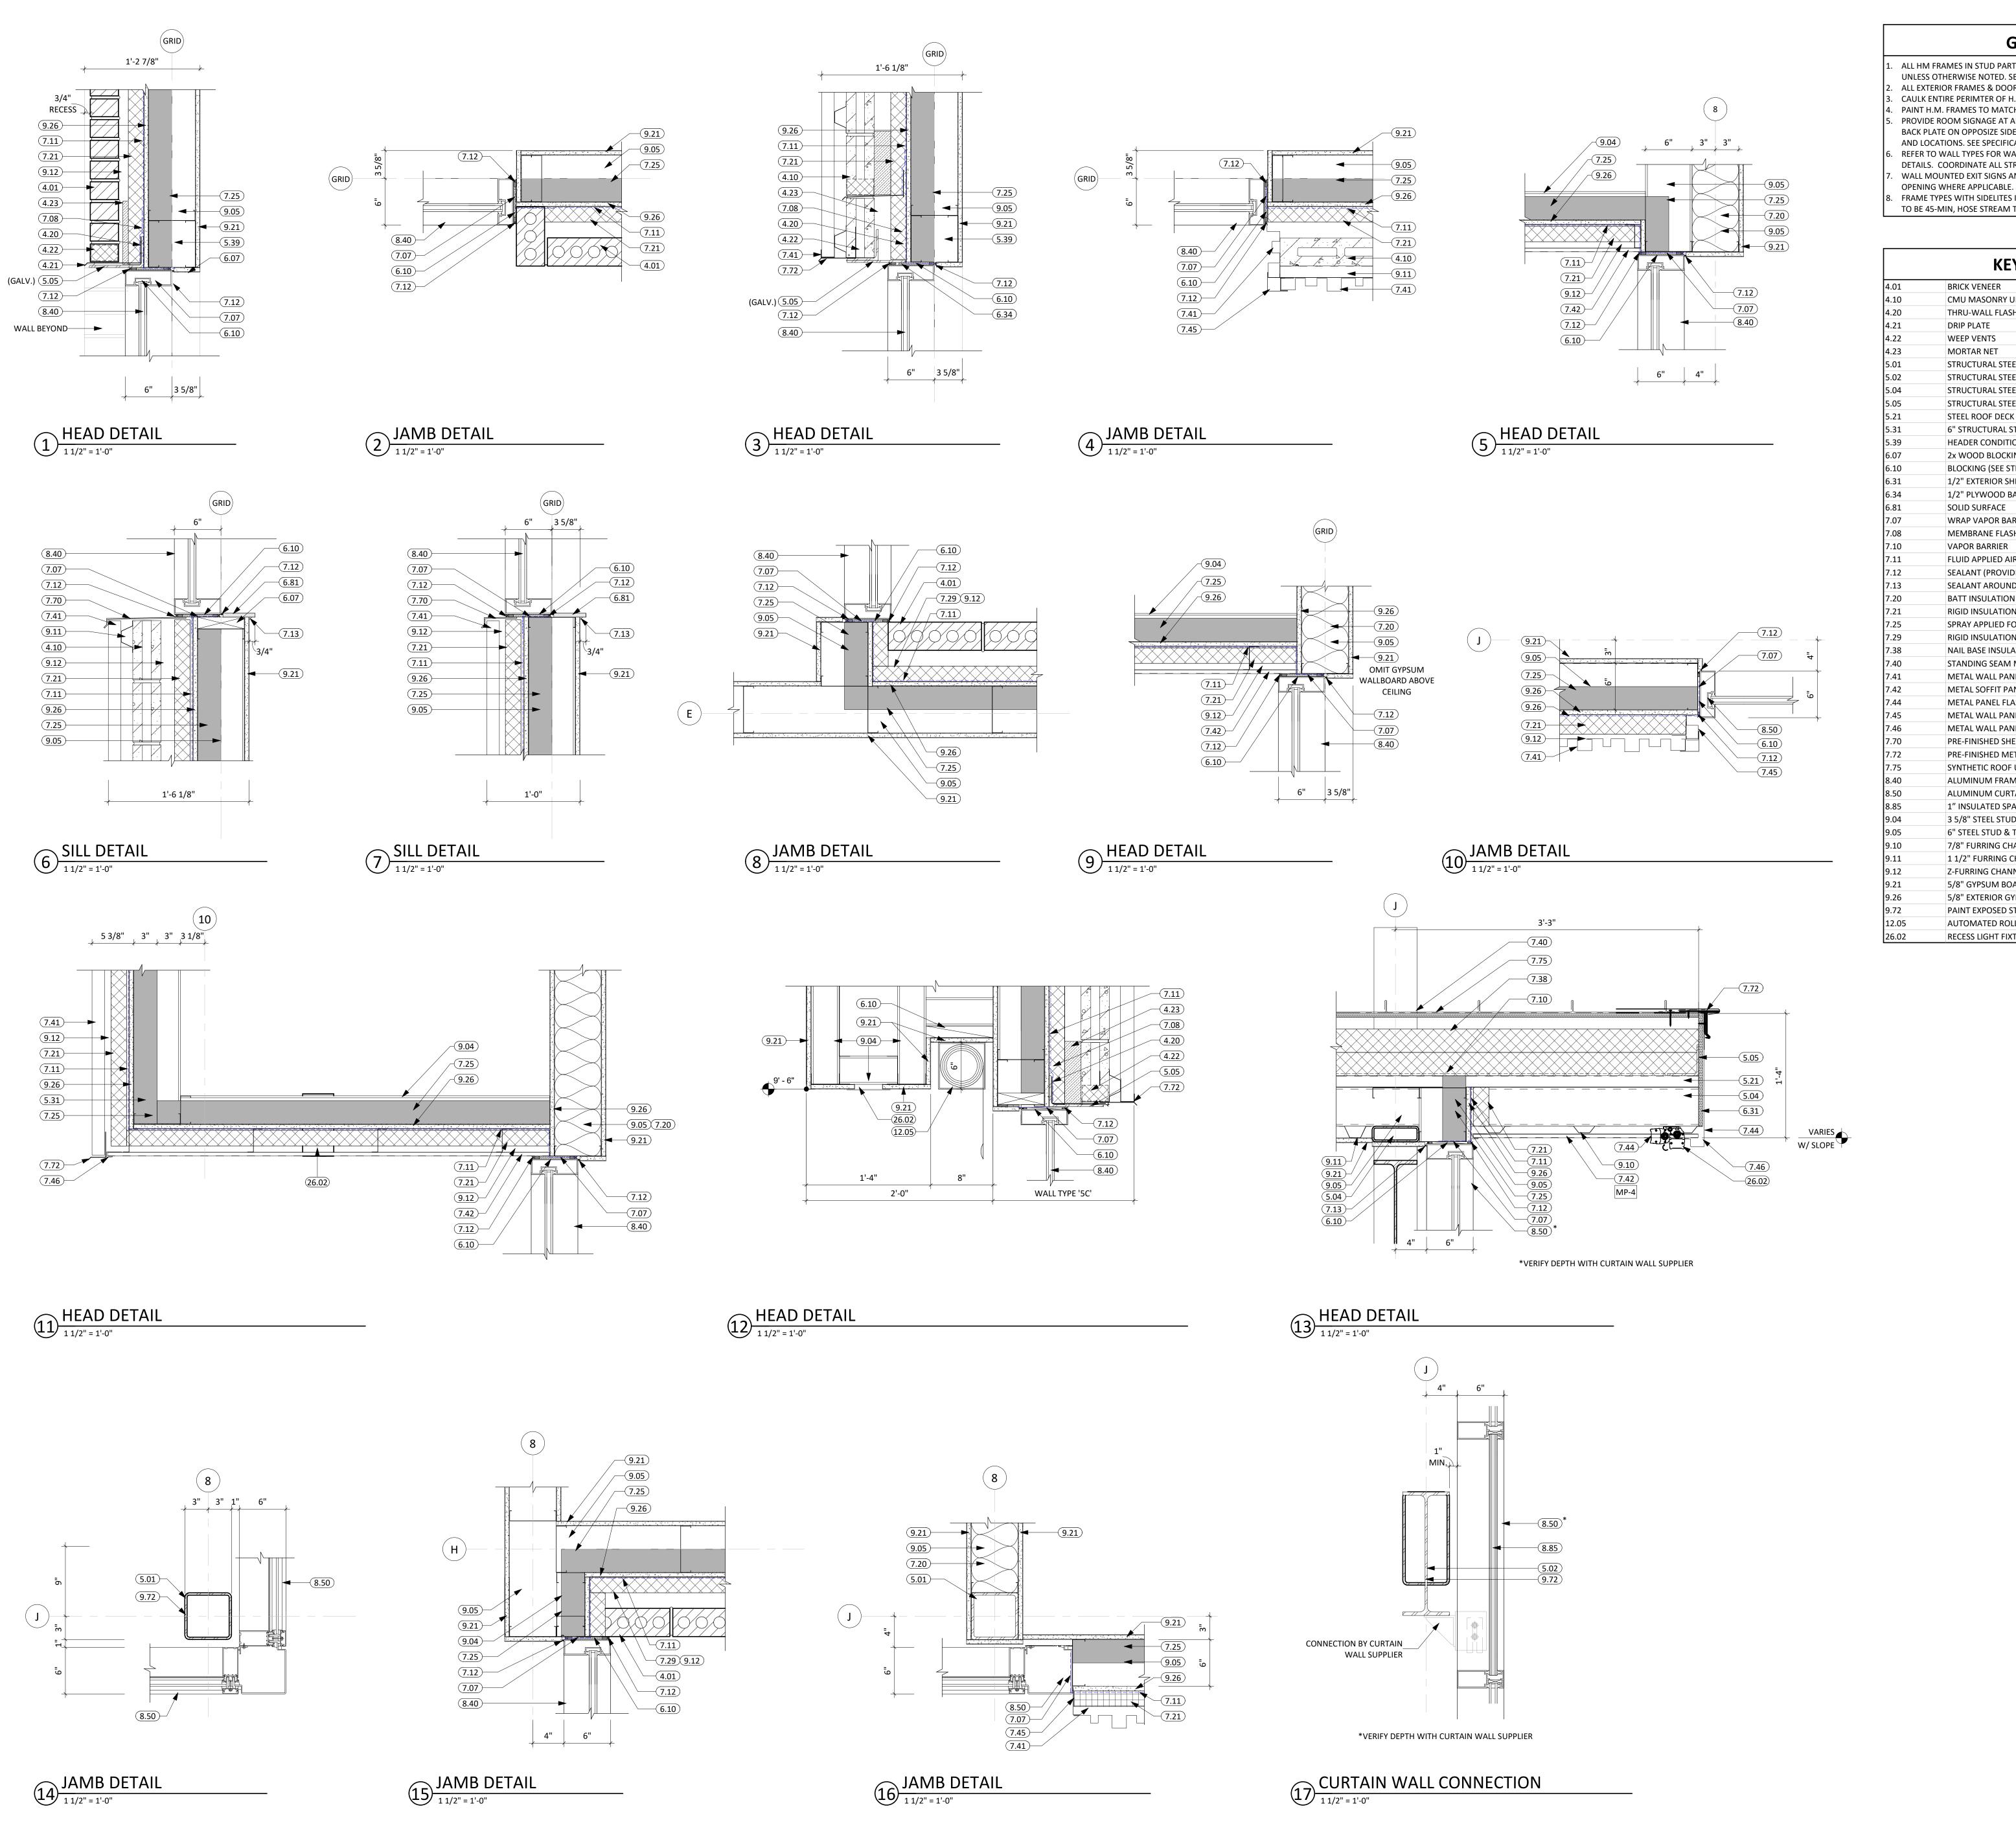
5/15/2025 100% CONSTRUCTION DOCUMENTS **REVISION SCHEDULE:** REV. # REV. DSC.

> PROJECT: NORTHERN ELECTRIC

NORTHERN ELECTRIC COOPERATIVE

BATH, SOUTH DAKOTA

SHEET TITLE: DOOR & WINDOW DETAILS

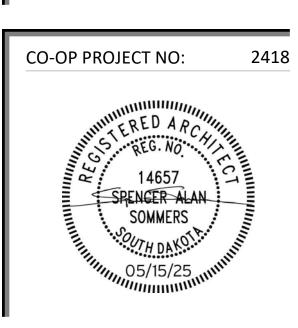

ALL HM FRAMES IN STUD PARTITIONS SHALL BE WRAPPED AROUND BOTH SIDES OF PARTITION UNLESS OTHERWISE NOTED. SEE FLOOR PLAN(S) FOR WALL THICKNESS.
 ALL EXTERIOR FRAMES & DOORS ARE TO BE THERMALLY BROKEN.

CAULK ENTIRE PERIMTER OF H.M. FRAMES (BOTH SIDES).

PAINT H.M. FRAMES TO MATCH WALL. SPLIT PAINT COLOR AT DOOR GASKET AS REQUIRED.

PROVIDE ROOM SIGNAGE AT ALL DOORS. WHERE MOUNTED TO GLAZING, PROVIDE A BLANK

BACK PLATE ON OPPOSIZE SIDE OF GLAZING. SEE CODE STANDARDS FOR MOUNTING HEIGHTS

PROVIDE ROOM SIGNAGE AT ALL DOORS. WHERE MOUNTED TO GLAZING, PROVIDE A BLANK BACK PLATE ON OPPOSIZE SIDE OF GLAZING. SEE CODE STANDARDS FOR MOUNTING HEIGHT: AND LOCATIONS. SEE SPECIFICATIONS FOR SPECIAL SIGNAGE REQUIREMENTS.
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8. FRAME TYPES WITH SIDELITES IN A 1-HR RATED WALL ASSEMBLY REQUIRE FIRE-RATED GLAZING TO BE 45-MIN, HOSE STREAM TESTED (IBC 716.1).

	KEYNOTE SCHEDULE
4.01	BRICK VENEER
4.10	CMU MASONRY UNIT
4.20	THRU-WALL FLASHING
4.21	DRIP PLATE
4.22	WEEP VENTS
4.23	MORTAR NET
5.01	STRUCTURAL STEEL COLUMN (SEE ARCH. & STRUCT.)
5.02	STRUCTURAL STEEL BEAM (SEE ARCH. & STRUCT.)
5.04	STRUCTURAL STEEL TUBE (SEE ARCH. & STRUCT.)
5.05	STRUCTURAL STEEL ANGLE (SEE ARCH. & STRUCT.)
5.21	STEEL ROOF DECK (SEE ARCH. & STRUCT.)
5.31	6" STRUCTURAL STEEL STUD & TRACK FRAMING (SEE ARCH. & STRUCT.)
5.39	HEADER CONDITION (SEE ARCH. & STRUCT.)
6.07	2x WOOD BLOCKING
6.10	BLOCKING (SEE STRUCT. FOR ADDITIONAL REQ.)
6.31	1/2" EXTERIOR SHEATHING
6.34	1/2" PLYWOOD BACKER
6.81	SOLID SURFACE
7.07	WRAP VAPOR BARRIER INTO WINDOW OPENING
7.08	MEMBRANE FLASHING
7.10	VAPOR BARRIER
7.11	FLUID APPLIED AIR & MOISTURE WEATHER BARRIER
7.12	SEALANT (PROVIDE BACKER ROD WHERE REQ.)
7.13	SEALANT AROUND PEREMETER (TYP. BOTH SIDES)
7.20	BATT INSULATION
7.21	RIGID INSULATION (2" POLYISO - U.O.N.)
7.25	SPRAY APPLIED FOAM INSULATION (3" MIN.)
7.29	RIGID INSULATION (2-1/2")
7.38	NAIL BASE INSULATION
7.40	STANDING SEAM METAL ROOFING
7.40 7.41	METAL WALL PANEL (PROVIDE ALL REQ. TRIM & FLASHING)
7.42	METAL SOFFIT PANELS
7.42 7.44	METAL PANEL FLASHING
7. 44 7.45	METAL WALL PANEL FINISH TRIM
7.45 7.46	METAL WALL PANEL J-TRIM
7.40 7.70	PRE-FINISHED SHEET METAL FLASHING
7.70 7.72	PRE-FINISHED METAL DRIP EDGE
7.75	SYNTHETIC ROOF UNDERLAYMENT
8.40	ALUMINUM FRAMED ENTRANCE/STOREFRONT
8.50	ALUMINUM CURTAIN WALL
8.85	1" INSULATED SPANDREL GLASS
9.04	3 5/8" STEEL STUD & TRACK FRAMING
9.05	6" STEEL STUD & TRACK FRAMING
9.10	7/8" FURRING CHANNEL
9.11	1 1/2" FURRING CHANNEL
9.12	Z-FURRING CHANNEL
9.21	5/8" GYPSUM BOARD
9.26	5/8" EXTERIOR GYPSUM SHEATHING
9.72	PAINT EXPOSED STRUCTURE
12.05	AUTOMATED ROLLER WINDOW SHADES (SEE ELECTRICAL)
26.02	RECESS LIGHT FIXTURE (SEE ELECTRICAL)

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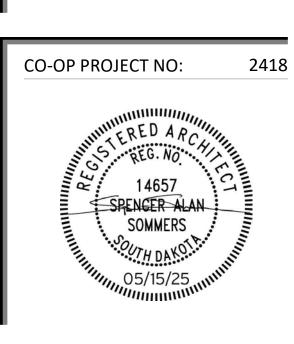
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ISSUE:

5/15/2025 100% CONSTRUCTION DOCUMENTS

REVISION SCHEDULE:

REV. # REV. DSC. REV. DATE

PROJECT:

NORTHERN ELECTRIC

NORTHERN ELECTRIC COOPERATIVE

BATH, SOUTH DAKOTA

SHEET TITLE:

DOOR & WINDOW DETAILS

4602

GENERAL DESIGN CRITERIA: CODES:

- INTERNATIONAL BUILDING CODE, 2021 AMERICAN INSTITUTE OF STEEL CONSTRUCTION, LATEST EDITION AMERICAN CONCRETE INSTITUTE, LATEST EDITION
- AMERICAN WOOD COUNCIL, NATIONAL DESIGN SPECIFICATION, LATEST EDITION COMPLY WITH ALL LOCAL CODES AND LAWS, INCLUDING OSHA REGULATIONS

LATERAL LOADS:

- LATERAL SYSTEM- PLYWOOD/GYPSUM/THERMOPLY SHEARWALLS, LG STRAP BRACING, STEEL BRACED FRAMES/MOMENT FRAMES, CMU WALLS, PRECAST WALLS BUILDING OCCUPANCY: II
- SEISMIC DESIGN CATEGORY A IMPORTANCE FACTOR le=1.00

BASIC WIND SPEED: 112 MPH

- ACCELERATIONS: SS= 0.091 S1= 0.035 SITE CLASS D SPECTRAL: SDS= 0.097 SD1= 0.057
- ANALYSIS PROCEDURE: EQUIVALENT LATERAL FORCE
- EXPOSURE C INTERNAL PRESSURE COEFFICIENT: ENCLOSED

COMPONENTS AND CLADDING WIND (UNFACTORED):

ROOF (ZONE 3r): +16PSF OR -49PSF

WALL (ZONE 4): +25PSF OR -28PSF

WALL (ZONE 5): +25PSF OR -31PSF

WIND ZONES	GROSS WIND PRESSURE	NET UPLIFT ROOF PRESSURE
ROOF (ZONE 1):	+16PSF OR -17PSF	-13.5PSF
ROOF (ZONE 2e):	+16PSF OR -17PSF	-13.5PSF
ROOF (ZONE 2n):	+16PSF OR -29PSF	-25.5PSF
ROOF (ZONE 2r):	+16PSF OR -29PSF	-25.5PSF
ROOF (ZONE 3e):	+16PSF OR -29PSF	-25.5PSF

THIS ASSUMES AN INFLUENCE AREA OF 15 SQ FT. FOR WALL ZONES & 72 SQ FT. FOR ROOF ZONES. INCREASE OF PRESSURE FOR OTHER INFLUENCE AREAS SHALL BE BY THE COMPONENT DESIGNER. THE USE OF ALTERNATE LOAD COMBINATIONS IN SECTION 1605.3.2 IS NOT ALLOWED.

-45.5PSF

3. SUPERIMPOSED – DEAD LOADS:

A.	METAL:	
	METAL DECK:	3PSF
	 INSULATION/MEMBRANE: 	3PSF
	CMEP:	8PSF
	 JOIST/BRIDGING: 	5PSF
B.	SAFE ROOM:	
	 HOLLOWCORE: 	56PSF
	 TOPPING SLAB: 	50PSF
	 INSULATION/MEMBRANE: 	3PSF
	CMEP:	8PSF
	MISC:	3PSF

LIVE LOADS

 GROUND SNOW LOAD: SLOPED ROOF SNOW LOAD (MINIMUM): IMPORTANCE FACTOR Is= 1.00 SNOW EXPOSURE FACTOR Ce= 1.00 THERMAL FACTOR Ct= 1.00

SNOW DRIFT LOAD: ASCE-7 (2016)

LIGHT STORAGE ABOVE HOLLOWCORE:

1. THE CONTRACT DRAWINGS REPRESENT THE COMPLETED STRUCTURE, AT TIME OF SUBSTANTIAL COMPLETION. UNLESS NOTED OTHERWISE, THEY DO NOT REPRESENT THE MEANS AND METHODS OF CONSTRUCTION. SEQUENCING AND MEANS-AND-METHODS OF CONSTRUCTION SHALL BE THE

RESPONSIBILITY OF THE GENERAL CONTRACTOR.

THE DESIGN OF ANY TEMPORARY BRACING AND SHORING.

LICENSED IN THE STATE WHERE THE PROJECT IS LOCATED.

2. THE CONTRACTOR IS RESPONSIBLE FOR THE STRENGTH, SAFETY, AND STABILITY OF THE NEW AND COLUMNS: EXISTING STRUCTURE DURING CONSTRUCTION AND SHALL PROVIDE TEMPORARY SHORING, DRILLED PIERS: BRACING, AND OTHER ELEMENTS REQUIRED TO MAINTAIN STABILITY UNTIL THE STRUCTURE IS FILL ON COMPOSITE MTL. DECK: COMPLETE. IT IS THE CONTRACTOR'S RESPONSIBILITY TO BE FAMILIAR WITH THE WORK REQUIRED FOOTINGS: IN THE CONSTRUCTION DOCUMENTS AND THE REQUIREMENTS FOR EXECUTING IT PROPERLY. THE FOUNDATION WALLS: CONTRACTOR SHALL, AT HIS DISCRETION, EMPLOY A REGISTERED PROFESSIONAL ENGINEER FOR GRADE BEAMS: SLABS ON GRADE:

CONCRETE:

SHALL BE AS FOLLOWS:

- 3. FIELD VERIFY ANY EXISTING DIMENSIONS, SIZES, AND THICKNESS SHOWN ON DRAWINGS. IMMEDIATELY NOTIFY ARCHITECT OF ANY DISCREPANCIES. 4. DETAILS AND NOTES SHOWN ON THE STRUCTURAL DOCUMENTS ARE TYPICAL FOR SIMILAR
- SITUATIONS IN THE PROJECT. SITE, UNLESS CALLED OUT ON THE APPROVED MIX DESIGN. 5. OPTIONS, IF SHOWN, ARE FOR THE CONVENIENCE OF THE CONTRACTOR. 6. THE COST OF ADDITIONAL DESIGN WORK NECESSITATED BY SEQUENCING OR CONSTRUCTION 4. CONCRETE MIX DESIGN PARAMETERS:
- ERRORS SHALL BE PAID BY THE CONTRACTOR. 7. ANY ENGINEERING PROVIDED BY OTHERS SHALL BE STAMPED BY A PROFESSIONAL ENGINEER WATER TO CEMENT RATIO (W/C): ≤ 0.48

SPECIAL INSPECTION:

THE OWNER SHALL EMPLOY SPECIAL INSPECTORS TO PERFORM SPECIAL INSPECTION. BASED ON IBC 2021, SPECIAL INSPECTION WILL BE REQUIRED FOR THE FOLLOWING:

- A. GEOTECHNICAL INVESTIGATIONS B. CAST-IN-PLACE CONCRETE C. STRUCTURAL MASONRY
- D. STRUCTURAL STEEL E. POST-INSTALLED ANCHORS

F. PRECAST CONCRETE

G. DRIVEN PILE FOUNDATIONS H. GUARDRAIL STRANDS MASS TIMBER CONSTRUCTION

FOOTING AND FOUNDATIONS:

1. NET ALLOWABLE BEARING PRESSURE: (PER GEOTEK REPORT #24-1914)

HOLE FILLED WITH LEAN CONCRETE.

- COLUMN FOOTINGS: 2000PSF WALL FOOTING: 2000PSF
- 2. CENTER FOOTINGS UNDER WALLS AND COLUMNS, UNLESS NOTED OTHERWISE. 3. CONCRETE SHALL NOT BE CAST ON FROZEN GROUND OR GROUND CONTAINING STANDING WATER. OWNER'S SOILS CONSULTANT SHALL REVIEW SUBGRADE PRIOR TO CASTING OF FOOTINGS AND SLABS. PROTECT SOIL FROM FREEZING AFTER CASTING FOOTING.
- 4. UNLESS NOTED OTHERWISE, SLABS ON GRADE SHALL CONTAIN FIBERMESH REINFORCEMENT. SLAB SHALL BE PLACED OVER VAPOR BARRIER AND 6" MINIMUM COMPACTED GRANULAR FILL.
- OWNER'S SOILS CONSULTANT SHALL VERIFY SUBGRADE PRIOR TO PLACEMENT OF ANY FILL BELOW SLABS. 5. PLACE REINFORCING IN ALL FOOTINGS PRIOR TO CASTING. FLOATING OF REINFORCING INTO
- FOOTING AFTER CASTING IS NOT PERMITTED. HOLD REINFORCING IN PLACE DURING CASTING OPERATIONS. CONSOLIDATE CONCRETE. 6. BASEMENT WALLS SHALL NOT BE BACKFILLED UNTIL LOWER LEVEL SLAB AND FIRST FLOOR
- STRUCTURE IS IN PLACE, UNLESS BRACING IS PROVIDED. 7. BACKFILL PLACED AGAINST FOUNDATION WALLS SHALL BE CLEAN, FREE-DRAINING GRANULAR MATERIAL FOR A MINIMUM OF 2FT AGAINST WALL. COMPACT SOILS ADJACENT TO FOUNDATION
- WALLS USING HAND EQUIPMENT. 8. STEPS IN FOOTING, FOUNDATION WALLS, AND GRADE BEAMS SHALL BE COORDINATED WITH WALL FORMING SYSTEM.
- 9. SEE ARCHITECTURAL DRAWINGS FOR OTHER REVEALS, INSERTS, EMBEDS, AND BOLTS. 10. ALL CAST-IN-PLACE ANCHOR BOLTS SHALL BE SET WITH TEMPLATES. 11. PIPING RUNNING BELOW FOOTING SHALL BE PLACED PRIOR TO FOOTING OPERATIONS AND THE

DRILLED PIERS:

- 1. THE SHALL BE CONTINUOUS SPECIAL INSPECTION DURING THE INSTALLATION OF PIERS. 2. SIZE, LENGTH, CASING, BELLING, ETC OF PIERS SHOWN ON THE DRAWINGS ARE MEANT TO BE FOR ESTIMATING PURPOSES ONLY, BASED ON EARLY SOILS INVESTIGATIONS. ACTUAL DIAMETER, LENGTH, ETC. OF PIERS SHALL BE DETERMINED BY THE SPECIAL INSPECTOR IN ORDER TO MEET
- CAPACITY OF PIERS SHOWN. 3. CONTRACTOR SHALL BE PLACED IMMEDIATELY AFTER SHAFT IS CLEANED, INSPECTED, AND REBAR

IS INSTALLED. AT NO TIME SHALL ANY PERSONNEL ACCESS SHAFT.

- UNDERPINNING: 1. UNDERPINNING OPERATIONS SHALL IMPART NO EXCESSIVE STRESS OR MOVEMENTS TO EXISTING
- 2. UNDERPINNING OPERATIONS SHALL BE DEEMED COMPLETED WHEN ALL ASSOCIATED WORK HAS ACHIEVED PROPER STRENGTH, AND ALL FINAL BRACING ITEMS (SLAB, WALL, ETC) ARE IN PLACE
- AND PROPERLY CURED. 3. CONTRACTOR SHALL SUBMIT FULL UNDERPINNING SCHEDULE, INCLUDING BRACING, AND OTHER TEMPORARY ITEMS FOR REVIEW PRIOR TO COMMENCING UNDERPINNING OPERATIONS.

4. UNDERPINNING SHALL TAKE PLACE IN SEGMENTS NO MORE THAN 4FT WIDE AT ANY ONE TIME.

CONCRETE SHALL BE ALLOWED TO GAIN SUFFICIENT STRENGTH PRIOR TO CONTINUING WITH NEXT 5. EXISTING MASONRY WALLS SHALL BE SURVEYED PRIOR, DURING AND AFTER UNDERPINNING

OPERATIONS TO ENSURE NO MOVEMENT OCCURS.

4000PSI

1. CONCRETE STRENGTHS: 145PCF CONCRETE DENSITY. MINIMUM 28-DAY CONCRETE STRENGTHS

- TYPICAL-UNLESS NOTED OTHERWISE: BEAMS, JOISTS, AND FORMED SLABS: 4000PSI 3500PSI 3500PSI 3500PSI 3500PSI 4000PSI 4000PSI
- 2. ALL CONCRETE WORK SHALL CONFORM TO THE LATEST EDITIONS OF ACI 301, 305, 306, 311, 315, 318
- 3. CONCRETE MIX DESIGN SHALL CONFORM TO ACI 301 AND 318. WATER SHALL NOT BE ADDED ON
 - A. INTERIOR SLAB ON GRADE:
 - AIR CONTENT: NO MORE THAN 3% B. FOOTINGS & FOUNDATION WALLS
 - WATER TO CEMENT RATIO (W/C): ≤ 0.48 AIR CONTENT: 6.5% +/- 1%
- 5. DRYPACK OR GROUT SHALL HAVE A MINIMUM 28-DAY COMPRESSIVE STRENGTH OF 7,000psi. 6. CONCRETE SLABS ON GRADE SHALL HAVE CONSTRUCTION JOINTS OR CUT JOINT AT 12FT O.C. MAXIMUM IN EACH DIRECTION. CUT SLAB BETWEEN 4 AND 12 HOURS AFTER CASTING SLAB. ISOLATE COLUMNS, WALLS, AND PIERS FROM SLABS AS SHOWN ON DRAWINGS. DO NOT CUT
- SLABS-ON-DECK OR PRECAST TOPPING SLABS. 7. SEE ARCHITECTURAL DRAWINGS FOR SLAB DEPRESSIONS. PITCH SLAB TO DRAIN WITHOUT REDUCING THICKNESS OF CONCRETE SECTION.
- 8. PROVIDE CONSTRUCTION JOINTS IN EXPOSED WALLS AT A MAXIMUM SPACING OF 40FT. COORDINATE LOCATION OF JOINT WITH ARCHITECTURAL DRAWINGS. PROVIDE CONSTRUCTION JOINTS IN UNEXPOSED WALLS AT A MAXIMUM SPACING OF 60FT.
- PROPERLY CONSOLIDATE CONCRETE WHEN CASTING. 10. DO NOT PLACE CONDUIT, PIPES, OR DUCTS WITHIN COLUMNS, BEAMS, WALLS, OR SLAB SYSTEMS WITHOUT APPROVAL FROM STRUCTURAL ENGINEER.

REINFORCING BARS:

1. BAR DETAILING SHALL CONFORM TO THE LATEST ACI DETAILING MANUAL. PROVIDE COVER TO REINFORCEMENT AS LISTED IN ACI 318.

9. ALL JOINTS IN CONCRETE CONSTRUCTION SHALL BE KEYED WITH A MINIMUM 2X4 KEYWAY.

- 2. STEEL SHALL BE AS FOLLOWS: REBAR- ASTM A605- GR 60 WELDABLE REINFORCING- A706, GR 60
- WELDED WIRE FABRIC- ASTM A185 3. ALL FIELD BENDING OF REINFORCING SHALL BE DONE COLD. DO NOT HEAT REINFORCEMENT. 4. BAR LAPS SHALL BE AS FOLLOWS, UNLESS NOTED OTHERWISE. STAGGER SPLICES OF
- REINFORCING BY 24 INCHES AT ALTERNATE BARS. BEAMS/JOIST TOP AND BOTTOM BARS – 48DB COLUMN/WALL VERTICAL BARS – 48DB
- TIES 38DB 5. HOLD REINFORCING IN PLACE DURING CASTING OPERATIONS.

MASONRY

- 1. HOLLOW CONCRETE MASONRY UNITS: NORMAL WEIGHT, F'M=2000, MORTAR TYPE "S" OR "M", GROUT STRENGTH – 2000PSI. 2. MASONRY CONSTRUCTION SHALL COMPLY WITH THE LATEST VERSION OF TMS 402/602. SEE IBC 2021/2018/2015 FOR HOT AND COLD WEATHER PROCEDURES.
- 3. CMU SHALL BE LAID IN A RUNNING-BOND PATTERN. 4. PROVIDE BOND BEAMS WITH 2 #5 AT ALL FLOOR LINES, ROOF LINES, TOP OF WALL, AND AT 12'-0"
- O.C. MAXIMUM SPACING IN WALL. 5. PROVIDE REINFORCING AT CENTER OF CORES OF CMU CONSTRUCTION, OR AS INDICATED ON STRUCTURAL DRAWINGS. HOLD REINFORCING IN PLACE DURING GROUTING OPERATIONS. FILL ALL
- REINFORCED CELLS WITH GROUT. FILL ALL CMU CELLS SOLID BELOW GRADE. SEE DRAWINGS FOR OTHER GROUTING. CONSOLIDATED GROUT.
- 6. GROUT CELLS FLOOR-TO-FLOOR AT JAMBS OF OPENINGS. 7. LAP BARS 48 BAR DIAMETERS, UNLESS NOTED OTHERWISE.
- 8. PROVIDE HORIZONTAL JOINT REINFORCEMENT AT 16" O.C. MAX SPACING PER SPECIFICATION. 9. HIGH LIFT GROUTING WILL NOT BE PERMITTED WITHOUT AN APPROVED WRITTEN PROCEDURE SUBMITTED THROUGH THE ARCHITECT.
- 10. USE GROUTED KEYWAYS OR PREMANUFACTURED JOINTS AT ALL CONTROL JOINTS.
- 11. DO NOT PLACE CONDUIT, CHASES, OR OTHER EMBED ITEMS IN GROUTED CELLS WITHOUT PRIOR APPROVAL FROM THE STRUCTURAL ENGINEER.
- 12. LOCATE CONTROL JOINTS IN CMU AT A MAXIMUM SPACING OF 20FT, UNLESS NOTED OTHERWISE. LOCATE CONTROL JOINTS IN EXTERIOR MASONRY PER ARCHITECTURAL DRAWINGS.
- 13. CONTINUE REINFORCING THROUGH CONTROL JOINTS. WRAP REBAR WITH BOND-BREAKING TAPE 2'-0" EACH SIDE OF JOINT. DO NOT SPLICE REINFORCING WITHIN 4FT OF JOINTS. 14. ALL NON-LOAD BEARING CMU WALLS TO HAVE #5 REBAR GROUTED SOLID @ 48" O.C. U.N.O.

LINTELS:

LINTELS SHALL BE PLACED ABOVE ALL OPENINGS AND RECESSES IN MASONRY CONSTRUCTION. 2. LINTELS NOT SHOWN ON THE CONSTRUCTION DRAWINGS SHALL BE AS FOLLOWS:

SPAN	NOMINAL THICKNESS	LINTEL
	4"	L3.5x3.5x1/4"
	6"	BOND BEAM w/ (1) #4
0'-0" - 2'-0"	8"	BOND BEAM w/ (2) #5
	10"	20112 221 1111 117 (2) 113
	12"	BOND BEAM w/ (2) #5
	4"	L3.5X3.5X1/4"
2'-1" - 4'-0"	6"	BOND BEAM w/ (1) #4
	8"	BOND BEAM w/ (2) #5
	10"	BOND BEAM w/ (2) #5
	12"	BOND BEAM w/ (2) #5
	4"	L5X3.5X1/4" LLV
	6"	BOND BEAM w/ (1) #4
4'-1" - 6'-0"	8"	BOND BEAM w/ (2) #5
	10"	BOND BEAM w/ (2) #5
	12"	BOND BEAM w/ (2) #5

3. STEEL LINTELS SHALL HAVE A MINIMUM OF 8" BEARING ON FULLY GROUTED CELL.

6. GALVANIZE ALL STEEL EXPOSED TO WEATHER.

1. STEEL SHALL BE DETAILED, FABRICATED AND ERECTED PER AMERICAN INSTITUTE OF STEEL CONSTRUCTION (AISC) CODE OF STANDARD PRACTICE FOR STEEL BUILDINGS AND BRIDGES.

CONCINCOTION (MICO) COBE OF CITAIND MICE	TIVIO HOL TON OTLLE DO	LDINGO / WID DINDOLG
HIGH STRENGTH BOLTS SHALL BE INSTALLE	D PER AISC SPECIFICATION	NS FOR STRUCTURAL
USING ASTM A325 OR A490 BOLTS.		
PROPERTIES:		
 WIDE FLANGE SHAPES 	ASTM A992	Fy = 50 KSI
 OTHER ROLLED SHAPES 	ASTM A36	Fy = 36 KSI
 PIPE SECTIONS 	ASTM A53, GR B	Fy = 35 KSI
 HSS SECTIONS, ROUND 	ASTM A500, GR C	Fy = 46 KSI
 HSS SECTION, SQ/RECT 	ASTM A500, GR C	Fy = 50 KSI
HP SHAPES	ASTM A572	Fy = 50 KSI
 BASE AND CONNECTION PLATES 	ASTM A36 A572	Fy = 36 50 KSI
 ANCHOR RODS 	ASTM F1554, GR 36 55	Fy = 36 55 KSI
 HIGH STRENGTH BOLTS 	ASTM F3125, GR A325	Fy = 120 KSI
 HIGH STRENGTH TWIST-OFF BOLTS 	ASTM F3125, GR A325	,
 HEAVY HEX NUTS 	ASTM A563	
WA CHEDO	A OTH A E 400	

- 4. SIMPLE SHEAR CONNECTIONS NOT FULLY DETAILED ON THE STRUCTURAL DRAWINGS SHALL BE SELECTED BY THE STEEL FABRICATOR FROM APPROPRIATE AISC LOAD TABLES USING END
- CONNECTIONS SHALL BE USED. BOLTED CONNECTIONS SHALL USE A MINIMUM OF 2 BOLTS. 5. ALL WELDING SHALL BE PERFORMED BY CERTIFIED WELDERS WITH EXPERIENCE IN THAT TYPE OF JOINT. WELDING SHALL BE ACCORDING TO AMERICAN WELDING SOCIETY. STRUCTURAL WELDING CODE. IN LIEU OF AWS WELDING CERTIFICATES, WELDERS EMPLOYED ON THE WORK MAY PROVIDE
- 7. PAINT STEEL EXPOSED TO VIEW WITH MANUFACTURER'S STANDARD PRIMER. DO NOT PRIME STEEL RECEIVING FIRE-PROOFING, OR AT WELDS. IF STEEL MEMBERS ARE NOT EXPOSED TO VIEW,
- 8. HEADED STEEL STUDS SHALL BE PLACED ON BEAMS IN FIELD, ARC-WELDED THROUGH METAL
- FLOOR DECK. SEE STUD REPLACEMENT DETAIL. 9. DO NOT FIELD TORCH-CUT HOLES OR NOTCHES IN STEEL MEMBERS WITHOUT PRIOR APPROVAL

INDICATED. ANCHOR BOLTS SHALL BE EMBEDDED 12 X (DIA. OF BOLT) MEASURED TO UNDERSIDE

11. FURNISH AND INSTALL OTHER MISCELLANEOUS STEEL AS CALLED OUT OR REQUIRED BY ARCHITECTURAL, MECHANICAL, PLUMBING AND ELECTRICAL DRAWINGS. 12. PROVIDE 5.000 PSI NON-SHRINK GROUT UNDER BASE PLATES AND BEARING PLATES WHERE

12 BUND BEAM W/ (2) #3

BACK-TO-BACK ANGELS SHALL BE WELDED TOGETHER WITH 2" WELD AT 12" O.C.

5. GROUT ALL CMU CORES SOLID UNDER LINTEL BEARING, BEAMS AND BEARING PLATES.

STRUCTURAL STEEL:


HIGH OTHER OTH DOLL	O OI I LEE DE INO I LEEE		NO I OIL OILLOOI OILL
USING ASTM A325 OR A	\490 BOLTS.		
PROPERTIES:			
 WIDE FLANGE S 	SHAPES	ASTM A992	Fy = 50 KSI
 OTHER ROLLED) SHAPES	ASTM A36	Fy = 36 KSI
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 ANCHOR RODS 	i	ASTM F1554, GR 36 55	Fy = 36 55 KSI
 HIGH STRENGT 	H BOLTS	ASTM F3125, GR A325	Fy = 120 KSI
 HIGH STRENGT 	H TWIST-OFF BOLTS	ASTM F3125, GR A325	•
 HEAVY HEX NU 	TS	ASTM A563	
 WASHERS 		ASTM F436	
 HEADED STUD 	ANCHORS	ASTM A108, TYPE B	
 ELECTRODES F 	OR ARCH WELDING	AWS 5.1, E70XX	
		·	

REACTION SHOWN ON PLANS. DOUBLE ANGLE, SINGLE ANGLE, OR WELDED SHEAR PLATE

WELDING TESTS THAT HAVE BEEN PERFORMED WITHIN THE LAST 12 MONTHS. 6. UNLESS NOTED OTHERWISE, WELDS SHALL BE 3/16" THROAT THICKNESS. CONTRACTOR MAY ELECT TO NOT PRIME THIS STEEL. GALVANIZE ALL STEEL EXPOSED TO

FROM THE STRUCTURAL ENGINEER. 10. BOLTS SHOWN ON STRUCTURAL DRAWINGS SHALL BE 3/4" DIAM., A325-N BOLTS UNLESS NOTED OTHERWISE. USE TWIST-OFF TYPE BOLTS FOR CONNECTIONS REQUIRING FULLY TIGHTENED CONDITIONS.

					ABBREVIATIONS				
ADJ	ADJACENT	CONST	CONSTRUCTION	GC	GENERAL CONTRACTOR	MTL	METAL	SL	SNOW LOAD
ACI	AMERICAN CONCRETE INSTITUTE	CONT	CONTINUOUS	H/C	HOLLOWCORE	NIC	NOT IN CONTRACT	SJI	STEEL JOIST INSTITUTE
AISC	AMERICAN INSTITUTE OF STEEL CONSTRUCTION	DBL	DOUBLE	HDR	HEADER	NLB	NON-LOAD BEARING	SPA	SPACES, SPACING
ANCH	ANCHOR	DTL	DETAIL	HORIZ	HORIZONTAL	NWT	NORMAL WEIGHT	SPC	SPECIAL
APA	AMERICAN PLYWOOD ASSOCIATION	DIA	DIAMETER	HAS	HEADED STUD ANCHOR	NO	NUMBER	SPECS	SPECIFICATIONS
ARCH	ARCHITECT/ARCHITECTURAL	DIAG	DIAGONAL	HSS	HOLLOW STRUCTURAL SECTION	NTS	NOT TO SCALE	STD	STANDARD
BLDG	BUILDING	DIM	DIMENSION	IBC	INTERNATIONAL BUILDING CODE	ОС	ON CENTER	STL	STEEL
BLKG	BLOCKING	DL	DEAD LOAD	ID	INSIDE DIAMETER	OD	OUTSIDE DIAMETER	STRUCT	STRUCTURAL
ВМ	BEAM	DWG	DRAWING	INSUL	INSULATION	P/C	PRECAST	T&B	TOP & BOTTOM
BOF	BOTTOM OF FOOTING	EA	EACH	JST	JOIST	PL	PLATE	T&G	TONGUE & GROOVE
BOS	BOTTOM OF STEEL	EL	ELEVATION	JT	JOINT	PSF	POUNDS per SQUARE FOOT	THK	THICK/THICKENED
вот	BOTTOM	EMB	EMBEDDED, EMBEDMENT	K	KIP	PSI	POUNDS per SQUARE INCH	TOF	TOP OF FOOTING
BRG	BEARING	EOR	ENGINEER OF RECORD	KLF	KIP PER LINEAL FOOT	QTY	QUANTITY	TOS	TOP OF STEEL
BSMT	BASEMENT	EQ	EQUAL	KSF	KIP PER SQUARE FOOT	REC	RECESSED	TOW	TOP OF WALL
втв	BACK-TO-BACK	EXIST	EXISTING	LG	LIGHT GAUGE STEEL	REINF	REINFORCEMENT	TPI	TRUSS PLATE INSTITUTE
CANT	CANTILEVER	EXP	EXPANSION	LL	LIVE LOAD	REF	REFERENCE	TRANS	TRANSVERSE
CFS	COLD FORMED STEEL	EXT	EXTERIOR	LLH	LONG LEG HORIZONTAL	REV	REVISION	TYP	TYPICAL
CL	CENTERLINE	FND	FOUNDATION	LLV	LONG LEG VERTICAL	REQD	REQUIRED	UNO	UNLESS NOTED OTHERWISE
CLR	CLEAR/CLEARANCE	FFE	FINISHED FLOOR ELEVATION	LOC	LOCATION, LOCATE	SCHED	SCHEDULE	VAR	VARIES
CMU	CONCRETE MASONRY UNIT	FLR	FLOOR	MAX	MAXIMUM	SDI	STEEL DECK INSTITUTE	VERT	VERTICAL
COL	COLUMN	FTG	FOOTING	MECH	MECHANICAL	SDL	SUPERIMPOSED DEAD LOAD	WD	WOOD
CONC	CONCRETE	GA	GAUGE	MEZZ	MEZZANINE	SECT	SECTION	WL	WIND LOAD
CONN	CONNECTION	GALV	GALVANIZED	MIN	MINIMUM	SIM	SIMILAR	WWF	WELDED WIRE FABRIC

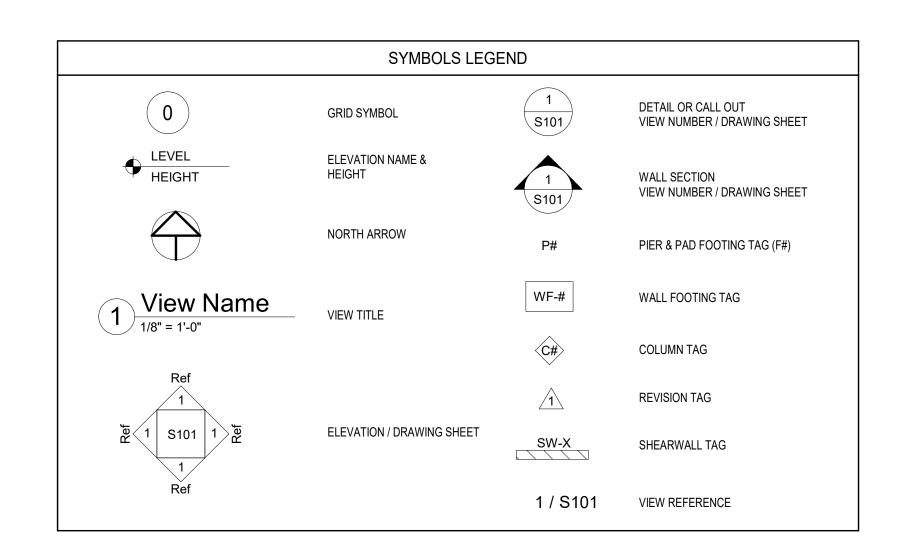

SHEET LIST STRUCTURAL NOTES & SCHEDULES FOOTING & FOUNDATION PLAN

STRUCTURAL NOTES

WIND UPLIFT PLAN

FLOOR FRAMING PLAN

ROOF FRAMING PLAN

FRAMING ELEVATIONS


FRAMING ELEVATIONS

STRUCTURAL DETAILS

STRUCTURAL DETAILS

STRUCTURAL DETAILS

STRUCTURAL DETAILS

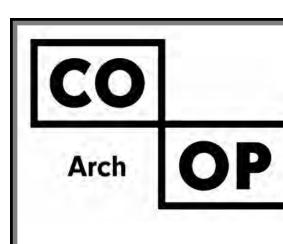

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CO-OP PROJECT NO:



ISSUE: 5/15/2025 100% CD REVISION SCHEDULE:

REV. # REV. DSC.

PROJECT: NORTHERN ELECTRIC RENOVATION NORTHERN ELECTRIC COOPERATIVE ABERDEEN, SOUTH DAKOTA

SHEET TITLE: STRUCTURAL NOTES

STEEL DECK:

 DESIGN, FABRICATE, DELIVER, AND ERECT METAL ROOF DECK, NON-COMPOSITE METAL DECK, AND COMPOSITE METAL DECK ACCORDING TO THE SPECIFICATIONS AND RECOMMENDATIONS OF THE STEEL DECK INSTITUTE (SDI). SUBMITTALS:

THE FOLLOWING SUBMITTALS SHALL BE PROVIDED
 A. CONCRETE & GROUT MIX DESIGNS

B. PRECAST ELEMENTS & CONNECTIONSC. CONCRETE & CMU REINFORCEMENT

E. POST-INSTALLED ANCHORS & EPOXY

G. STEEL BAR JOISTS & JOIST GIRDERS

H. METAL FLOOR & ROOF DECK

K. WOOD WALL PANELS

CONTRACTOR/SUPPLIER.

ENGINEER.

DELEGATED DESIGNS:

I. COLD-FORMED STEEL FRAMING

L. WOOD FLOOR & ROOF TRUSSES

M. GLU-LAM FRAMING & CONNECTIONS

F. STRUCTURAL STEEL FRAMING & MISCELLANEOUS METALS

J. ALUMINUM FRAMING (DECKS, CANOPIES, GUARDRAILS, ETC.)

2. SUBMITTALS SHALL BE REVIEWED AND COORDINATED PRIOR TO SUBMITTING TO THE ARCHITECT.

3. SUBMITTALS SHALL BE REVIEWED BY THE ARCHITECT AND STRUCTURAL ENGINEER FOR GENERAL CONFORMANCE WITH DESIGN CONCEPT ONLY. NOTATIONS MADE BY THE ARCHITECT AND

D. STEEL STAIRS, ACCESS LADDERS, HANDRAILS, GUARDRAILS, GRATING & CONNECTIONS.

E. ALUMINUM DECKS, AWNINGS/CANOPIES, HANDRAILS, GUARDRAILS & CONNECTIONS.

STRUCTURAL ENGINEER ON THE SUBMITTALS DO NOT RELIEVE THE CONTRACTOR FROM

MANAGER/GENERAL CONTRACTOR. REVIEW BY THE ARCHITECT SHALL NOT BEGIN UNTIL THIS IS COMPLETE. WORK SHALL NOT BEGIN WITHOUT REVIEW BY THE ARCHITECT AND STRUCTURAL

EACH SUBMITTAL SHALL BE STAMPED INDICATING REVIEW BY THE CONSTRUCTION

COMPLYING WITH THE REQUIREMENTS OF THE CONSTRUCTION DRAWINGS.

1. THE DESIGN OF THE FOLLOWING BUILDING COMPONENTS SHALL BE DELEGATED TO THE

F. LOAD BEARING & NON-LOAD BEARING COLD-FORMED STEEL FRAMING.

2. DESIGN ITEMS THAT HAVE BEEN DELEGATED WILL REQUIRE THE CONTRACTOR/SUPPLIER TO PROVIDE SHOP DRAWINGS AND CALCULATIONS TO THE ENGINEER OF RECORD THAT HAVE BEEN SIGNED AND STAMPED BY A PROFESSIONAL ENGINEER LICENSED IN THE STATE WHERE THE

3. THE DESIGN OF DELEGATED ITEMS MAY BE DEFERRED UNTIL AFTER A BUILDING PERMIT HAS BEEN

I. MASS-TIMBER FLOOR PANELS, WALL PANELS & CONNECTIONS.

N. MASS-TIMBER FLOOR / WALL PANELS & CONNECTIONS

A. EXCAVATION, SHORING, & UNDERPINNING.

. STRUCTURAL STEEL CONNECTIONS.

G. WOOD FLOOR AND ROOF TRUSSES.

H. GLU-LAM COLUMNS, BEAMS & CONNECTIONS.

B. PRECAST CONCRETE ELEMENTS & CONNECTIONS.

D. CAST-IN-PLACE ANCHOR BOLTS

- STEEL DECK INSTITUTE (SDI).

 2. STEEL DECK PROPERTIES SHALL BE (AT MINIMUM), THOSE LISTED IN VULCRAFT CATALOGS FOR THE TYPE AND GAGE SHOWN ON THE DRAWINGS.
- STEEL DECK SHALL BE ATTACHED TO SUPPORTING STRUCTURE AS NOTED ON PLANS.

 3. USE WELD-WASHERS WHEN WELDING THROUGH DECK. POWDER DRIVEN FASTENERS, IF DESIRED FOR DECK ATTACHMENT, SHALL BE SUBMITTED FOR DEVIEW.
- FOR DECK ATTACHMENT, SHALL BE SUBMITTED FOR REVIEW.

 4. ROOF/FLOOR DECKING THAT WILL HAVE CONCRETE POURED ON TOP OF IT OR IS LOCATED IN AN AREA THAT WILL HAVE HIGH HUMIDITY SHALL BE GALVANIZED. FOR ALL OTHER INSTANCES THE
- DECKING SHALL BE PRIME-PAINTED.

 5. ROOF DECK AND NON-COMPOSITE DECK ENDS SHALL BE LAPPED 2" OVER SUPPORT. COMPOSITE DECK ENDS SHALL BE BUTTED OVER CENTER OF SUPPORT.

 6. ROOF DECK ENDS SHALL BE BUTTED OVER CENTER OF SUPPORT.
- PROVIDE HIP AND VALLEY PLATES, GIRDER FILLERS, END CLOSERS, CANT STRIPS, SUMP PANS, EDGE FORMS AND OTHER ACCESSORIES AS SHOWN ON THE STRUCTURAL AND ARCHITECTURAL DRAWINGS, OR AS NEEDED TO PROVIDE A COMPLETE DECK SYSTEM SHOWN ON THE DRAWINGS.
- SUPPORT DECK AT SUMP PANS AND OTHER ROOF DECK OPENINGS. SEE DETAILS.
 HANG LOADS FROM STEEL BEAMS AND JOISTS WHENEVER POSSIBLE. PROVIDE UNISTRUT, ANGLES, OR TUBES TO ACCOMMODATE THIS. DO NOT HANG ANY LOADS FROM ROOF DECK OR NON-COMPOSITE DECK. LOADS LESS THAN 100LBS MAY BE HUNG FROM CURED, COMPOSITE DECK. RESPONSIBILITY FOR DESIGN OF MEP SUPPORT SYSTEMS WILL BE WITH THE CONTRACTOR.

STEEL JOISTS:

- DESIGN, FABRICATE, DELIVER, AND ERECT OPEN WEB STEEL JOISTS, JOIST GIRDERS, AND ACCESSORIES ACCORDING TO THE SPECIFICATIONS OF THE STEEL JOIST INSTITUTE (SJI).

 THE BASIS OF DESIGN FOR JOIST SIZES SHOWN ON THE DRAWINGS IS DEPOVILED FOR JOIST DESIGN.
- 2. THE BASIS OF DESIGN FOR JOIST SIZES SHOWN ON THE DRAWINGS IS PER VULCRAFT DÉSIGN CATALOG. SPECIAL JOIST PRELIMINARY SIZES SHOWN ARE BASED ON SNOW DRIFT AND
- MECHANICAL LOADS SHOWN ON DOCUMENTS.

 3. ATTACH STEEL JOIST TO SUPPORT AS FOLLOWS:

		LS WITH ORMATION	DETAILS \ BOLT INFOR			MUM END RING (IN.)
JOIST TYPE/SERIES	FILLET WELD SIZE	WELD LENGTH (IN.)	BOLT DIAMETER (IN.)	BOLT MATERIAL	STEEL	MASONRY
K	1/8	2	1/2	A307	2 1/2	4
LH/DLH 02-06	3/16	2	3/4	A307	2 1/2	6
LH/DLH 07-17	1/4	2	3/4	A307	4	6
LH/DLH 18-25	1/4	4	3/4	A325	6	6
JOIST GIRDER	1/4	2	3/4	A307	4	6

- 4. PROVIDE BRIDGING, EXTENDED ENDS, SLOPED BEARINGS, CEILING EXTENSIONS AND OTHER ACCESSORIES AS SHOWN ON THE STRUCTURAL AND ARCHITECTURAL DRAWINGS.
- 5. BRIDGING SHOWN ON DRAWINGS SHALL BE USED FOR ESTIMATING ONLY. FINAL SIZE, CONFIGURATION, AND QUANTITY OF BRIDGING SHALL BE DETERMINED BY THE JOIST
- MANUFACTURER. UPLIFT BRIDGING MAY BE REQUIRED- SEE DRAWINGS.

 6. WHERE BRIDGING INTERFERES WITH MECHANICAL DUCTWORK OR PIPING, BRIDGING MAY BE REMOVED AFTER ROOF DECK ATTACHMENT. NOTIFY STRUCTURAL ENGINEER OF LOCATIONS
- PRIOR TO REMOVAL.

 7. PAINT JOISTS WITH MANUFACTURER'S STANDARD RUST-INHIBITING PRIMER. JOISTS TO RECEIVE
- FAINT JOISTS WITH MANUFACTURER'S STANDARD ROST-INHIBITING PRIMER: JOISTS TO RECEIVE FIREPROOFING ARE NOT TO BE PAINTED.
 TO AID IN BEARING SEAT DESIGN FOR JOISTS, IF JOIST MANUFACTURER WOULD LIKE TO STAGGER JOISTS ON EITHER SIDE OF A SUPPORT, THIS SHALL BE SUBMITTED FOR APPROVAL ON THE SHOP
- DRAWINGS.

 9. JOISTS BEARING ABOVE A COLUMN LINE SHALL HAVE ERECTION BOLTS IN THE BEARING SEAT.

 BOTTOM CHORDS SHALL BE ALSO EXTENDED TO THE FACE OF THE COLLIMN.
- BOTTOM CHORDS SHALL BE ALSO EXTENDED TO THE FACE OF THE COLUMN.

 10. JOISTS SHALL BE WELDED TO SUPPORTS, TYPICAL.

 11. LIGHT-WEIGHT MECHANICAL DUCTS, CONDUIT, AND CEILING MAY BE HUNG AT ANY POINT ALONG
- THE JOIST BOTTOM OR TOP CHORD.

 12. LOADS GREATER THAN 100LBS SHALL BE HUNG WITHIN 6" OF TOP AND BOTTOM CHORD POINTS.
 LOADS HUNG OUTSIDE THIS RANGE SHALL HAVE ADDED BRACING TO NEAREST CHORD POINT, AS SHOWN ON THE DETAILS.

LIGHT GAGE STEEL:

- LIGHT GAGE STEEL DESIGN, DETAILING AND ERECTION SHALL FOLLOW STEEL STUD
 MANUFACTURED ASSOCIATION (2014) SHIPE INTER
- MANUFACTURERS ASSOCIATION (SSMA) GUIDELINES.

 2. LIGHT GAGE CALLED OUT ON THE DRAWINGS SHALL HAVE A MINIMUM PROPERTIES CALLED OUT IN
- THE LATEST EDITION OF SSMA PRODUCT TECHNICAL INFORMATION.

 3. END TRACK GAGE SHALL MATCH WALL STUD GAGE. ALIGN STUDS BELOW STRUCTURAL MEMBERS ABOVE. PROVIDE FULL BEARING OF WALL STUDS TO TOP AND BOTTOM TRACK. STUDS SHALL NOT
- HAVE PUNCH-OUT LOCATED AT ENDS OF STUDS.

 4. PROVIDE TRACK, BRIDGING, BLOCKING, HEADERS, CLIP-ANGLES, SLIDE CLIPS, FASTENERS, AND OTHER ACCESSORIES AS NEEDED TO SUPPLY A COMPLETED LIGHT-GAGE SYSTEM AS SHOWN ON
- THE DRAWING.

 5. PROVIDE BRIDGING AT 4'-0" O.C. MAXIMUM SPACING IN BEARING ,SHEAR AND EXTERIOR WALLS. PROVIDE FULL DEPTH BLOCKING AT ALL SHEAR PANEL EDGES.
- PROVIDE FULL DEPTH BLOCKING AT ALL SHEAR PANEL EDGES.

 6. SCREW SHEATHING FOR FLOORS & ROOFS WITH #8 SCREWS AT 6" O.C. AT PANEL EDGES AND 12"

 O.C. IN THE FIELD. STAGGER EDGES OF PANELS.
- PROVIDE 2 FULL HEIGHT STUDS AT JAMBS OF OPENINGS, UNLESS NOTED OTHERWISE.
 ALL WELDED CONNECTIONS SHALL BE DONE BY PERSONNEL CERTIFIED IN LIGHT-GAGE WELDING.

WOOD:

- WOOD CONSTRUCTION SHALL COMPLY WITH IBC 2021/2018/2015, AMERICAN INSTITUTE OF TIMBER
- CONSTRUCTION, AND THE AMERICAN WOOD COUNCIL.

 2. MEMBERS PROPERTIES SHALL BE AS FOLLOWS, UNLESS NOTED OTHERWISE:
 - ROOF SHEATHING- 19/32" APA RATED SHEATHING (FLAT ROOF).
 ROOF SHEATHING- 7/16" APA RATED SHEATHING (PITCHED ROOF).
 - FLOOR SHEATHING- ¾" APA RATED TONGUE & GROOVE SHEATHING.
 WALL SHEATHING- 7/16" APA RATED SHEATHING/5/8" EXTERIOR GYPSUM SHEATHING.
- 2X4 THROUGH 2X10: SPRUCE-PINE-FIR #1/#2 (OR EQUAL).
 2X12: SPRUCE-PINE-FIR SELECT STRUCTURAL (OR EQUAL).
- LAMINATED VENEER LUMBER (LVL): E= 1,900,000PSI, FB= 2,600PSI
 DO NOT DRILL OR NOTCH STRUCTURAL ELEMENTS WITHOUT PRIOR APPROVAL FROM THE
- STRUCTURAL ENGINEER.

 4. CONNECTIONS NOT SHOWN SHALL BE FASTENED PER TABLE 2304.10.1 IN IBC 2021.

 5. PLYWOOD INDICATED AS RATED SHEATHING, SHALL BEAR THE APPROPRIATE MARK OF THE
- AMERICAN PLYWOOD ASSOCIATION. ALL WOOD MEMBERS SHALL BEAR THE APPROPRIATE MARK OF THE APPROPRIATE ACCREDITING AGENCY.
- 6. HOLES FOR BOLTS SHALL BE MATCH-DRILLED IN FIELD TO ENSURE PROPER ALIGNMENT. PROVIDE WASHERS AT ALL BOLT LOCATIONS.
- WASHERS AT ALL BOLT LOCATIONS.
 7. FASTEN SHEATHING FOR FLOORS AND ROOFS TO WOOD FRAMING WITH 10d COMMON NAILS (0.148"x3") AT 6" O.C. AT PANEL EDGES AND SUPPORTING MEMBERS. LONG EDGE OF PANEL SHALL
- BE APPLIED PERPENDICULAR TO FRAMING MEMBERS. STAGGER PANEL EDGES AND PROVIDE BLOCKING AT PANEL EDGES WHERE SPECIFIED.
- PROVIDE 2 FULL HEIGHT STUDS AT JAMBS OF OPENINGS, UNLESS NOTED OTHERWISE.
 CONNECT FRAMING MEMBERS WITH APPROVED LIGHT-GAGE CONNECTORS FROM SIMPSON
- STRONG TIE, OR EQUAL. CONNECT PER MANUFACTURERS'S INSTRUCTIONS.

 10. FOR MEMBERS EXPOSED TO WEATHER: NAILS, SCREWS AND BOLTS LESS THAN ½" DIAM SHALL BE STAINLESS STEEL. GREATER THAN ½" SHALL BE GALVANIZED OR STAINLESS STEEL.
- 11. ALL LUMBER IN CONTACT WITH CONCRETE/MASONRY OR EXPOSED TO WEATHER SHALL BE PRESSURE TREATED SOUTHERN PINE #2, UNLESS NOTED OTHERWISE ON PLANS.
- PRESSURE TREATED SOUTHERN PINE #2, UNLESS NOTED OTHERWISE ON PLANS.

 12. SPACING OF BRIDGING FOR JOISTS SHALL NOTE EXCEED 8'-0" O.C. BRIDGING SHALL BE METAL OR
 1X3 MEMBERS.
- 13. DOUBLE ALL JOISTS UNDER PARALLEL PARTITIONS.

 14. MINIMUM ANCHORAGE OF STRUCTURAL WALLS SHALL BE WITH 5/8" ANCHOR BOLT AT 4FT O.C. UNO
- 14. MINIMUM ANCHORAGE OF STRUCTURAL WALLS SHALL BE WITH IN SHEARWALL SCHEDULE
- 15. DESIGN, FABRICATE, AND ERECT PLATE-CONNECTED WOOD TRUSSES TO WITHSTAND LOADS SHOWN IN (DESIGN CRITERIA), ACCORDING TO RULES ESTABLISHED BY TPI.
 SHOP DRAWINGS SHALL INCLUDE STRUCTURAL ANALYSIS STAMPED BY A LICENSED
- ENGINEER IN THE STATE WHERE THE PROJECT IS LOCATED.
 ALL TEMPORARY AND FINAL BRACING SHALL BE DESIGNED PER TPI RECOMMENDATIONS.
 STORE TRUSSES ON SITE IN A MANNER TO MINIMIZE WARPING.
- TRUSS DEFLECTION CRITERIA:
 TOTAL LOAD L/240
 LIVE LOAD L/360

. CO	SPECIAL INSPECTIONS SCHEDULE REQUIRED VERIFICATION & INSPECTION	CONT.	PERIO
. CO		CONT.	PERIC
	NCRETE CONSTRUCTION		
1.			Х
2.	INSPECTION OF REINFORCING STEEL WELDING:		
	a. VERIFICATION OF WELDABILITY OF REINFORCING STEEL OTHER THAN ASTM A706	.,	>
	b. SHEAR REINFORCEMENT	X	
	c. OTHER REINFORCING STEEL		>
	d. BUMPER WALL REINFORCING	Х	
3.	INSPECTION OF BOLTS TO BE INSTALLED IN CONCRETE PRIOR TO AND DURING PLACEMENT OF CONRETE WHERE ALLOWABLE LOADS HAVE BEEN INCREASED OR WHERE STRENGTH DESIGN IS USED.	X	
4.	INSPECTION OF ANCHORS INSTALLED IN HARDENED CONCRETE	X	
5.	VERIFYING USE OF REQUIRED DESIGN MIX)
6.	PERFORM SAMPLING AND TESTING OF CONCRETE ACCORDING TO SPECIFICATIONS	X	
7.	INSPECTION OF CONCRETE PLACEMENT FOR PROPER APPLICATION TECHNIQUES	X	
8.	INSPECTION FOR MAINTENANCE OF SPECIFIED CURING TEMPERATURE AND TECHNIQUES)
9.	INSPECT FORMWORK FOR SHAPE. LOCATION AND DIMENSIONS OF CONCRETE MEMBER BEING FORMED)
10.)
1			
11)
ST	EEL CONSTRUCTION		
1.	MATERIAL VERIFICATION OF HIGH-STRENGTH BOLTS, NUTS, AND WASHERS:		
	A. IDENTIFICATION MARKINGS TO CONFORM TO ASTM STANDARDS SPECIFIED IN CONSTRUCTION DOCUMENTS		2
	B. MANUFACTURER'S CERTIFICATE OF COMPLIANCE REQUIRED		2
2.	INSPECTION OF HIGH-STRENGTH BOLTING:		
•	A. BEARING-TYPE CONNECTIONS		
	B. SLIP-CRITICAL CONNECTION (SEE IBC 1704.3.3)	Х	
3.	MATERIAL VERIFICATION OF STEEL:		
	A. IDENTIFICATION MARKINGS TO CONFORM TO ASTM STANDARDS IN APPROVED CONSTRUCTION DOCUMENTS)
	B. MANUFACTURER'S CERTIFIED MIL TEST REPORTS)
4.	MATERIAL VERIFICATION OF WELD FILLER MATERIALS		
	A. IDENTIFICATION MARKINGS TO CONFORM TO AWS SPECIFICATION IN APPROVED CONSTRUCTION DOCUMENTS		
	B. MANUFACTURER'S CERTIFICATE OF COMPLAINCE REQUIRED		
5.	INSPECTION OF STRUCTURAL STEEL WEDLING:		
1	A. COMPLETE AND PARTIAL PENETRATION GROOVE WELDS	X	
	B. MULTI-PASS FILLET WELDS	X	
	C. SINGLE-PASS FILLET WELDS > 5/16"	X	
	D. SINGLE4 ASS FILLET WELDS > 3/10 D. SINGLE PASS FILLET WELDS ≤ 5/16"		
	E. FLOOR AND DECK WELDS)
6.	INSPECTION OF STEEL FRAME JOINT DETAILS FOR COMPLIANCE WITH CONSTRUCTION DOCUMENTS:		,
0.)
	A. DETAILS SUCH AS BRACING AND STIFFENENING		-
	B. MEMBER LOCATIONS)
T	C. APPLICATINO OF JOINT DETAILS AT EACH CONNECTION)
MA	SONRY CONSTRUCTION (SEE IBC SECTION 1704.5.2)		
1.	VERIFICATION OF SLUMP FLOW AND VSI AS DELIVERED TO THE SITE FOR SELF-CONSOLIDATING GROUT	X	
2.	VERIFICATION OF MASONRY CONSTRUCTION		
	A. PROPORTIONS OF SITE-PREPARED MORTAR		2
	B. CONSTRUCTION OF MORTAR JOINTS		
	C. LOCATION OF REINFORCEMENT, CONNECTORS, AND ANCHORAGES.		
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		BASEF	PLATE	OULE ANCHOR	
MARK	TYPE	THICKNESS	DIAGRAM	BOLTS	REMARKS
C1	HSS 5X5X1/4	3/4"	1	(4)	
C2	HSS 5X5X5/16	3/4"	I	(4)	
C3	HSS 5X5X3/8	3/4"	I	(4)	
C4	HSS 6X6X5/16	3/4"	III	(4)	
C5	HSS 6X6X3/8	3/4"	III	(4)	
C6	HSS 8X6X5/16	3/4"	V	(4)	
C7	HSS 5X5X1/4	3/4"	II	(4)	
C8	HSS 6X6X5/16	3/4"	II	(4)	
C9	HSS 5X5X3/8	3/4"	IV	(4)	
C10	HSS 6X6X5/16	3/4"	IV	(4)	
C11	HSS 6X6X3/8	3/4"	IV	(4)	
C12	HSS 5X5X1/4	3/4"	IV	(4)	
C13	HSS 8X6X5/16	3/4"	IV	(4)	
1 1/2"	4" 4" 11/2" =	3	1 1/2	2" 11/2"-	4 1/2" 4 1/2" 1 1/2"
	1		1'-0"		<u></u>
1 1/2"	1'-5" 8 1/2" 4" 4" 3" 1 1/2"	Δ3	EQ EQ	11/2" 5 1/2" 5 1/2"	<u></u>

2. VERIFY ATTACHMENT AND/OR BRACING OF MISCELLANEOUS ITEMS SUCH AS PIPES, EQUIPMENT, SIGNS, BOLLARDS, ETC.

WALL FOOTING SCHEDULE			
MARK	SIZE	REINFORCEMENT	
	9'-10" x 1'-6"		
WF1	2'-0" x 1'-0"	(2) #5 CONT.	

PA	D FOOTING	SCHEDULE
MARK	SIZE	REINFORCEMENT
F1	4'-0" x 4'-0" x 1'-0"	(5) #5 @ 12" O.C. EA. WAY
F2	5'-0" x 5'-0" x 1'-0"	(6) #5 @ 12" O.C. EA. WAY
F3	6'-0" x 6'-0" x 1'-0"	(7) #5 @ 12" O.C. EA. WAY

	PIER SCHEDULE				
MARK	SIZE	VERT. REINF.	TIES	T/PIER	
P1	18" x 18"	(6) #5	#4 @ 12" O.C.	99'-4"	


MARK	HEADER	BRG.	KING	REMARKS
H1	(2) 600S162-43 BOX HEADER w/ 600T125-54 TOP & BOT.	(1) 600S162-54	(1) 600S162-68	
H2	(2) 600S162-68 BOX HEADER w/ 600T125-68 TOP & BOT.	(1) 600\$162-54	(1) 600S200-97	
НЗ	(2) 800S200-68 BOX HEADER w/ 600T300-118 TOP & BOT.	N/A	(2) 600S200-97 BTB	

LINTEL SCHEDULE						
MARK	OPENING TYPE	LINTEL	DETAIL	REMARKS		
L1	12" CMU	BOND BEAM w/ (2) #5				
L2	10" CMU	BOND BEAM w/ (2) #5				
L3	12" CMU	(3) L5x3-1/2x5/16" (LLV)				
L4		L7x4x3/8"				
NOTES:						
2. STOP PLAT 3. FULLY GRO 4. PROVIDE 7 5. CONT. 5/16 6. PROVIDE 1	TE 1/2" SHORT OF JAN DUT CMU CORES BEL " x 5/8" x 8" STL. BEAN " BOT. PL. TO BE WE /4" END PLATES ON B	BLOCK AT ALL LINTELS. MB EA. END. .OW LINTEL BEARING. RING PLATE w/ (2) 3/4"Ø x 4' LDED TO BOT. FLANGE OF EA. END OF EA. LINTEL. LINTEL TO CFS HEADER w/	LINTEL (2@12)			

SHEARWALL SCHEDULE				
MARK	1ST FLOOR		# END WALL	SILL PLATE
	SHEATHING	HOLDOWN	STUDS	ANCHORAGE
SW-A	7/16" APA RATED OSB SHEATHING - #8 SCREWS @ 6" O.C. MAX @ PANEL EDGES & 12" O.C. REST OF FIELD	SIMPSON HTT4 ATTACH TO ENDWALL STUDS w/ (18) #10 SCREWS, PROVIDE 5/8" DIA.x7-1/2" EMBED THREADED ROD ANCHOR	(2) BTB 16 GA. STUDS MIN.	(2) 0.157"Ø PAF's @ 16" O.C. MAX.

IOTES:

- PROVIDE FULL-DEPTH LG BLOCKING OR CONT. 18 GA. COILED STRAP BLOCKING @ PANEL EDGES.
 FASTENERS TO BE 12" O.C. MAX. REST OF FIELD.
- 3. #8 SCREWS TO BE 0.164"Ø x 1-1/4" LONG.
 4. THREADED ROD ADHESIVE TO BE SIMPSON SET-3G (OR BETTER).
 5. BLOCK ALL PANEL EDGES SOLID.
- BLOCK ALL PANEL EDGES SOLID.
 IF STEEL COLUMN IS LOCATED @ CHORD MEMBER, FASTEN CHORD MEMBER TO COLUMN w/ 0.157"Ø PAF's @ 12" O.C. MAX. STAGGERED & IGNORE SPECIFIED HOLDOWN.

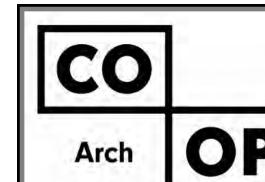

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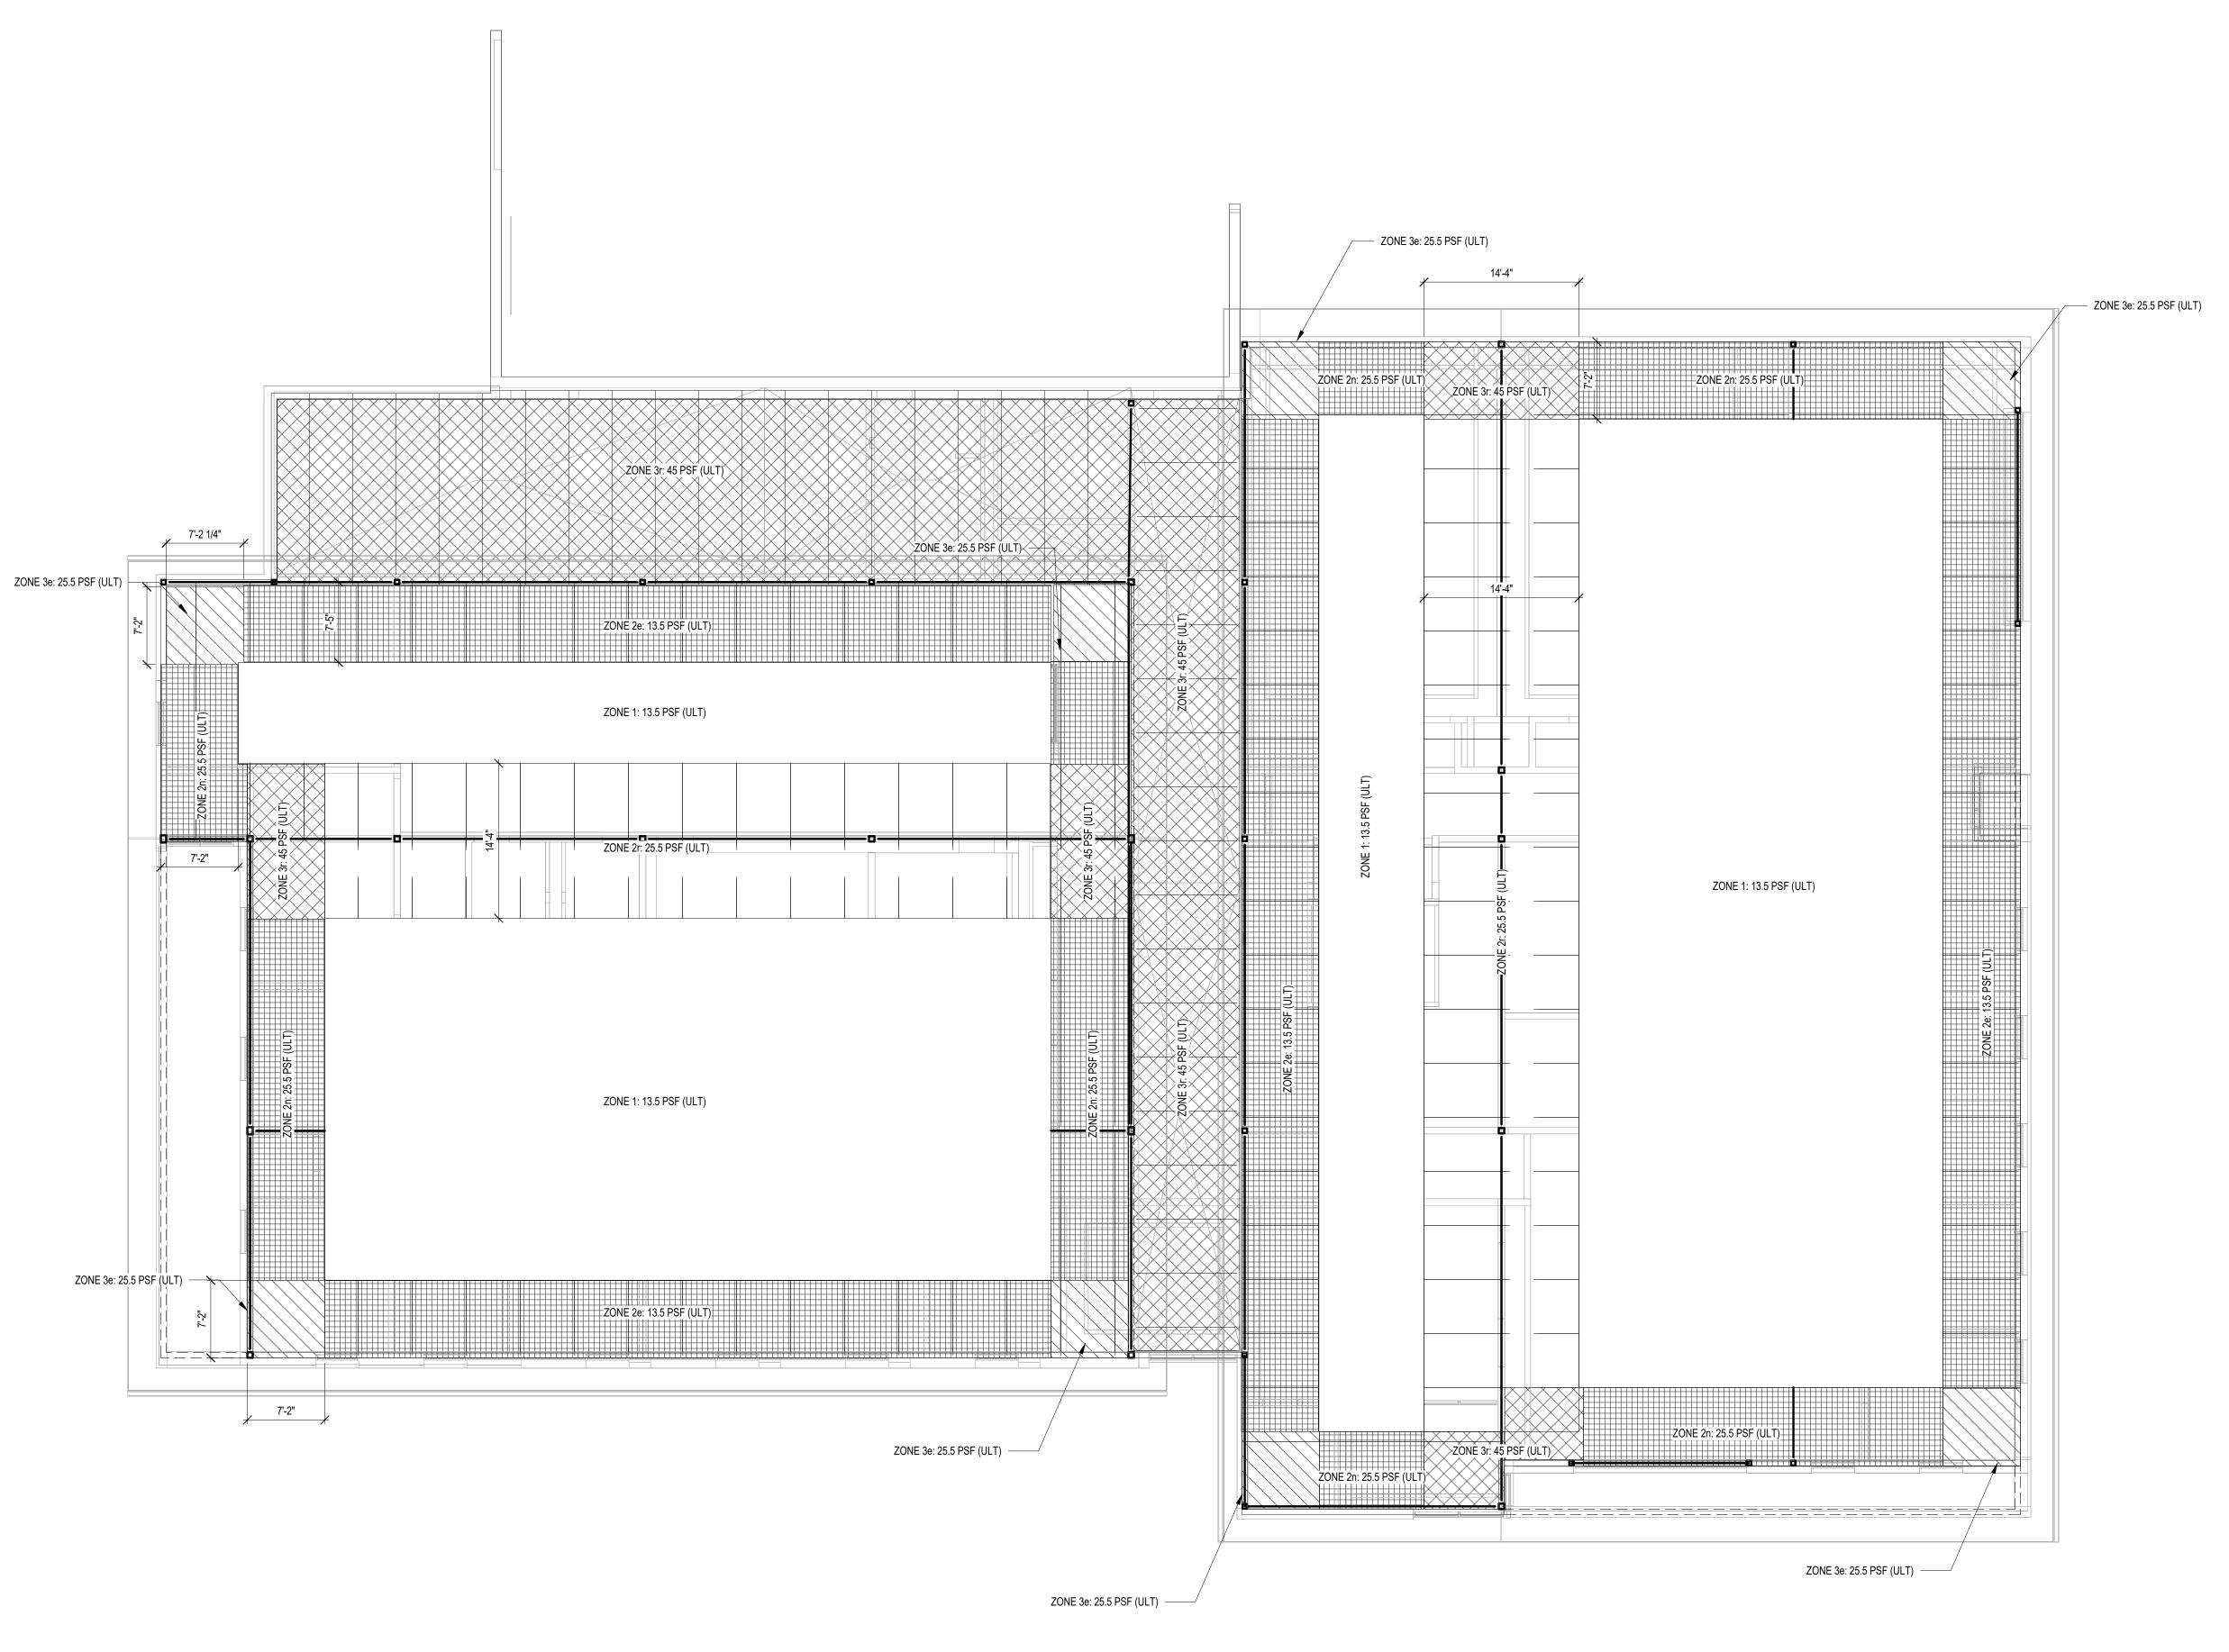
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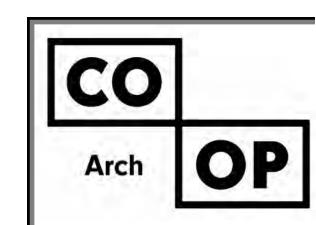
NORTHERN ELECTRIC RENOVATION NORTHERN ELECTRIC COOPERATIVE ABERDEEN, SOUTH DAKOTA

SHEET TITLE:
STRUCTURAL NOTES &

STRUCTURAL NOTES & SCHEDULES

5002





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PROJECT: NORTHERN ELECTRIC RENOVATION NORTHERN ELECTRIC COOPERATIVE ABERDEEN, SOUTH DAKOTA

SHEET TITLE:

WIND UPLIFT PLAN


CONC. SLAB TO BE 4" w/ FIBERMESH REINFORCEMENT ON VAPOR BARRIER (REF. ARCH.)
ON 6" DRAINAGE FILL ON APPROVED SUBGRADE.
CONTRACTOR TO SUBMIT CONTROL JOINT LAYOUT FOR ARCH./ENGINEER APPROVAL.
SEE STRUCTURAL NOTES FOR SIZE/SPACING LIMITATIONS.
SEE 6 & 7 ON SHEET S401 FOR TYPICAL CONTROL JOINT DETAILS. • SEE 8/S401 FOR TYPICAL CORNER WALL REINFORCING.

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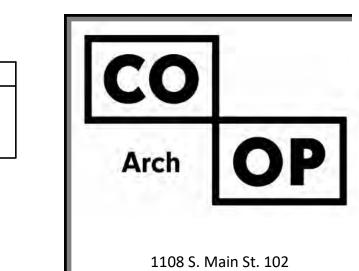
NORTHERN ELECTRIC RENOVATION NORTHERN ELECTRIC COOPERATIVE ABERDEEN, SOUTH DAKOTA

SHEET TITLE:

FOOTING & FOUNDATION PLAN

S101

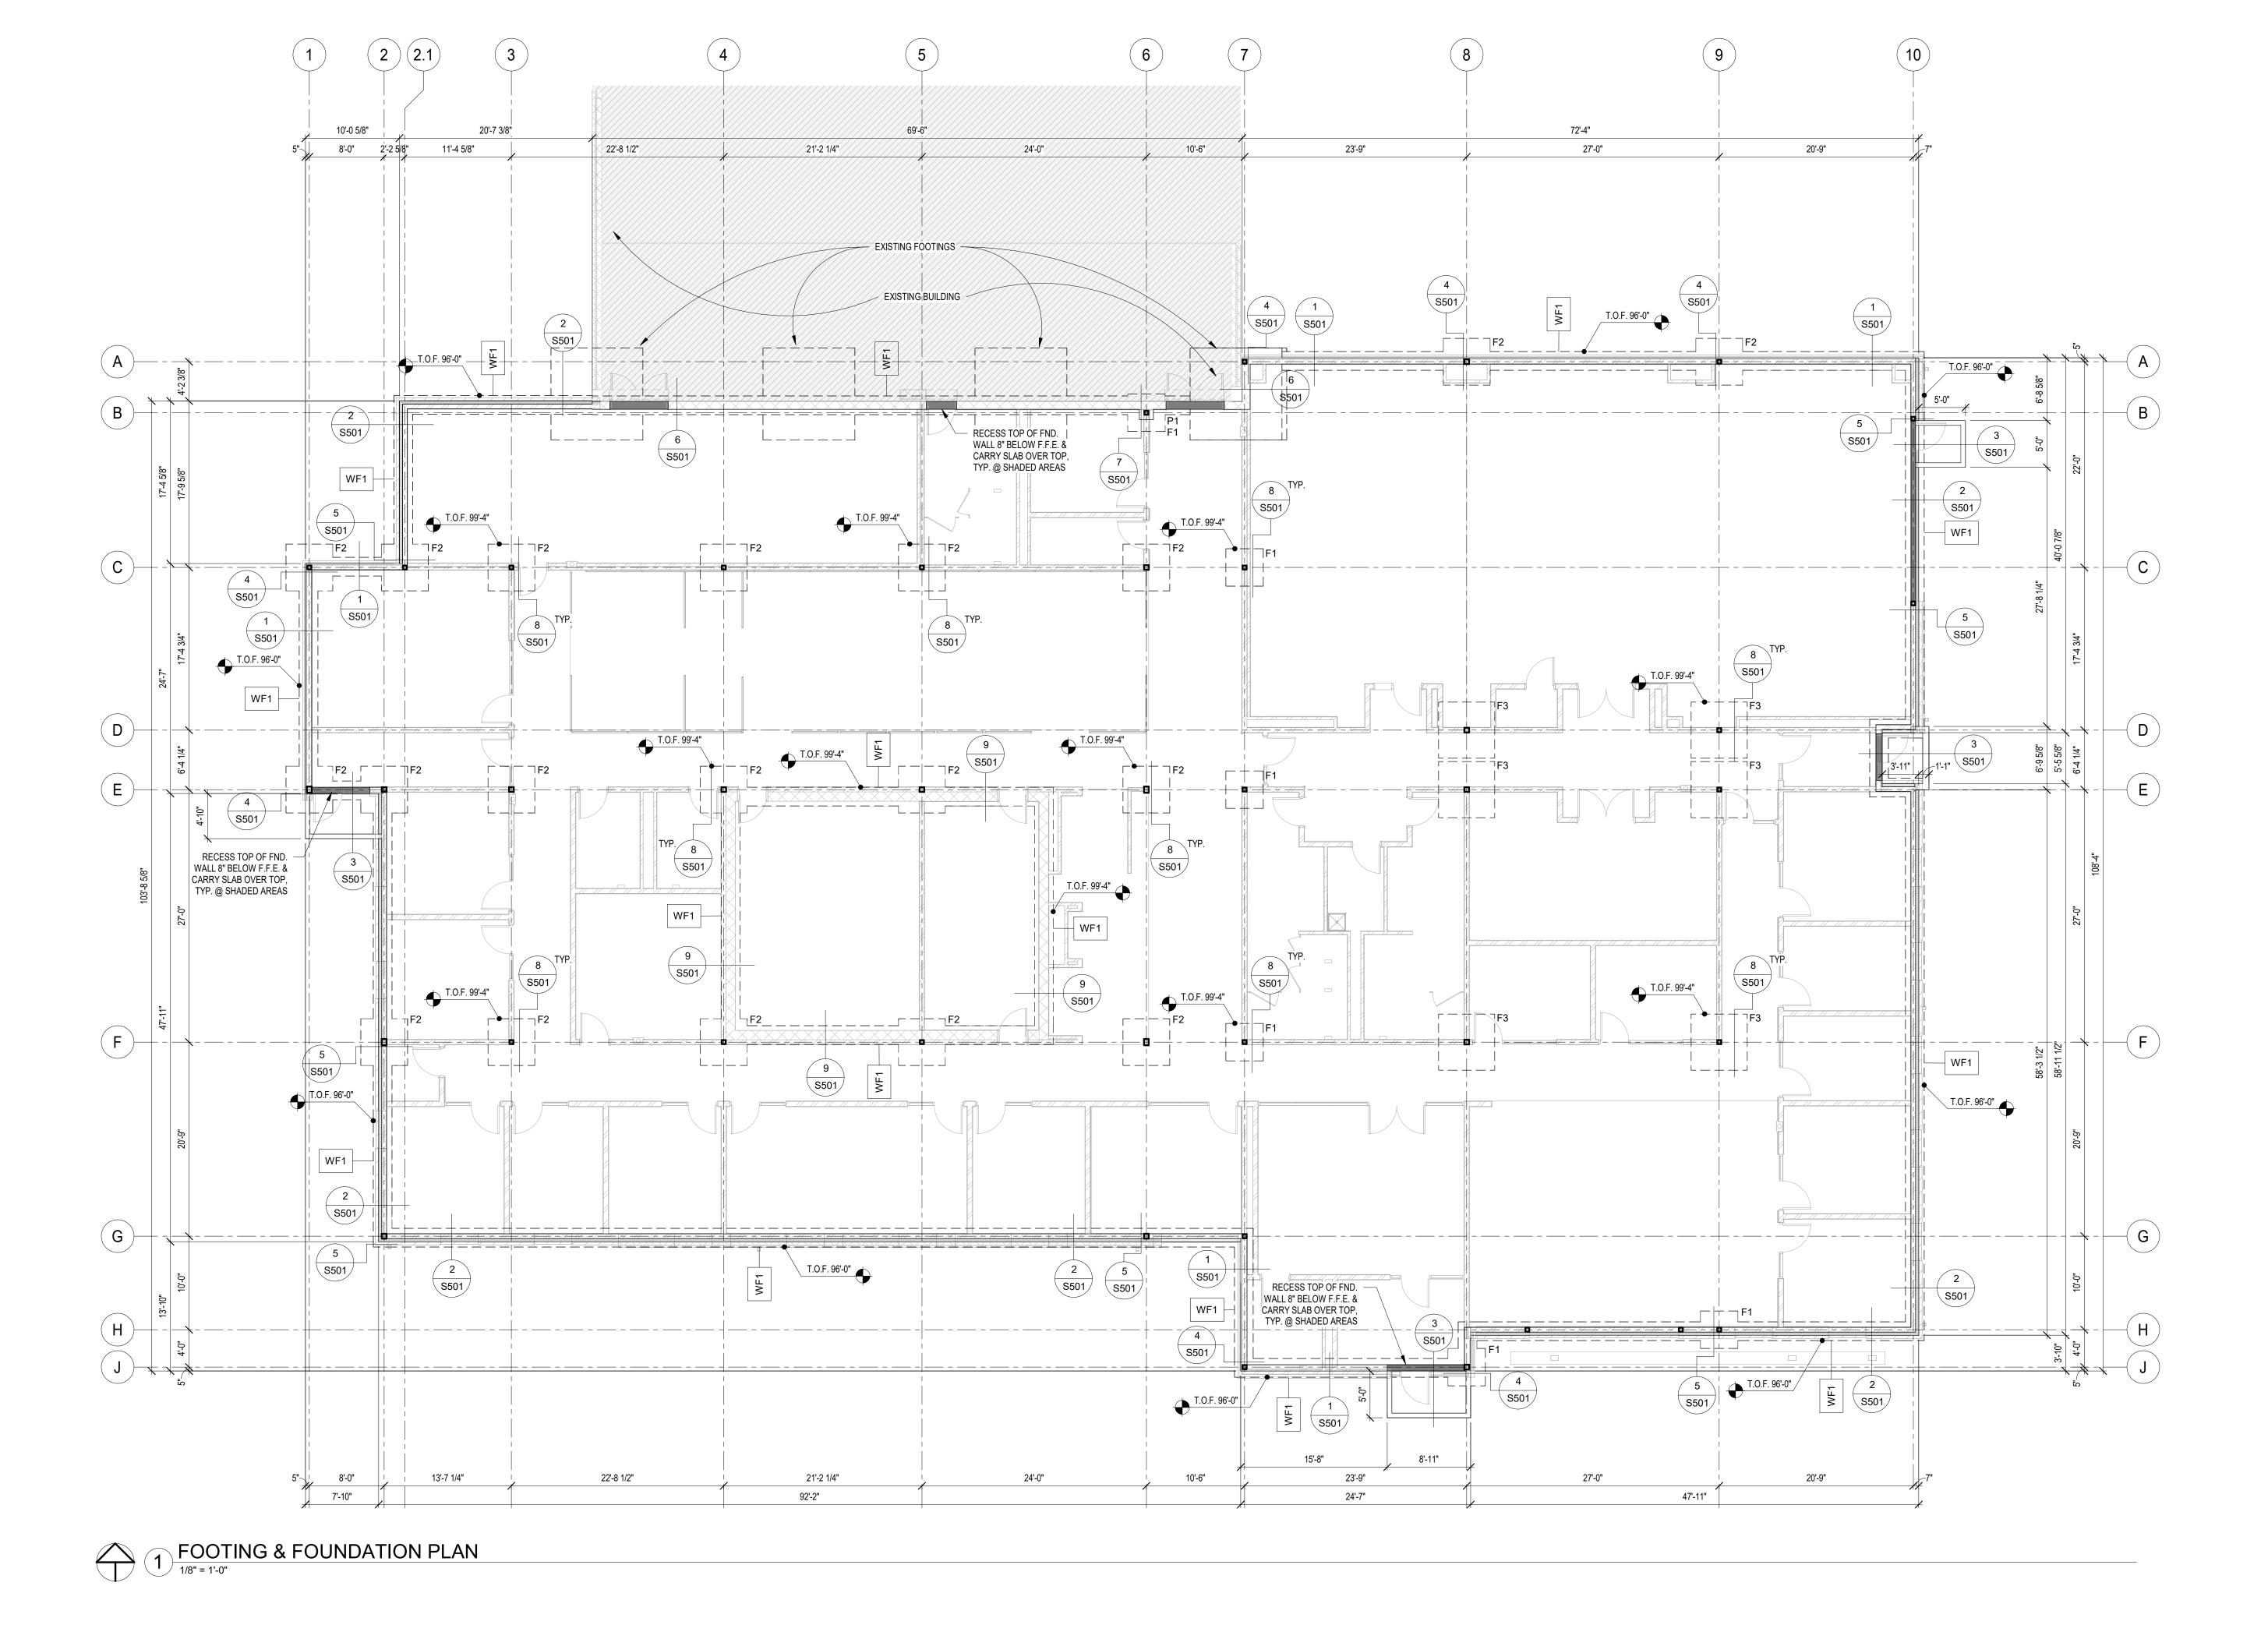 ALL INTERIOR AND EXTERIOR CMU LOAD BEARING WALLS TO ALL INTERIOR AND EXTERIOR CIVIO LOAD BEARING WALLS TO CONTAIN #5 VERTICAL REBAR GROUTED SOLID @ 24" O.C.
 ALL INTERIOR AND EXTERIOR CMU NON-LOAD BEARING WALLS TO CONTAIN #5 VERTICAL REBAR GROUTED SOLID @ 48" O.C.



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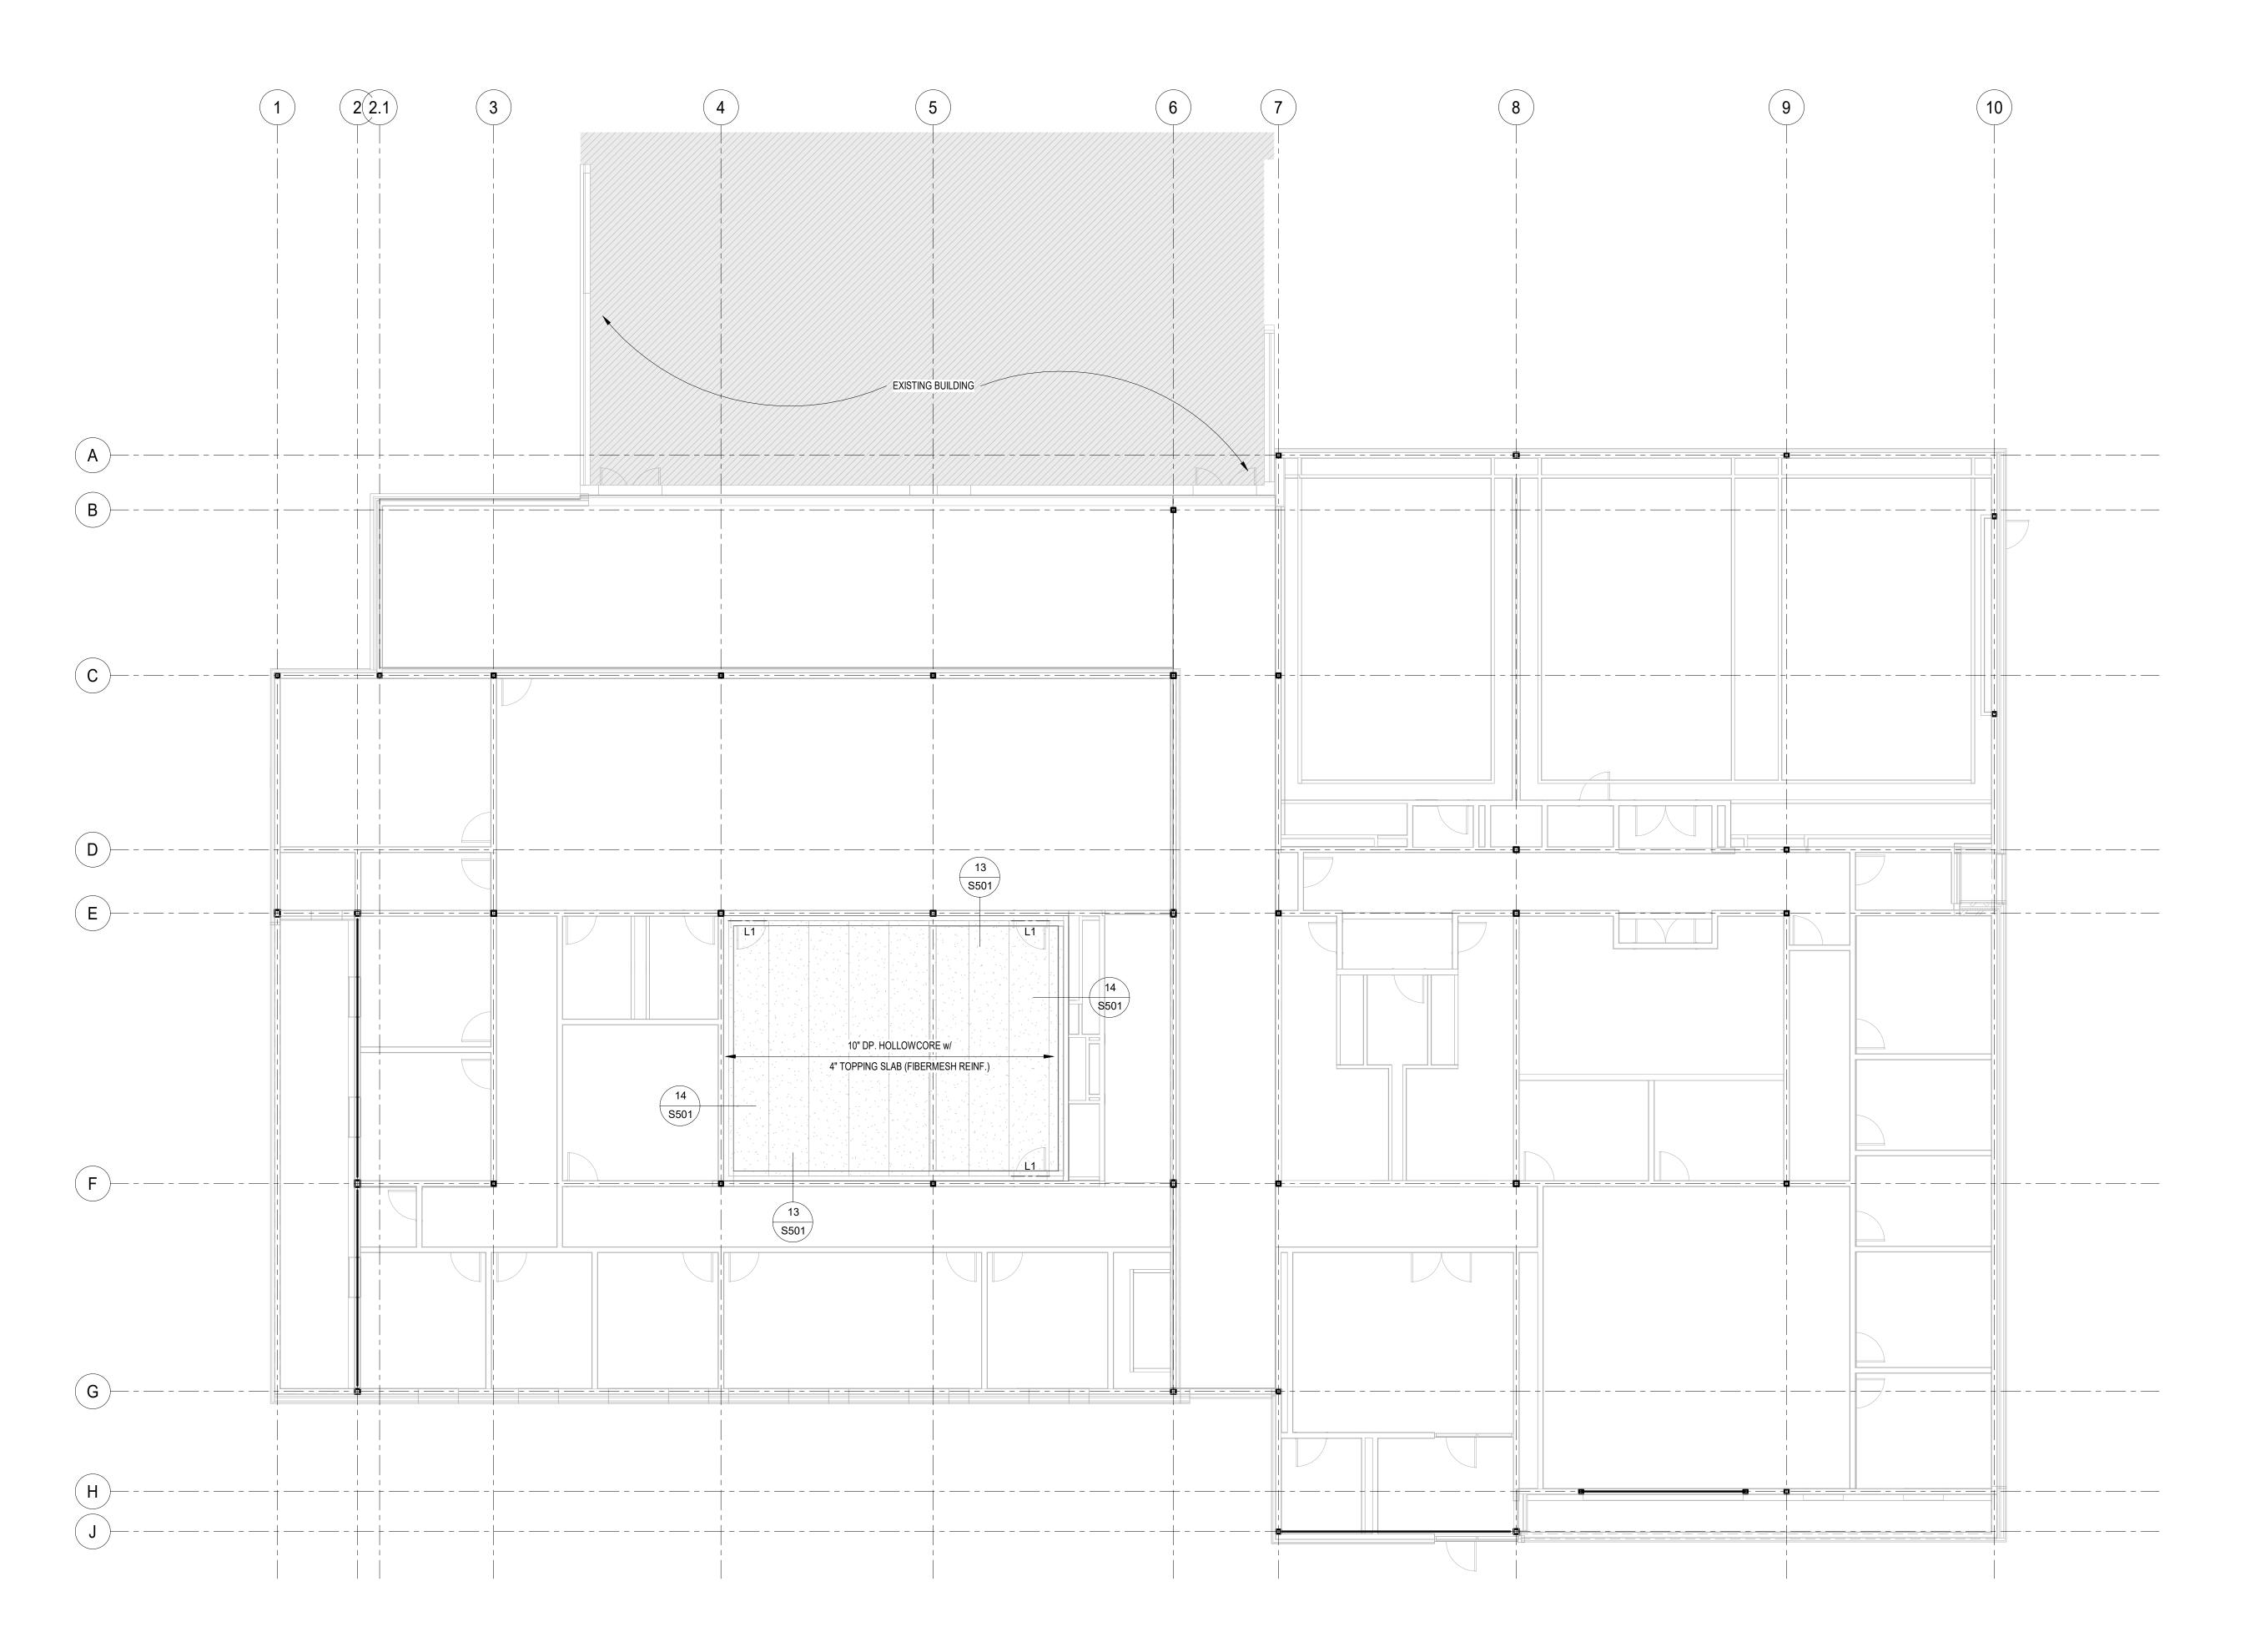
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CO-OP PROJECT NO: 5/15/2025 100% CD

PROJECT: NORTHERN ELECTRIC RENOVATION NORTHERN ELECTRIC COOPERATIVE ABERDEEN, SOUTH DAKOTA

SHEET TITLE: FLOOR FRAMING PLAN



HOLLOW CORE FRAMING PLAN

1/8" = 1'-0"

NOTES:


• BEARING WALLS TO BE 600S162-54 @ 16" O.C. w/ (2) STUDS BTB BENEATH EA. JOIST (IF STUDS ARE TALLER THAN 22', USE 600S200-68 @ 16" O.C.)

• ALL INTERIOR AND EXTERIOR CMU LOAD BEARING WALLS TO CONTAIN #5 VERTICAL REBAR GROUTED SOLID @ 24" O.C.

• ALL INTERIOR AND EXTERIOR CMU NON-LOAD BEARING WALLS TO CONTAIN #5 VERTICAL REBAR GROUTED SOLID @ 48" O.C.

• ROOF DECKING ON STL. JOISTS TO BE 1.5B-22GA. FASTENED w/ HILTI X-HSN24 OR EQUIVALENT IN A 36/4 PATTERN & #10 SIDE LAP FASTENERS @ 18" O.C.

• FOR ALL MECHANICAL OPENINGS IN EXISTING SHOP - USE L3 LINTELS, CONSULT EOR IF OPENINGS ARE LARGER THAN 60"

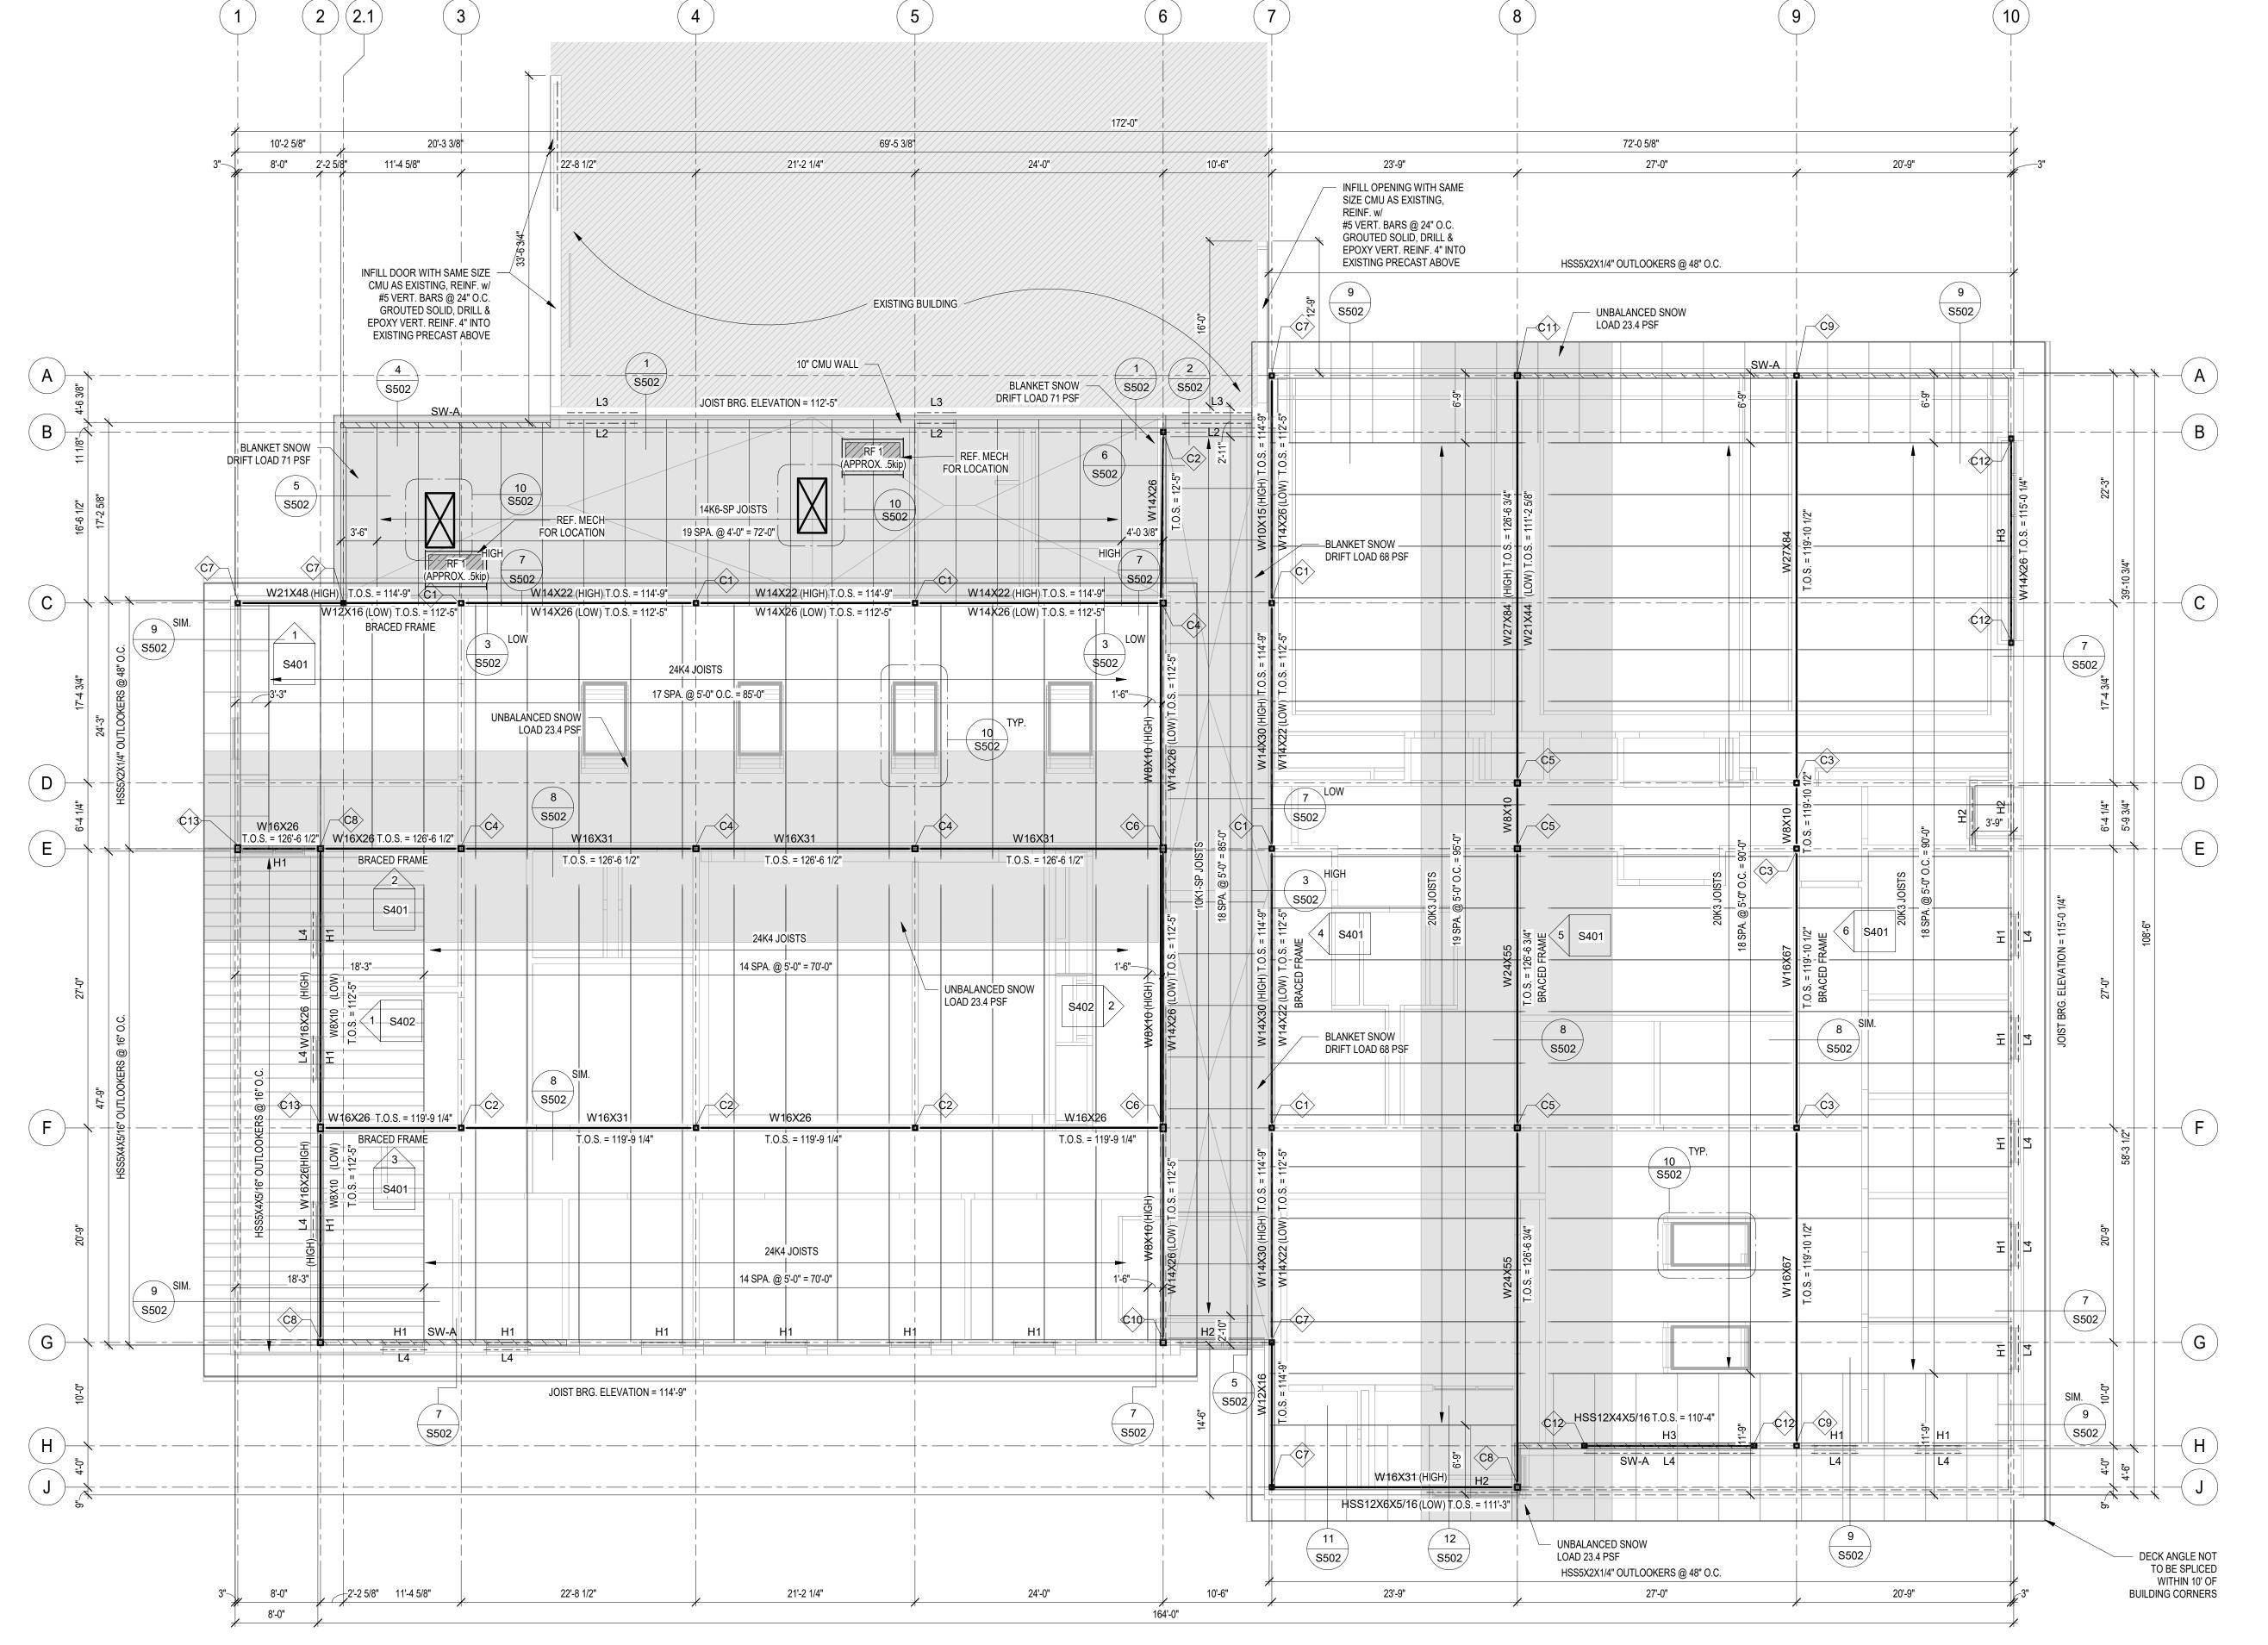

1 ROOF FRAMING PLAN
1/8" = 1'-0"

CO-OP PROJECT NO: 24285

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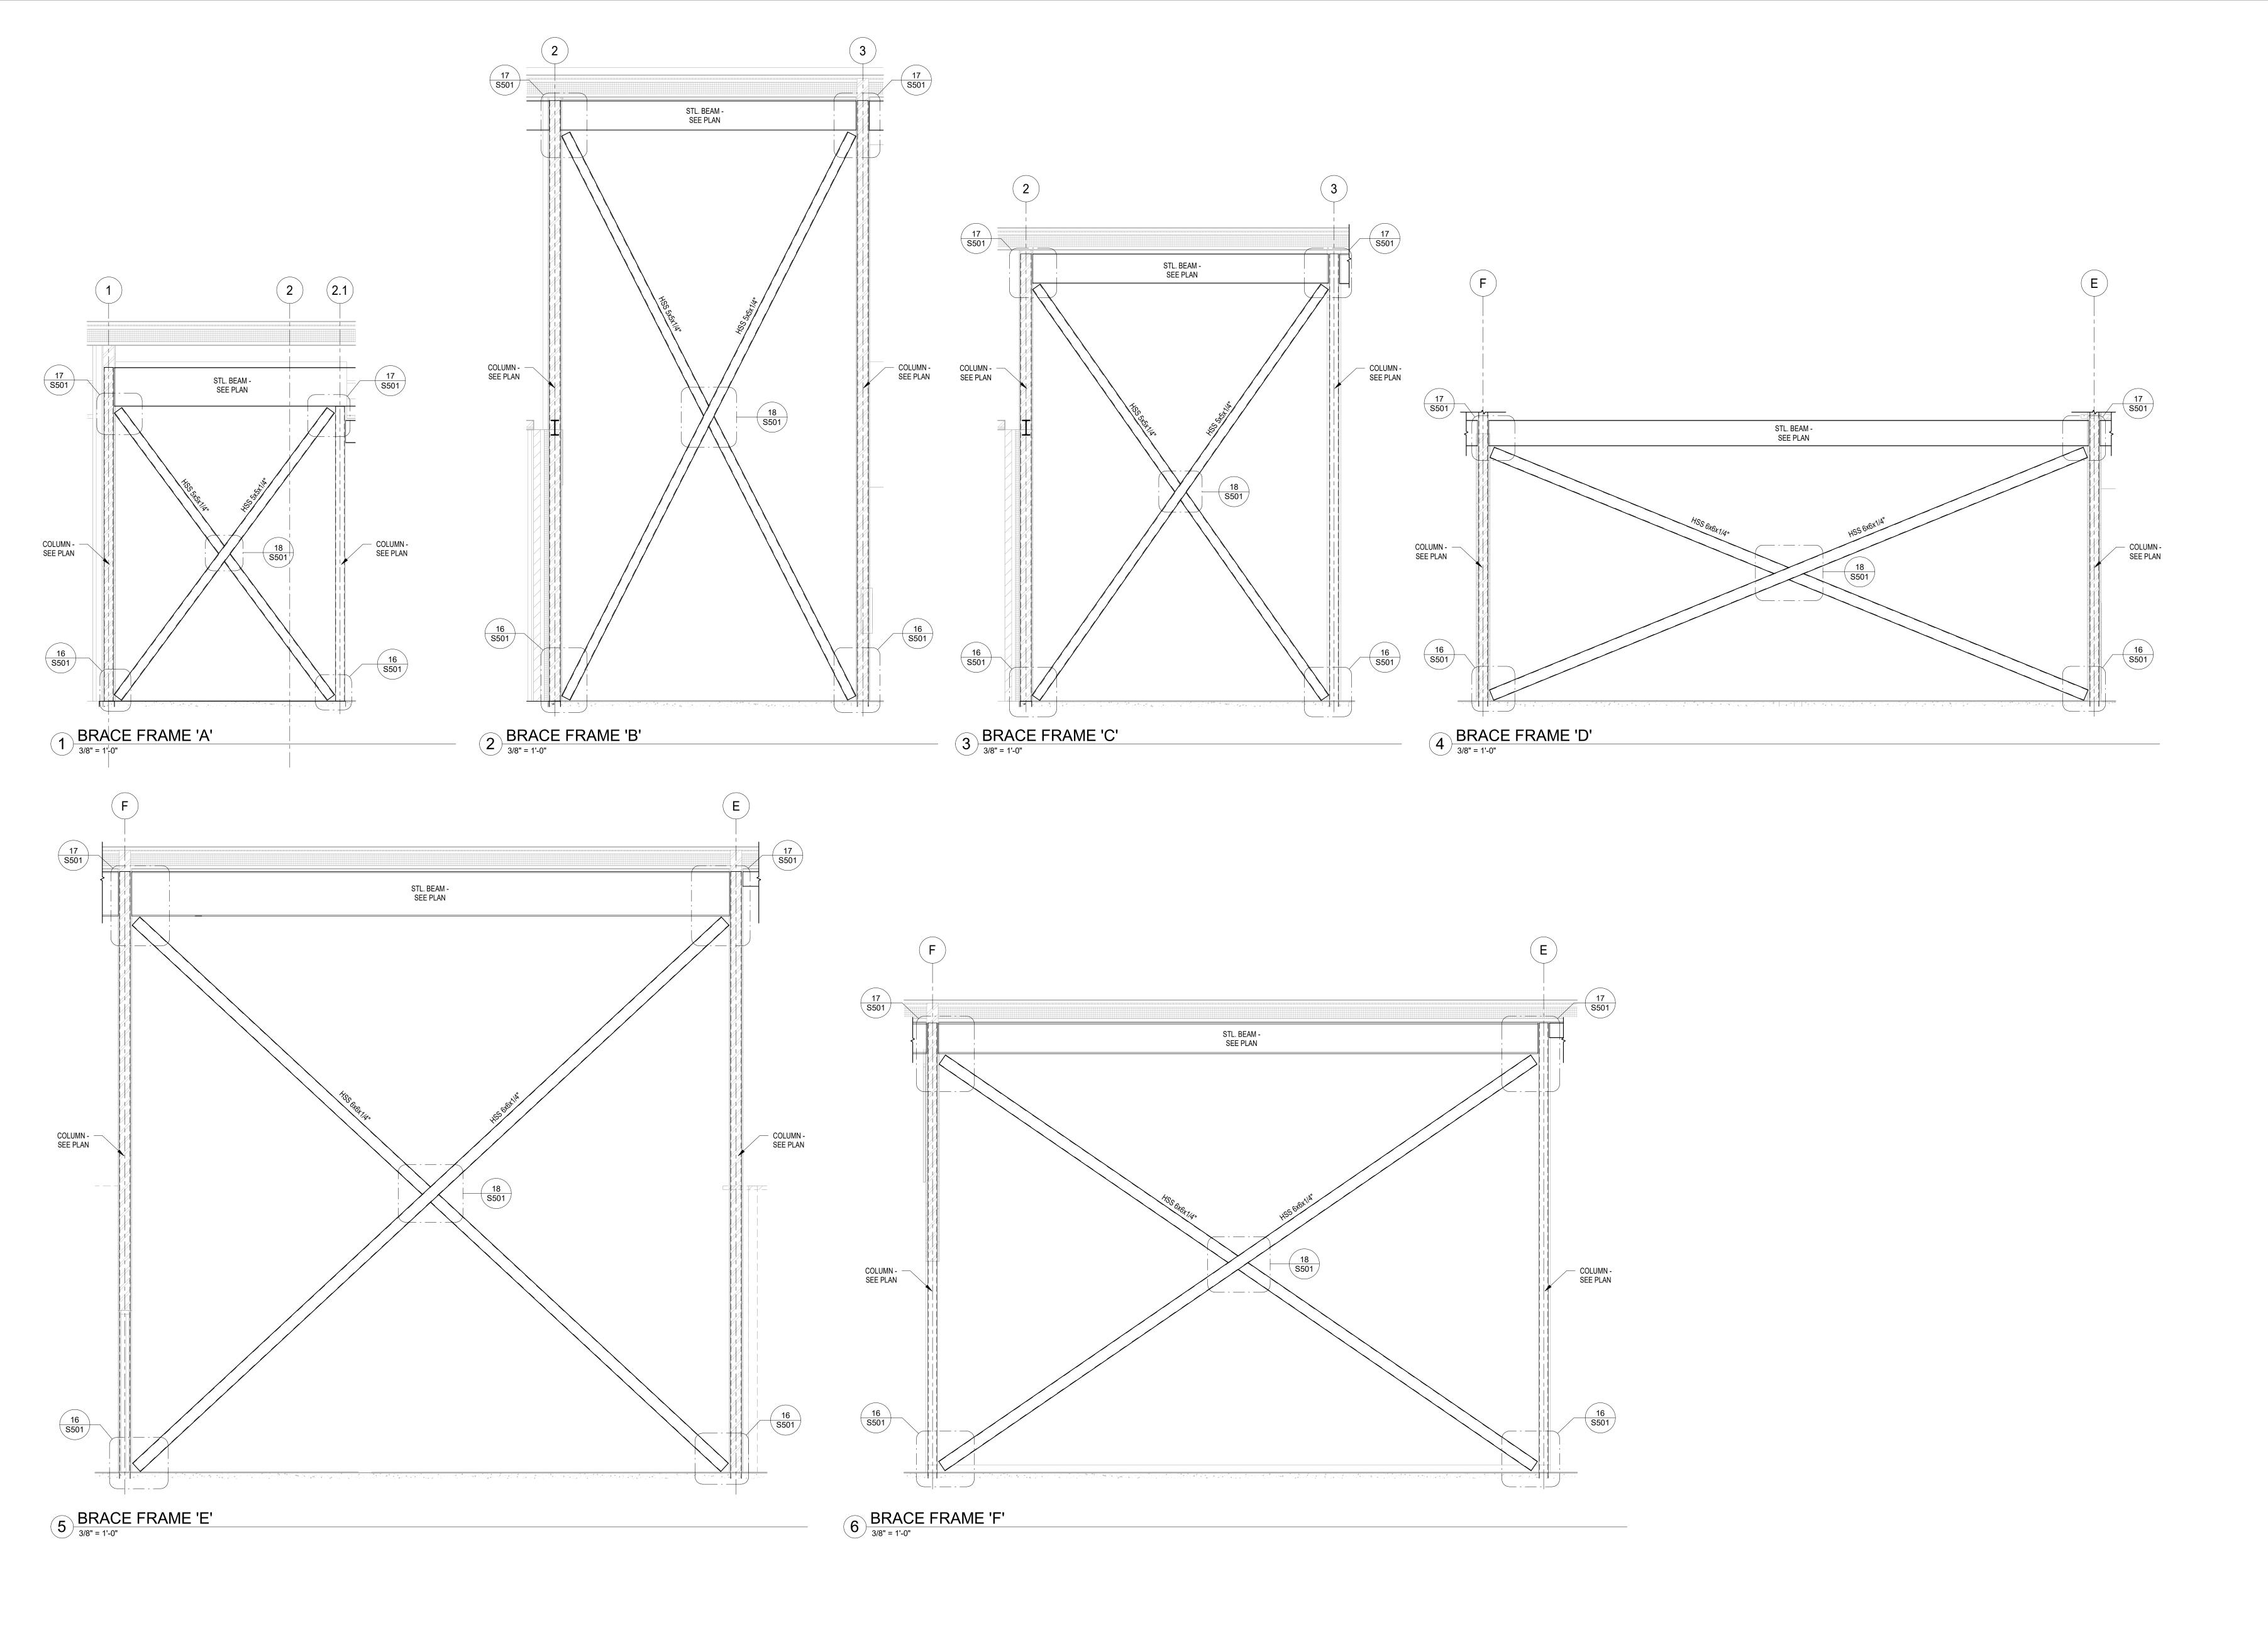
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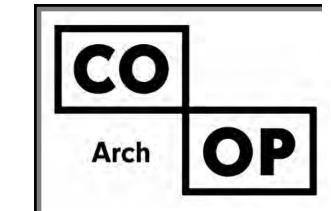
NORTHERN ELECTRIC RENOVATION NORTHERN ELECTRIC COOPERATIVE ABERDEEN, SOUTH DAKOTA

SHEET TITLE:

ROOF FRAMING PLAN

301





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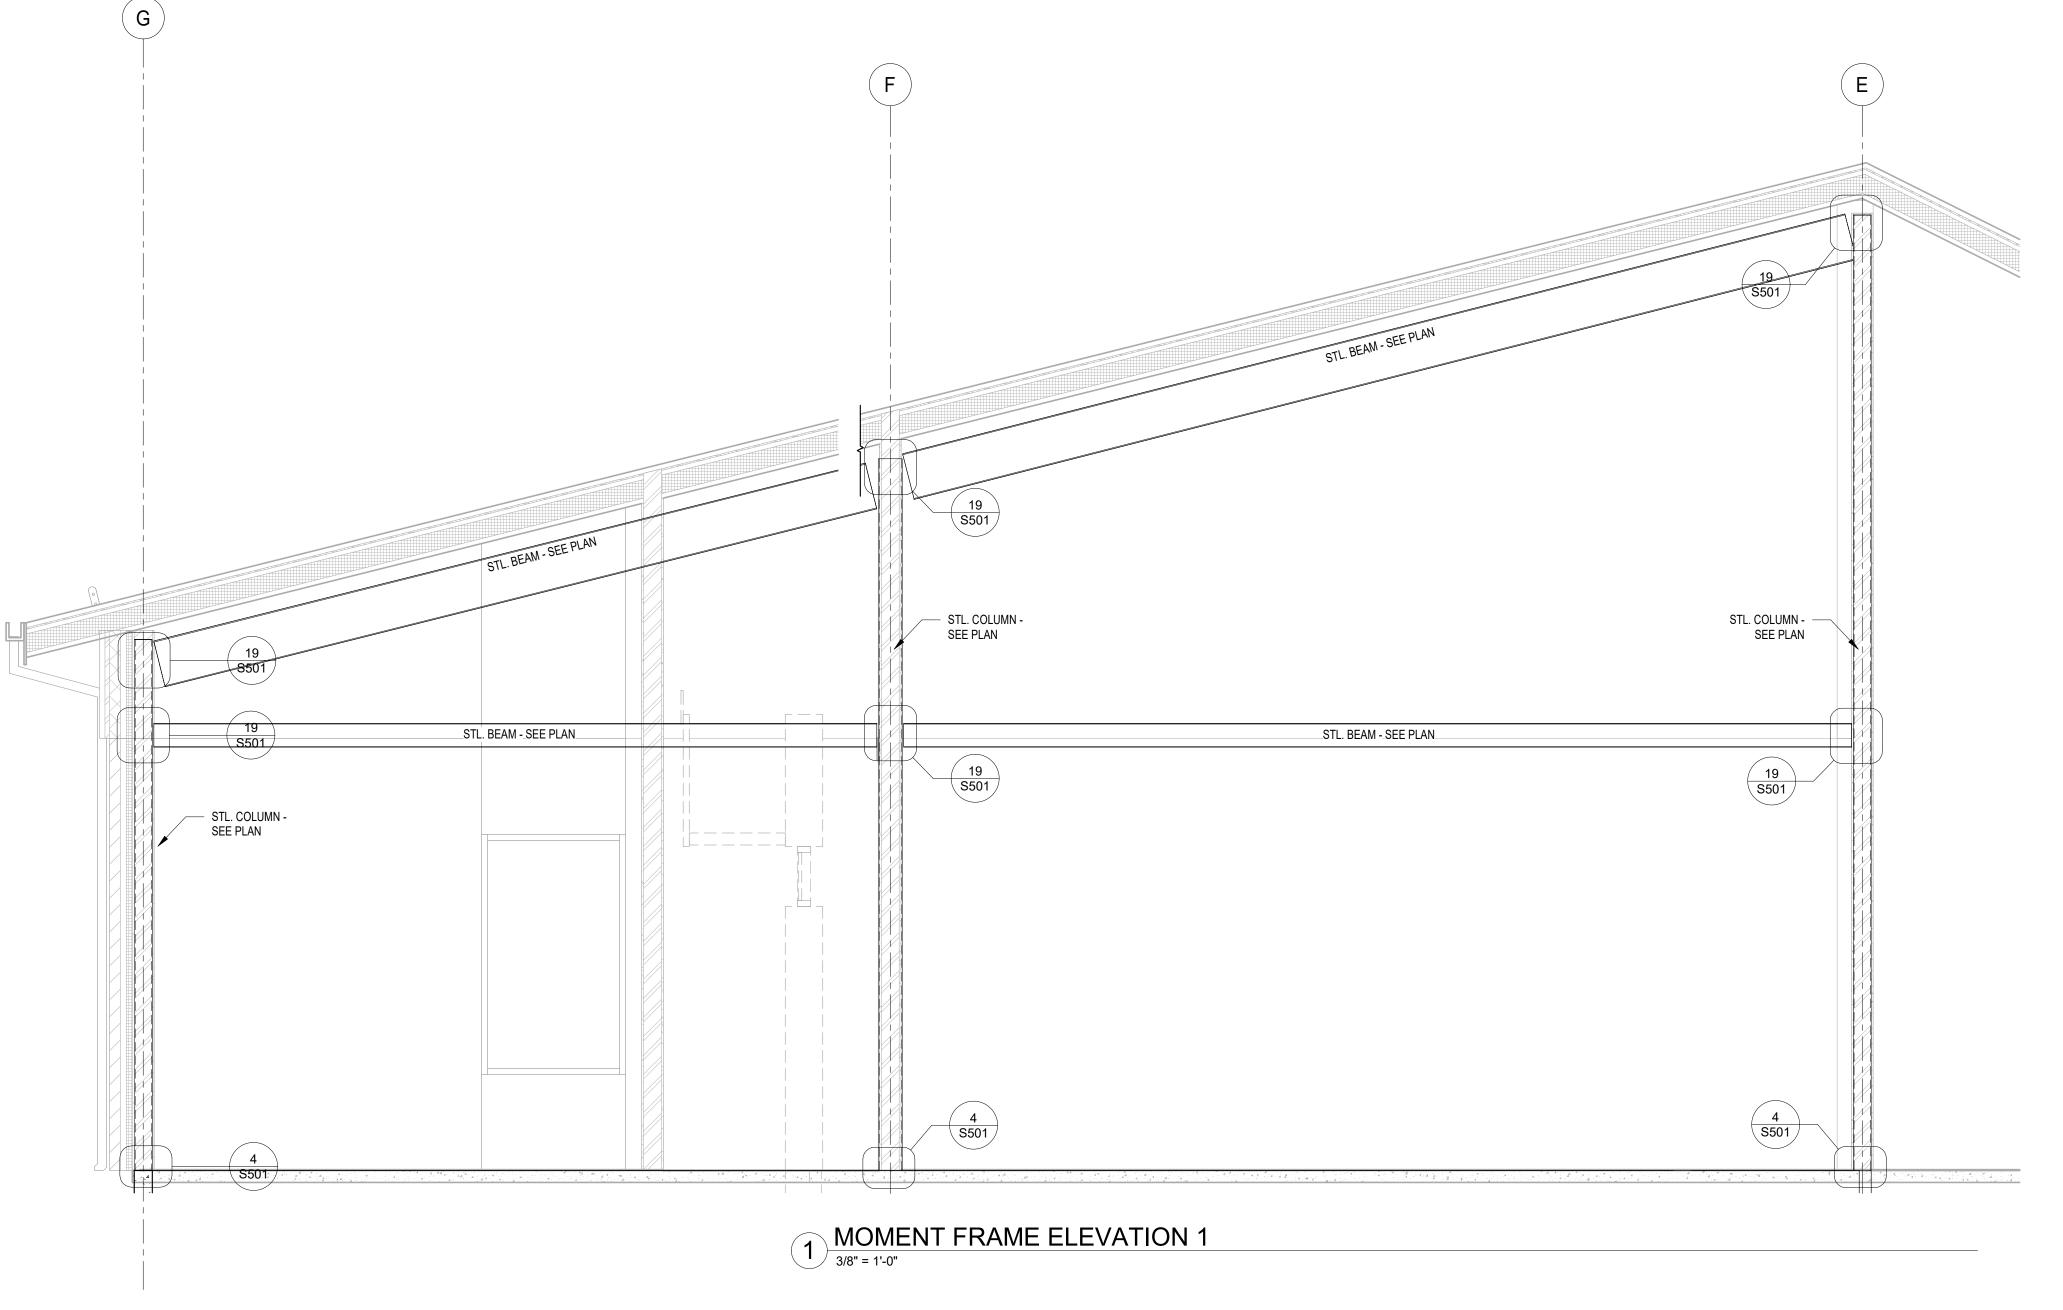
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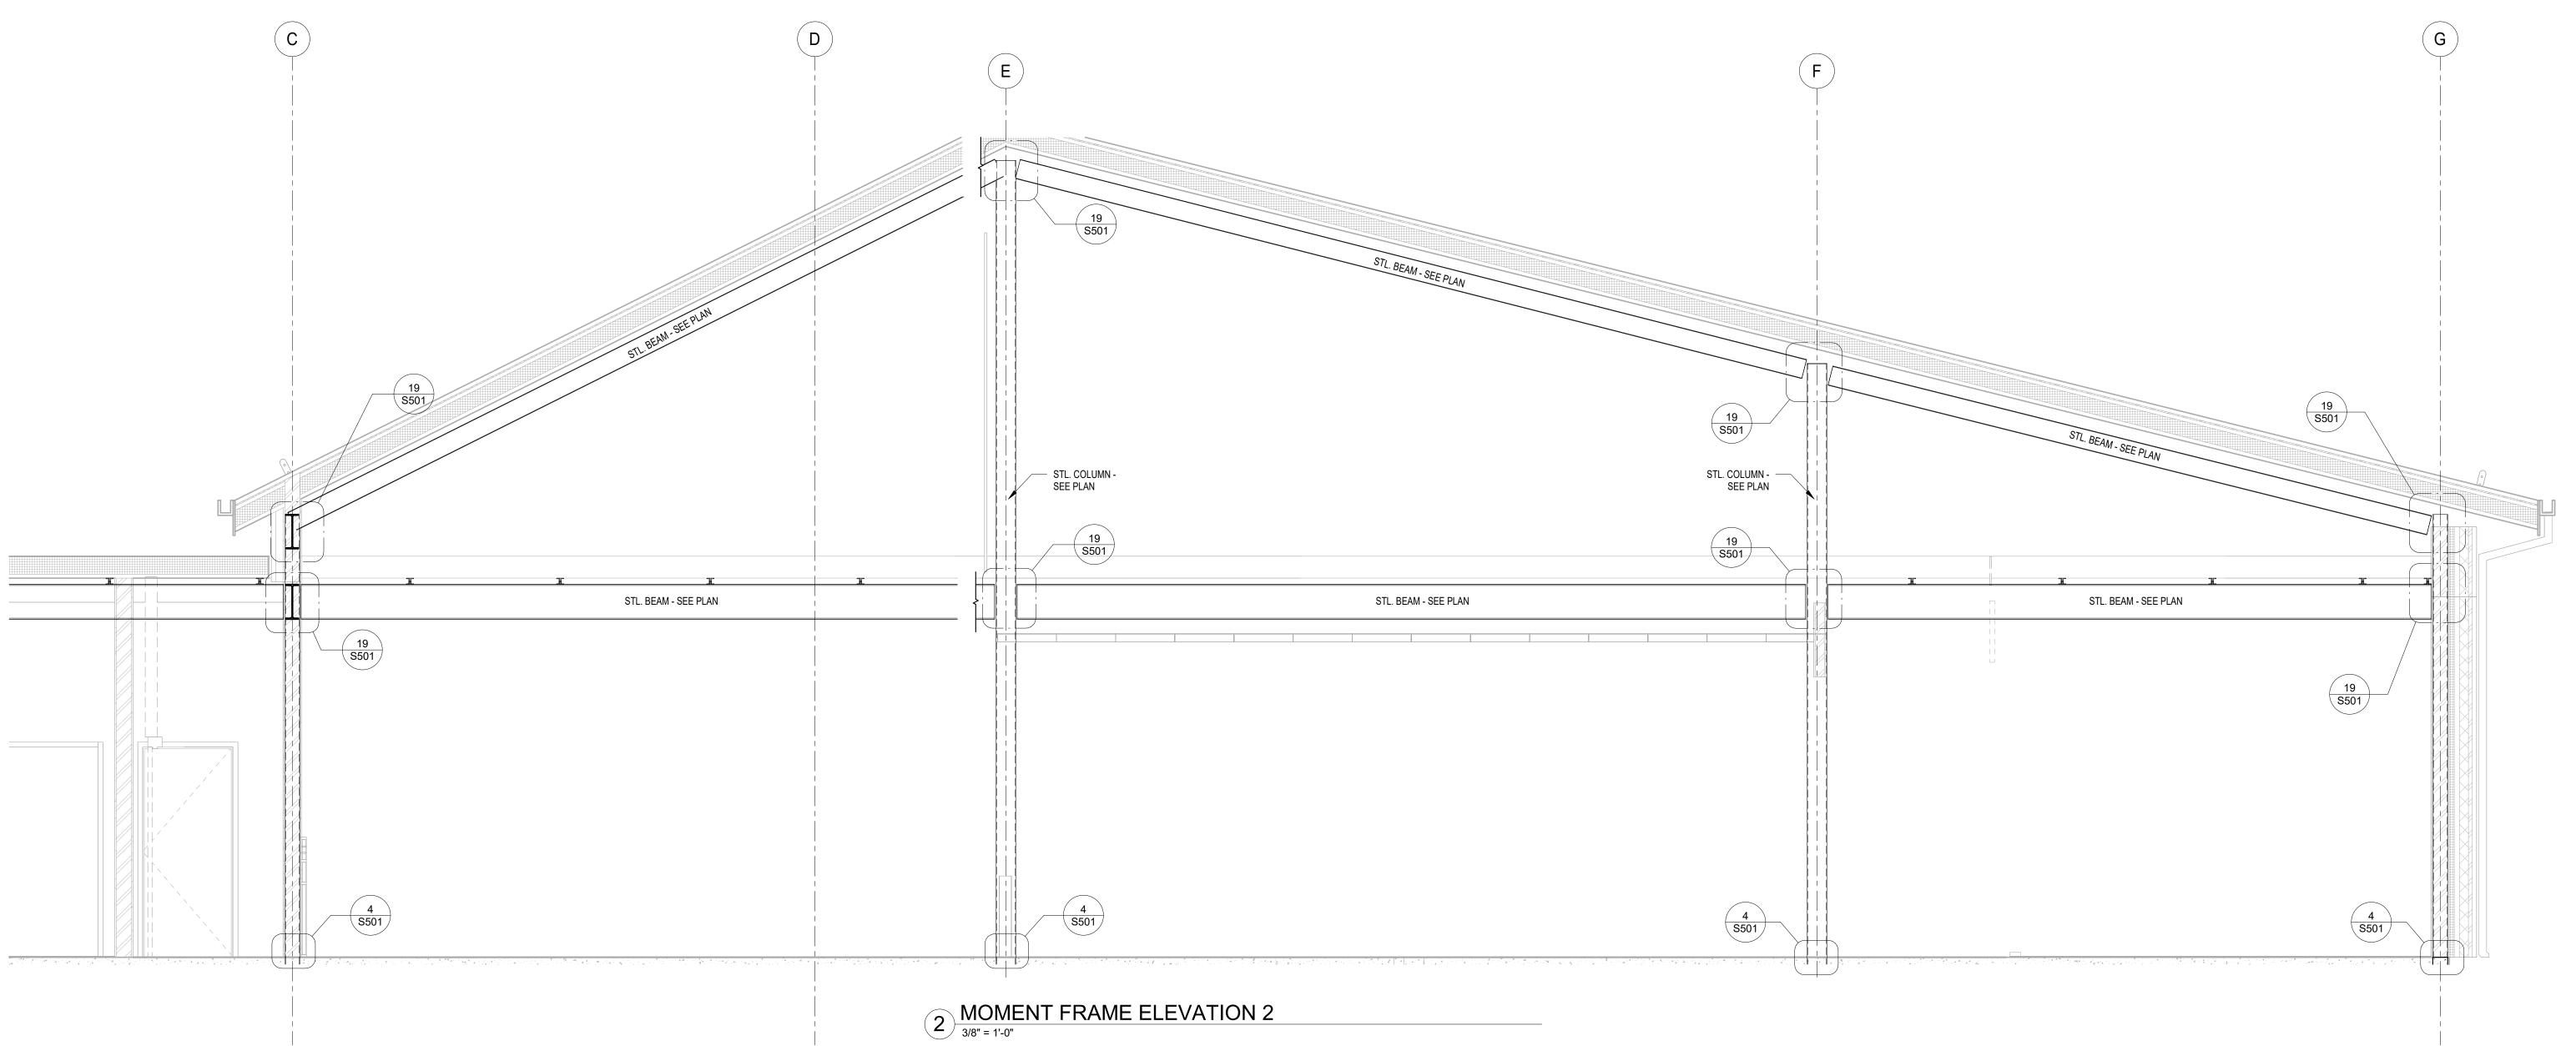
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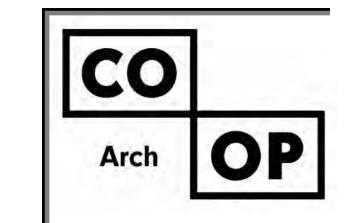
SHEET TITLE:

FRAMING ELEVATIONS

S401







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CO-OP PROJECT NO: 24285

ISSUE: 5/15/2025 100% CD REVISION SCHEDULE:

REV. # REV. DSC. REV. DATE


PROJECT:


NORTHERN ELECTRIC RENOVATION NORTHERN ELECTRIC COOPERATIVE ABERDEEN, SOUTH DAKOTA

SHEET TITLE:

FRAMING ELEVATIONS

S402

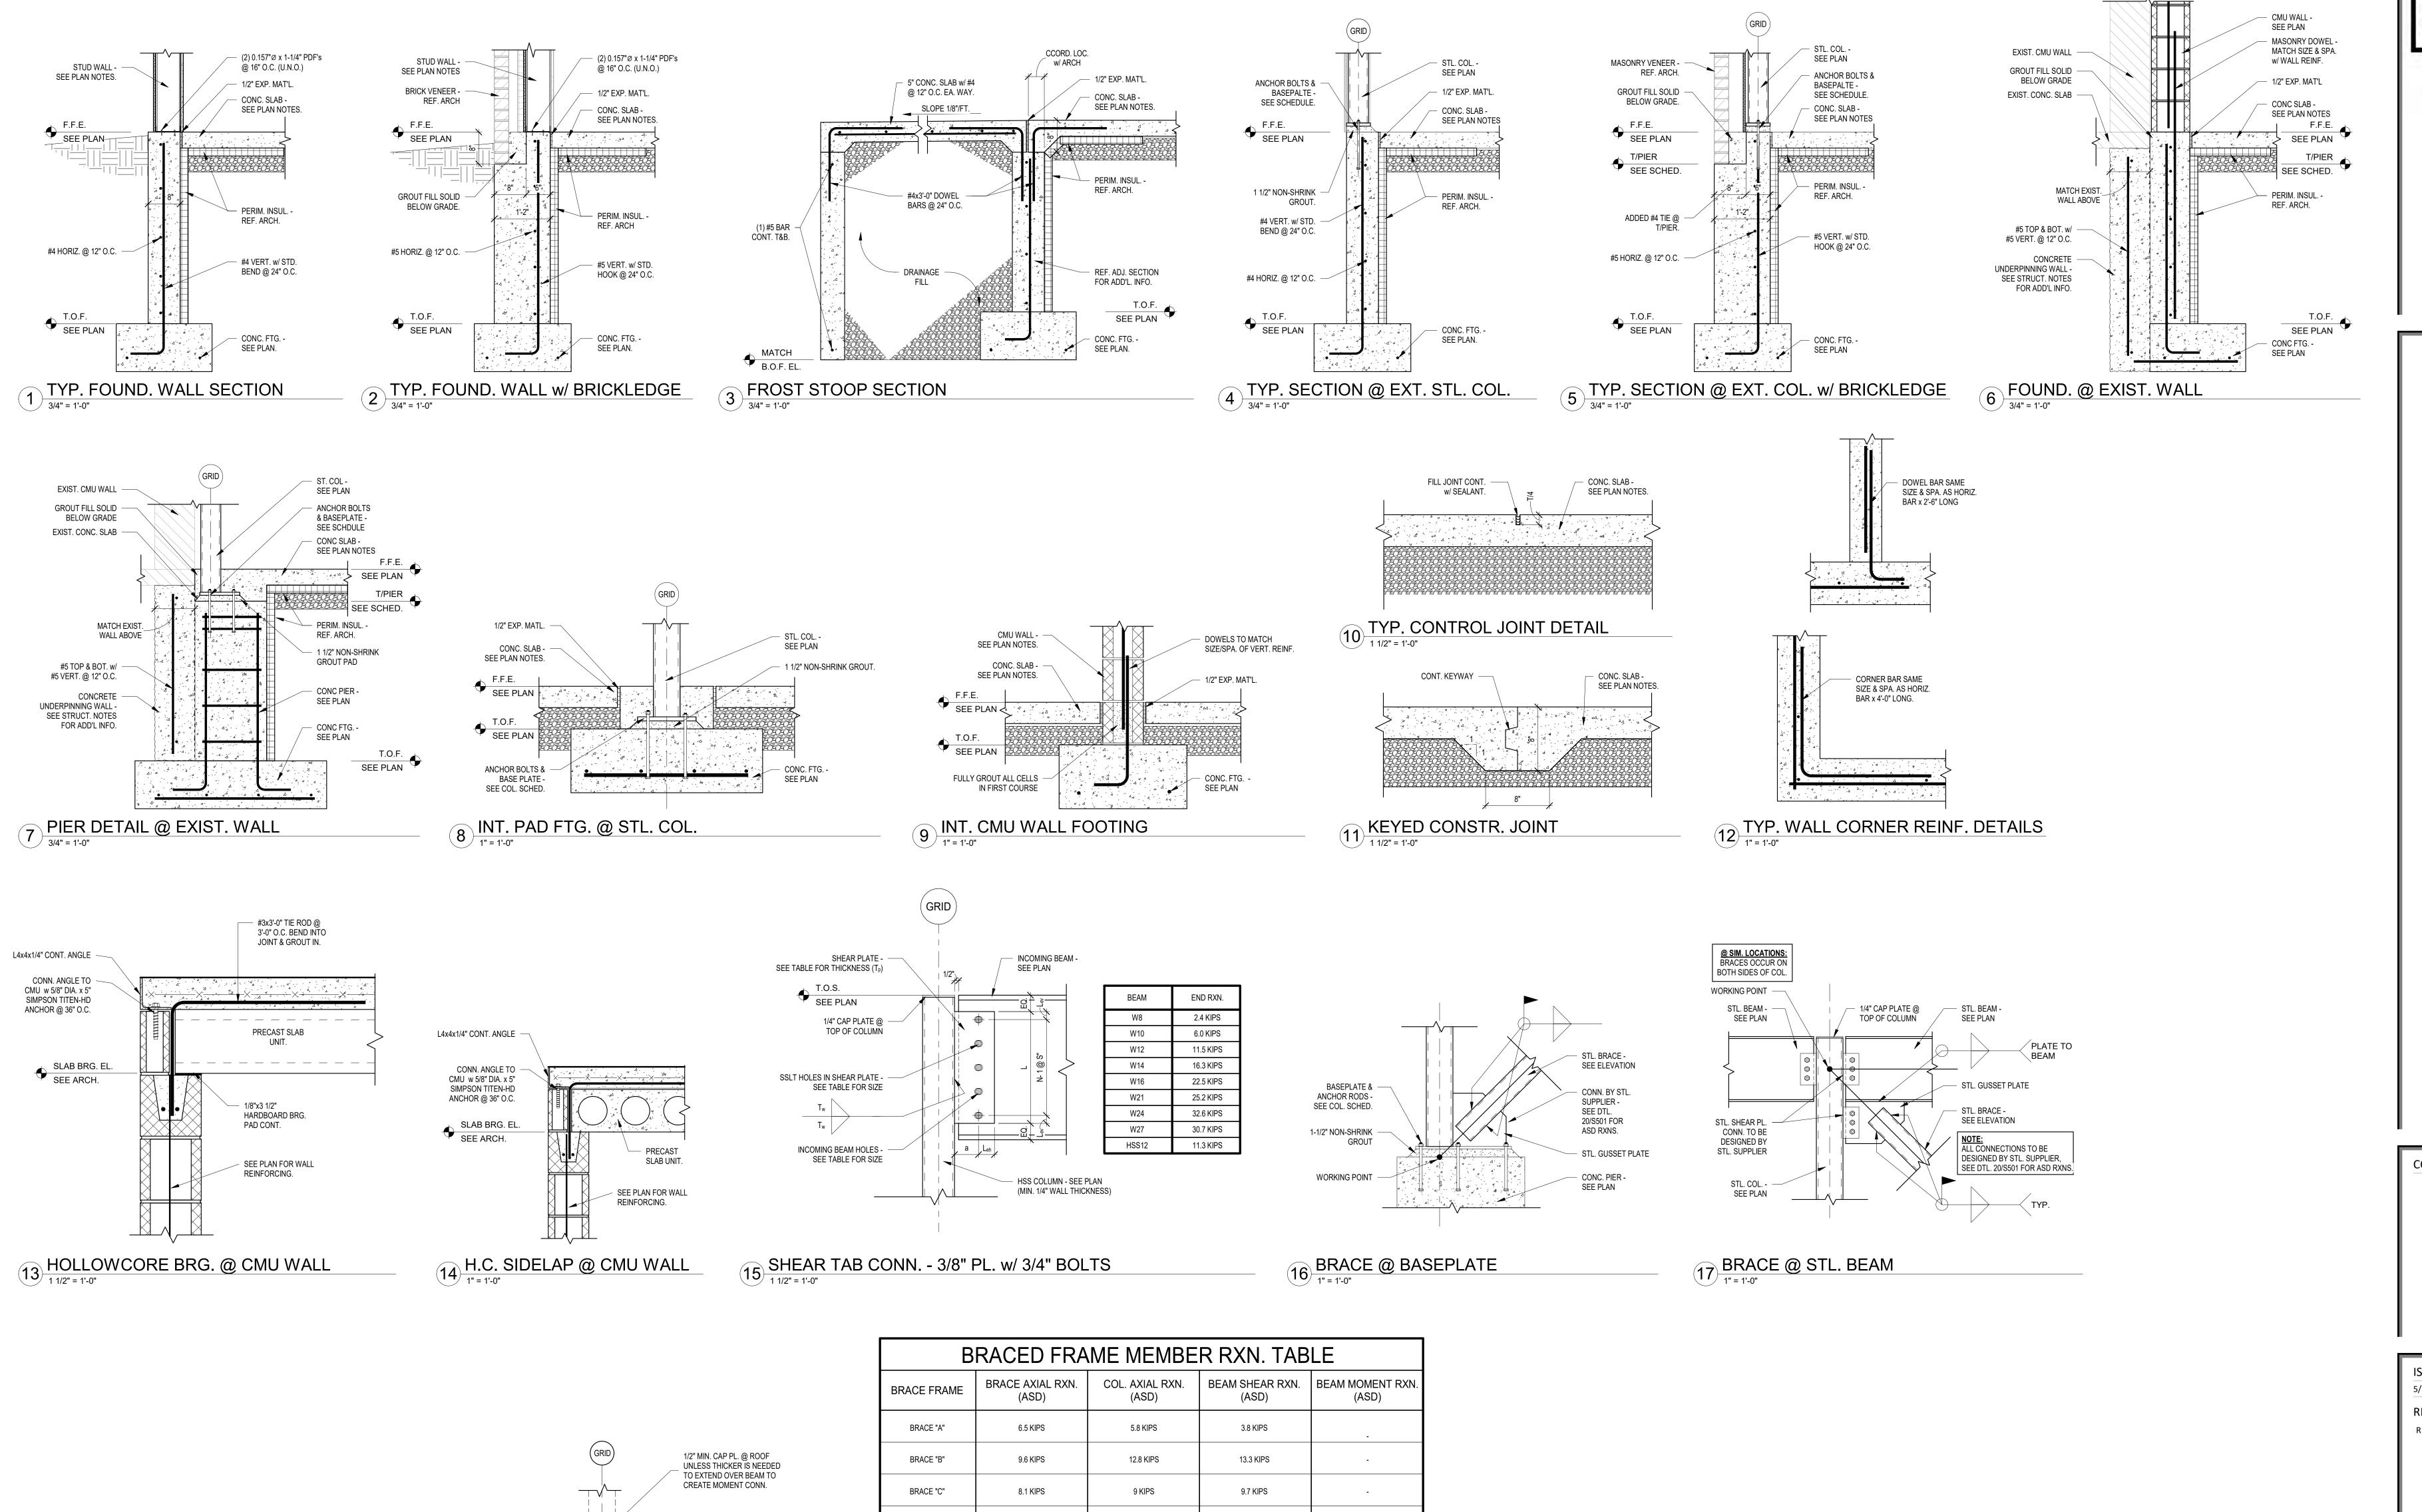

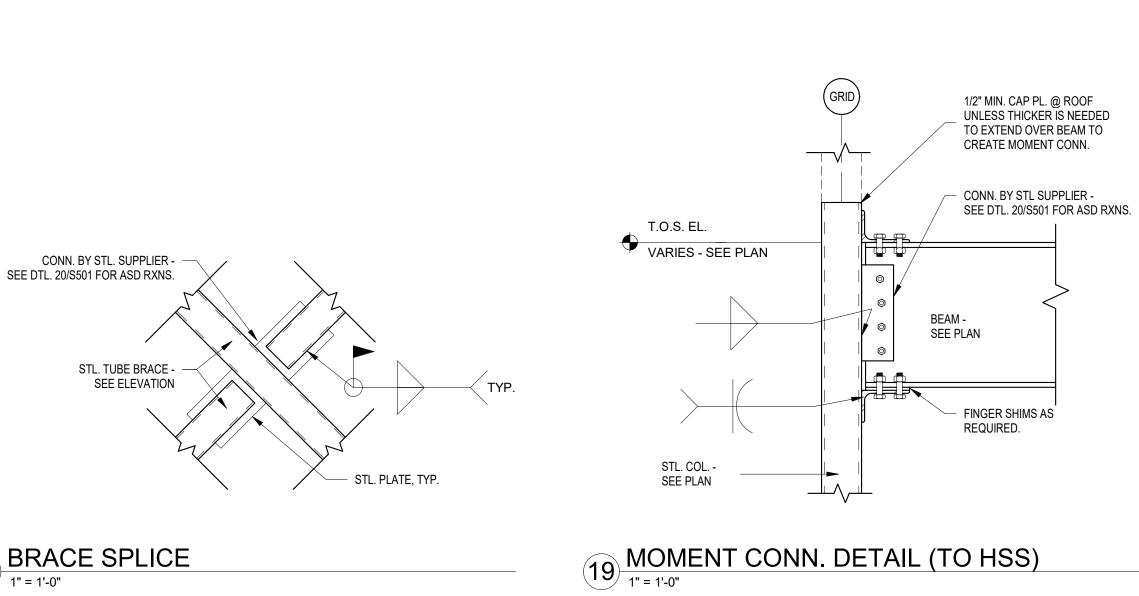

BRACE FRAME	BRACE AXIAL RXN. (ASD)	COL. AXIAL RXN. (ASD)	BEAM SHEAR RXN. (ASD)	BEAM MOMENT RX (ASD)
BRACE "A"	6.5 KIPS	5.8 KIPS	3.8 KIPS	-
BRACE "B"	9.6 KIPS	12.8 KIPS	13.3 KIPS	-
BRACE "C"	8.1 KIPS	9 KIPS	9.7 KIPS	-
BRACE "D"	6.8 KIPS	18.5 KIPS	20.3 KIPS	-
BRACE "E"	9.8 KIPS	23.6 KIPS	27.6 KIPS	-
BRACE "F"	6.8 KIPS	18.5 KIPS	20.3 KIPS	-
BRACE "G"	-	17.8 KIPS	7.5 KIPS	38.5 KIP-FT
BRACE "H"	-	17.8 KIPS	3.8 KIPS	38.5 KIP-FT

20 BRACED FRAME MEMBER RXN. TABLE

1108 S. Main St. 102 Aberdeen, SD 57401 Phone: 605-725-4852 601 Kansas City St. 7 Rapid City, SD 57701 Phone: 605-716-3652 440 E. 8th St. 221 Sioux Falls, SD 57103 Phone: 605-334-9999 co-oparch.com

> 24285 CO-OP PROJECT NO:

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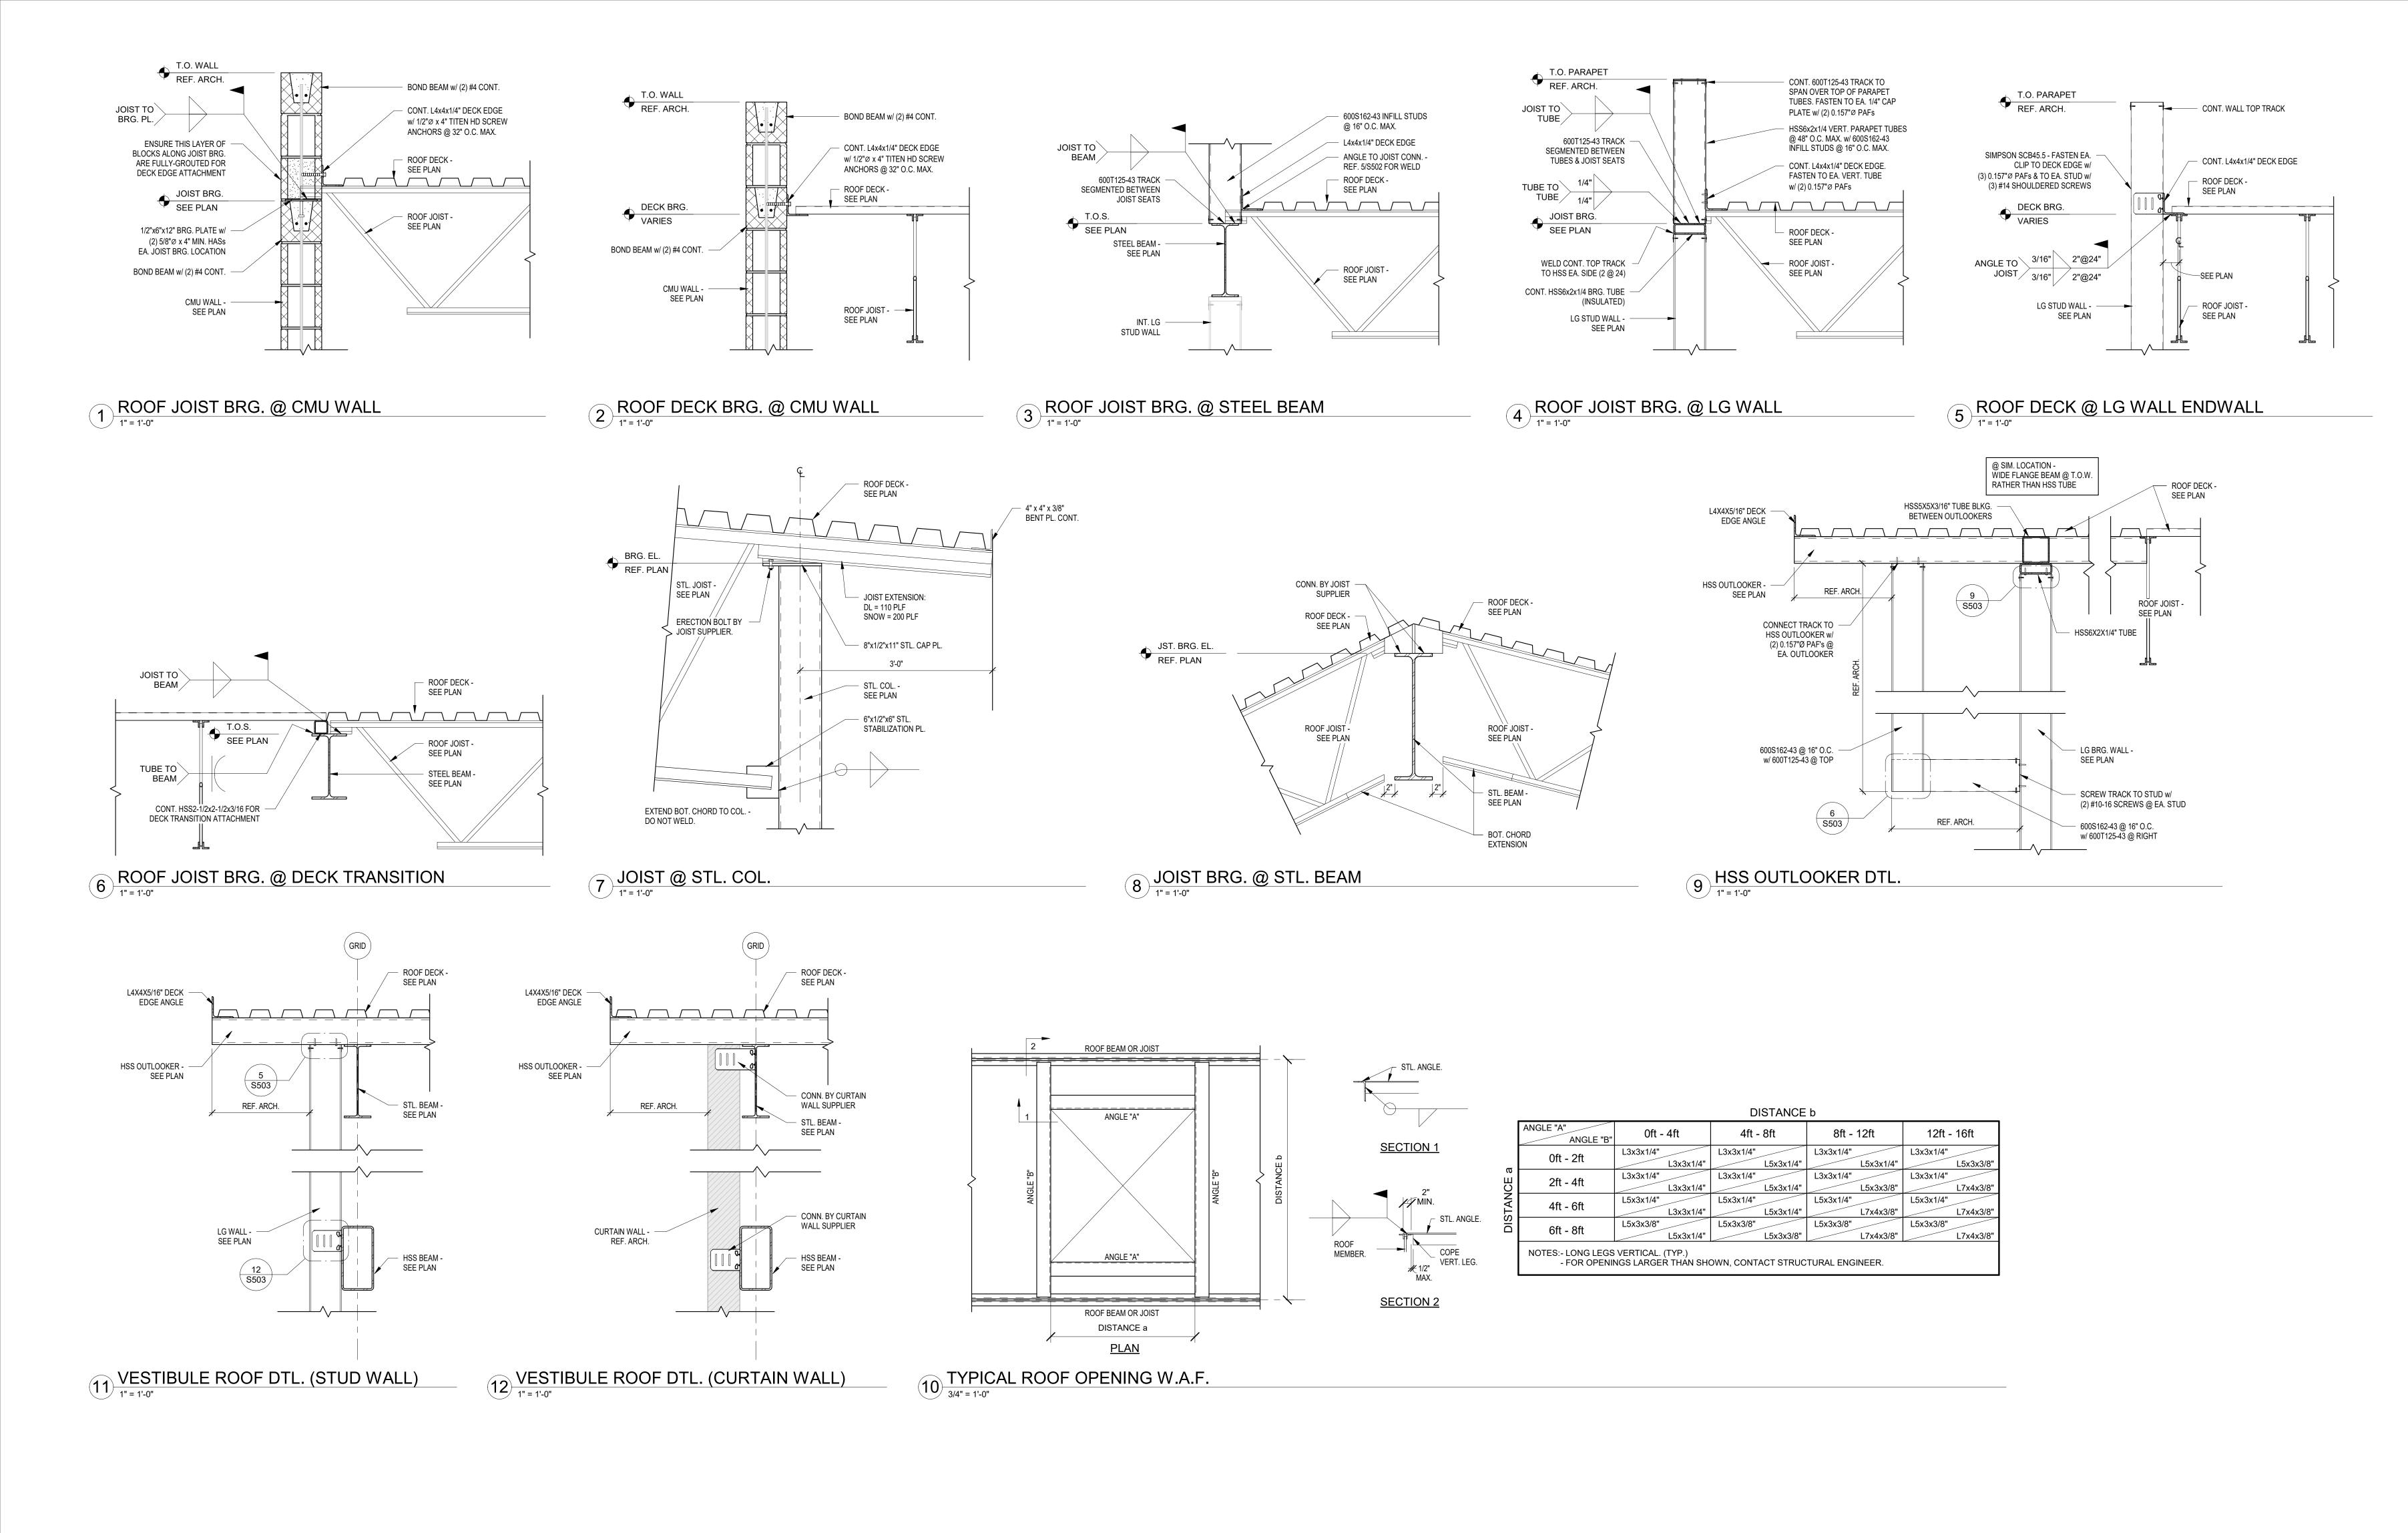
PROJECT: NORTHERN ELECTRIC RENOVATION NORTHERN ELECTRIC COOPERATIVE

ABERDEEN, SOUTH DAKOTA

SHEET TITLE: STRUCTURAL DETAILS

S501

18 BRACE SPLICE





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ISSUE:
5/15/2025 100% CD

REVISION SCHEDULE:
REV. # REV. DSC. REV

PROJECT:

NORTHERN ELECTRIC RENOVATION


NORTHERN ELECTRIC COOPERATIVE

ABERDEEN, SOUTH DAKOTA

SHEET TITLE:
STRUCTURAL DETAILS

STRUCTURAL DETAILS

S502

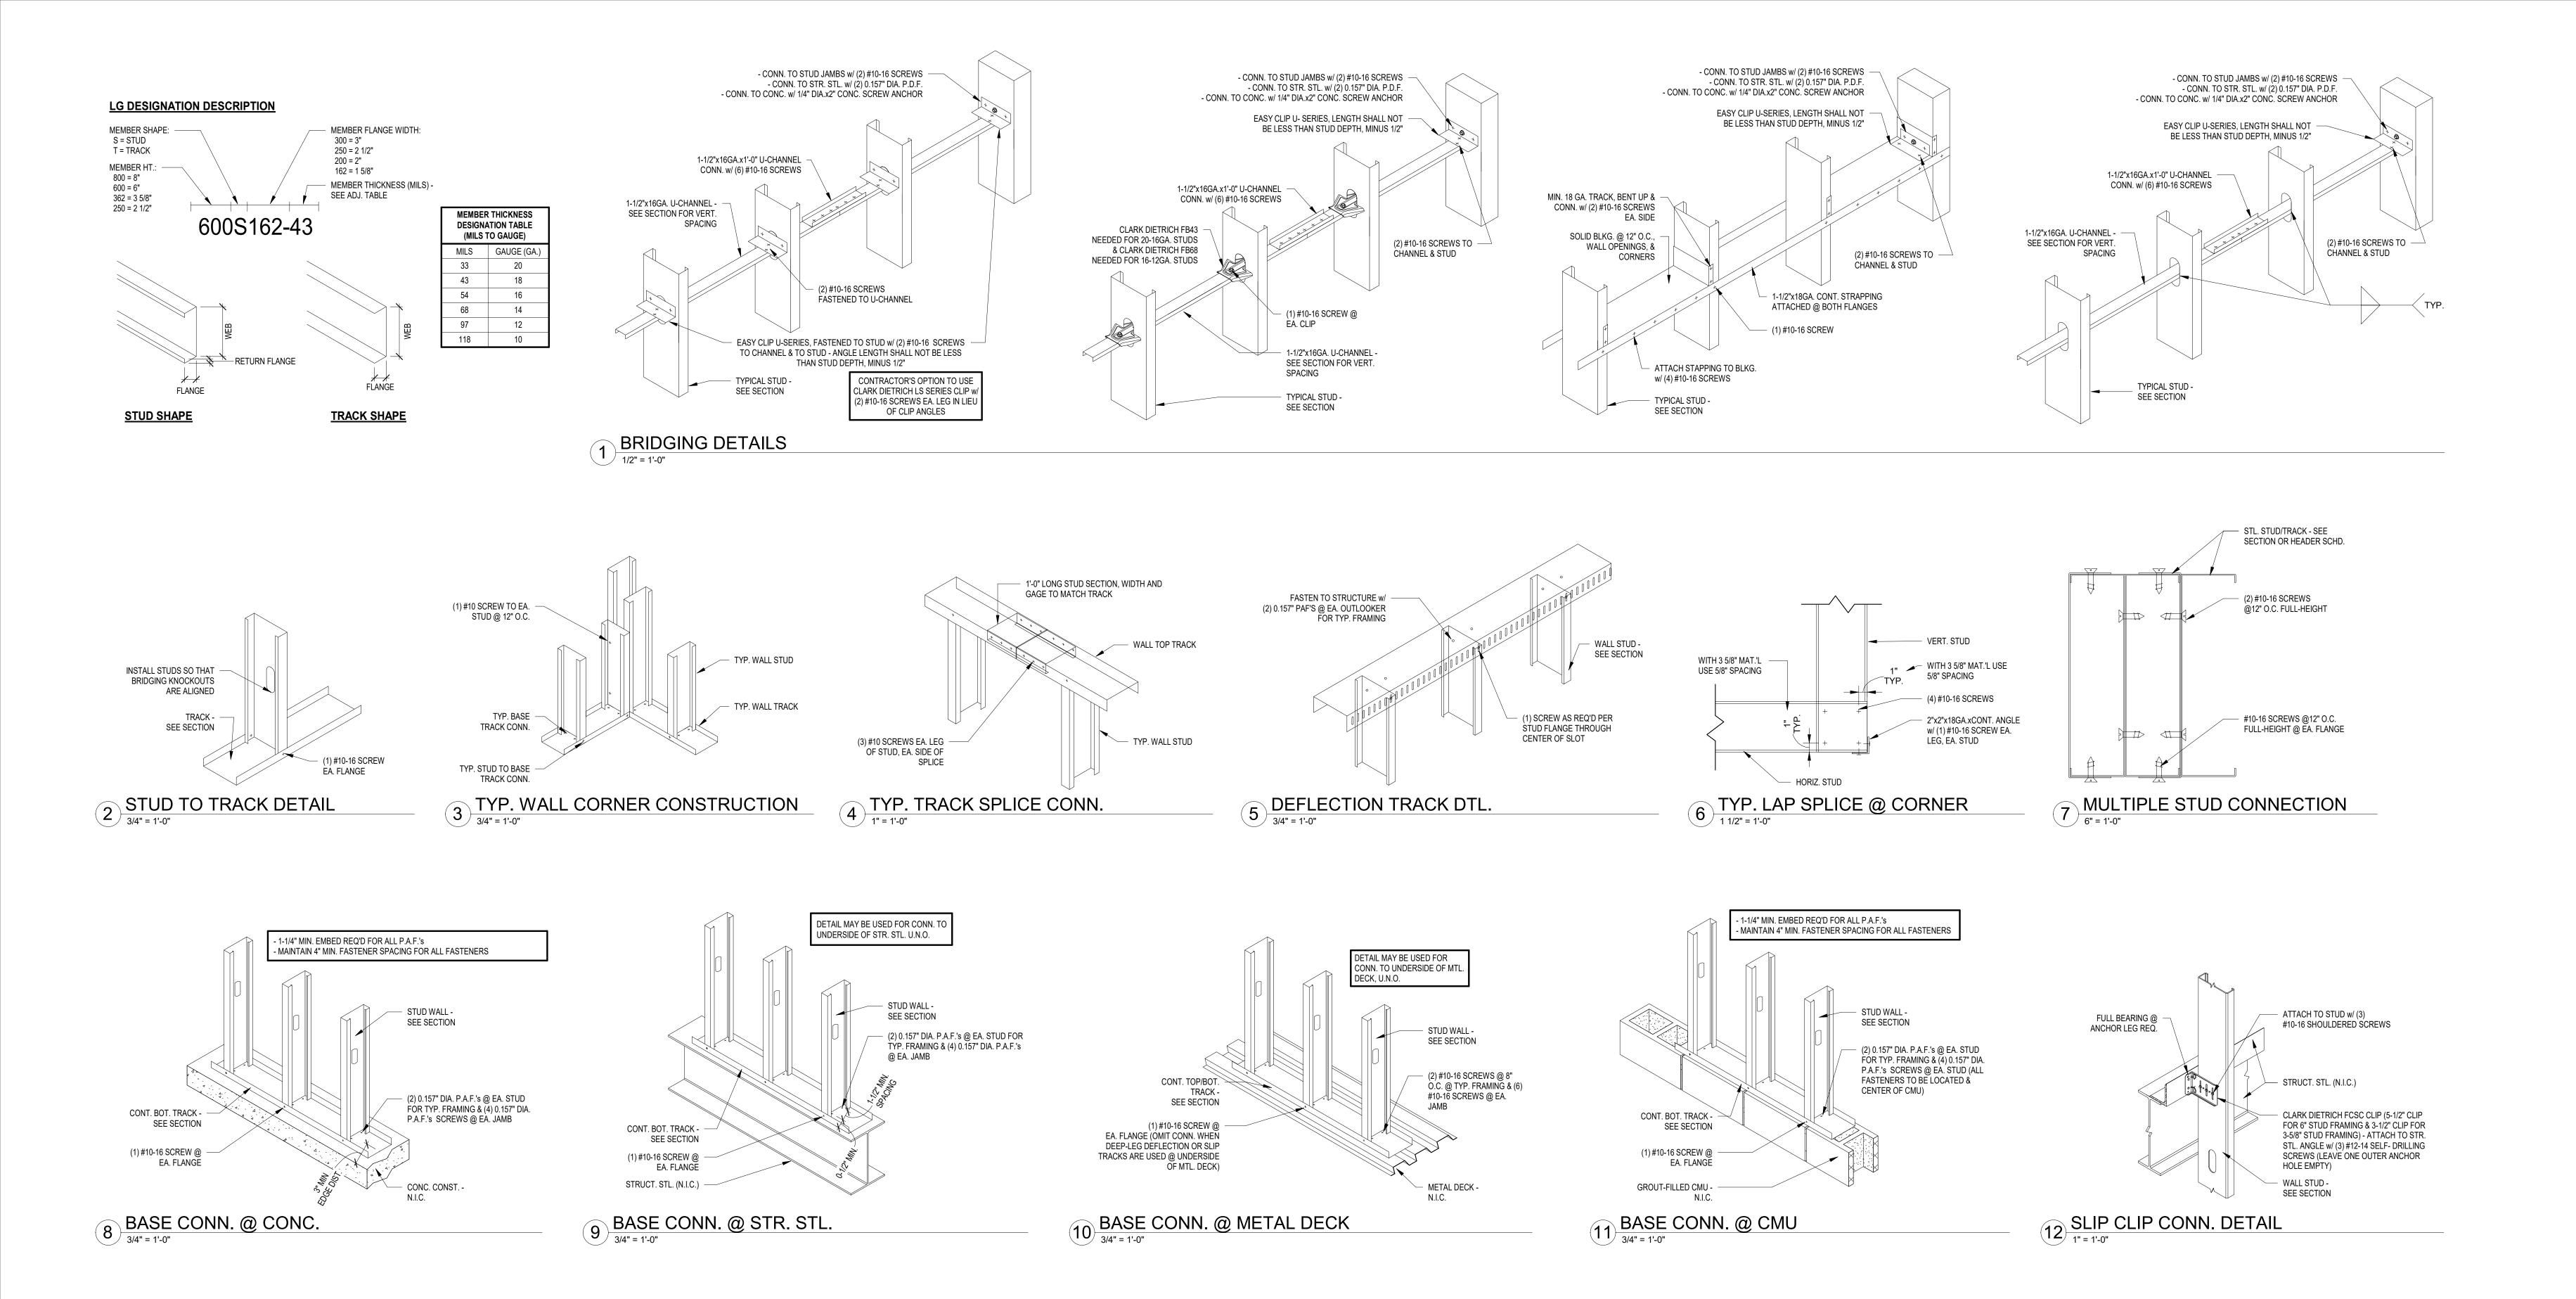



CO-OP PROJECT NO: 24285

ISSUE:
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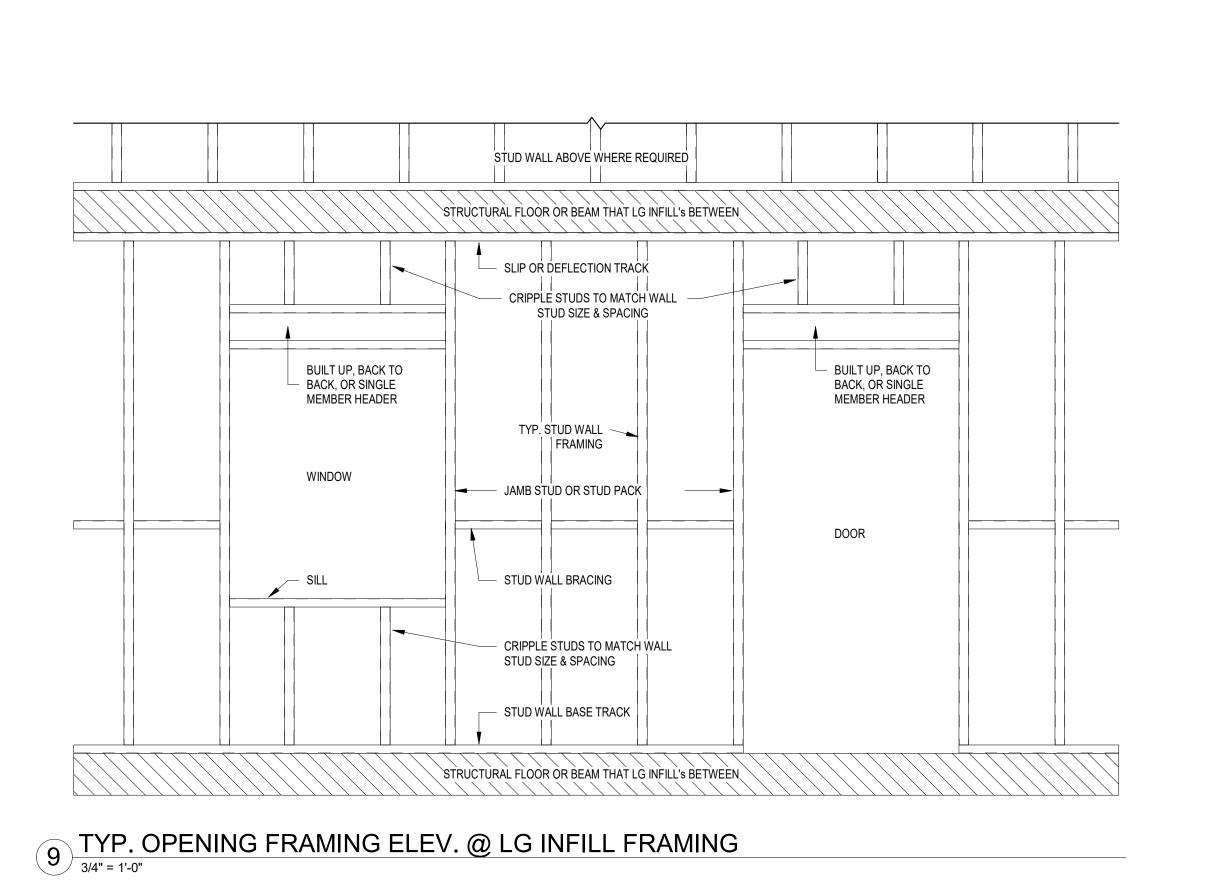
REVISION SCHEDULE:
REV. # REV. DSC. REV. DATE


PROJECT:


NORTHERN ELECTRIC RENOVATION
NORTHERN ELECTRIC COOPERATIVE
ABERDEEN, SOUTH DAKOTA


SHEET TITLE:
STRUCTURAL DETAILS

S503



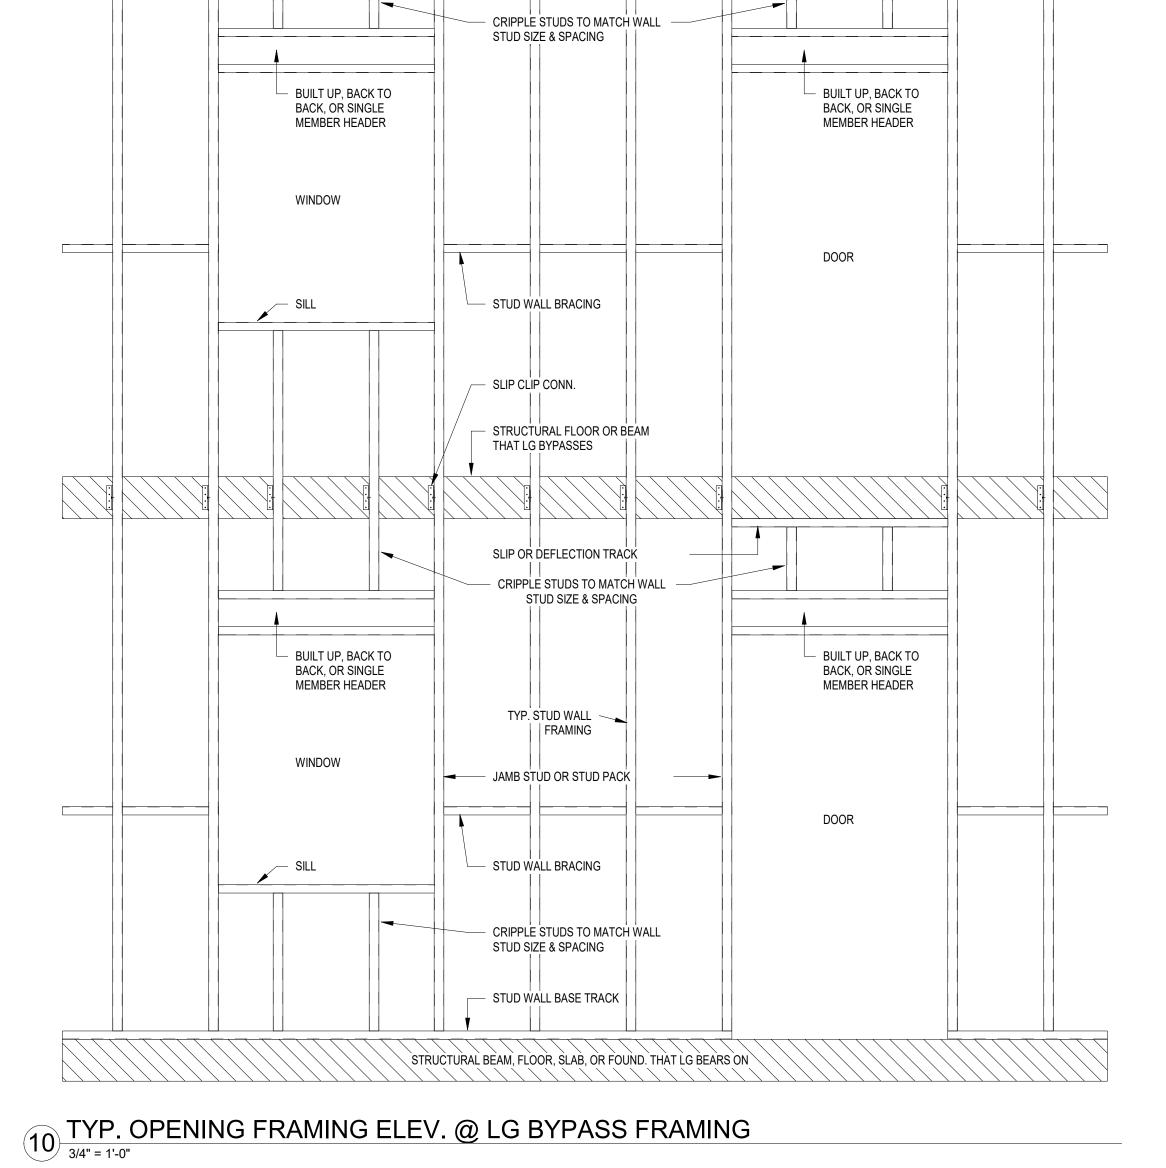

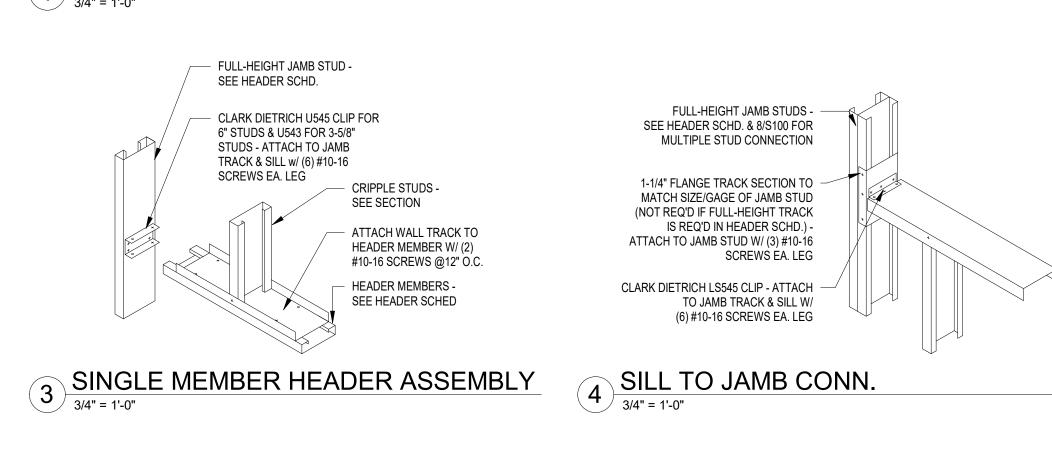

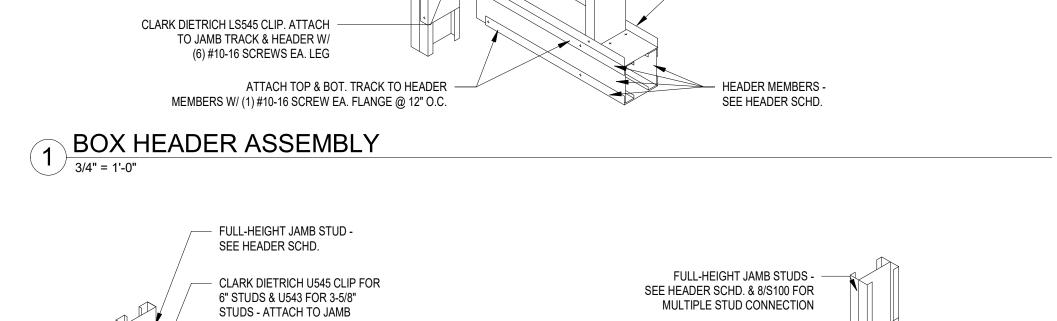

 $\left(\begin{array}{c} 2\\ 5503 \end{array}\right)$

FULL-HEIGHT JAMB STUDS - -

SEE HEADER SCHD. & 8/S100 FOR

1-1/4" FLANGE TRACK SECTION TO -

MATCH SIZE/GAGE OF JAMB STUD

IS REQ'D IN HEADER SCHD.).

TRACK TO MATCH SIZE/GAGE OF -HEADER TRACKS. ATTACH TRACK

SCREWS EA. LEG

(NOT REQ'D IF FULL-HEIGHT TRACK

ATTACH TO JAMB STUD W/ (4) #10-16

TO JAMB W/ (6) #10-16 SCREWS. ATTACH TRACK TO HEADER W/ (3) #10-16 SCREWS EA. FLANGE

MULTIPLE STUD CONNECTION

(4) #10 SCREWS

HEADER STUDS

CRIPPLE STUDS -

SEE SECTION

WALL TRACK -


SCREWS @16" O.C.

ATTACH TO HEADER W/ (2) #10-16

WEB STIFFENER TRACK EA. FACE EA. END

OF BOX HEADER WHERE REQ. (SEE

HEADER SCHD.). MATCH SIZE/GAGE OF

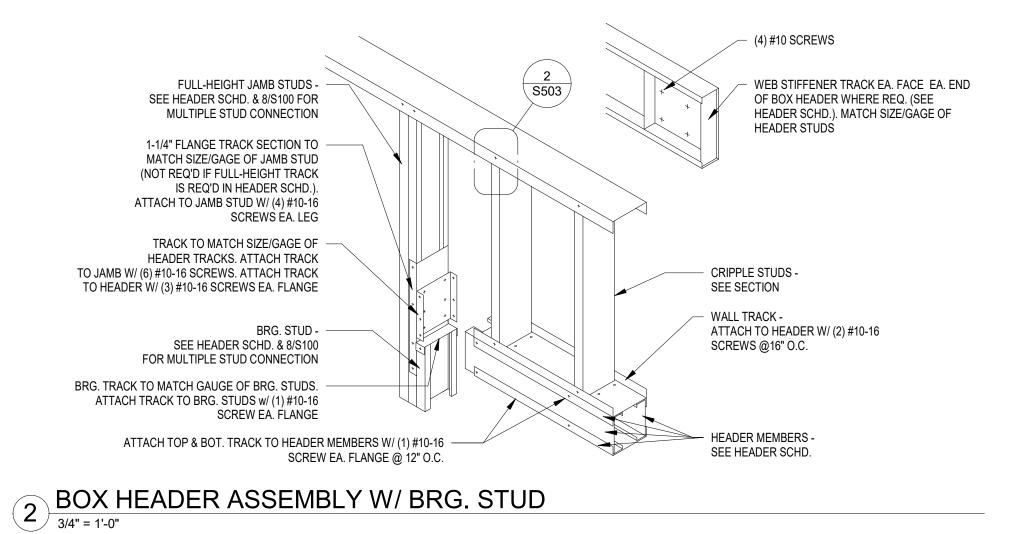

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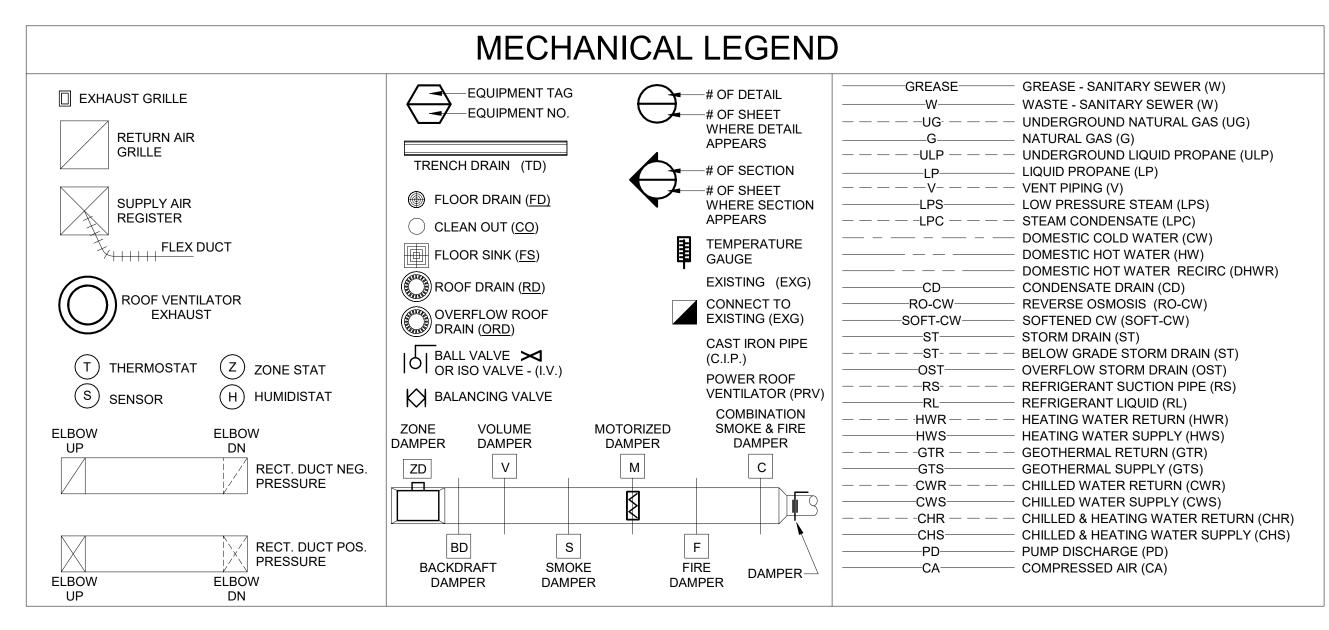
REVISION SCHEDULE:

REV. # REV. DSC.

PROJECT: NORTHERN ELECTRIC RENOVATION NORTHERN ELECTRIC COOPERATIVE ABERDEEN, SOUTH DAKOTA

SHEET TITLE:

STRUCTURAL DETAILS



		ELE	ECTRICAL LEGENI)	
SYMBOL	DESCRIPTION	SYMBOL	DESCRIPTION	SYMBOL	DESCRIPTION
\$	SINGLE POLE SWITCH	## /	LIGHTING FIXTURE	Q	SMOKE DETECTOR
\$ ₃	THREE WAY SWITCH		E = EMERGENCY BALLAST NL = NIGHT LIGHT		HEAT DETECTOR (FT = FIXED TEMPERATURE
\$4	FOUR WAY SWITCH		## = FIXTURE ID TAG		,
\$LV	LOW VOLTAGE PUSH BUTTON SWITCH	/ a,b	a,b = CNTRL/RELAY ID TAG	M	MANUAL PULL STATION
\$ _D	DIMMER SWITCH		UNDER CABINET FIXTURE	H	HORN/STROBE
\$т	TIMER SWITCH	' `		S	SPEAKER/STROBE
\$ ₀	OCCUPANCY SENSOR	₩	WALL MOUNTED FIXTURE	*>	STROBE ONLY XX CANDELA RATING
\$ _P			RECESSED FIXTURE	S	FIRE ALARM WALL SPEAKER
	PILOT LIGHT SWITCH	©	PHOTO CONTROL		
\$ K	KEYED SWITCH		SECURITY CAMERA	(s)	FIRE ALARM CEILING SPEAKER
^{\$} F	VARIABLE SPEED FAN SWITCH			FACP	FIRE ALARM CONTROL PANEL
OS1	OCCUPANCY SENSOR - CEILING MOUNTED	S	WALL SPEAKER	ANNC	FIRE ALARM ANNUNCIATOR PANEL
(PP)	POWER PACK FOR LOW VOLTAGE	_ & _	EXIT FIXTURE	TS	TAMPER SWITCH
	OCCUPANCY SENSOR		EMERGENCY WALL PACK	FS	FLOW SWITCH
Ψ	DUPLEX RECEPTACLE	0—	POLE MOUNTED LIGHT FIXTURE	SD	SMOKE DAMPER
Ψ	GROUND FAULT CIRCUIT INTERRUPTER DUPLEX RECEPTACLE	\bigcirc	CLOCK		
Ψ	250V 4-WIRE RECEPTACLE	N	NURSE CALL PULL STATION	MD	MOTORIZED DAMPER
 	DOUBLE DUPLEX RECEPTACLE	D	NURSE CALL DUTY STATION	DSD	DUCT SMOKE DETECTOR
\bullet	TOP SWITCHED DUPLEX RECEPTACLE	\ <u>\</u>	Notice of the Bott Civilian		DOOD DOOLTION
	SPECIAL OUTLET	$\langle N \rangle$	NURSE CALL CORRIDOR LIGHT	DP	DOOR POSITION
XX	DATA/PHONE OUTLET	NCCP	NURSE CALL CONTROL PANEL	FR	FACIAL RECOGNITION
*	XX INDICATES NO. OF JACKS	T	THERMOSTAT	DS	DOOR STRIKE
$oldsymbol{ abla}$	WALL DATA & HDMI OUTLET			CR	CARD READER/KEYPAD
$oldsymbol{\Lambda}$	WIRELESS ACCESS POINT	(<u>s</u>)	INTERCOM SPEAKER		
	FLOOR BOX WITH POWER, DATA AND HDMI	Н	INTERCOM CALL STATION		DISCONNECT (F = FUSED)
□	FLOOR BOX WITH POWER AND DATA	J	JUNCTION BOX		COMBINATION STARTER
		TC	TIME CLOCK	R	RELAY
0	FLOOR BOX WITH POWER ONLY	V	VOLUME CONTROL	*	CONNECT TO EXISTING
\$ M	MANUAL MOTOR STARTER			WG WP	WIRE GUARD WEATHER PROOF
(3)	MOTOR CONNECTION	T	TRANSFORMER	AC	ABOVE COUNTER
		$\langle T \rangle$	CABLE TV - TWO CAT6A PER OPENING	UC	UNDER COUNTER
VFD	VARIABLE FREQUENCY DRIVE			UPS	UNINTERRUPTIBLE POWER SUPPLY
Q.	CENTER LINE	DH	DOOR HOLDER	EXG MON	EXISTING MONITOR SEE ARCHITECTURAL ELEVATION

SPECIAL NOTES:

1. IN AREAS WHERE EXISTING CEILINGS ARE TO REMAIN, EACH TRADE SHALL BE RESPONSIBLE FOR ANY DAMAGE OR REPAIR NEEDED TO EXISTING CEILINGS AS A RESULT OF THEIR WORK. 2. EACH TRADE SHALL BE RESPONSIBLE FOR CUTTING AND PATCHING AS NECESSARY TO ALLOW FOR COMPLETION OF THEIR WORK. REFER TO ARCHITECTURAL PLANS FOR SELECTIVE DEMOLITION BY

- 3. ALL CONTRACTORS SHALL VISIT THE SITE AND VERIFY ALL EXISTING CONDITIONS AND DIMENSIONS. NOTIFY THE ENGINEER IMMEDIATELY OF ANY DISCREPANCIES.
- 4. ALL ROOFING WORK BY ROOFING CONTRACTOR, ALL TRADES TO COORDINATE.
- 5. THE EXISTING BUILDING WILL BE IN USE DURING THIS CONSTRUCTION. SCHEDULE AND CARRY OUT THE WORK IN SUCH A MANNER AS TO CAUSE THE OWNER A MINIMUM OF INCONVENIENCE DUE TO SERVICE INTERRUPTIONS. TEMPORARY SERVICES SHALL BE INSTALLED IF ONE PHASE OF CONSTRUCTION DISRUPTS SERVICE TO ANOTHER AREA OF THE BUILDING OR IF EQUIPMENT HAS TO BE RELOCATED TO ALLOW CONSTRUCTION TO PROGRESS. SERVICE INTERRUPTIONS SHALL BE CONFINED TO THE SMALLEST AREA POSSIBLE AT ANY ONE TIME AND INTERRUPTIONS SHALL BE SCHEDULE WITH THE OWNER'S SITE REPRESENTATIVE. AFTER SERVICE HAS BEEN RESTORED FOLLOWING AN INTERRUPTION, INSPECT AREAS AFFECTED BY THE INTERRUPTION AND BE RESPONSIBLE FOR RETURNING AUTOMATICALLY CONTROLLED EQUIPMENT TO THE SAME OPERATING CONDITION, WHICH EXISTED PRIOR TO THE INTERRUPTION.
- 6. BY BASE BID: ALL DDC TEMPERATURE CONTROL WORK TO BE COMPLETED BY G&R CONTROLS (CONTACT

BY ALT #7.1: ALL DDC TEMPERATURE CONTROL WORK TO BE COMPLETED BY JOHNSON CONTROLS (CONTACT GREG HINTGEN 605-362-5315).


BY ALT #7.2: ALL DDC TEMPERATURE CONTROL WORK TO BE COMPLETED BY OTHER ENGINEER PRIOR APPROVED CONTROLS COMPANY, SEE SPECS & ADDENDUM(S).

GLYCOL SOLUTION:

- A. EXISTING HYDRONICS SYSTEM (SHOP): a. EXISTING SYSTEM TO BE MAINTAINED DURING CONSTRUCTION FOR TEMPORARY HEATING OF THE SHOP. AFTER NEW BUILDING IS CONSTRUCTED, THIS SYSTEM SOLUTION TO BE DRAINED & DISPOSED OF, AND NEW HYDRONICS SYSTEM TO FEED INTO THIS EXISTING HYDRONICS SYSTEM. b. SOLUTION IN EXISTING WELLFIELD TO BE DRAINED/PURGED BY WELLFIELD CONTRACTOR. c. THE PLUMBING CONTRACTOR SHALL BE RESPONSIBLE FOR DRAINING AND STORING THE EXISTING GLYCOL SOLUTION AS REQUIRED FOR COMPLETION OF THEIR WORK AS NECESSARY FOR TEMPORARY HYDRONICS WORK TO SERVICE THE SHOP DURING CONSTRUCTION.
- d. THE EXISTING SYSTEM SHALL BE DRAINED AS NECESSARY FOR PROPOSED DEMOLITION, NO CLEANING AND FLUSHING ON EXISTING PIPING. e. AFTER 2025/2026 HEATING SEASON IS OVER, THIS EXISTING SYSTEM TO BE COMPLETELY DRAINED
- AND NOT SALVAGED. B. NEW HEATING, CHILLED, & GEOTHERMAL HYDRONICS SYSTEM (ADDITION & EXISTING SHOP): a. HYDRONICS SYSTEM SOLUTION SHALL BE 35% DOWFROST HD PROPYLENE GLYCOL.
- b. SYSTEM VOLUME: EXISTING SYSTEM VOLUME: 1,730 GALLONS PROPOSED ADDITIONS TO SYSTEM VOLUME: 1,600 GALLONS
- TOTAL SYSTEM VOLUME: 3,330 GALLONS c. THE PLUMBING CONTRACTOR SHALL BE RESPONSIBLE FOR CLEANING AND FLUSHING THE NEW HYDRONICS SYSTEM PIPING PRIOR TO PUMPING IN NEW SOLUTION AND SYSTEM STARTUP.
- d. AFTER PROPOSED WORK IS COMPLETE, THE PLUMBING/HYDRONICS CONTRACTOR IS TO PROVIDE A COMPLETE ANALYSIS OF THE HYDRONICS SOLUTION TO CONFIRM PROPER GLYCOL % AND TREATMENT. SUBMIT ANALYSIS/RECOMMENDATIONS TO SICHMELLER ENGINEERING & OWNER. IF SOLUTION ANALYSIS INDICATES EITHER SOLUTION IS NOT SATISFACTORY, THIS CONTRACTOR TO MAKE ADJUSTMENTS AS RECOMMENDED BY GLYCOL SUPPLER & RETEST UNTIL ANALYSIS RESULTS
- 8. DURING THE SHOP DRAWING PROCESS, ALL M&E CONTRACTORS TO BE RESPONSIBLE FOR MARKING UP ALL OPENINGS IN THE CONCRETE SLAB, PRECAST WALL, CORE FLOOR, OR STRUCTURAL STEEL FRAMING, AND STRUCTURAL STEEL ROOF JOIST SYSTEMS REQUIRED FOR THE INSTALLATION OF THEIR RESPECTIVE SYSTEMS IN NEW AND EXISTING STRUCTURAL SYSTEMS.
- 9. WHERE PEX PIPING IS USED, PIPING SHALL BE UPONOR PEX-A POTABLE WATER PIPING WITH UPONOR F1960 EXPANDABLE FITTINGS, NO CRIMP FITTINGS TO BE ACCEPTED, PROVIDED THE CONTRACTOR IS TRAINED AND FOLLOWING ALL MANUFACTURER'S RECOMMENDATIONS TO FULFILL ALL AVAILABLE UPONOR 25 YEAR WARRANTY COVERAGE.
- 10. ORIGINAL PLANS ARE AVAILABLE. PLEASE CONTACT THE ENGINEER'S OFFICE TO REQUEST. CONTACT ISAAC @ 605-225-4344.
- 11. REFER TO THE FRONT END BIDDING DOCUMENTS FOR DESCRIPTION OF ALTERNATES.

ITOR SEE A	ARCHITECTURAL ELEVATIONS
	ELECTRICAL & MECHANICAL SHEET INDEX
Sheet	Chart Name
Number	Sheet Name
EM100	MOTOR SCHEDULE, LEGEND & SHEET INDEX
EM101	ELECTRICAL & MECHANICAL SITE DEMOLITION PLAN
EM102	ELECTRICAL & MECHANICAL BOOF BLAN
EM103	ELECTRICAL & MECHANICAL ROOF PLAN
M200.N	PLUMBING & HYDRONICS DEMOLITION PLAN - NORTH
M200.S	PLUMBING & HYDRONICS DEMOLITION PLAN - SOUTH
M300.N	HVAC DEMOLITION PLAN - SOUTH
M300.S	HVAC DEMOLITION PLAN - SOUTH
M400.N	BELOW GRADE PLUMBING & HYDRONICS PLAN - SOUTH
M400.S	BELOW GRADE PLUMBING & HYDRONICS PLAN - SOUTH
M401.N	ABOVE GRADE PLUMBING & HYDRONICS PLAN - NORTH
M401.S	ABOVE GRADE PLUMBING & HYDRONICS PLAN - SOUTH
M500.N	HVAC PLAN - NORTH
M500.S	HVAC PLAN - SOUTH
M501	HVAC TEMPERATURE CONTROL ZONE PLAN
M600	PLUMBING FIXTURE SCHEDULE
M700	MECHANICAL DETAILS - 1 OF 4
M701	MECHANICAL DETAILS - 2 OF 4
M702	MECHANICAL DETAILS - 3 OF 4
M703	MECHANICAL DETAILS - 4 OF 4
M800	MECHANICAL SECTIONS - 1 OF 3
M801	MECHANICAL SECTIONS - 2 OF 3
M802	MECHANICAL SECTIONS - 3 OF 3
M900	MECHANICAL SCHEDULES
M901	MECHANICAL SCHEDULES - CONTINUED
E200.N	ELECTRICAL DEMOLITION PLAN - NORTH
E200.S	ELECTRICAL DEMOLITION PLAN - SOUTH
E300.N	POWER & DATA PLAN - NORTH
E300.S	POWER & DATA PLAN - SOUTH
E400.N	LIGHTING PLAN - NORTH
E400.S	LIGHTING PLAN - SOUTH
E500.N	SPECIAL SYSTEMS PLAN - NORTH
E500.S	SPECIAL SYSTEMS PLAN - SOUTH
E600	ELECTRICAL DETAILS
E700	ELECTRICAL SCHEDULES

				н۷А(U EQ	P0	VER			RDINA			MOTO		SCH							P.C. = PLUMBING CONTRAC V.C. = VENTILATION CONTRAC T.C. = TEMPERATURE CONTROL CONTRAC
			(F)			CY	60 'C.	ST	ARTER	R C	CONTROL	-	INFORM		N	DISCO	ONNEC	* T				
EQUIPMENT NUMBER	USE	TION	FIRE ALARM INTERLOCK REQUIRED HP OR WATTAGE (KW) OR FRACTIONAL	МСА	FLA	VOLTAGE	PHASE	ТҮРЕ	SIZE	BY BY	RING	TURE	THERMOSTAT BY AQUASTAT BY	SPEED SELECT SWITCH BY	TIME CLOCK BY		SIZE/TYPE/FUSE SIZE	NEMA	CIRCUIT	CONDUIT SIZE	CONDUCTOR SIZE	NOTES
AHU - 1	WEST HVAC - SUPPLY FAN	MECH 141	Y 2X5	12.0	0 10.0	480	3	VFD		VC TC		тс				EC						DUCT SMOKE DETECTOR SHUTDOWNS BY EC; CO2/HUMIDITY SENSORS IN RA DUCT; FACTORY INSTALLED VFD'S, DISCONNECT BY EC
RF-1	WEST HVAC - RETURN FAN MOTORIZED DAMPER - OUTSIDE AIR TO AHU-1 MOTORIZED DAMPER - RETURN AIR TO AHU-1 MOTORIZED DAMPER - RELIEF AIR FROM RF-1	MECH 141 MECH 141 MECH 141 MECH 141	Y 7-1/	2	11.0	480	3			TC TC TC TC TC		TC TC TC				EC						DUCT SMOKE DETECTOR SHUTDOWNS BY EC; FACTORY EC MOTOR; COMBINATION STARTER BY EC PROVIDED & INSTALLED BY VC; CONTROLLED BY TC PROVIDED & INSTALLED BY VC; CONTROLLED BY TC PROVIDED & INSTALLED BY VC; CONTROLLED BY TC
AHU-2	EAST HVAC - SUPPLY FAN	MECH 141	Y 2X5	12.0	0 10.0	480	3	VFD		VC TC		TC				EC						DUCT SMOKE DETECTOR SHUTDOWNS BY EC; CO2/HUMIDITY SENSORS IN RA DUCT; FACTORY INSTALLED VFD'S, DISCONNECT BY EC
RF-2	EAST HVAC - RETURN FAN MOTORIZED DAMPER - OUTSIDE AIR TO AHU-2 MOTORIZED DAMPER - RETURN AIR TO AHU-2 MOTORIZED DAMPER - RELIEF AIR FROM RF-2 HUMIDIFICATION - AHU-1	MECH 141 MECH 141 MECH 141 MECH 141 MECH 141	Y 7-1/		9 13.5	480	3			TC TC TC TC TC TC TC TC		TC TC TC TC				EC						DUCT SMOKE DETECTOR SHUTDOWNS BY EC; FACTORY EC MOTOR; COMBINATION STARTER BY EC PROVIDED & INSTALLED BY VC; CONTROLLED BY TC PROVIDED & INSTALLED BY VC; CONTROLLED BY TC PROVIDED & INSTALLED BY VC; CONTROLLED BY TC
HUM-2 HUM-3	HUMIDIFICATION - AHU-2 HUMIDIFICATION - SERVER 126	MECH 141 SERVER 126	(18.7		2 22.5 8 12.7		3			TC TC		TC TC				EC EC						
VAV'S	HVAC - MULTIPLE LOCATIONS	SEE PLANS	-			-	-			тс		TC T	тс									SEE HVAC TEMPERATURE CONTROL PLAN
DSA-1	DUCTLESS SPLIT SYSTEM - BACK-UP COOLING FOR SERVER 126	SERVER 126	(F)			208	1			VC	VC	VC V	VC									VC TO PROVIDE & INSTALL HARDWIRED REMOTE T-STAT AND SET-UP FOR BACK-UP COOLING; POWER FED FROM OUTDOOR UNIT
SF-1 SF-2	AIR COOLED CONDENSING UNIT FOR DSA-1 NO2CO EXHAUST MAKE-UP - SHOP GENERAL MAKE-UP - SHOP	SHOP 61 EXG SHOP EXG SHOP	10 (F)		14.0		3			тс		TC TC				EC EC						LINE VOLTAGE N.C. MOTORIZED DAMPER TO MATCH FAN VOLTAGE POWERED BY EC WITH FAN OPERATION LINE VOLTAGE N.C. MOTORIZED DAMPER TO MATCH FAN VOLTAGE
SF-3	NO2CO EXHAUST MAKE-UP - SHOP	EXG SHOP	10		14.0		3			тс		TC				EC						POWERED BY EC WITH FAN OPERATION LINE VOLTAGE N.C. MOTORIZED DAMPER TO MATCH FAN VOLTAGE POWERED BY EC WITH FAN OPERATION
EF-1	NO2CO EXHAUST - SHOP	EXG SHOP	10		14.0					ТС		тс				EC						LINE VOLTAGE N.C. MOTORIZED DAMPER TO MATCH FAN VOLTAGE POWERED BY EC WITH FAN OPERATION LINE VOLTAGE N.C. MOTORIZED DAMPER TO MATCH FAN VOLTAGE
EF-2	GENERAL EXHAUST - SHOP	EXG SHOP	(F)		1.9					TC		TC				EC						POWERED BY EC WITH FAN OPERATION LINE VOLTAGE N.C. MOTORIZED DAMPER TO MATCH FAN VOLTAGE
EF-3 EF-4	NO2CO EXHAUST - SHOP GENERAL EXHAUST - OFFICE AREA	EXG SHOP CORRIDOR	10 (F)		14.0		3			TC TC		TC TC				EC EC						POWERED BY EC WITH FAN OPERATION LINE VOLTAGE N.C. MOTORIZED DAMPER TO MATCH FAN VOLTAGE
EF-5	GENERAL EXHAUST - OFFICE AREA	CUST 132	(F)		4.4					тс		TC				EC						POWERED BY EC WITH FAN OPERATION LINE VOLTAGE N.C. MOTORIZED DAMPER TO MATCH FAN VOLTAGE POWERED BY EC WITH FAN OPERATION
EF-6	EXHAUST - RESTROOM 140	RERSTROOM 140	(F)		1.2	120	1			TC		тс				EC						FOWERED BY EC WITH FAN OPENATION
EF-A	RANGEHOOD EXHAUST - TRAINING ROOM 136	TRAINING ROOM 136	(F)		4.0	120	1			EC		TC				EC						
HP - 1	CENTRAL GEO WATER TO WATER HEAT PUMP - HEATING & CHILLED WATER CENTRAL GEO WATER TO WATER HEAT PUMP -	MECH 141			0 41.4					TC		TC				EC						
HP-2	HEATING & CHILLED WATER CENTRAL GEO WATER TO WATER HEAT PUMP -	MECH 141			0 41.4					TC		TC				EC						
17-3	HEATING & CHILLED WATER CENTRAL HEAT PUMP - VME CONTROL PANEL	MECH 141		4.0	0 41.4		1			TC TC		TC TC				EC						
B-1	ELECTRIC BOILER - SUPPLEMENTAL HEAT TO HWS	TEMP EXG STORAGE 63 /MECH 141	(80) (100		120.3	480	3			тс		тс				EC						TEMPORARILY INSTALLED IN EXG STORAGE 63 AT 80 KW (WITH 100 KW INTERNALLY DISCONNECTED) & TEMP CONTROL BY EXG BUFFER TANK CONTROLS; THEN RELOCATED MECH 141 AT FULL KW AND CONTROLLED BY BAS
CP - 1	PRIMARY PUMP HEATING WATER PUMP BACKUP PUMP HEATING WATER PUMP	MECH 141	7.5		11.0		3	VFD VFD		TC TC		TC TC				TC TC						VFD WITH INTEGRAL DISCONNECT FURNISHED BY TC - INSTALLED BY EC VFD WITH INTEGRAL DISCONNECT FURNISHED BY TC - INSTALLED BY EC
CP-3	PRIMARY PUMP CHILLED WATER PUMP	MECH 141	10		14.0		3	VFD		тс		TC				TC						VFD WITH INTEGRAL DISCONNECT FURNISHED BY TC - INSTALLED BY EC
CP-4 CP-5	PRIMARY GOETHERMAL WELLFIELD PUMP	MECH 141 MECH 141	10		21.0		3	VFD VFD		TC TC		TC TC				TC TC						VFD WITH INTEGRAL DISCONNECT FURNISHED BY TC - INSTALLED BY EC VFD WITH INTEGRAL DISCONNECT FURNISHED BY TC - INSTALLED BY EC
CP-6 CP-7	BACKUP GOETHERMAL WELLFIELD PUMP SUPPLEMENTAL BOILER B-1 CIRCULATOR	MECH 141	15 (F)		21.0		3	VFD		TC TC		TC TC				TC EC						VFD WITH INTEGRAL DISCONNECT FURNISHED BY TC - INSTALLED BY EC
P-8	DOMESTIC HOT WATER RECIRC - 120° F	MECH 141	(F)		2.3		1			TC		TC				EC						
CP - 9 UH - 1	IN-FLOOR HEAT CIRCULATOR HEATING - LOCKERS 61A	STORAGE 63	(F)		2.1		1			TC		TC				EC EC						
JH-2	HEATING - EXG MEZZANINE 201	EXG MEZZ 201	(F)		1.8		1									EC						
/H - 1 3P - 1	OWNER PROVIDED AIR SOURCE HEAT PUMP WATER HEATER - 140° F DOMESTIC WATER SERVICE BOOSTER PUMP	MECH 141	2X7-1	/2	21.6		3			PC		PC				EC PC						FACTORY CONTROL PANEL WITH INTEGRAL DISCONNECT
ST - 1 ST - 2	DOMESTIC COLD WATER STORAGE TANK DOMESTIC COLD WATER STORAGE TANK	MECH 141																				
UH-1	ELECTRIC HEAT - VESTIBULE 119	VESTIBULE 119	(4)		19.2	208	1			EC	EC	E	EC									INTEGRAL TAMPER PROOF T-STAT HIDDEN BEHIND PANEL BY EC
UH-2 UH-3	ELECTRIC HEAT - VESTIBULE 100 ELECTRIC HEAT - VESTIBULE 135	VESTIBULE 100 VESTIBULE 135	(4)		19.2	208	1 1			EC EC	EC EC		EC EC									INTEGRAL TAMPER PROOF T-STAT HIDDEN BEHIND PANEL BY EC
H-1	ELECTRIC HEAT - RESTROOM 101A	RR 101A	(1.05		8.8					EC		-	EC									LINE VOLTAGE THERMOSTAT FIELD INSTALLED BY EC
D-1	DEHUMIDIFIER - SHOP/WAREHOUSE	EXG SHOP & WAREHOUSE	(F)	·	12.0					TC		тс				EC						CORD CONNECTED, SHARES HUMIDISTAT WITH EXG DUCTED DEHUMIDIFIER
D-2	DEHUMIDIFIER - SHOP/WAREHOUSE	EXG SHOP & WAREHOUSE	(F)		12.0	120	1			TC		TC T	TC			EC						CORD CONNECTED, SHARES HUMIDISTAT WITH EXG DUCTED DEHUMIDIFIER
.S-1	NEW SANITARY SEWER LIFT STATION	EXTERIOR	2			480	1			EC	EC					EC						EC TO PROVIDE COMBINATION STARTER DISCONNECT, INSTALLED ON UNISTRUT STAN MOUNTED TO CONCRETE PAD AROUND LIFT STATION
	NEW SHOP HOLDING TANK	EXTERIOR								тс		тс										TC TO PROVIDE & INSTALL ULTRASONIC SENSOR TO MONITOR AND ALARM HIGH WATE LEVEL IN HOLDING TANK FOR SHOP WASTE WATER. PROVIDE & INSTALL CONDUIT LAID ENOUGH FOR FUTURE MONITORING OF LS-1 LIFT STATION.
C IID	EXG GEO HEAT PUMP W-TO-W	EVO STORAGE 62				400				EXI	STING	SHOP	EQUIPM	MENT								
(G HP XG B	PRIMARY HTG & CLG TO EXG BUFFER TANK EXG ELECTRIC BOILER	EXG STORAGE 63 EXG STORAGE 63	(36)			480																TO BE DEMO'D SUMMER 2025 TO BE DEMO'D SUMMER 2025
G BT	SUPPLEMENTAL HEAT TO EXG BUFFER TANK EXG BUFFER TANK WITH PUMP MODULE HYDRONIC HTG & CLG WATER (EXG INFLOOR HEAT & EXG FC HTG & CLG)	EXG STORAGE 63				208																TO BE DEMO'D SPRING 2026 NEW B-1 @ 80KW TO BE TEMP'D FOR 2025/2026 HEATING SEASON
G AC	CONTROLS EXG AIR COMPRESSOR EXG SHOP	EXG STORAGE 63	5/3			120 230 / 460										EXG						DANGER THIS CONTACTOR IS FED FROM TWO SOURCES CONTACTOR 480V COIL 208V
(G FC	EXG SHOP EXG FAN COIL HTG & CLG EXG SHOP ROOMS STORAGE 63, TOOL STORAGE 65, METER ROOM 66	EXG STORAGE 63	1/3			208				TC		тс т	тс			EXG						
KG DH	EXG DUCTED DEHUMIDIFIER EXG SHOP	EXG STORAGE 63	(F)			120				TC		тс т	тс			EXG						SHARES HUMIDISTAT WITH D-1 & D-2
(G WH	EXG ELECTRIC WATER HEATER EXG SHOP	EXG STORAGE 63	(4.5)		208										EXG						
G PW	EXG PRESSURE WASHER EXISTING POWER ROOF VENTILATOR	EXG SHOP				208																
G PRV	EXISTING POWER ROOF VENTILATOR EXHAUST EXG SHOP 61 EXISTING ELECTRIC HANGING UNIT HEATER -	ROOF EXG SHOP &	3/4			480																TO BE DEMO'D SUMMER 2025
G EH-1	SUPPLEMENTAL HEAT EXISTING ELECTRIC HANGING UNIT HEATER -	WAREHOUSE EXG SHOP &	(15)			480																TO BE DEMO'D SUMMER 2025
G EH-1	SUPPLEMENTAL HEAT EXISTING ELECTRIC HANGING UNIT HEATER -	WAREHOUSE EXG SHOP &	(15)			480							_									TO BE DEMO'D SUMMER 2025
En ,		1	(15)	1	1	480	1 [ı	ı I	1 1				ı [1	TO BE DEMO'D SUMMER 2025
G FPN	SUPPLEMENTAL HEAT EXISTING MOTOR VEHICLE FUEL PUMP (NORTH)	WAREHOUSE EXTERIOR	(13)			120										EXG						

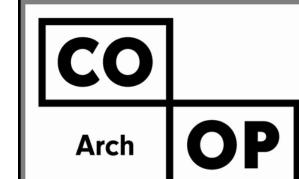

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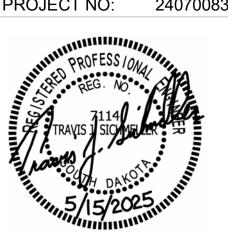
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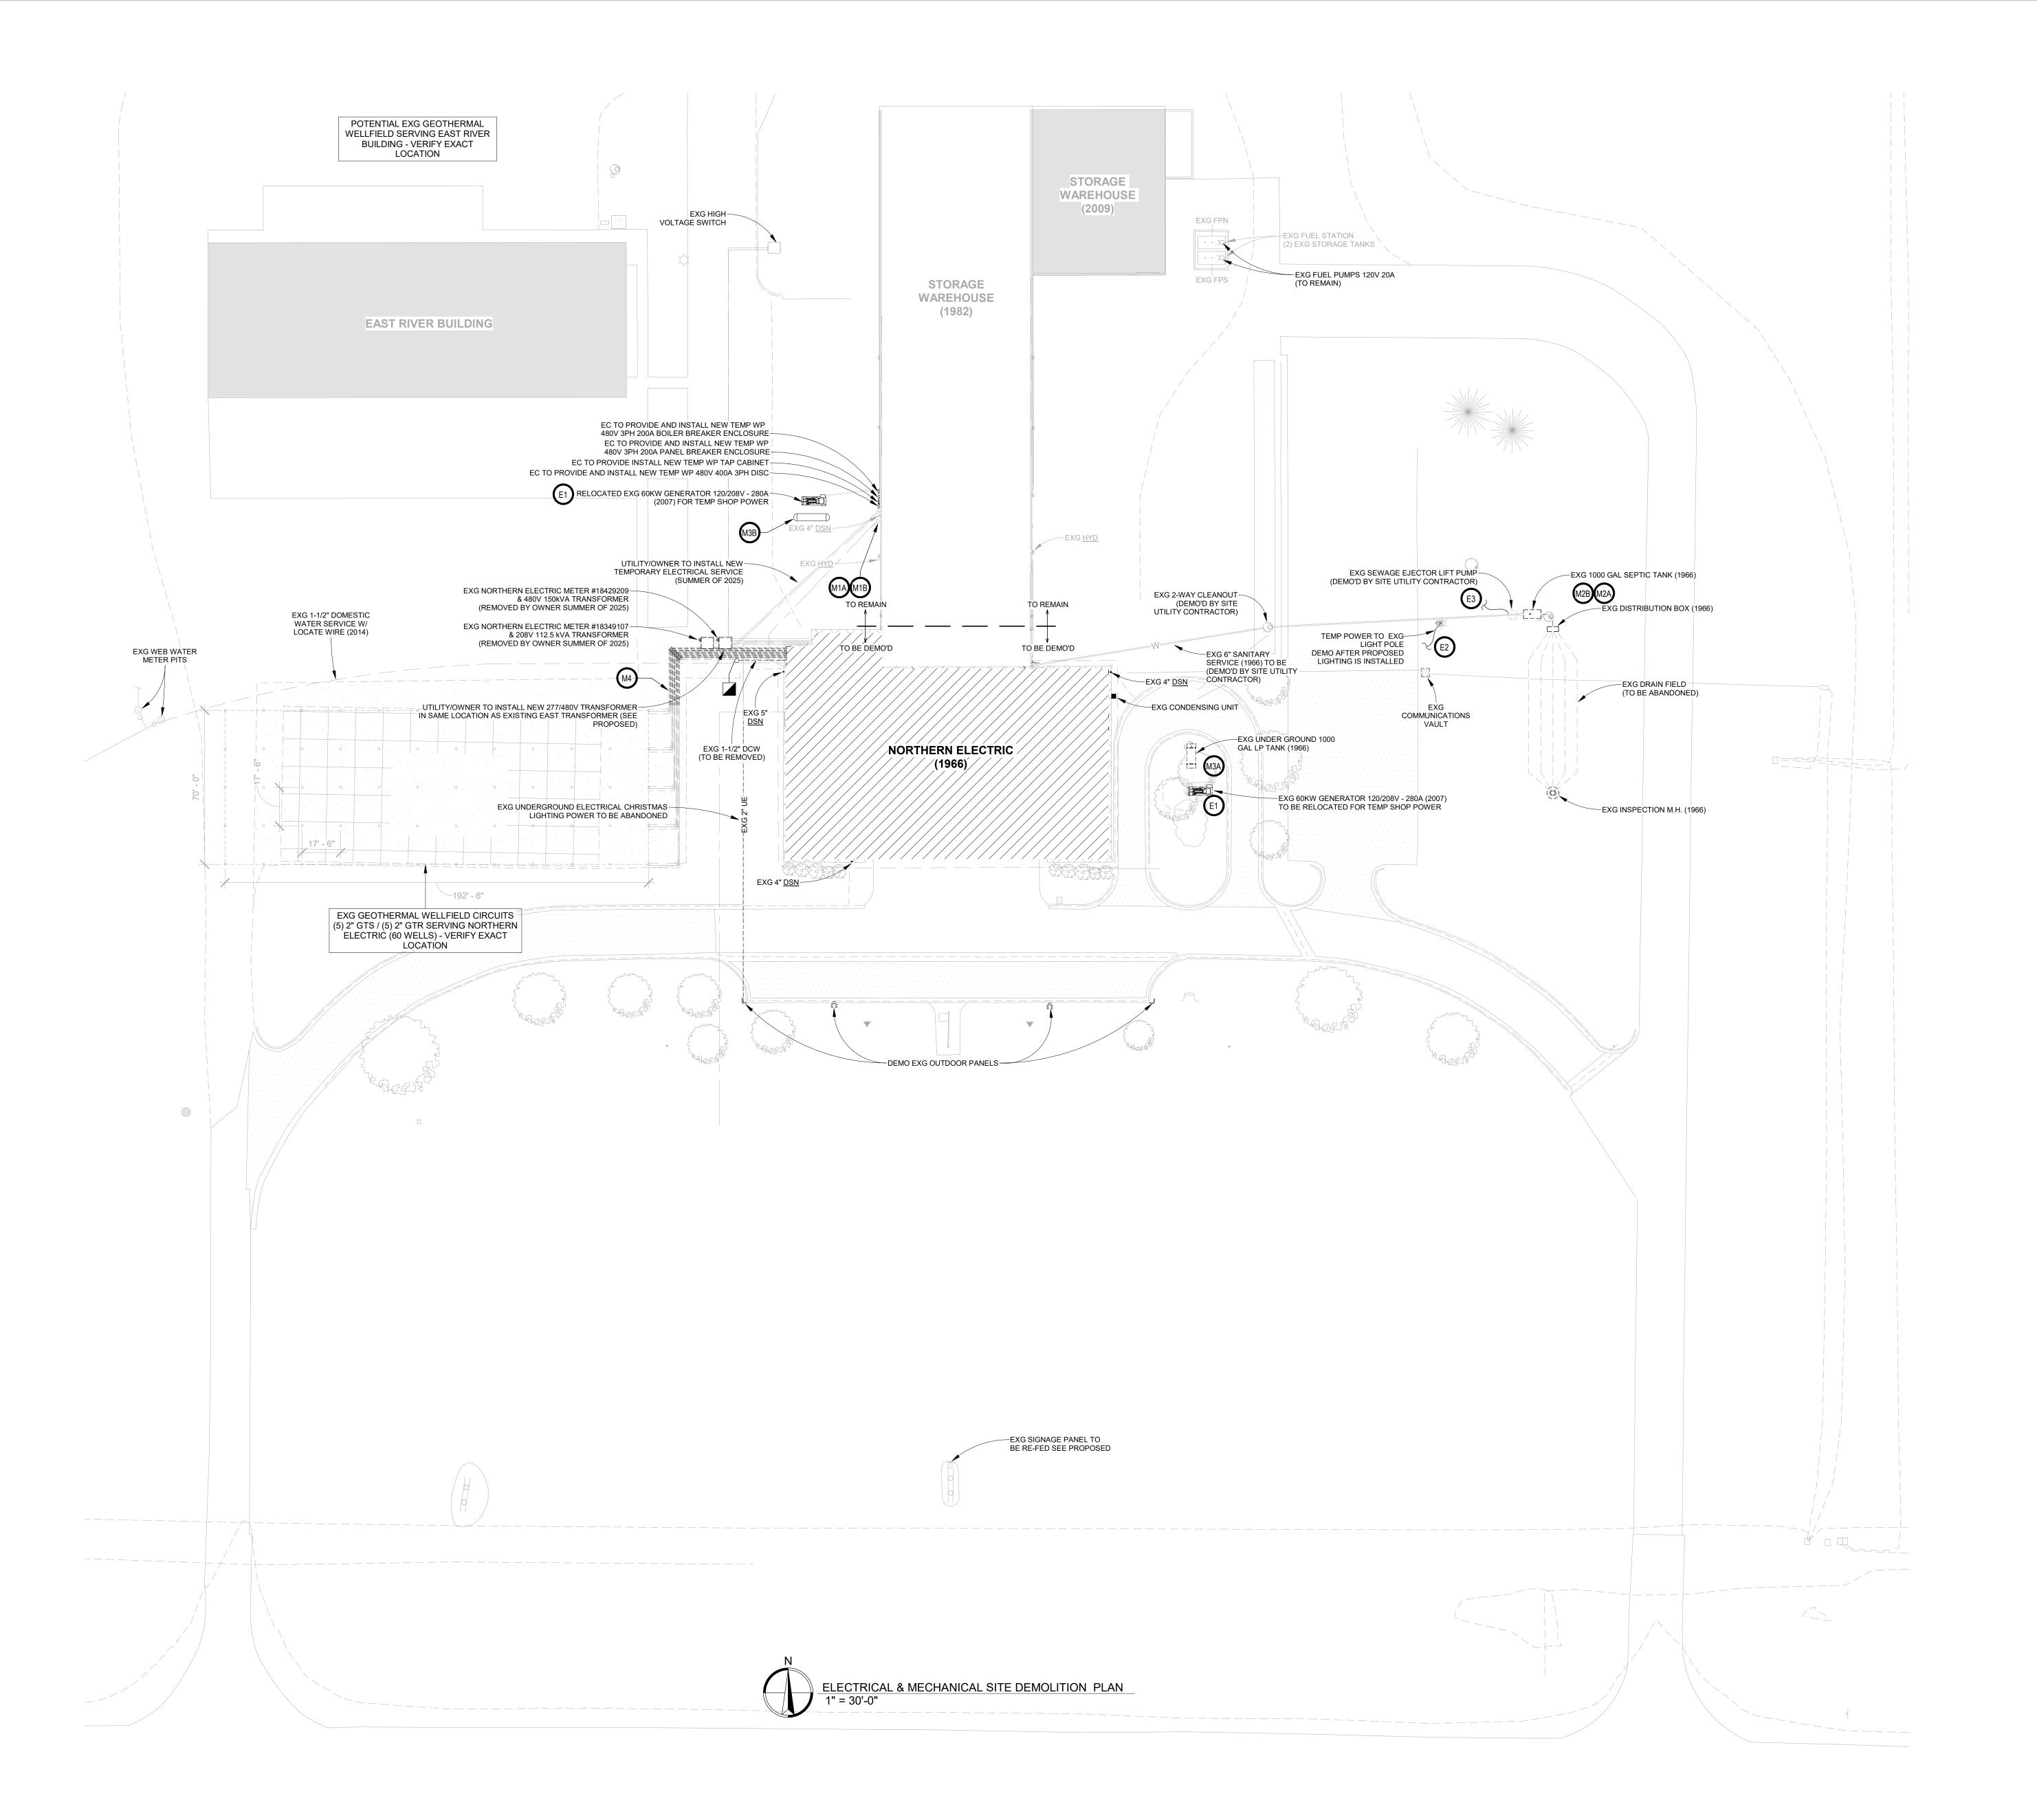
SE PROJECT NO: 240700836



ISSUE: 5/15/2025 100% CONSTRUCTION DOCUMENTS REVISION SCHEDULE: REV. # REV. DSC. REV. DATE

PROJECT: NORTHERN ELECTRIC COOPERATIVE ABERDEEN, SOUTH DAKOTA

SHEET TITLE: MOTOR SCHEDULE, LEGEND & SHEET INDEX



- A. CONTRACTOR SHALL VISIT THE SITE AND VERIFY ALL EXISTING CONDITIONS AND DIMENSIONS. NOTIFY THE A/E IMMEDIATELY OF ANY DISCREPANCIES.
- B. ALL TRENCH BACKFILL SHALL BE 95% STANDARD COMPACTION. WHERE EXCAVATION TAKES PLACE, PROVIDE COMPACTION AND RESTORE TO PREVIOUS SURFACING OR AS REQUIRED FOR NEW CONSTRUCTION. SEE SPECIFICATIONS FOR TESTING REQUIREMENTS.
- C. COORDINATE NEW SERVICES WITH LOCAL UTILITIES.



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SPECIAL NOTES

- 1. CLARIFICATION TO THE BIDDING ANY ELECTRIC UTILITY COSTS FROM NORTHERN ELECTRIC WILL BE PAID DIRECTLY BY THE OWNER AND SHALL NOT BE INCLUDED AS PART OF THE
- 2. CIVIL UTILITIES ARE NOT SHOWN. REFER TO CIVIL ENGINEERS PLANS FOR INFORMATION.

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MECHANICAL KEYNOTES

M1A. SEE PROPOSED.

M1B. SUMMER OF 2025 - PLUMBING CONTRACTOR TO CONNECT NEW TEMPORARY 1-1/2" DOMESTIC WATER SERVICE TO EXISTING 1-1/2" DOMESTIC WATER SERVICE FOR SERVICE OF SHOP THROUGH CONSTRUCTION AND ROUTE UP AT EXTERIOR FOUNDATION, SEE ABOVE GRADE PLUMBING PLANS FOR CONTINUATION. TEMPORARY INSULATED DOGHOUSE BY GC.

M2A. SEE PROPOSED.

M2B. SUMMER OF 2025 - PLUMBING CONTRACTOR TO DEMO EXISTING SEPTIC TANK, DISTRIBUTOR BOX & DRAIN FIELD INSPECTION MANHOLE AS PER DANR REQUIREMENTS. EXISTING DRAIN FIELD TO BE ABANDONED IN PLACE. EXISTING SANITARY SEWER PIPING & LIFT PUMP TO BE DEMO'D BY SITE UTILITY CONTRACTOR.


M3A. SUMMER OF 2025 - PLUMBING CONTRACTOR TO DISCONNECT EXG 1000 GAL UNDERGROUND PROPANE TANK SERVING GENERATOR, EXCAVATE & BACKFILL WITHIN 12" OF FINISHED GRADE. FINAL SITE WORK BY OTHERS.

M3B. SUMMER OF 2025 - OWNER'S PROPANE SUPPLIER TO PROVIDE & INSTALL TEMPORARY 1000 GALLON PROPANE TANK & PIPE TO TEMPORARILY RELOCATED GENERATOR (TEMPORARY PROPANE TANK & PIPE SHOWN FOR REFERENCE ONLY - NO WORK BY PC).

M4. GEOTHERMAL WELLFIELD CONTRACTOR TO DEMO EXISTING 2" GEOTHERMAL WELLFIELD CIRCUITS FROM EXISTING BUILDING TO THIS APPROXIMATE LOCATION. WELLFIELD CONTRACTOR TO PURGE ALL EXISTING GLYCOL FROM WELLFIELD, AND CAP ALL EXISTING CIRCUITS FOR DEMO PHASE. TEMPORARILY BURRY EXISTING CAPPED CIRCUITS BELOW GRADE AT THIS LOCATION, RECORD LOCATION, AND PROTECT DURING CONSTRUCTION.



SE PROJECT NO: 240700836

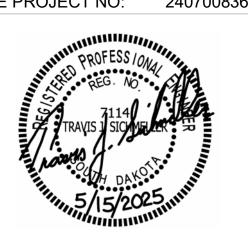

ELECTRICAL KEYNOTES

E1. ELECTRICAL CONTRACTOR TO DISCONNECT EXISTING GENERATOR, AND EXG TRANSFER SWITCHES. SALVAGE EQUIPMENT AND RETURN TO OWNER. GENERATOR TO BE TEMPORARILY RELOCATED TO SERVE EXG SHOP DURING CONSTRUCTION. REWORK CONDUIT AND CONDUCTORS AS REQUIRED TO SUPPLY EXG PANEL 120-N-1 WITH TEMPORARY RELOCATED EXG ATS.

E2. ELECTRICAL CONTRACTOR TO PROVIDE TEMPORARY POWER TO SERVE EXG LIGHT POLES AND EXG SITE LIGHTING. E3. ELECTRICAL CONTRACTOR TO PROVIDE AND INSTALL TEMPORARY FEED FOR EXG LIFT STATION ELECTRICAL 30A/1P FEED FROM EXG SHOP MEZZ PANEL 120-N-1 TO EXG LIFT STATION. EC TO LOCATE AND VERIFY EXISTING CIRCUITRY TO PROVIDE AND INSTALL NEW TEMPORARY FEED. COORDINATE WITH PC.


ISSUE: 5/15/2025 100% CONSTRUCTION DOCUMENTS REVISION SCHEDULE: REV. # REV. DSC. REV. DATE

PROJECT: NORTHERN ELECTRIC COOPERATIVE ABERDEEN, SOUTH DAKOTA

SHEET TITLE: ELECTRICAL & MECHANICAL

SITE DEMOLITION PLAN

EM101

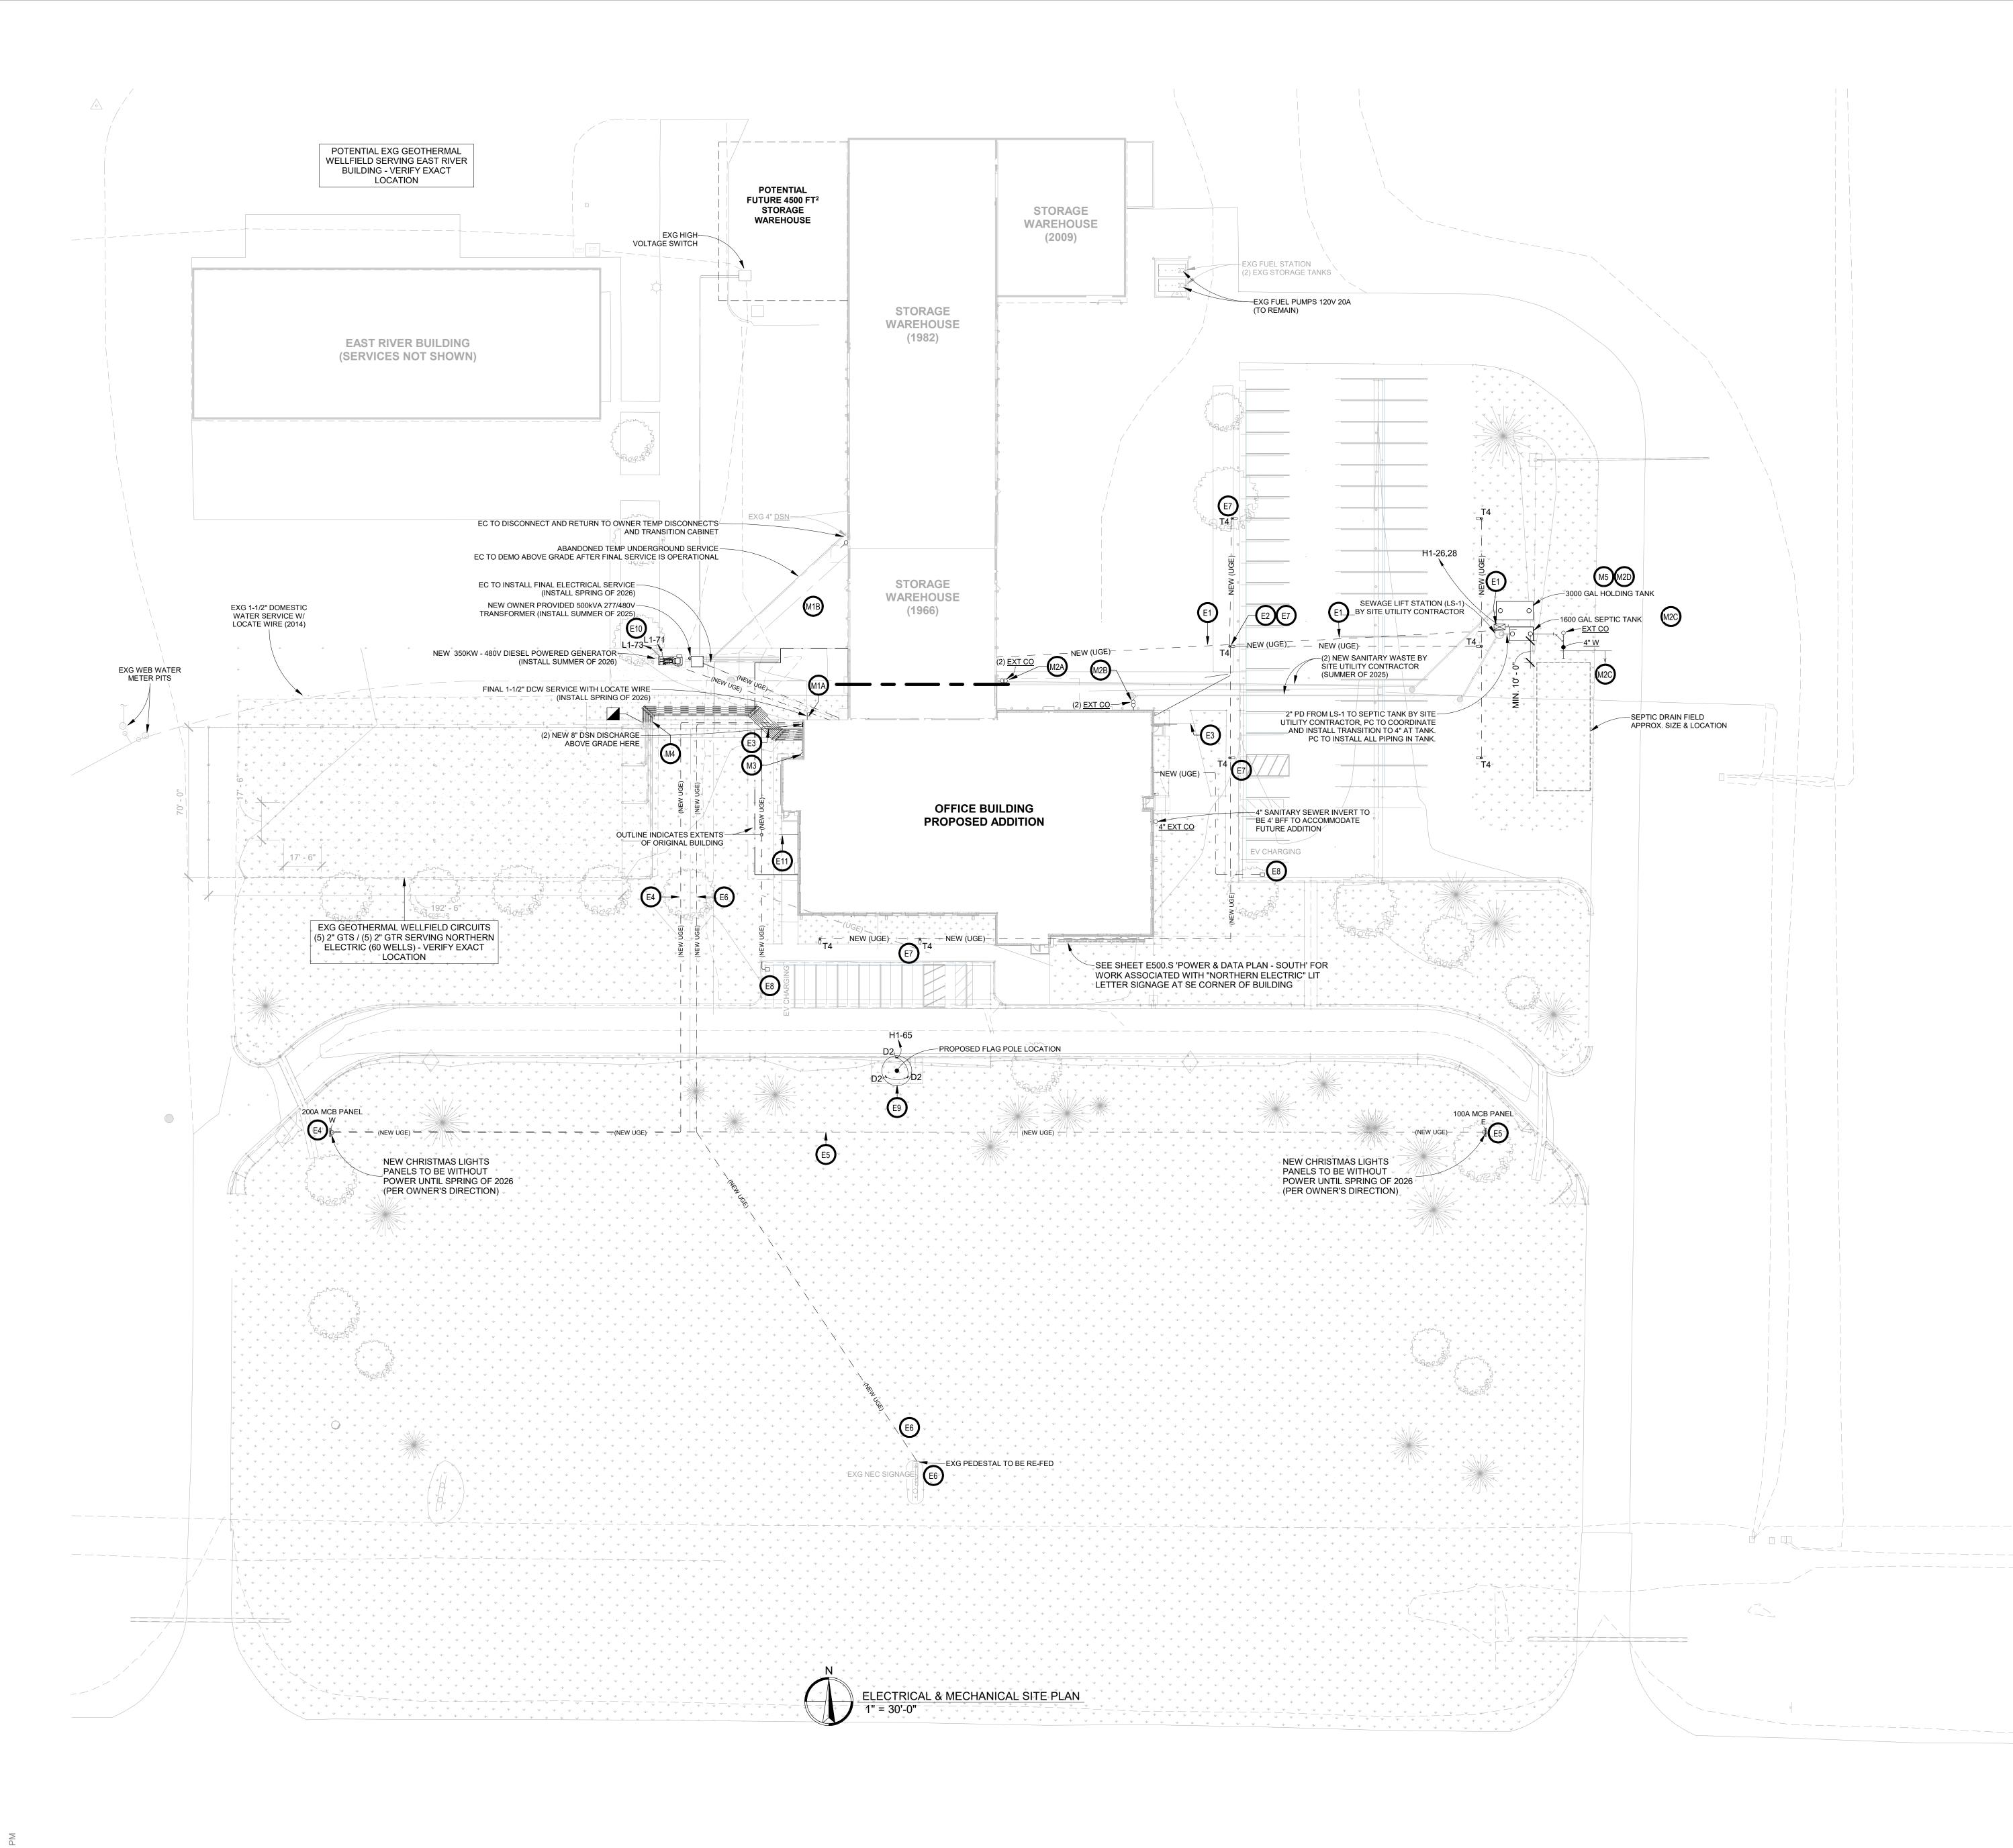

- A. CONTRACTOR SHALL VISIT THE SITE AND VERIFY ALL EXISTING CONDITIONS AND DIMENSIONS. NOTIFY THE A/E IMMEDIATELY OF ANY DISCREPANCIES.
- B. ALL TRENCH BACKFILL SHALL BE 95% STANDARD COMPACTION. WHERE EXCAVATION TAKES PLACE, PROVIDE COMPACTION AND RESTORE TO PREVIOUS SURFACING OR AS REQUIRED FOR NEW CONSTRUCTION. SEE SPECIFICATIONS FOR TESTING REQUIREMENTS.
- C. COORDINATE NEW SERVICES WITH LOCAL UTILITIES.

SPECIAL NOTES

- 1. CLARIFICATION TO THE BIDDING ANY ELECTRIC UTILITY COSTS FROM NORTHERN ELECTRIC WILL BE PAID DIRECTLY BY THE OWNER AND SHALL NOT BE INCLUDED AS PART OF THE CONTRACT.
- 2. CIVIL UTILITIES ARE NOT SHOWN. REFER TO CIVIL ENGINEERS PLANS FOR INFORMATION.

MECHANICAL KEYNOTES

M1A. SUMMER OF 2026 - PLUMBING CONTRACTOR TO CONNECT NEW 1-1/2" DOMESTIC WATER SERVICE TO NEW 1-1/2" DOMESTIC WATER SERVICE INSTALLED BY SITE UTILITY CONTRACTOR AT THIS LOCATION 5' OUTSIDE OF BUILDING. FURNISH AND INSTALL THRUST BLOCKS AND/OR TIE-RODS IN ACCORDANCE WITH THE LOCAL WATER DEPARTMENT STANDARDS AND REGULATIONS. PLUMBING CONTRACTOR SHALL VERIFY EXACT LOCATION, AND INVERT.

M1B. TEMPORARY WATER SERVICE TO BE ABANDONED.

M2A. SUMMER OF 2025 - PLUMBING CONTRACTOR TO CONNECT EXISTING 4" SANITARY SEWER TO NEW 6" SANITARY SEWER INSTALLED BY SITE UTILITY CONTRACTOR AT THIS LOCATION 5' OUTSIDE OF BUILDING, PLUMBING CONTRACTOR TO PROVIDE & INSTALL 4" 2-WAY CLEANOUT AT THIS LOCATION. PC SHALL VERIFY EXACT LOCATION AND INVERT.

M2B. SPRING OF 2026 - PLUMBING CONTRACTOR TO CONNECT NEW 4" SANITARY SEWER TO NEW 6" SANITARY SERVICE INSTALLED BY SITE UTILITY CONTRACTOR AT THIS LOCATION 5' OUTSIDE OF BUILDING, PLUMBING CONTRACTOR TO PROVIDE & INSTALL 4" 2-WAY CLEANOUT AT THIS LOCATION. PLUMBING CONTRACTOR SHALL VERIFY EXACT LOCATION, &

M2C. SPRING OF 2026 - PLUMBING CONTRACTOR TO PROVIDE & INSTALL NEW SEPTIC SYSTEM INCLUDING SEPTIC TANK, ALL PIPING, DRAIN FIELD, AND BACKFILL MATERIALS AS REQUIRED. CONNECT4" PVC FROM SEPTIC TANK TO 2' PUMPED DISCHARGE OF SEWAGE LIFT STATION INSTALLED BY SITE UTILITY CONTRACTOR. PLUMBING CONTRACTOR TO PERFORM PERCOLATION TEST ON SOIL TO DETERMINE EXACT SIZE OF DRAIN FIELD. FOLLOW ALL REQUIREMENTS & GUIDELINES AS REQUIRED BY THE SOUTH DAKOTA DEPARTMENT OF AGRICULTURE & NATURAL RESOURCES. SUBMIT ALL TEST DATA & CALCULATIONS TO THE SD DANR. REFER TO FRONT END BID DOCUMENTS FOR ALLOWANCE FOR DRAIN FIELD.

M2D. SUMMER OF 2025 - PLUMBING CONTRACTOR TO PROVIDE & INSTALL NEW 3000 GAL BELOW GRADE HOLDING TANK FOR SHOP AREA SANITARY WASTE CONNECT TO NEW 6" SANITARY SEWER SERVICE BY SITE UTILITY CONTRACTOR. PLUMBING CONTRACTOR SHALL VERIFY EXACT LOCATION AND

M3. PLUMBING CONTRACTOR TO PROVIDE & INSTALL LAWN IRRIGATION VACUUM BREAKER AT THIS LOCATION, SEE PRESSURE VACUUM BREAKER DETAIL. LAWN IRRIGATION TO BE BY OWNER'S FUTURE LAWN IRRIGATION CONTRACTOR. FUTURE CONTROLLER IN MECHANICAL 141 BY OWNER.

M4. GEOTHERMAL WELLFIELD CONTRACTOR TO EXTEND EXISTING 2" GEOTHERMAL WELLFIELD CIRCUITS INTO NEW MECHANICAL ROOM AND INSTALL AT NEW HEADERS. SEE GROUND-COUPLED HEAT EXCHANGER HEADER DETAIL, AND HEADER SUPPORT & STUB OUT DETAIL. AVOID ROUTING NEAR ELECTRICAL AND DOMESTIC WATER SERVICES AS MUCH AS

M5. TEMPERATURE CONTROLS CONTRACTOR TO PROVIDE & INSTALL FLOAT LEVEL SENSOR IN HOLDING TANK FOR SHOP AND ALARM BAS. INSTALL CONTROL WIRING TO ALLOW FOR FUTURE LIFT STATION (LS-1) MONITORING.

ELECTRICAL KEYNOTES

E1. EC TO PROVIDE AND INSTALL NEW UNDERGROUND ELECTRICAL POWER AND CONDUIT TO FEED NEW LIFT STATION (LS-1). PROVIDE AND INSTALL 1" CONDUIT WITH #6 CU. CONDUCTOR(S) FOR NEW CIRCUIT TO 2HP 480V SINGLE PHASE LIFT STATION. PROVIDE COMBINATION STARTER/DISCONNECT SWITCH AT LIFT STATION. PROVIDE C-CHANNEL MOUNTED TO CONCRETE PAD FOR MOUNDING OF STARTER DISCONNECT.

E2. EC TO PROVIDE AND INSTALL NEW UNDERGROUND ELECTRICAL POWER AND CONDUIT TO FEED NEW PARKING LOT FIXTURES. PROVIDE AND INSTALL 1" CONDUIT WITH #6 CU. CONDUCTOR(S) ROUTED BACK TO TIME CLOCK IN MECH 141 SEE PROPOSED.

E3. EC TO PROVIDE AND INSTALL (2) 2" SPARE CONDUITS AS NOTED ON SITE PLAN. (1) ROUTED TO THE WEST PAST BUILDING CONCRETE. (1) ROUTED TO EAST PAST BUILDING CONCRETE. COORDINATE EXACT LOCATION WITH OWNER. E4. EC TO PROVIDE AND INSTALL (2) 1/2" CONDUIT AND 250 MCM. CU. CONDUCTORS FOR NEW EXTERIOR PANEL W FED FROM

OWNER. SEE PROPOSED E5. EC TO PROVIDE AND INSTALL 1 1/2" CONDUIT AND 1/0 CONDUCTORS FOR NEW EXTERIOR PANEL E FED FROM TRANSFORMER 3. COORDINATE LOCATION OF PANEL E WITH OWNER. SEE PROPOSED

TRANSFORMER 3. COORDINATE LOCATION OF PANEL W WITH

E6. EC TO PROVIDE AND INSTALL 1 1/4" CONDUIT AND #6 CONDUCTORS TO RE-FEED EXG SIGNAGE FEED FROM PANEL H1 WITH (1) 20A 1 POLE BREAKER TO RE-SUPPLY EXG SIGNAGE. PROVIDE AND INSTALL (1) 30A TRANSFORMER TO STEP DOWN FROM 277/120V TO RE-SUPPLY EXG SIGNAGE PEDESTAL PANEL.

E7. EC TO PROVIDE AND INSTALL WP GFCI DUPLEX RECEPTACLE AT THE BASE OF EACH T4 LIGHTING FIXTURE AT LOCATIONS WHERE NOTED. COORDINATE WITH OWNER. SEE PANEL SCHEDULE FOR CIRCUITS.

E8. EC TO PROVIDE AND INSTALL 1-1/4 CONDUIT(S) ROUTED BY ELECTRICAL PANELS IN TO MECH ROOM 141, PROVISIONS FOR FUTURE EV CHARGING STATION FOR SOUTH & EAST PARKING. COORDINATE LOCATION WITH OWNER. E9. EC TO PROVIDE AND INSTALL 1" CONDUIT AND #10

CONDUCTORS TO POWER (3) D2 FIXTURES. INSTALL 6' AWAY FROM FLAG POLE BASE SPACED EVENLY 120 DEGREES APART. E10. EC TO PROVIDE AND INSTALL (2) 120V CIRCUIT(S) FOR GENERATOR BLOCK HEATER AND BATTERY CHARGER. SEE

PANEL SCHEDULES. E11. PROVIDE AND INSTALL (1) 2" CONDUIT FROM SERVER 126 STUBBED OUTSIDE WEST SIDE OF BUILDING PAST NEW SIDEWALK PLUGGED & CAPPED FOR FUTURE. COORDINATE EXACT PLACEMENT WITH OWNER.

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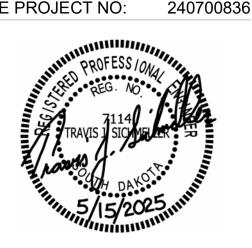
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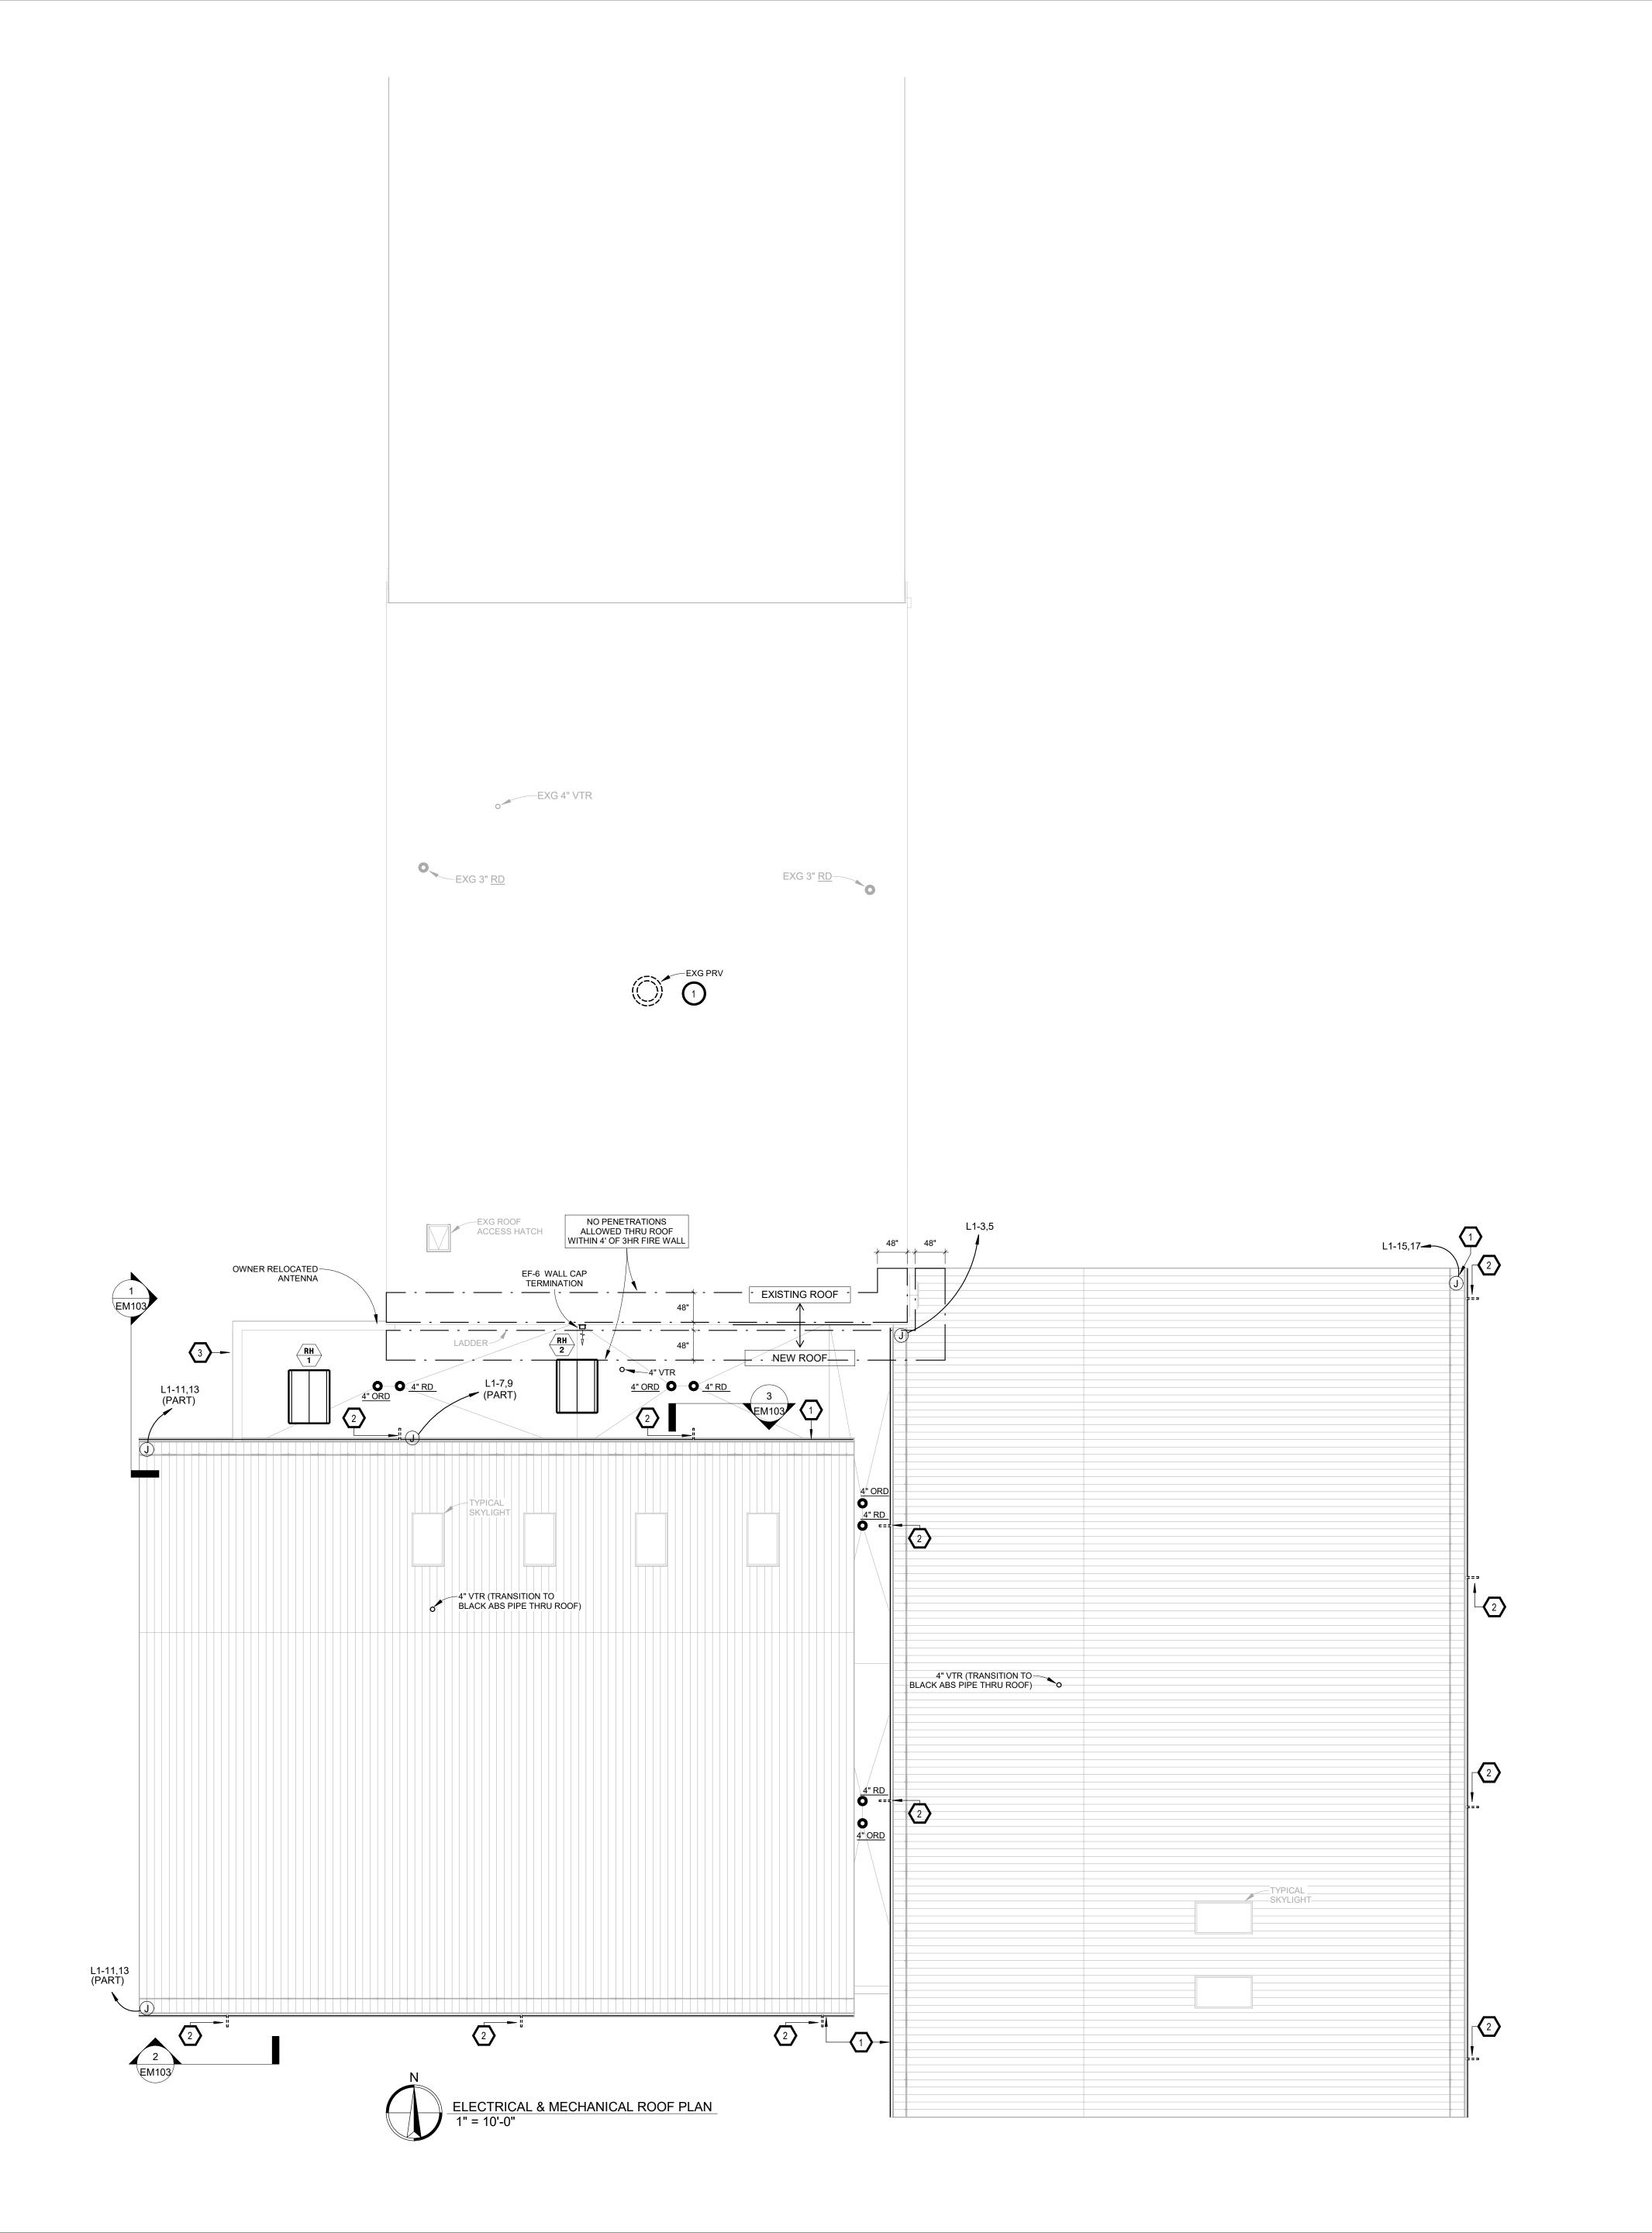
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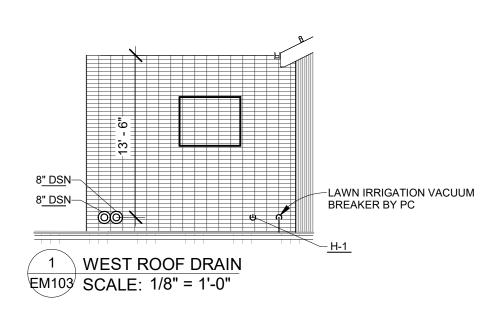
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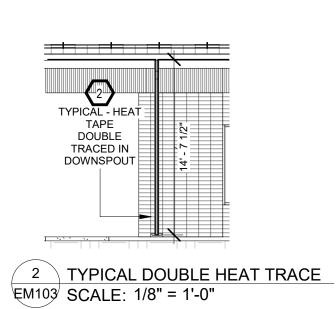
SHEET TITLE **ELECTRICAL & MECHANICAL**

SITE PLAN


EM102







 A. FRESH AIR INTAKES TO BE MINIMUM 10' FROM ANY EXHAUST TERMINATION.

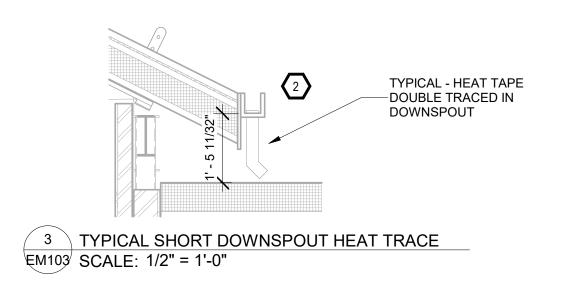

MECHANICAL KEYNOTES:

 VC TO DISCONNECT & REMOVE EXG PRV. VC TO PROVIDE & INSTALL INSULATED WEATHER-TIGHT CAP ON EXISTING CURB.



SE PROJECT NO: 240700836

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ELECTRICAL KEYNOTES:

- 1. TYPICAL PROVIDE SELF-REGULATING HEAT TAPE IN GUTTERS, DOWNSPOUTS AND ROOF DRAINS AS SHOWN ON THE PLANS. HEAT TAPE SHALL BE EQUAL TO CHROMALX NO. CPR-8-2-CR, 8 WATT PER LINEAR FOOT CAPACITY. PROVIDE A COMPLETE AND FUNCTIONING SYSTEM INCLUDING BUT NOT LIMITED TO THE FOLLOWING PARTS: CONTROL PANEL CHROMALOX NO. CHROMA-RG-OD, ARIEL SENSOR NO. CS-AS WITH BRACKET NO. CS-MB, GUTTER SENSOR NO. CS-GS AND POWER CONNECTION KITS AS REQUIRED.
- 2. GUTTER DOWNSPOUT LOCATION INSTALL DOUBLE TRACE HEAT TAPE IN DOWN SPOUT FOR CONTINUOUS RUN OF HEAT TAPE. PROVIDE ADDITIONAL HEAT TAPE LENGTH FOR DOWNSPOUT KICKOUT. SEE ELEVATIONS FOR APPROXIMATE HEIGHTS.
- TYPICAL HEAT TAPE ROOF DRAIN INSTALL 50' OF HEAT TAPE FROM JUNCTION BOX INTO ROOF DRAIN DOWN TO LAMBS TONGUE. FIELD VERIFY.

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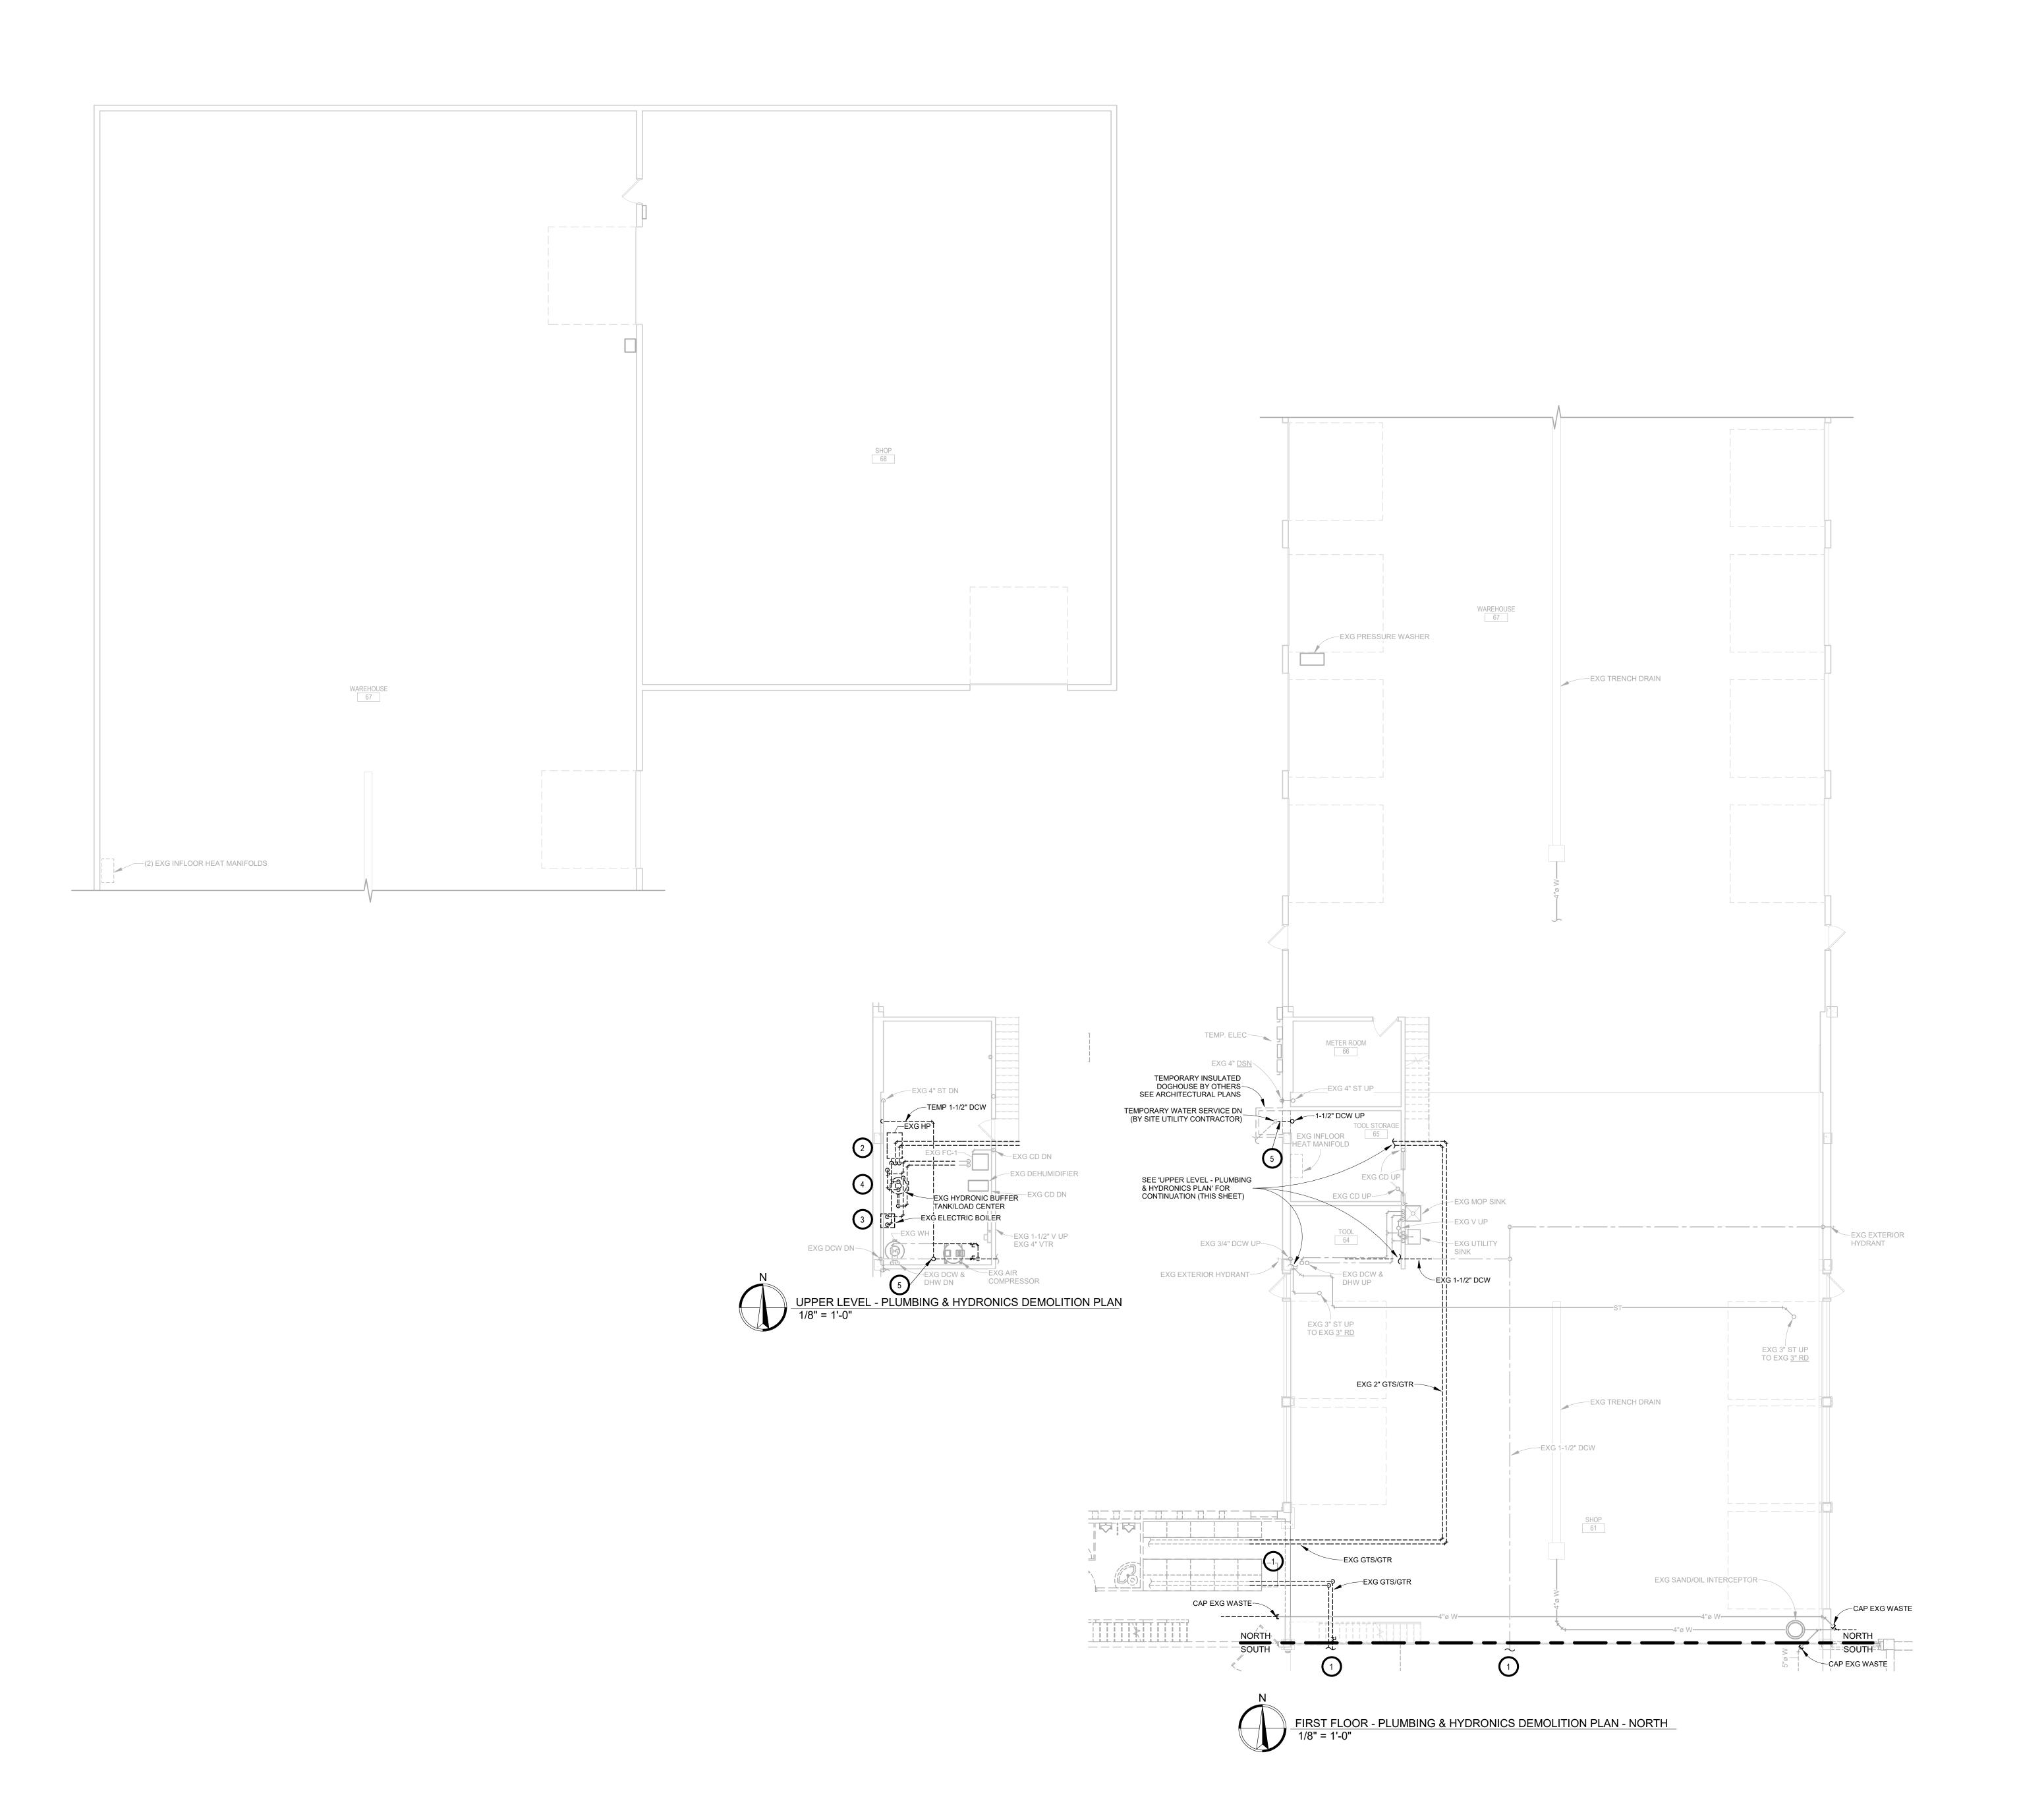
PROJECT:

NORTHERN ELECTRIC
COOPERATIVE

ABERDEEN, SOUTH DAKOTA

SHEET TITLE: ELECTRICAL & MECHANICAL ROOF PLAN

EM103



- A. CONTRACTOR SHALL VISIT THE SITE AND VERIFY ALL EXISTING CONDITIONS AND DIMENSIONS. NOTIFY THE ENGINEER IMMEDIATELY OF ANY DISCREPANCIES, INCLUDING ANY NECESSARY DEMOLITION.
- B. REMOVE MECHANICAL EQUIPMENT IN THE AREAS SHOWN ON THE PLAN, DISCONNECT SERVICES AND REMOVE TO A POINT OUT OF THE WAY OF THE GENERAL DEMOLITION. MARK ON THE PLAN TO CLEARLY SHOW WHERE THESE SERVICES ARE STOPPED. DEMOLITION WORK SHALL BE COORDINATED WITH THE OWNER. SHOULD QUESTIONS ARISE REGARDING THE REMOVAL OF EQUIPMENT, CONFER WITH THE OWNER BEFORE SUCH EQUIPMENT IS DEMOLISHED. MATERIALS REMOVED BY DEMOLITION SHALL REMAIN THE PROPERTY OF THE OWNER UNLESS OTHERWISE SPECIFICALLY NOTED. MATERIAL THE OWNER DOES NOT WISH TO RETAIN SHALL BE REMOVED AND DISPOSED OF PROPERLY BY THE CONTRACTOR.
- C. EQUIPMENT SHOWN ON DRAWINGS AS EXISTING IS BASED ON EXISTING PLANS AND LIMITED FIELD INVESTIGATION. THE FIELD SURVEY WAS CONDUCTED TO VERIFY, AS MUCH AS POSSIBLE, THE ACCURACY OF THE LOCATIONS SHOWN. THE CONTRACTOR SHALL VERIFY THE ACCURACY OF THE "EXISTING CONDITIONS" AS SHOWN ON THE DRAWINGS AS THE DEMOLITION WORK PROGRESSES. PERFORM MODIFICATIONS AND ADDITIONS AS NECESSARY TO CORRECT FOR THESE HIDDEN CONDITIONS AND ALLOW FOR THE COMPLETION OF THE
- D. THE EXISTING BUILDING WILL BE IN USE DURING THIS CONSTRUCTION. SCHEDULE AND CARRY OUT THE WORK IN SUCH A MANNER AS TO CAUSE THE OWNER A MINIMUM OF INCONVENIENCE DUE TO SERVICE INTERRUPTIONS. TEMPORARY SERVICES SHALL BE INSTALLED IF ONE PHASE OF CONSTRUCTION DISRUPTS SERVICE TO ANOTHER AREA OF THE BUILDING OR IF EQUIPMENT HAS TO BE RELOCATED TO ALLOW CONSTRUCTION TO PROGRESS. SERVICE INTERRUPTIONS SHALL BE CONFINED TO THE SMALLEST AREA POSSIBLE AT ANY ONE TIME AND INTERRUPTIONS SHALL BE SCHEDULED WITH THE OWNER'S SITE REPRESENTATIVE. AFTER SERVICE HAS BEEN RESTORED FOLLOWING AN INTERRUPTION, INSPECT AREAS AFFECTED BY THE INTERRUPTION AND BE RESPONSIBLE FOR RETURNING AUTOMATICALLY CONTROLLED EQUIPMENT TO THE SAME OPERATING CONDITION, WHICH EXISTED PRIOR TO THE INTERRUPTION.
- E. PROVIDE PENETRATIONS TO THE BUILDING STRUCTURE AS REQUIRED FOR INSTALLATION. WHERE EXISTING OR TEMPORARY SYSTEMS ARE BEING DEMOLISHED, WHICH LEAVE OPENINGS IN THE EXISTING BUILDING STRUCTURE, THE BUILDING STRUCTURE SHALL BE PATCHED TO MATCH THE EXISTING CONSTRUCTION AND MAINTAIN THE EXISTING BUILDING FIRE RATINGS. ALL PENETRATIONS THROUGH DRAFT STOPS AND OTHER FIRE-RATED PARTITIONS SHALL BE FIRE STOPPED AS PER SPECIFICATIONS AND LOCAL CODES.

O KEYNOTES

- 1. PC TO DISCONNECT AND REMOVE PORTION OF ANY EXISTING PIPING THRU EXISTING WALL OR FOUNDATION THAT REMAINS TO A POINT TO ALLOW FOR DEMOLITION OF EXISTING BUILDING.
- 2. PC TO DISCONNECT AND REMOVE EXISTING HP AND ASSOCIATED PIPING SHOWN DARK AND DASHED. SALVAGE HP FOR OWNER.
- 3. PC TO DISCONNECT AND REMOVE EXISTING BOILER AND ASSOCIATED PIPING SHOWN DARK AND DASHED. SALVAGE BOILER
- 4. SUMMER 2026 PC TO DISCONNECT AND REMOVE EXISTING HYDRONIC BUFFER TANK AND ASSOCIATED PUMPS AND PIPING SHOWN DARK AND DASHED. SALVAGE BUFFER TANK FOR OWNER.
- 5. SUMMER 2025 PC TO PROVIDE & INSTALL 1-1/2" DCW PIPING TO REFEED SHOP DOMESTIC WATER PIPING DURING CONSTRUCTION. CONNECT TO TEMPORARY RISER BY SITE UTILITY CONTRACTOR IN TEMPORARY DOG HOUSE. ROUTE TO EXISTING DOMESTIC PIPING WHERE SHOWN. AFTER CONSTRUCTION IS COMPLETE, DEMO TEMPORARY PIPING AND CAP AT EXISTING PIPING CONNECTION. SEE PROPOSED.

W-D-E

<u>KEYPLAN</u>



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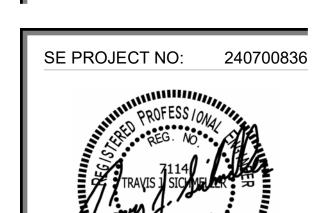
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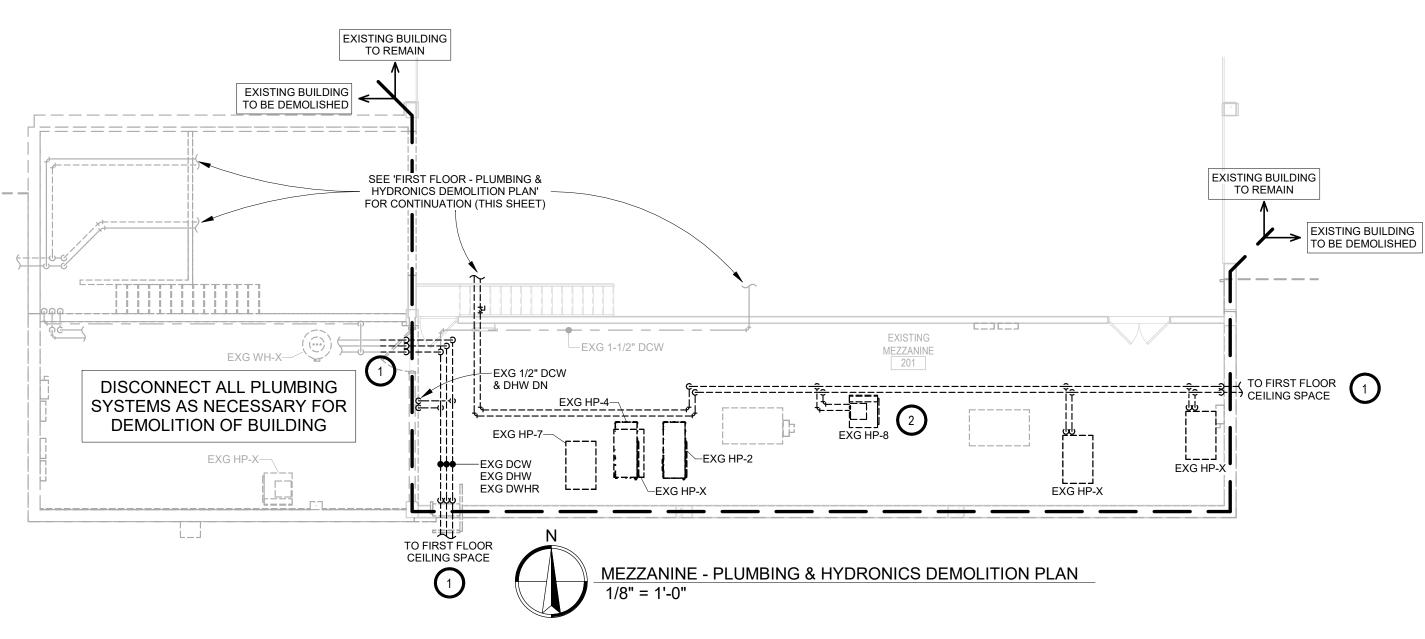
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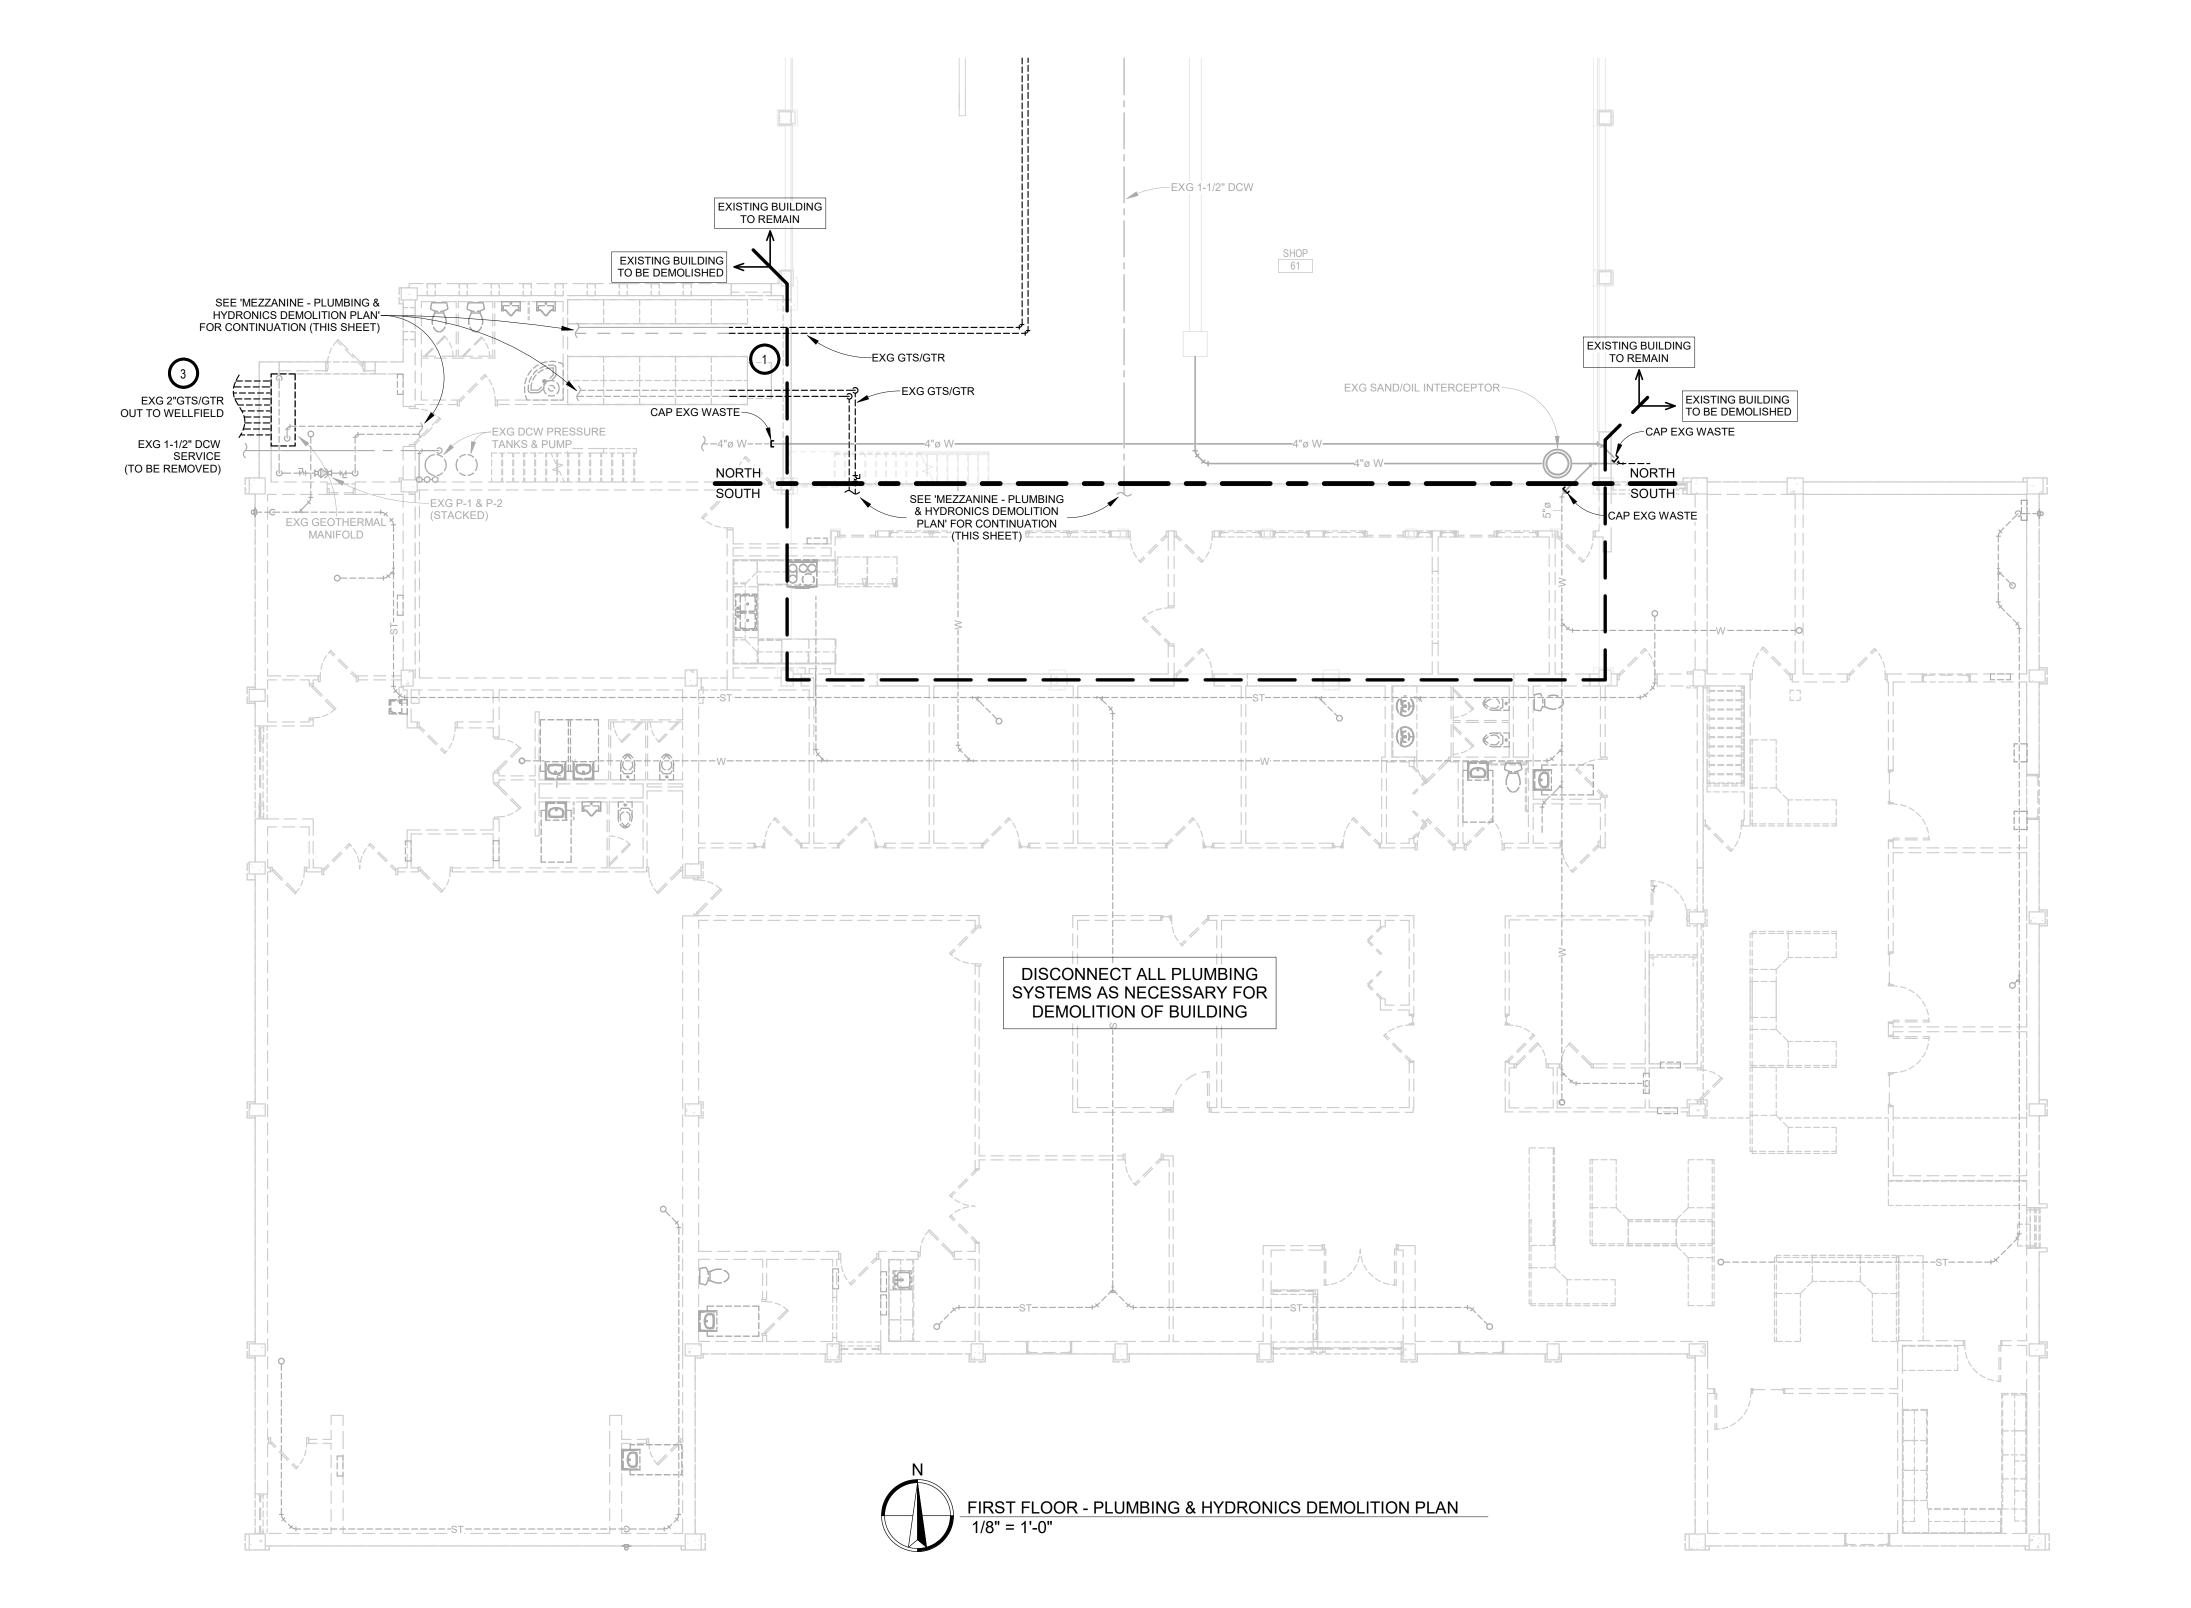



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PROJECT: NORTHERN ELECTRIC COOPERATIVE ABERDEEN, SOUTH DAKOTA

SHEET TITLE: PLUMBING & HYDRONICS DEMOLITION PLAN - NORTH





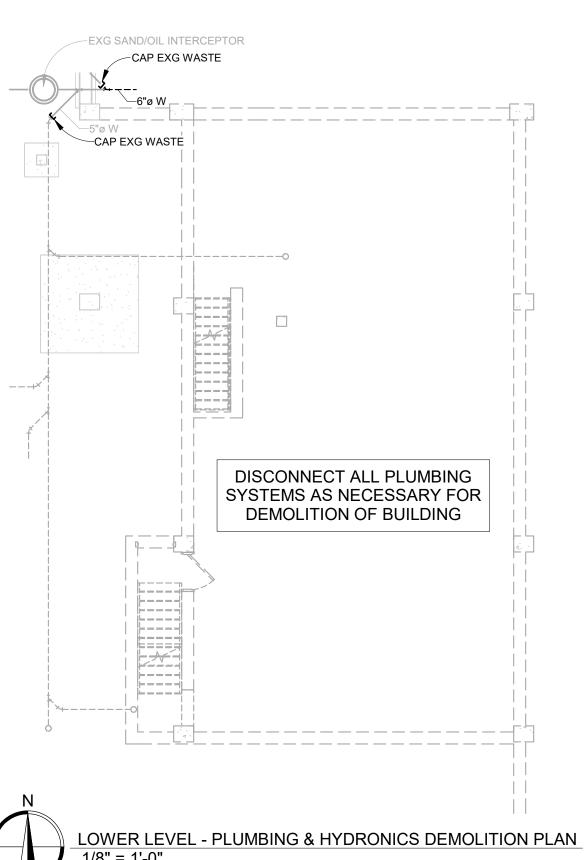

- A. CONTRACTOR SHALL VISIT THE SITE AND VERIFY ALL EXISTING CONDITIONS AND DIMENSIONS. NOTIFY THE ENGINEER IMMEDIATELY OF ANY DISCREPANCIES, INCLUDING ANY NECESSARY DEMOLITION.
- B. REMOVE MECHANICAL EQUIPMENT IN THE AREAS SHOWN ON THE PLAN, DISCONNECT SERVICES AND REMOVE TO A POINT OUT OF THE WAY OF THE GENERAL DEMOLITION. MARK ON THE PLAN TO CLEARLY SHOW WHERE THESE SERVICES ARE STOPPED. DEMOLITION WORK SHALL BE COORDINATED WITH THE OWNER. SHOULD QUESTIONS ARISE REGARDING THE REMOVAL OF EQUIPMENT, CONFER WITH THE OWNER BEFORE SUCH EQUIPMENT IS DEMOLISHED. MATERIALS REMOVED BY DEMOLITION SHALL REMAIN THE PROPERTY OF THE OWNER UNLESS OTHERWISE SPECIFICALLY NOTED. MATERIAL THE OWNER DOES NOT WISH TO RETAIN SHALL BE REMOVED AND DISPOSED OF PROPERLY BY THE CONTRACTOR.
- C. EQUIPMENT SHOWN ON DRAWINGS AS EXISTING IS BASED ON EXISTING PLANS AND LIMITED FIELD INVESTIGATION. THE FIELD SURVEY WAS CONDUCTED TO VERIFY, AS MUCH AS POSSIBLE, THE ACCURACY OF THE LOCATIONS SHOWN. THE CONTRACTOR SHALL VERIFY THE ACCURACY OF THE "EXISTING CONDITIONS" AS SHOWN ON THE DRAWINGS AS THE DEMOLITION WORK PROGRESSES. PERFORM MODIFICATIONS AND ADDITIONS AS NECESSARY TO CORRECT FOR THESE HIDDEN CONDITIONS AND ALLOW FOR THE COMPLETION OF THE
- D. THE EXISTING BUILDING WILL BE IN USE DURING THIS CONSTRUCTION. SCHEDULE AND CARRY OUT THE WORK IN SUCH A MANNER AS TO CAUSE THE OWNER A MINIMUM OF INCONVENIENCE DUE TO SERVICE INTERRUPTIONS, TEMPORARY SERVICES SHALL BE INSTALLED IF ONE PHASE OF CONSTRUCTION DISRUPTS SERVICE TO ANOTHER AREA OF THE BUILDING OR IF EQUIPMENT HAS TO BE RELOCATED TO ALLOW CONSTRUCTION TO PROGRESS. SERVICE INTERRUPTIONS SHALL BE CONFINED TO THE SMALLEST AREA POSSIBLE AT ANY ONE TIME AND INTERRUPTIONS SHALL BE SCHEDULED WITH THE OWNER'S SITE REPRESENTATIVE. AFTER SERVICE HAS BEEN RESTORED FOLLOWING AN INTERRUPTION, INSPECT AREAS AFFECTED BY THE INTERRUPTION AND BE RESPONSIBLE FOR RETURNING AUTOMATICALLY CONTROLLED EQUIPMENT TO THE SAME OPERATING CONDITION, WHICH EXISTED PRIOR TO THE INTERRUPTION.
- E. PROVIDE PENETRATIONS TO THE BUILDING STRUCTURE AS REQUIRED FOR INSTALLATION. WHERE EXISTING OR TEMPORARY SYSTEMS ARE BEING DEMOLISHED, WHICH LEAVE OPENINGS IN THE EXISTING BUILDING STRUCTURE, THE BUILDING STRUCTURE SHALL BE PATCHED TO MATCH THE EXISTING CONSTRUCTION AND MAINTAIN THE EXISTING BUILDING FIRE RATINGS. ALL PENETRATIONS THROUGH DRAFT STOPS AND OTHER FIRE-RATED PARTITIONS SHALL BE FIRE STOPPED AS PER SPECIFICATIONS AND LOCAL CODES.

O KEYNOTES

- 1. PC TO DISCONNECT AND REMOVE PORTION OF ANY EXISTING PIPING THRU EXISTING WALL OR FOUNDATION THAT REMAINS TO A POINT TO ALLOW FOR DEMOLITION OF EXISTING BUILDING.
- 2. TYPICAL PC TO DISCONNECT EXISTING HEAT PUMP AND ASSOCIATED PIPING SHOWN DARK AND DASHED & ASSOCIATED CONDENSATE PIPING (CONDENSATE PIPING NOT SHOWN).
- 3. GEOTHERMAL WELLFIELD CONTRACTOR TO DISCONNECT EXISTING GEOTHERMAL HEADERS FOR BUILDING DEMOLITION. SEE ELECTRICAL & MECHANICAL SITE DEMOLITION PLAN.



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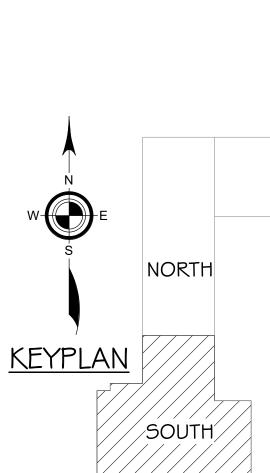
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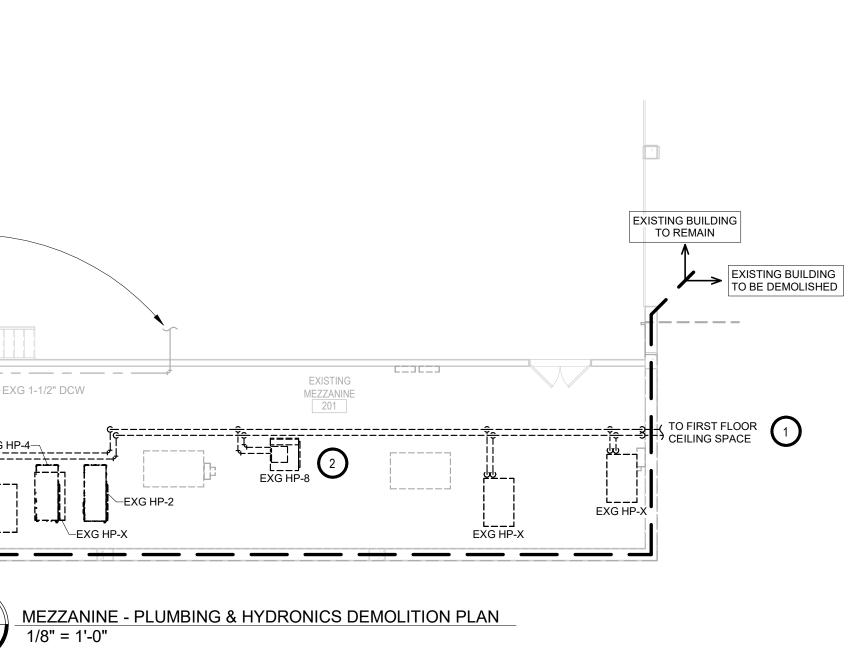
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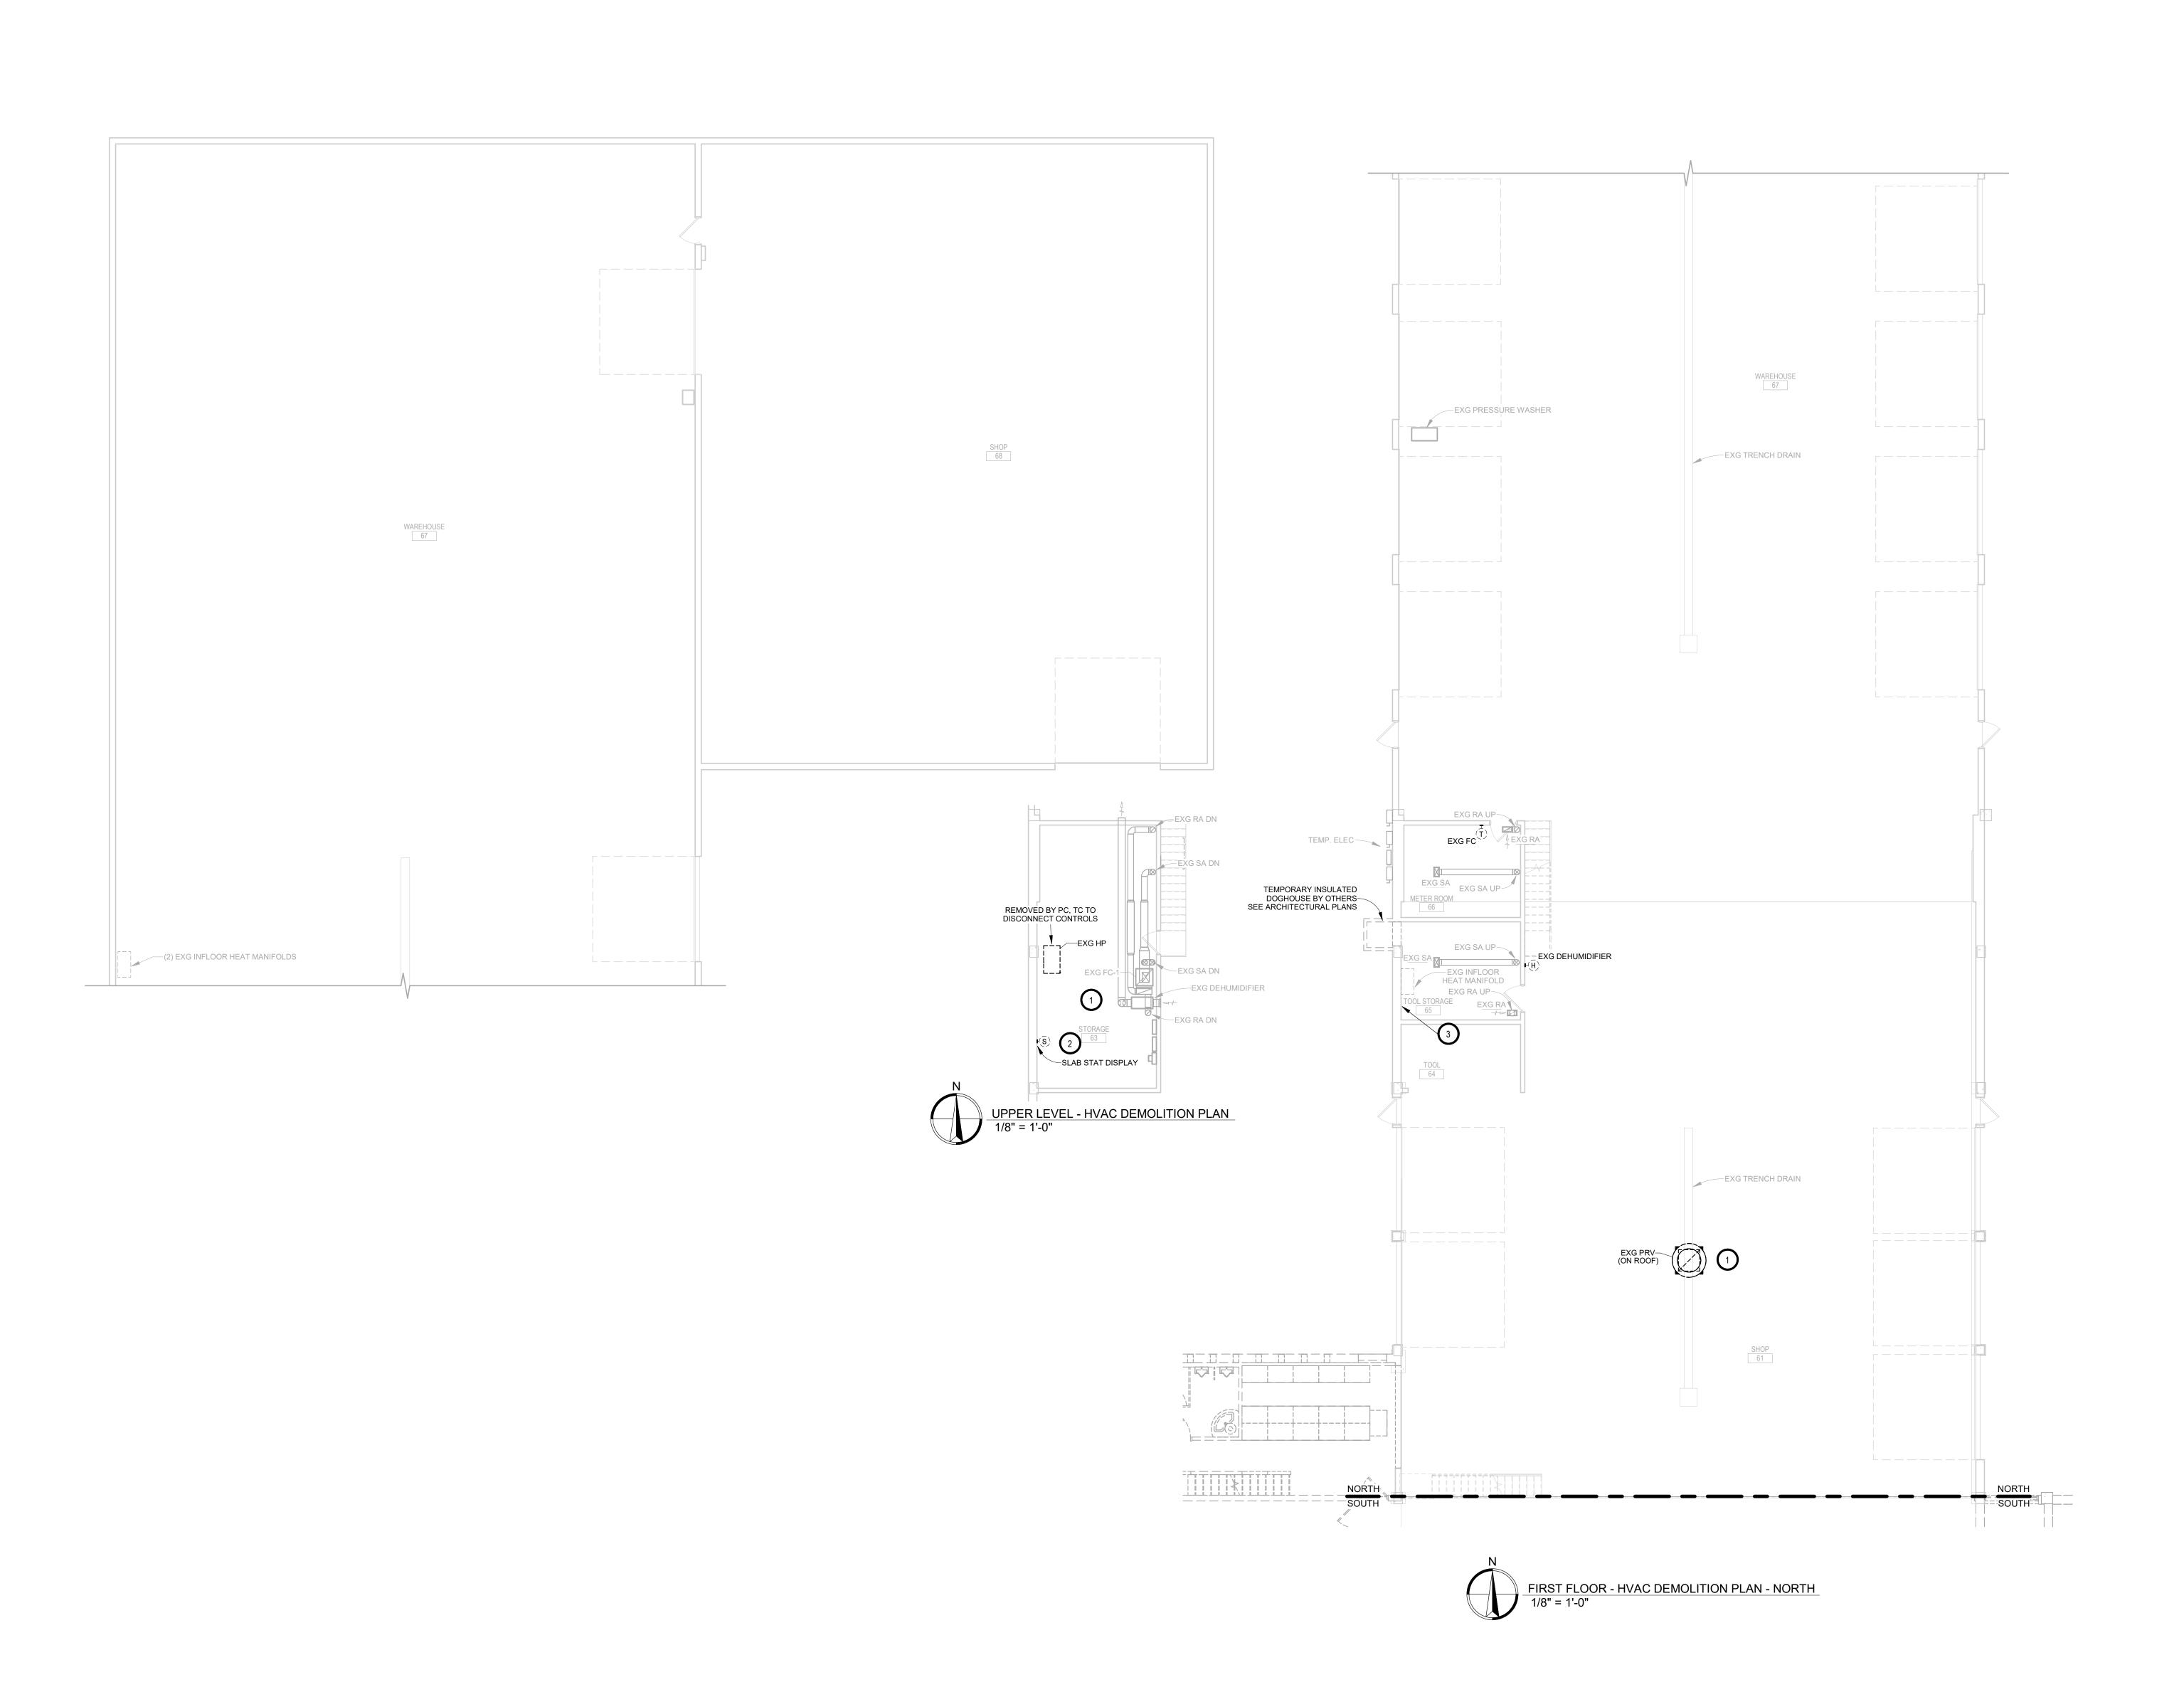
PROJECT: NORTHERN ELECTRIC COOPERATIVE ABERDEEN, SOUTH DAKOTA

SHEET TITLE PLUMBING & HYDRONICS DEMOLITION PLAN - SOUTH

M200.S







- A. CONTRACTOR SHALL VISIT THE SITE AND VERIFY ALL EXISTING CONDITIONS AND DIMENSIONS. NOTIFY THE ENGINEER IMMEDIATELY OF ANY DISCREPANCIES, INCLUDING ANY NECESSARY DEMOLITION.
- B. REMOVE MECHANICAL EQUIPMENT IN THE AREAS SHOWN ON THE PLAN, DISCONNECT SERVICES AND REMOVE TO A POINT OUT OF THE WAY OF THE GENERAL DEMOLITION. MARK ON THE PLAN TO CLEARLY SHOW WHERE THESE SERVICES ARE STOPPED. DEMOLITION WORK SHALL BE COORDINATED WITH THE OWNER. SHOULD QUESTIONS ARISE REGARDING THE REMOVAL OF EQUIPMENT, CONFER WITH THE OWNER BEFORE SUCH EQUIPMENT IS DEMOLISHED. MATERIALS REMOVED BY DEMOLITION SHALL REMAIN THE PROPERTY OF THE OWNER UNLESS OTHERWISE SPECIFICALLY NOTED. MATERIAL THE OWNER DOES NOT WISH TO RETAIN SHALL BE REMOVED AND DISPOSED OF PROPERLY BY THE CONTRACTOR.
- C. EQUIPMENT SHOWN ON DRAWINGS AS EXISTING IS BASED ON EXISTING PLANS AND LIMITED FIELD INVESTIGATION. THE FIELD SURVEY WAS CONDUCTED TO VERIFY, AS MUCH AS POSSIBLE, THE ACCURACY OF THE LOCATIONS SHOWN. THE CONTRACTOR SHALL VERIFY THE ACCURACY OF THE "EXISTING CONDITIONS" AS SHOWN ON THE DRAWINGS AS THE DEMOLITION WORK PROGRESSES. PERFORM MODIFICATIONS AND ADDITIONS AS NECESSARY TO CORRECT FOR THESE HIDDEN CONDITIONS AND ALLOW FOR THE COMPLETION OF THE
- D. THE EXISTING BUILDING WILL BE IN USE DURING THIS CONSTRUCTION. SCHEDULE AND CARRY OUT THE WORK IN SUCH A MANNER AS TO CAUSE THE OWNER A MINIMUM OF INCONVENIENCE DUE TO SERVICE INTERRUPTIONS. TEMPORARY SERVICES SHALL BE INSTALLED IF ONE PHASE OF CONSTRUCTION DISRUPTS SERVICE TO ANOTHER AREA OF THE BUILDING OR IF EQUIPMENT HAS TO BE RELOCATED TO ALLOW CONSTRUCTION TO PROGRESS. SERVICE INTERRUPTIONS SHALL BE CONFINED TO THE SMALLEST AREA POSSIBLE AT ANY ONE TIME AND INTERRUPTIONS SHALL BE SCHEDULED WITH THE OWNER'S SITE REPRESENTATIVE. AFTER SERVICE HAS BEEN RESTORED FOLLOWING AN INTERRUPTION, INSPECT AREAS AFFECTED BY THE INTERRUPTION AND BE RESPONSIBLE FOR RETURNING AUTOMATICALLY CONTROLLED EQUIPMENT TO THE SAME OPERATING CONDITION, WHICH EXISTED PRIOR TO THE INTERRUPTION.
- E. PROVIDE PENETRATIONS TO THE BUILDING STRUCTURE AS REQUIRED FOR INSTALLATION. WHERE EXISTING OR TEMPORARY SYSTEMS ARE BEING DEMOLISHED, WHICH LEAVE OPENINGS IN THE EXISTING BUILDING STRUCTURE, THE BUILDING STRUCTURE SHALL BE PATCHED TO MATCH THE EXISTING CONSTRUCTION AND MAINTAIN THE EXISTING BUILDING FIRE RATINGS. ALL PENETRATIONS THROUGH DRAFT STOPS AND OTHER FIRE-RATED PARTITIONS SHALL BE FIRE STOPPED AS PER SPECIFICATIONS AND LOCAL CODES.

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- 1. VC TO DISCONNECT & REMOVE EXG PRV. VC TO PROVIDE & INSTALL INSULATED WEATHER-TIGHT CAP ON EXISTING CURB.
- 2. TYPICAL SPRING 2026 VC TO DEMO EXISTING LOW VOLTAGE CONTROLS AFTER NEW BUILDING BAS IS OPERATIONAL FOR TC TO TAKE CONTROL OF EXISTING EQUIPMENT, SEE PROPOSED.
- 3. APPROXIMATE LOCATION OF EXISTING SLAB STAT. VC TO DEMO FOR TC TO REPLACE WITH NEW WITHIN EXISTING SLEEVE. DEMO EXISTING SLAB STAT SERVING EXISTING LINEMAN/LOCKER AREA THAT WILL BE




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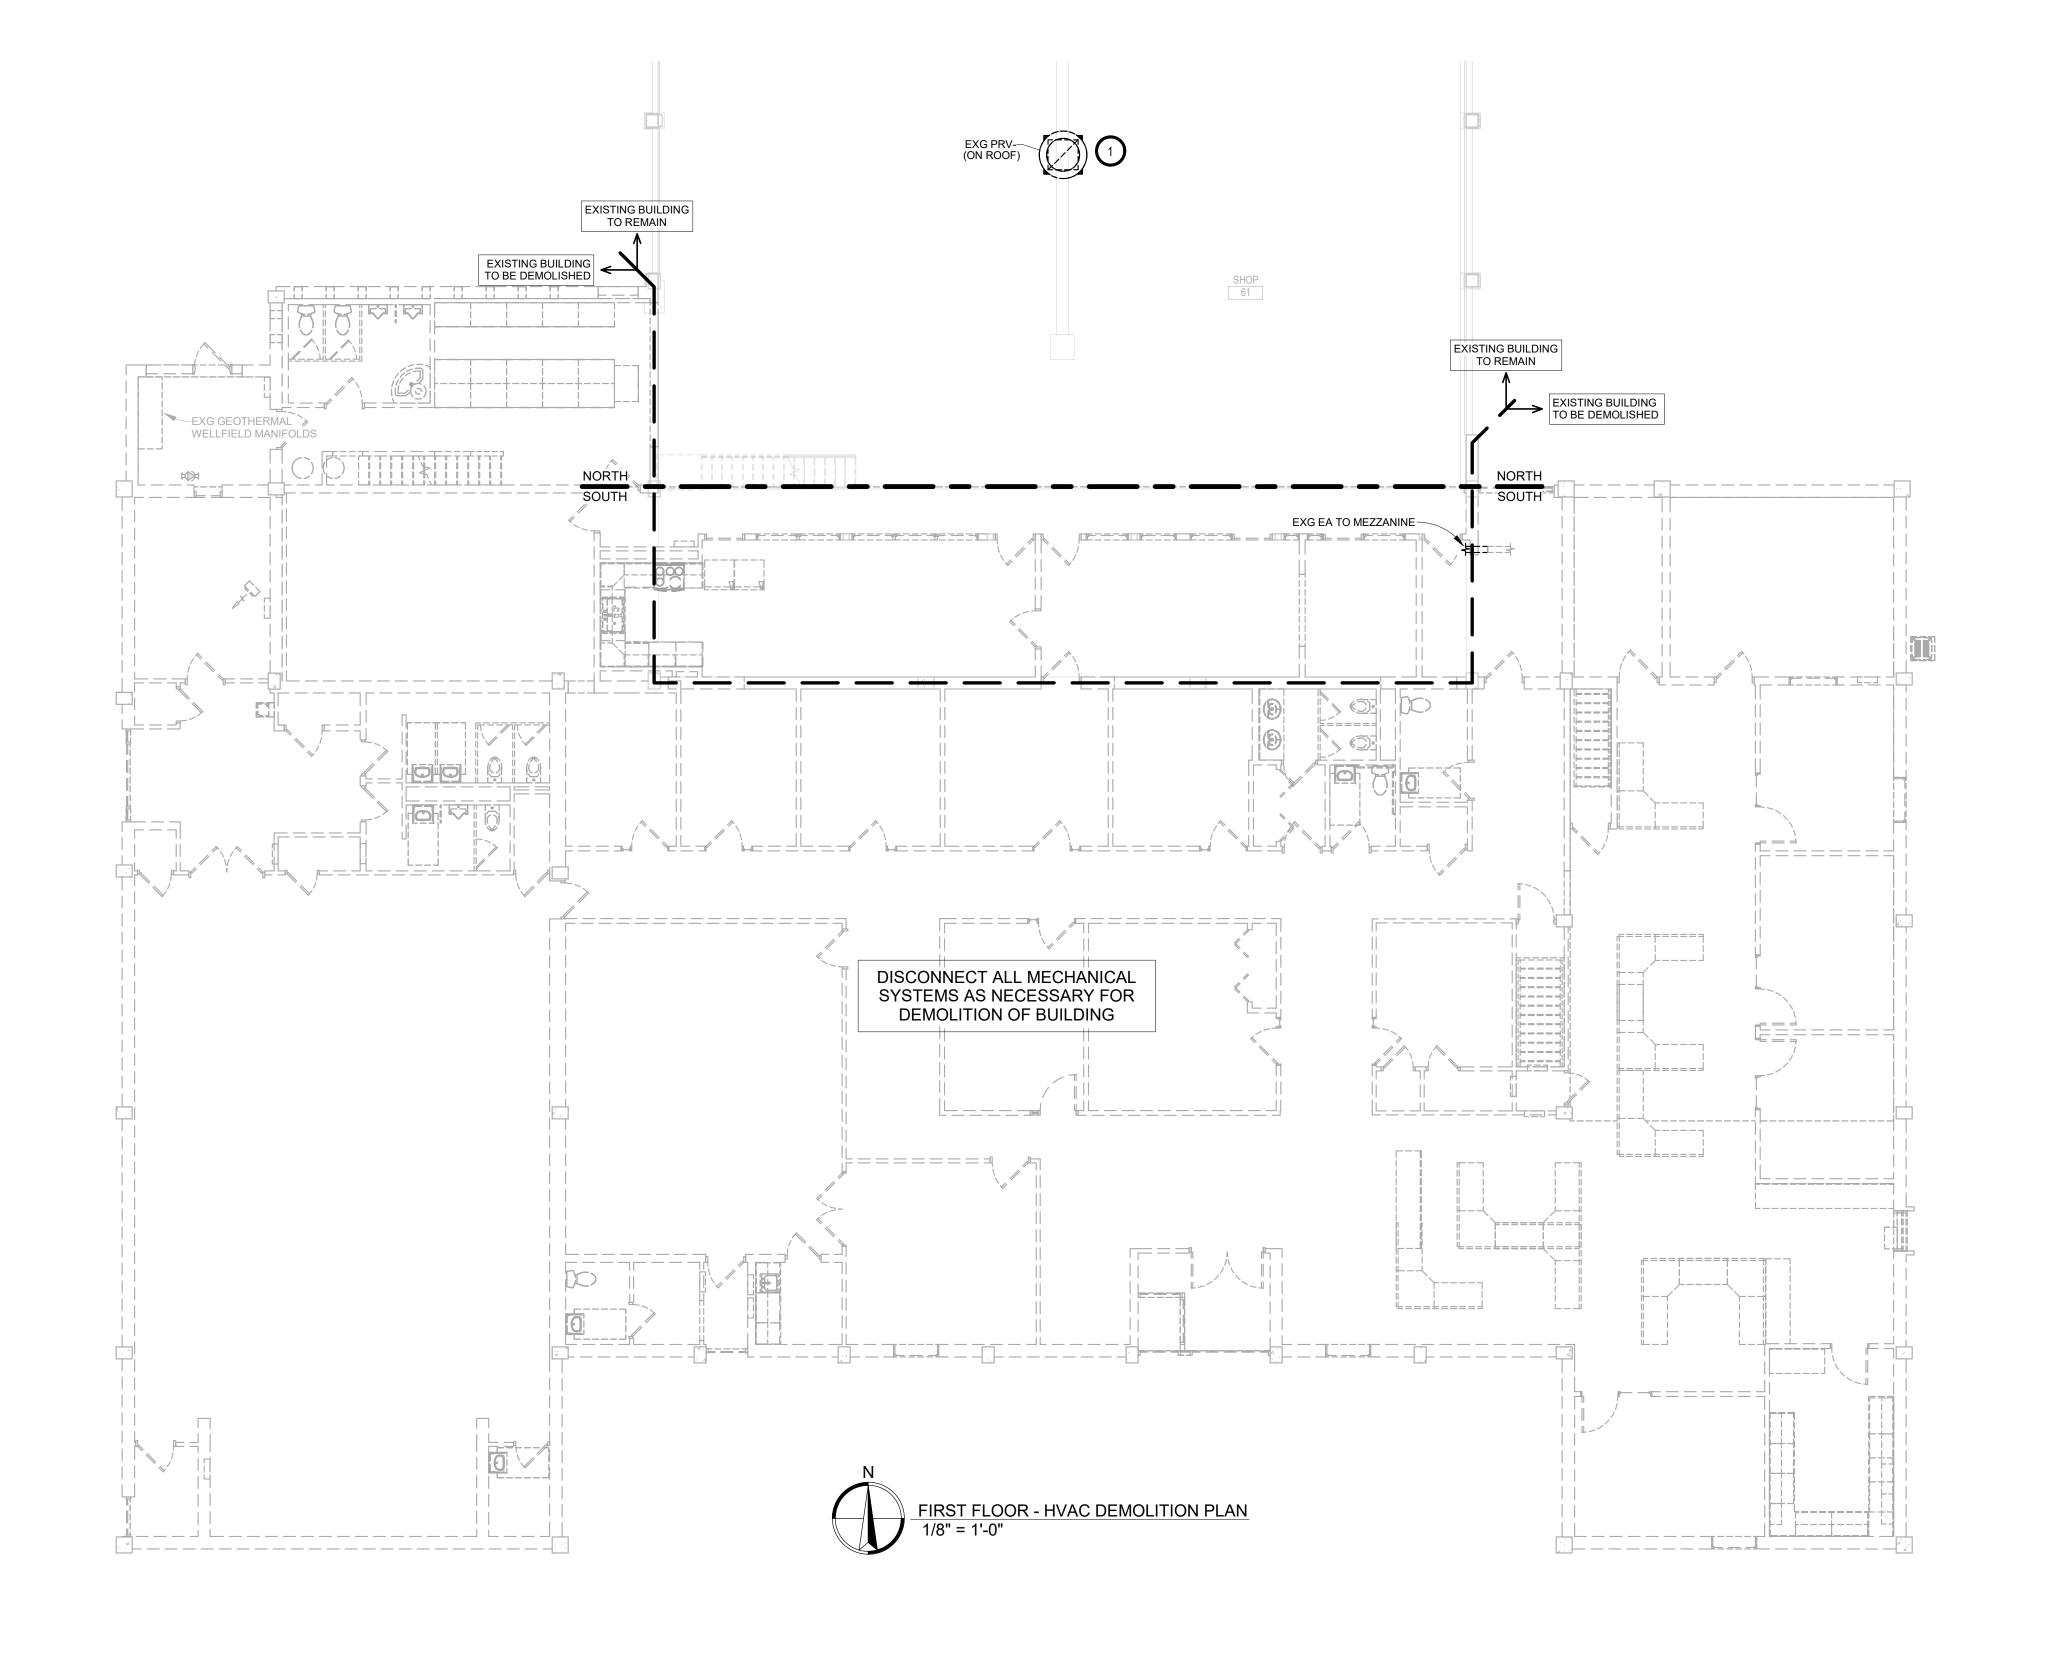
PROJECT: NORTHERN ELECTRIC COOPERATIVE ABERDEEN, SOUTH DAKOTA


SHEET TITLE: HVAC DEMOLITION PLAN -

M300.N

W-D-E <u>KEYPLAN</u>



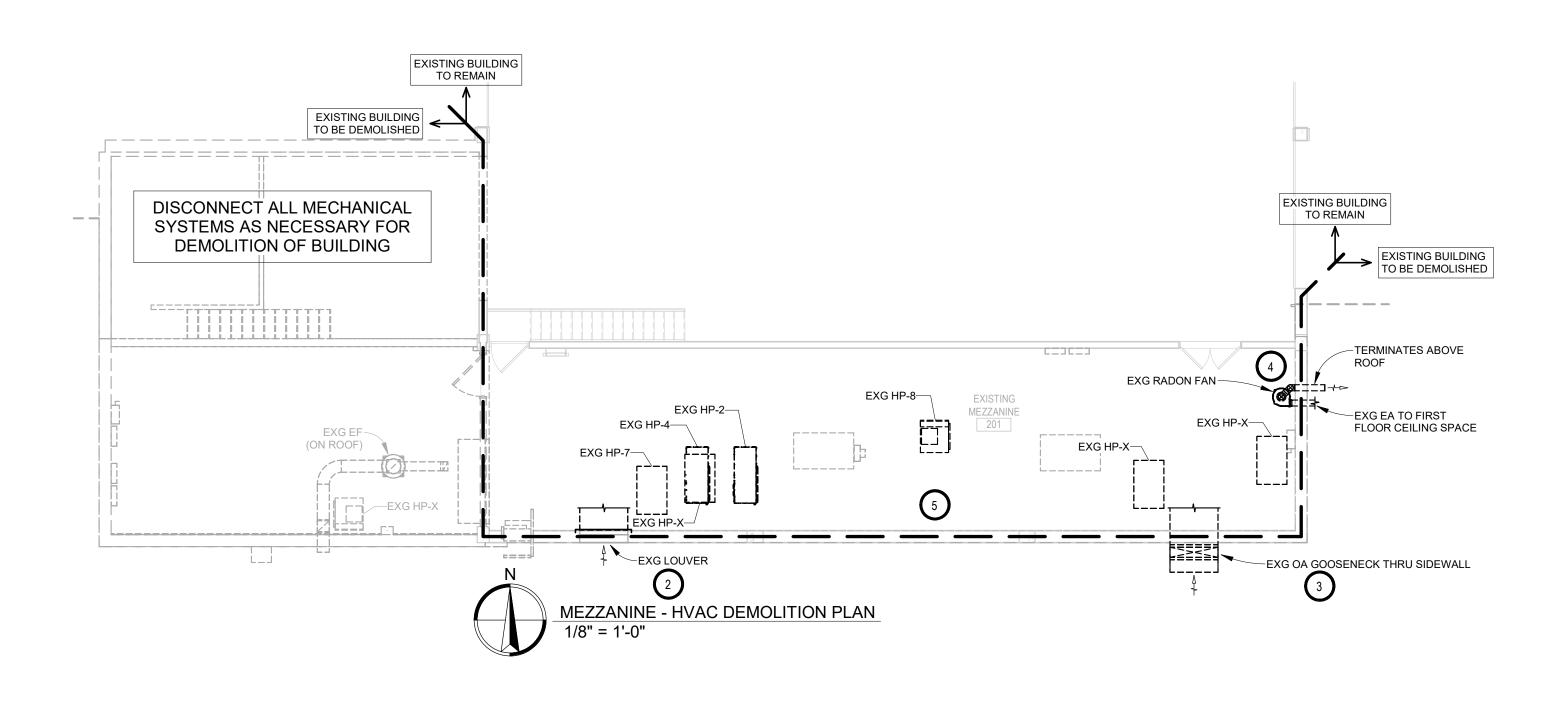

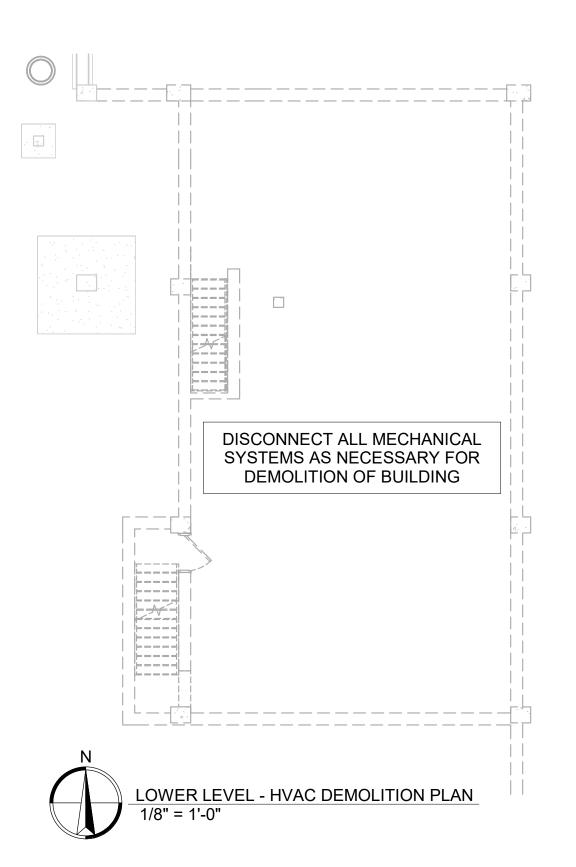

- A. CONTRACTOR SHALL VISIT THE SITE AND VERIFY ALL EXISTING CONDITIONS AND DIMENSIONS. NOTIFY THE ENGINEER IMMEDIATELY OF ANY DISCREPANCIES, INCLUDING ANY NECESSARY DEMOLITION.
- B. REMOVE MECHANICAL EQUIPMENT IN THE AREAS SHOWN ON THE PLAN, DISCONNECT SERVICES AND REMOVE TO A POINT OUT OF THE WAY OF THE GENERAL DEMOLITION. MARK ON THE PLAN TO CLEARLY SHOW WHERE THESE SERVICES ARE STOPPED. DEMOLITION WORK SHALL BE COORDINATED WITH THE OWNER. SHOULD QUESTIONS ARISE REGARDING THE REMOVAL OF EQUIPMENT, CONFER WITH THE OWNER BEFORE SUCH EQUIPMENT IS DEMOLISHED. MATERIALS REMOVED BY DEMOLITION SHALL REMAIN THE PROPERTY OF THE OWNER UNLESS OTHERWISE SPECIFICALLY NOTED. MATERIAL THE OWNER DOES NOT WISH TO RETAIN SHALL BE REMOVED AND DISPOSED OF PROPERLY BY THE CONTRACTOR.
- C. EQUIPMENT SHOWN ON DRAWINGS AS EXISTING IS BASED ON EXISTING PLANS AND LIMITED FIELD INVESTIGATION. THE FIELD SURVEY WAS CONDUCTED TO VERIFY, AS MUCH AS POSSIBLE, THE ACCURACY OF THE LOCATIONS SHOWN. THE CONTRACTOR SHALL VERIFY THE ACCURACY OF THE "EXISTING CONDITIONS" AS SHOWN ON THE DRAWINGS AS THE DEMOLITION WORK PROGRESSES. PERFORM MODIFICATIONS AND ADDITIONS AS NECESSARY TO CORRECT FOR THESE HIDDEN CONDITIONS AND ALLOW FOR THE COMPLETION OF THE NEW WORK.
- D. THE EXISTING BUILDING WILL BE IN USE DURING THIS CONSTRUCTION. SCHEDULE AND CARRY OUT THE WORK IN SUCH A MANNER AS TO CAUSE THE OWNER A MINIMUM OF INCONVENIENCE DUE TO SERVICE INTERRUPTIONS. TEMPORARY SERVICES SHALL BE INSTALLED IF ONE PHASE OF CONSTRUCTION DISRUPTS SERVICE TO ANOTHER AREA OF THE BUILDING OR IF EQUIPMENT HAS TO BE RELOCATED TO ALLOW CONSTRUCTION TO PROGRESS. SERVICE INTERRUPTIONS SHALL BE CONFINED TO THE SMALLEST AREA POSSIBLE AT ANY ONE TIME AND INTERRUPTIONS SHALL BE SCHEDULED WITH THE OWNER'S SITE REPRESENTATIVE. AFTER SERVICE HAS BEEN RESTORED FOLLOWING AN INTERRUPTION, INSPECT AREAS AFFECTED BY THE INTERRUPTION AND BE RESPONSIBLE FOR RETURNING AUTOMATICALLY CONTROLLED EQUIPMENT TO THE SAME OPERATING CONDITION, WHICH EXISTED PRIOR TO THE INTERRUPTION.
- E. PROVIDE PENETRATIONS TO THE BUILDING STRUCTURE AS REQUIRED FOR INSTALLATION. WHERE EXISTING OR TEMPORARY SYSTEMS ARE BEING DEMOLISHED, WHICH LEAVE OPENINGS IN THE EXISTING BUILDING STRUCTURE, THE BUILDING STRUCTURE SHALL BE PATCHED TO MATCH THE EXISTING CONSTRUCTION AND MAINTAIN THE EXISTING BUILDING FIRE RATINGS. ALL PENETRATIONS THROUGH DRAFT STOPS AND OTHER FIRE-RATED PARTITIONS SHALL BE FIRE STOPPED AS PER SPECIFICATIONS AND LOCAL CODES.

KEYNOTES

- VC TO DISCONNECT & REMOVE EXG PRV. VC TO PROVIDE & INSTALL INSULATED WEATHER-TIGHT CAP ON EXISTING CURB.
- VC TO DEMO EXISTING DUCTWORK TO LOUVER AND ABANDON LOUVER IN PLACE. PROVIDE & INSTALL WEATHER TIGHT CAP ON INSIDE OF LOUVER, AS TIGHT AS POSSIBLE TO EXISTING LOUVER. PROVIDE & INSTALL EXTERIOR INSULATION ON CAP.
- 3. VC TO DEMO EXISTING GOOSENECK THRU SIDEWALL OF MEZZANINE. PROVIDE & INSTALL WEATHERTIGHT INSULATED CAP THROUGH WALL PENETRATION THAT REMAINS. SEAL WALL PENETRATION WEATHER TIGHT, ENTIRE ASSEMBLY TO BE FULLY INSULATED AND SEALED WEATHER TIGHT. PROVIDE & INSTALL EXTERIOR INSULATION ON CAP.
- VC TO DEMO EXISTING RADON FAN & ASSOCIATED 4" PVC PIPING ROUTED THRU SIDEWALL. PATCH EXTERIOR WALL OPENING WITH LIKE MATERIALS TO MATCH EXISTING.
- 5. TYPICAL VC TO DISCONNECT AND REMOVE EXISTING HEAT PUMPS, CONTROLS, AND ASSOCIATED DUCTWORK. (EXISTING DUCTWORK NOT SHOWN) CONTRACTOR TO VERIFY EXISTING. TYPICAL ALL MEZZANINE DUCTWORK SIDEWALL & FLOOR PENETRATIONS WHERE DUCTWORK IS DEMO'D. VC TO PROVIDE & INSTALL INSULATED SHEET METAL CAP FLUSH WITH EXG FLOOR & EXG WALLS.



ISSUE:
5/15/2025 100% CONSTRUCTION DOCUMENTS

REVISION SCHEDULE:
REV. # REV. DSC. REV. DATE

PROJECT:
NORTHERN ELECTRIC
COOPERATIVE
ABERDEEN, SOUTH DAKOTA

SHEET TITLE:

HVAC DEMOLITION PLAN -

M300.S

W S NORTH

KEYPLAN

SOUTH

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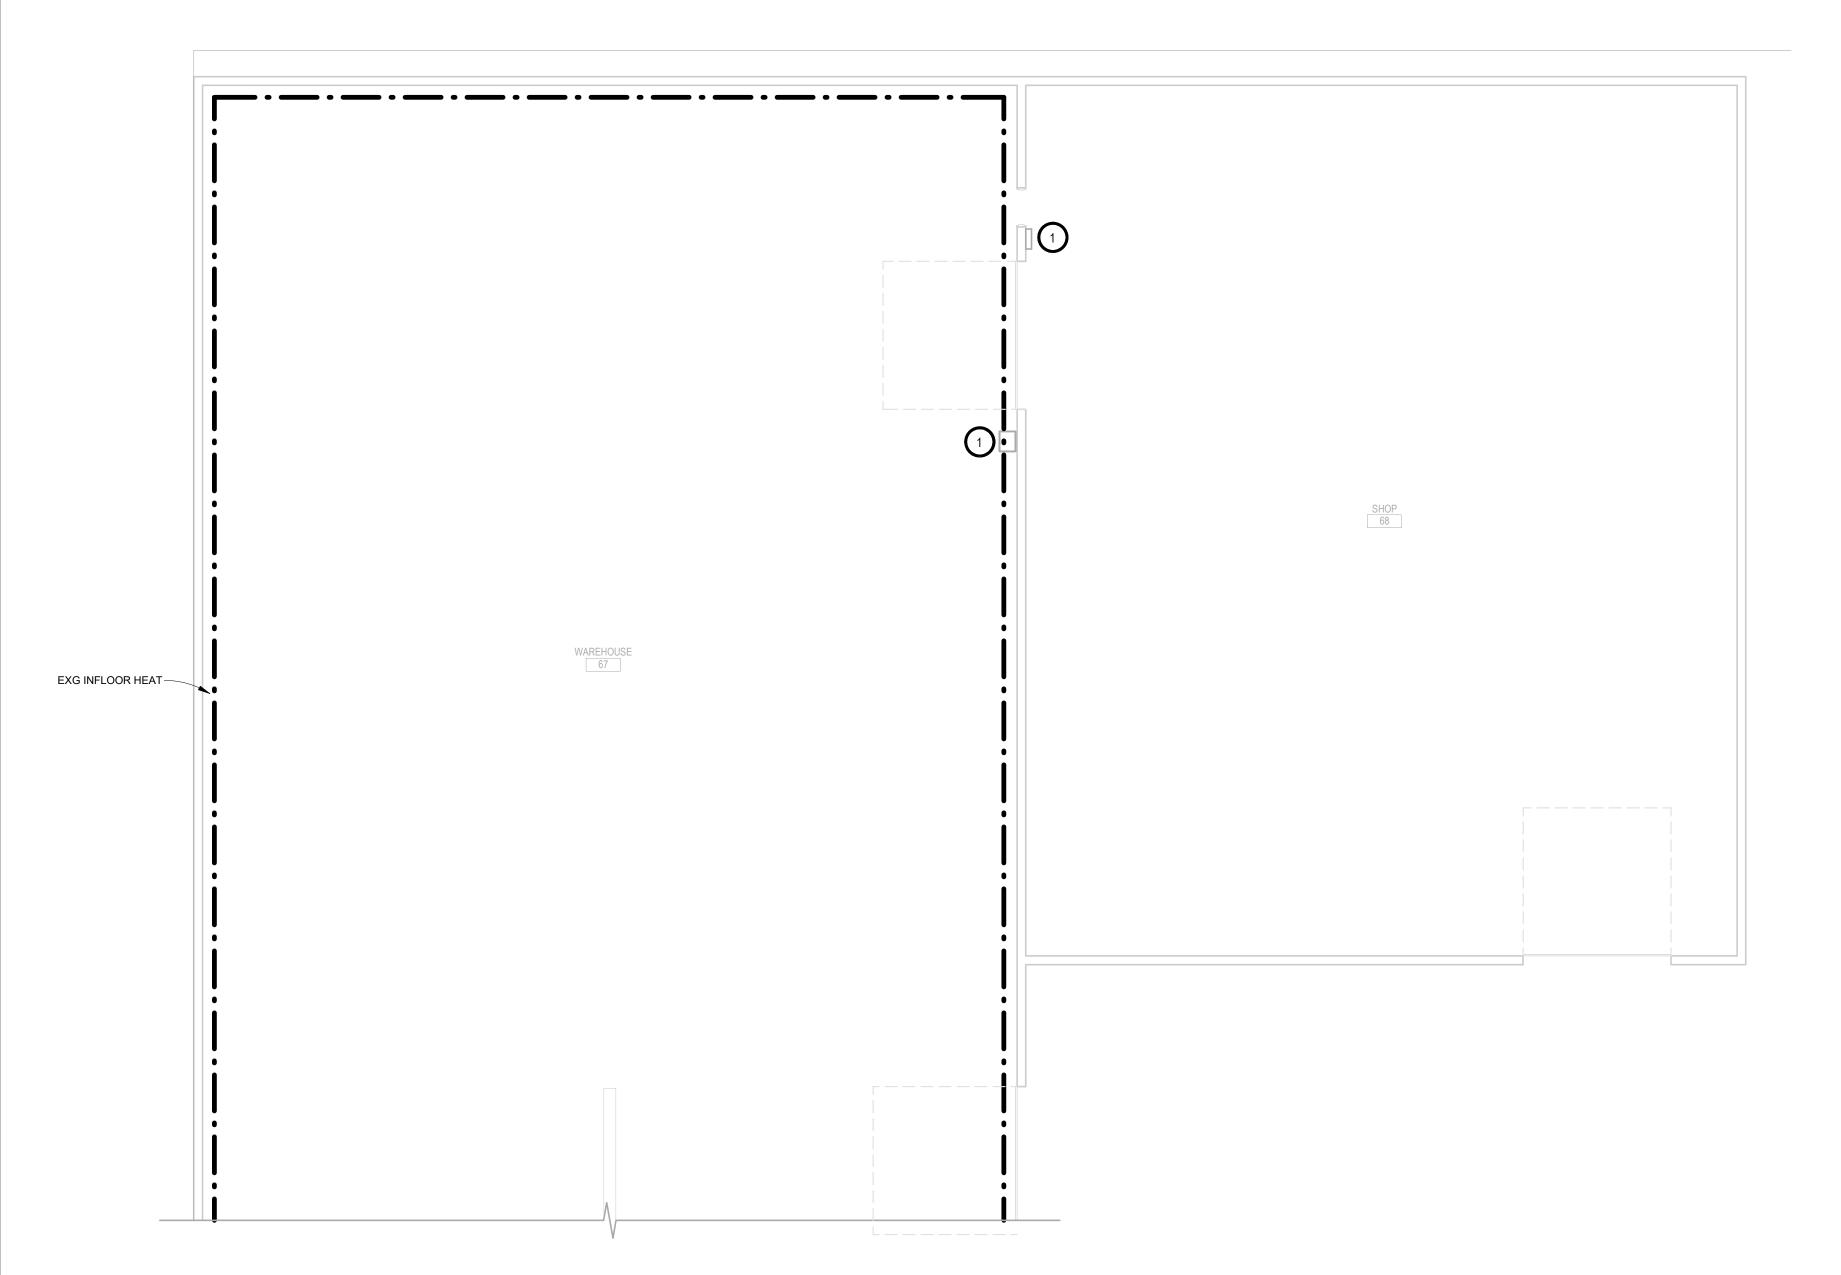
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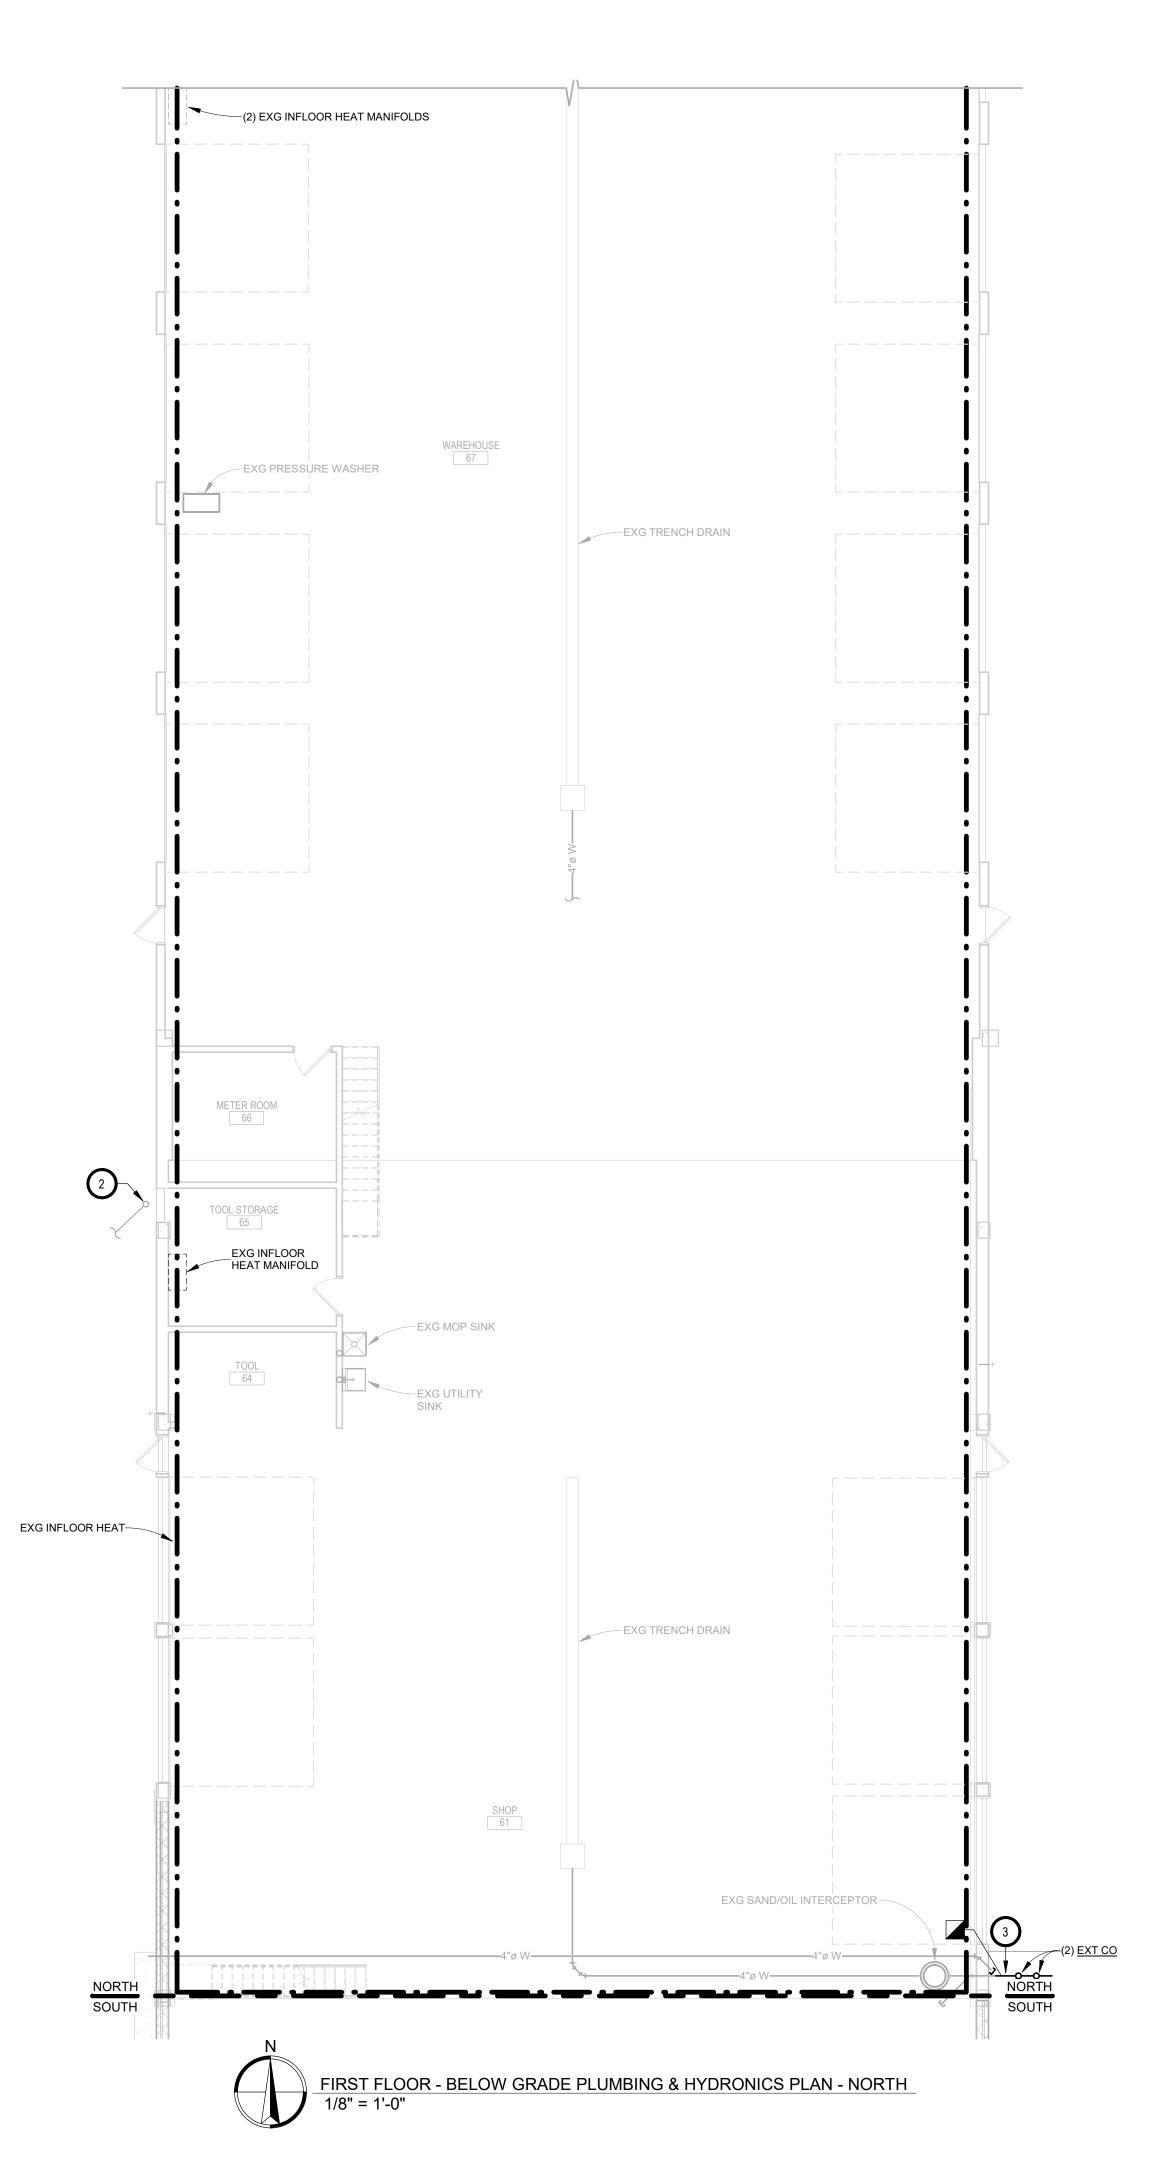
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- A. ALL WORK SHALL BE PERFORMED IN A CLEAN AND WORKMANLIKE MANNER.
- B. THE MECHANICAL CONTRACTOR SHALL BE RESPONSIBLE FOR PATCHING ANY OPENINGS LEFT IN FLOORS, WALLS, AND CEILINGS THAT WERE CAUSED BY HIS/HER ACTIONS. PATCHING SHALL MATCH EXISTING SURFACE IN COLOR, TEXTURE AND QUALITY SO THAT PATCH IS INDISTINGUISHABLE FROM ORIGINAL SURFACE.
- C. ALL PENETRATIONS THROUGH DRAFT STOPS AND OTHER FIRE-RATED PARTITIONS SHALL BE FIRE STOPPED AS PER SPECIFICATIONS AND LOCAL CODES.
- D. ALL MECHANICAL WORK SHALL BE INSTALLED IN STRICT ACCORDANCE WITH ALL APPLICABLE LOCAL, STATE, NATIONAL PLUMBING REGULATIONS, AND THE AUTHORITY HAVING JURISDICTION.
- E. THE MECHANICAL DRAWINGS SHOW GENERAL ARRANGEMENT ONLY. EXACT LOCATION SHALL AVOID INTERFERENCE WITH ELECTRICAL EQUIPMENT & REQUIRED ELECTRICAL CLEARANCES.
- F. CONTRACTOR SHALL COORDINATE ALL PLUMBING WITH LIGHT FIXTURES, HVAC, AND STRUCTURAL TO ACCOMMODATE LIMITED CEILING SPACE.
- G. FRESH AIR INTAKES TO BE MINIMUM 10' FROM ANY EXHAUST TERMINATION.
- H. CONTRACTOR SHALL VISIT THE SITE AND VERIFY ALL EXISTING CONDITIONS AND DIMENSIONS. NOTIFY THE A/E IMMEDIATELY OF ANY DISCREPANCIES.
- I. COORDINATE NEW SERVICES WITH LOCAL UTILITIES.
- J. PLUMBING CONTRACTOR TO PROVIDE VENTING FOR ALL FLOOR DRAINS, TRENCH DRAINS, AND FLOOR SINKS AS SHOWN OR AS REQUIRED BY CODE.
- K. THE MECHANICAL CONTRACTOR IS RESPONSIBLE FOR THE TESTING & CLEANING OF EACH RESPECTIVE SYSTEM IN ACCORDANCE WITH APPLICABLE STATE & LOCAL CODES. TESTS SHALL BE PERFORMED IN THE PRESENCE OF THE AUTHORITY HAVING JURISDICTION. WRITTEN NOTIFICATION OF TEST, DATE, AND RESULTS SHALL BE FURNISHED TO THE ENGINEER BEFORE CONCEALING OR COVERING THE INSTALLATION. TESTS SHALL BE REPEATED UNTIL EACH SYSTEM IS PROVEN ACCEPTABLE.

- 2. PLUMBING CONTRACTOR TO DISCONNECT & SITE SERVICE IN SPRING OF 2026. GC TO REMOVE
- 3. SUMMER OF 2025 PLUMBING CONTRACTOR TO CONNECT EXISTING 4" SANITARY SEWER TO NEW 6" SANITARY SEWER INSTALLED BY SITE UTILITY CONTRACTOR AT THIS LOCATION 5' OUTSIDE OF BUILDING, PC TO PROVIDE & INSTALL 2-WAY CLEANOUT AT THIS LOCATION. PC SHALL VERIFY EXACT LOCATION AND INVERT. SEE SITE PLAN FOR HOLDING TANK BY PC.

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- 1. THIS SPACE IS RESERVED FOR ELECTRICAL GEAR. PIPING AND EQUIPMENT SHALL NOT BE LOCATED IN FRONT OF OR ROUTED ABOVE ELECTRICAL PANELS. COORDINATE WITH DIVISION 26.
- UTILITY CONTRACTOR TO DEMO TEMPORARY WATER TEMPORARY DOG HOUSE AND PATCH CONCRETE.



SPECIAL NOTES

- A. ALL MECHANICAL SYSTEMS, EXCLUDING DROPS, TO BE INSTALLED AS HIGH AS POSSIBLE TO PROVIDE MAXIMUM CLEARANCES FOR OWNER.
- B. FLOOR DRAINS & SINK LOCATIONS SHALL BE INSTALLED IN LOCATIONS PROPER TO ACCEPT INDIRECT DRAIN PIPING FROM BOILERS, WATER HEATER, RELIEFS, ETC. (TRIP HAZARDS FROM PIPING WILL NOT BE ACCEPTABLE).
- C. ALL FLOOR CLEANOUTS TO BE LOCATED IN INCONSPICUOUS LOCATIONS. CLEANOUTS LOCATED IN DOORWAYS AND MIDDLE OF HALLWAYS WILL NOT BE ACCEPTABLE.


ISSUE: 5/15/2025 100% CONSTRUCTION DOCUMENTS **REVISION SCHEDULE:** REV. # REV. DSC. REV. DATE

PROJECT: NORTHERN ELECTRIC COOPERATIVE ABERDEEN, SOUTH DAKOTA

SHEET TITLE: BELOW GRADE PLUMBING & HYDRONICS PLAN - NORTH

M400.N

<u>KEYPLAN</u> SOUTH

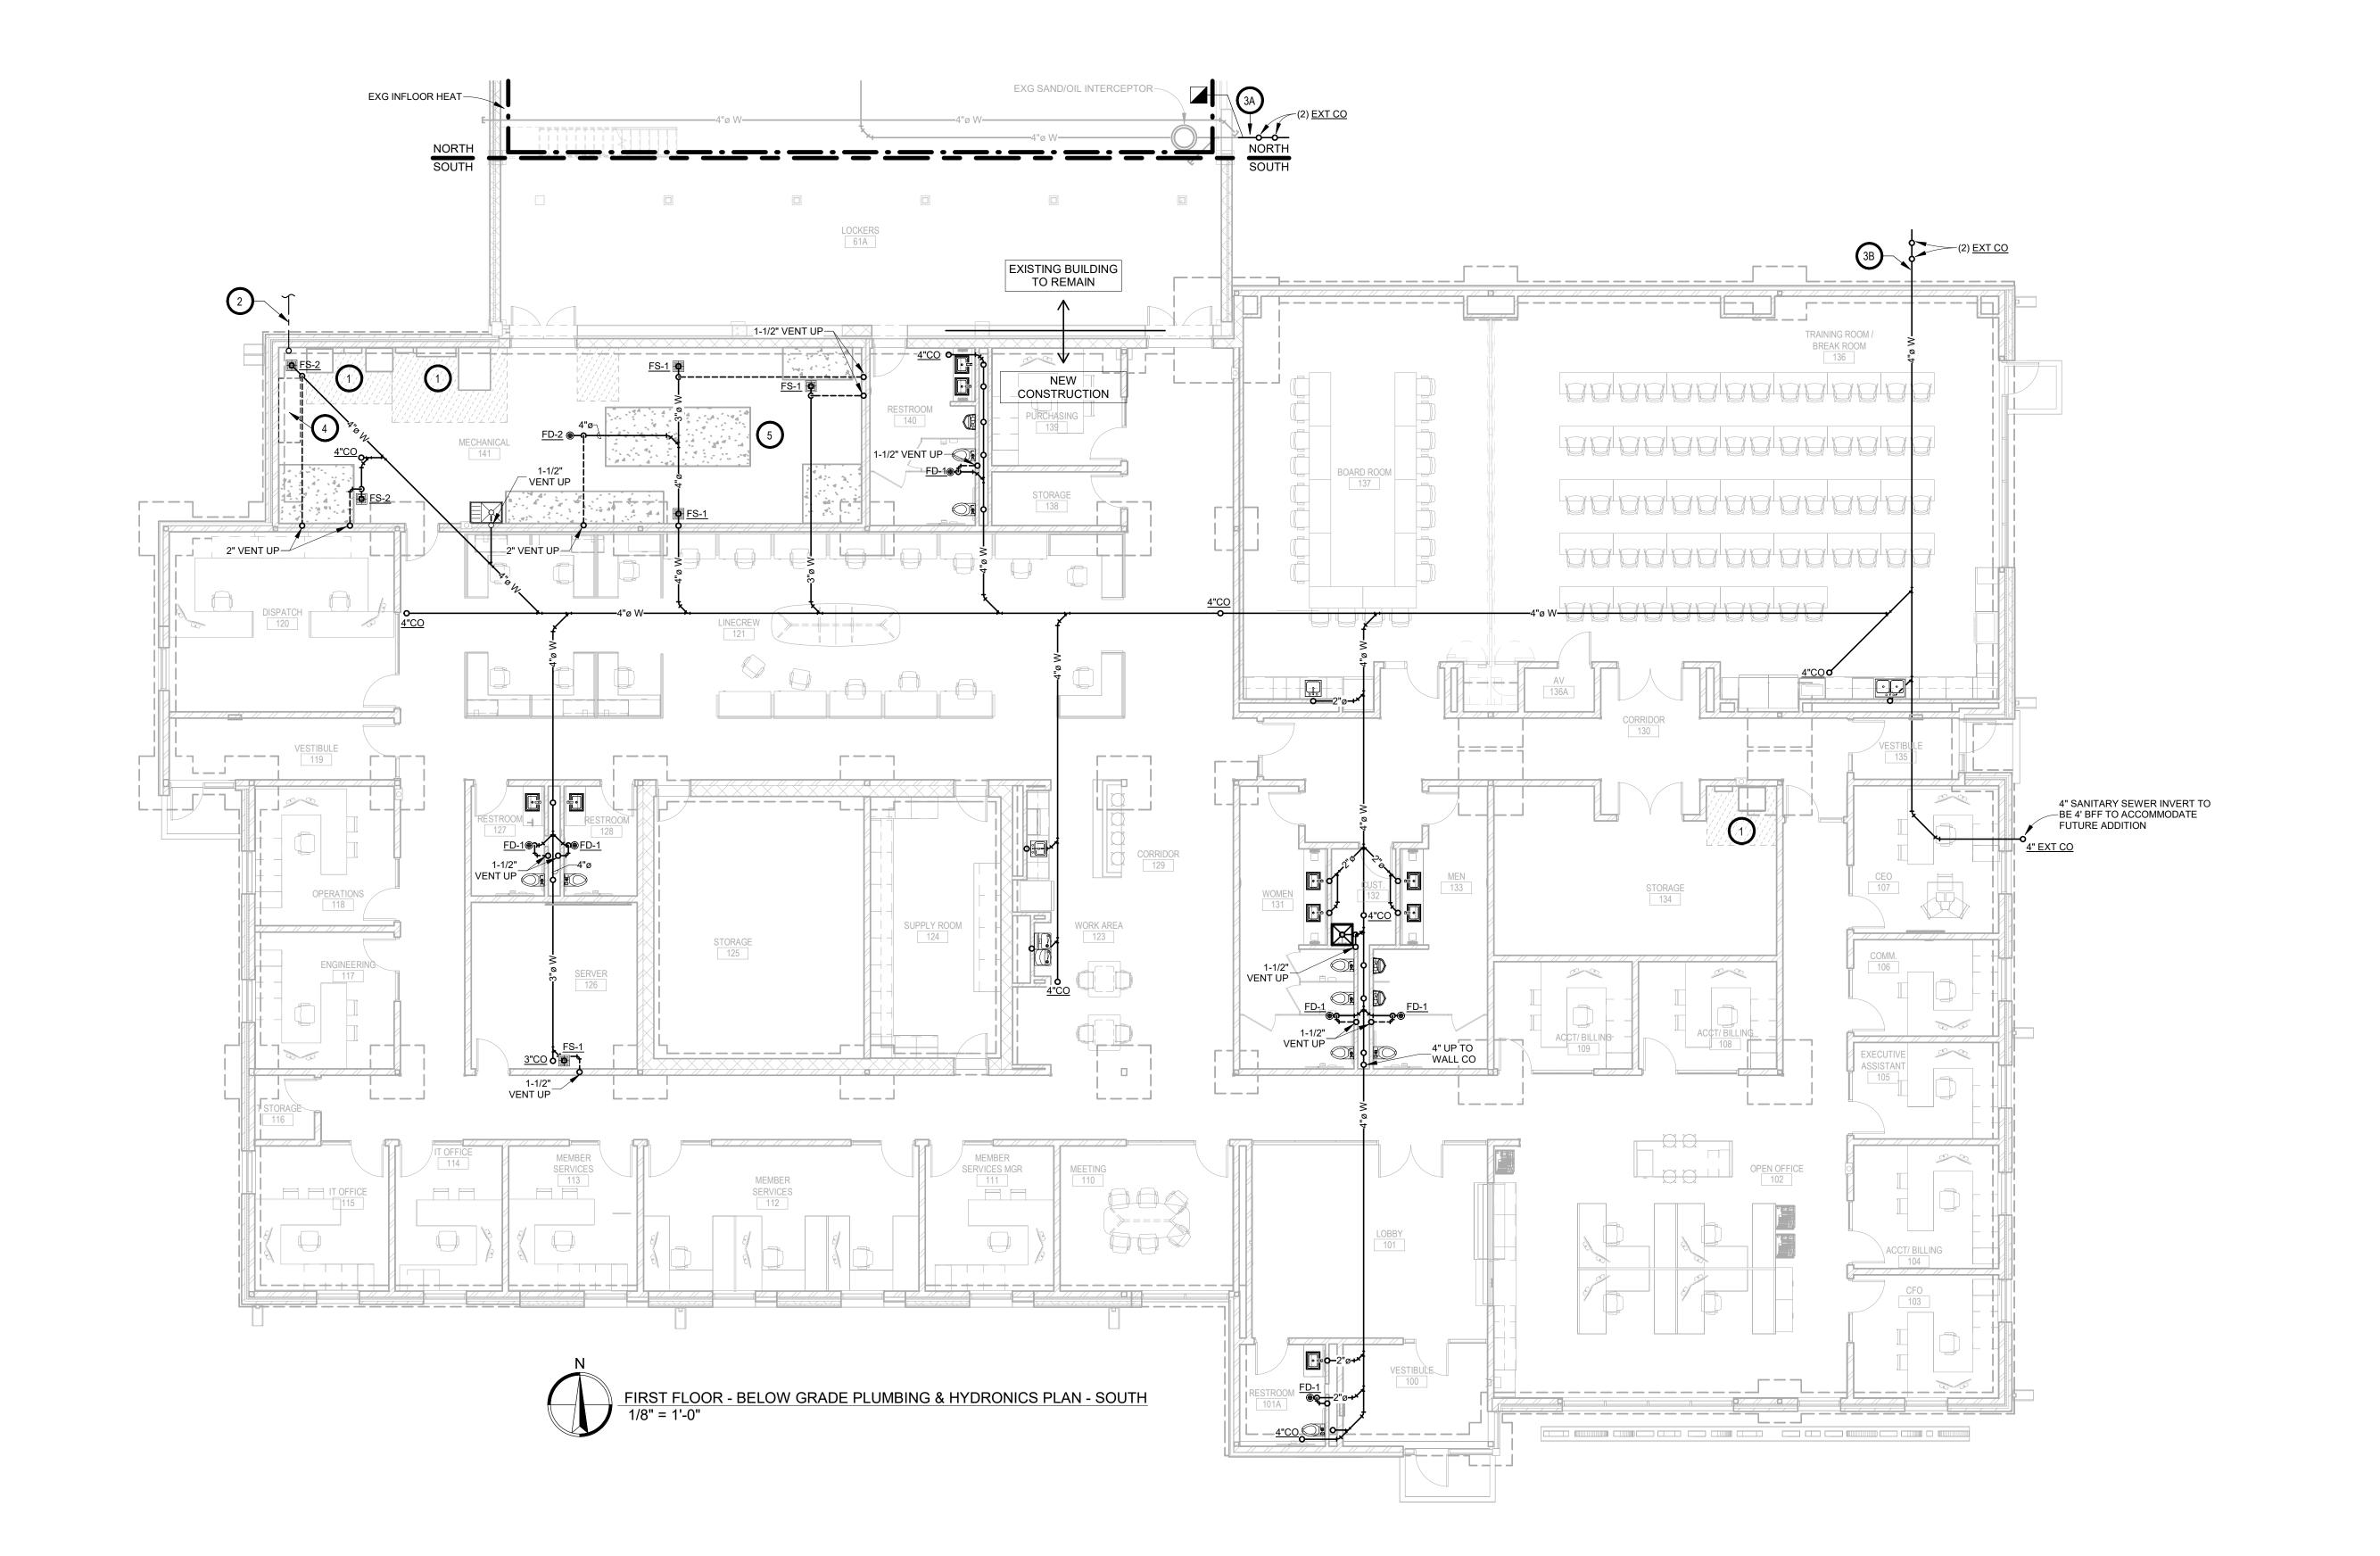

- A. ALL WORK SHALL BE PERFORMED IN A CLEAN AND WORKMANLIKE MANNER.
- B. THE MECHANICAL CONTRACTOR SHALL BE RESPONSIBLE FOR PATCHING ANY OPENINGS LEFT IN FLOORS, WALLS, AND CEILINGS THAT WERE CAUSED BY HIS/HER ACTIONS. PATCHING SHALL MATCH EXISTING SURFACE IN COLOR, TEXTURE AND QUALITY SO THAT PATCH IS INDISTINGUISHABLE FROM ORIGINAL SURFACE.
- C. ALL PENETRATIONS THROUGH DRAFT STOPS AND OTHER FIRE-RATED PARTITIONS SHALL BE FIRE STOPPED AS PER SPECIFICATIONS AND LOCAL CODES.
- D. ALL MECHANICAL WORK SHALL BE INSTALLED IN STRICT ACCORDANCE WITH ALL APPLICABLE LOCAL, STATE, NATIONAL PLUMBING REGULATIONS, AND THE AUTHORITY HAVING JURISDICTION.
- E. THE MECHANICAL DRAWINGS SHOW GENERAL ARRANGEMENT ONLY. EXACT LOCATION SHALL AVOID INTERFERENCE WITH ELECTRICAL EQUIPMENT & REQUIRED ELECTRICAL CLEARANCES.
- F. CONTRACTOR SHALL COORDINATE ALL PLUMBING WITH LIGHT FIXTURES, HVAC, AND STRUCTURAL TO ACCOMMODATE LIMITED CEILING SPACE.
- G. FRESH AIR INTAKES TO BE MINIMUM 10' FROM ANY EXHAUST TERMINATION.
- H. CONTRACTOR SHALL VISIT THE SITE AND VERIFY ALL EXISTING CONDITIONS AND DIMENSIONS. NOTIFY THE A/E IMMEDIATELY OF ANY DISCREPANCIES.
- I. COORDINATE NEW SERVICES WITH LOCAL UTILITIES.
- J. PLUMBING CONTRACTOR TO PROVIDE VENTING FOR ALL FLOOR DRAINS, TRENCH DRAINS, AND FLOOR SINKS
- AS SHOWN OR AS REQUIRED BY CODE. K. THE MECHANICAL CONTRACTOR IS RESPONSIBLE FOR THE TESTING & CLEANING OF EACH RESPECTIVE SYSTEM IN ACCORDANCE WITH APPLICABLE STATE & LOCAL CODES. TESTS SHALL BE PERFORMED IN THE PRESENCE OF THE AUTHORITY HAVING JURISDICTION. WRITTEN NOTIFICATION OF TEST, DATE, AND RESULTS SHALL BE FURNISHED TO THE ENGINEER BEFORE CONCEALING OR COVERING THE INSTALLATION. TESTS SHALL BE REPEATED UNTIL EACH SYSTEM IS PROVEN ACCEPTABLE.

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O KEYNOTES

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2. PLUMBING CONTRACTOR TO CONNECT NEW 1-1/2" DOMESTIC WATER SERVICE TO NEW 1-1/2" DOMESTIC WATER SERVICE INSTALLED BY SITE UTILITY CONTRACTOR AT THIS LOCATION 5' OUTSIDE THE BUILDING. FURNISH AND INSTALL THRUST BLOCKS AND/OR TIE-RODS IN ACCORDANCE WITH THE LOCAL WATER DEPARTMENT STANDARDS AND REGULATIONS. PLUMBING CONTRACTOR SHALL VERIFY EXACT LOCATION, AND

3A. SUMMER OF 2025 - PLUMBING CONTRACTOR TO CONNECT EXISTING 4" SANITARY SEWER TO NEW 6" SANITARY SEWER INSTALLED BY SITE UTILITY CONTRACTOR AT THIS LOCATION 5' OUTSIDE OF BUILDING. PLUMBING CONTRACTOR TO PROVIDE & INSTALL 2-WAY 4" CLEAN OUTS AT THIS LOCATION. PC SHALL VERIFY EXACT LOCATION AND INVERT.

3B. SPRING OF 2026 - PLUMBING CONTRACTOR TO CONNECT NEW 4" SANITARY SEWER TO NEW 6" SANITARY SERVICE INSTALLED BY SITE UTILITY CONTRACTOR AT THIS LOCATION 5' OUTSIDE OF BUILDING, PLUMBING CONTRACTOR TO PROVIDE & INSTALL 2-WAY 4" CLEAN OUTS AT THIS LOCATION. PLUMBING CONTRACTOR SHALL VERIFY EXACT LOCATION, & INVERT.

4. GEOTHERMAL WELLFIELD CONTRACTOR TO EXTEND EXISTING 2" GEOTHERMAL WELLFIELD CIRCUITS INTO NEW MECHANICAL ROOM AND INSTALL AT NEW HEADERS. SEE GROUND-COUPLED HEAT EXCHANGER HEADER DETAIL, AND HEADER SUPPORT & STUB OUT DETAIL. AVOID ROUTING NEAR ELECTRICAL AND DOMESTIC WATER SERVICES AS MUCH AS POSSIBLE.

5. TYPICAL - POURED 4" HIGH CONCRETE HOUSEKEEPING PADS BY GC, MECHANICAL CONTRACTORS TO COORDINATE EXACT SIZE AND LOCATION..



- A. ALL MECHANICAL SYSTEMS, EXCLUDING DROPS, TO
- B. FLOOR DRAINS & SINK LOCATIONS SHALL BE INSTALLED IN LOCATIONS PROPER TO ACCEPT
- C. ALL FLOOR CLEANOUTS TO BE LOCATED IN BE ACCEPTABLE.

ISSUE: 5/15/2025 100% CONSTRUCTION DOCUMENTS REVISION SCHEDULE: REV. # REV. DSC. REV. DATE

PROJECT: NORTHERN ELECTRIC COOPERATIVE ABERDEEN, SOUTH DAKOTA

SHEET TITLE:

BELOW GRADE PLUMBING & HYDRONICS PLAN - SOUTH

M400.S




BE INSTALLED AS HIGH AS POSSIBLE TO PROVIDE MAXIMUM CLEARANCES FOR OWNER.

INDIRECT DRAIN PIPING FROM BOILERS, WATER HEATER, RELIEFS, ETC. (TRIP HAZARDS FROM PIPING WILL NOT BE ACCEPTABLE).

INCONSPICUOUS LOCATIONS. CLEANOUTS LOCATED IN DOORWAYS AND MIDDLE OF HALLWAYS WILL NOT

> W-**(**-)-E NORTH <u>KEYPLAN</u> SOUTH

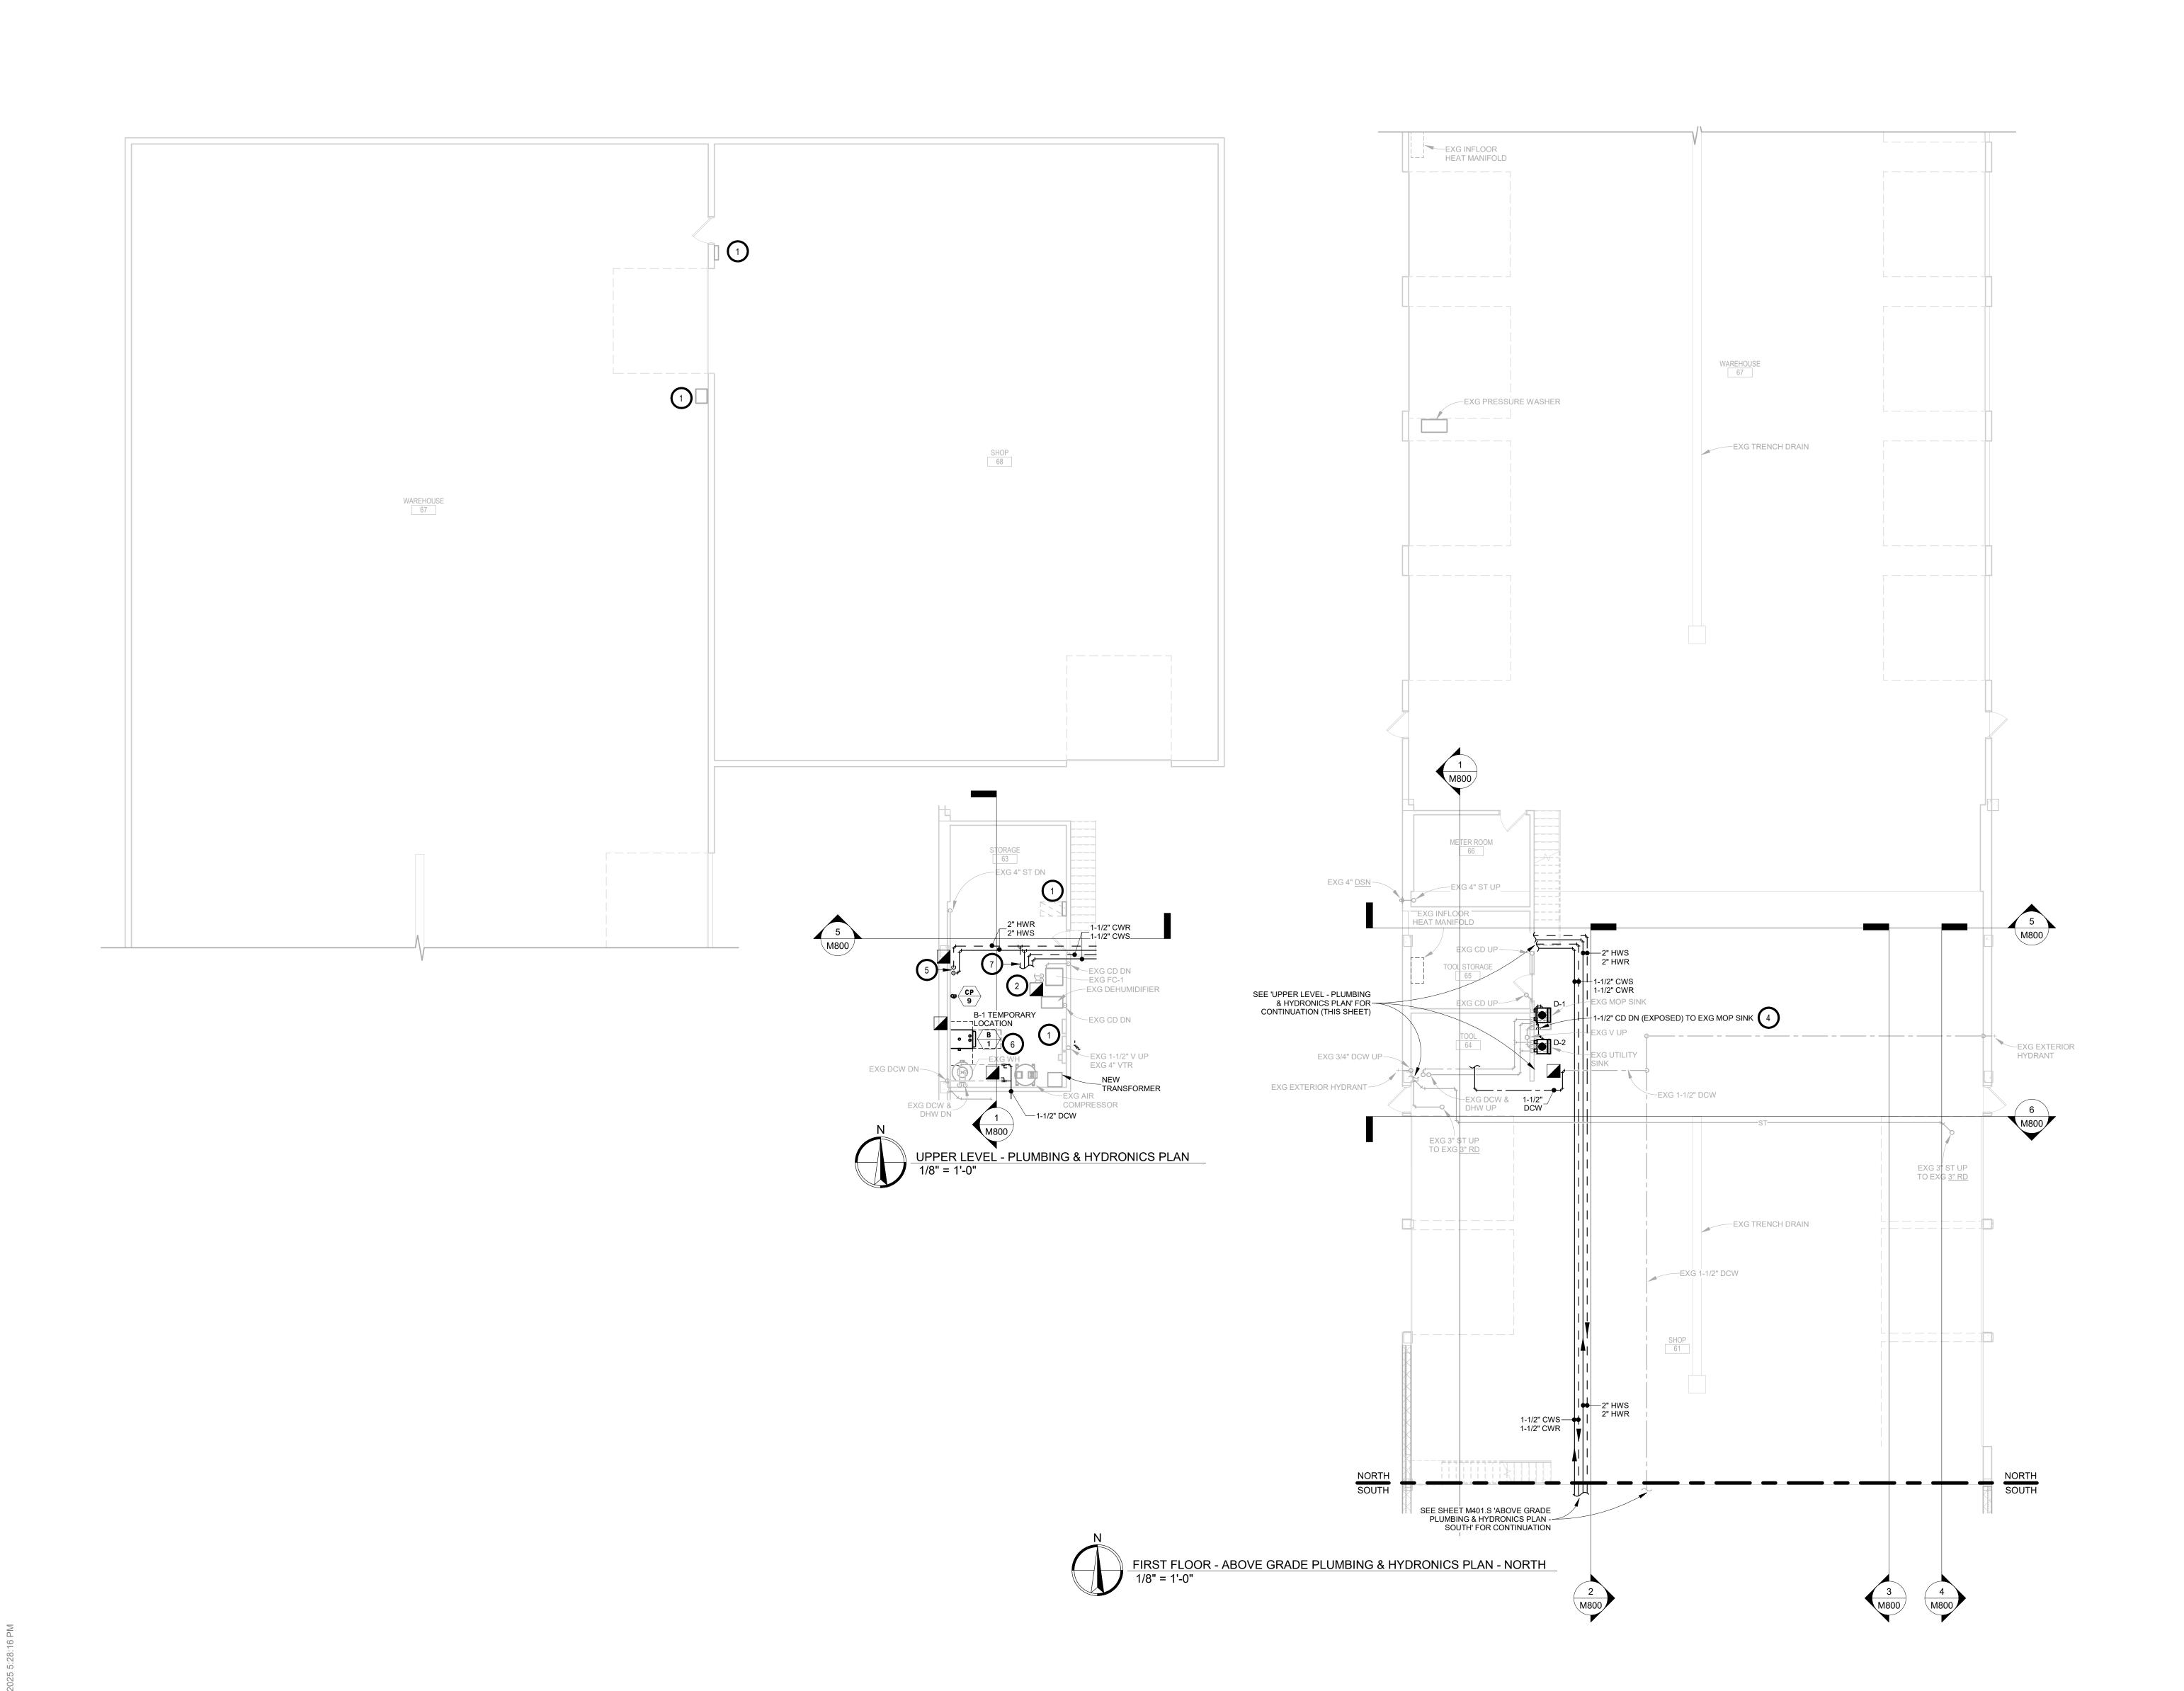

- A. ALL WORK SHALL BE PERFORMED IN A CLEAN AND WORKMANLIKE MANNER.
- B. THE MECHANICAL CONTRACTOR SHALL BE RESPONSIBLE FOR PATCHING ANY OPENINGS LEFT IN FLOORS, WALLS, AND CEILINGS THAT WERE CAUSED BY HIS/HER ACTIONS. PATCHING SHALL MATCH EXISTING SURFACE IN COLOR, TEXTURE AND QUALITY SO THAT PATCH IS INDISTINGUISHABLE FROM ORIGINAL SURFACE.
- C. ALL PENETRATIONS THROUGH DRAFT STOPS AND OTHER FIRE-RATED PARTITIONS SHALL BE FIRE STOPPED AS PER SPECIFICATIONS AND LOCAL CODES.
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- E. THE MECHANICAL DRAWINGS SHOW GENERAL ARRANGEMENT ONLY. EXACT LOCATION SHALL AVOID INTERFERENCE WITH ELECTRICAL EQUIPMENT & REQUIRED ELECTRICAL CLEARANCES.
 F. CONTRACTOR SHALL COORDINATE ALL PLUMBING WITH
- ACCOMMODATE LIMITED CEILING SPACE.

 G FRESH AIR INTAKES TO BE MINIMUM 10' FROM AN'

LIGHT FIXTURES, HVAC, AND STRUCTURAL TO

- G. FRESH AIR INTAKES TO BE MINIMUM 10' FROM ANY EXHAUST TERMINATION.
- H. CONTRACTOR SHALL VISIT THE SITE AND VERIFY ALL EXISTING CONDITIONS AND DIMENSIONS. NOTIFY THE A/E IMMEDIATELY OF ANY DISCREPANCIES.
- I. COORDINATE NEW SERVICES WITH LOCAL UTILITIES.
- J. PLUMBING CONTRACTOR TO PROVIDE VENTING FOR ALL FLOOR DRAINS, TRENCH DRAINS, AND FLOOR SINKS
- AS SHOWN OR AS REQUIRED BY CODE.

 K. THE MECHANICAL CONTRACTOR IS RESPONSIBLE FOR THE TESTING & CLEANING OF EACH RESPECTIVE SYSTEM IN ACCORDANCE WITH APPLICABLE STATE & LOCAL CODES. TESTS SHALL BE PERFORMED IN THE PRESENCE OF THE AUTHORITY HAVING JURISDICTION. WRITTEN NOTIFICATION OF TEST, DATE, AND RESULTS SHALL BE FURNISHED TO THE ENGINEER BEFORE CONCEALING OR COVERING THE INSTALLATION. TESTS SHALL BE REPEATED UNTIL EACH SYSTEM IS PROVEN ACCEPTABLE.

O KEYNOTES

- THIS SPACE IS RESERVED FOR ELECTRICAL GEAR. PIPING AND EQUIPMENT SHALL NOT BE LOCATED IN FRONT OF OR ROUTED ABOVE ELECTRICAL PANELS. COORDINATE WITH DIVISION 26.
- 2. SEE EXISTING FAN COIL PIPING DETAIL.
- 3. NOT USED.
- TYPICAL PC TO ROUTE 1-1/2" SCH 40 PVC TO EXISTING MOB SINK FROM DEHUMIDIFIERS. COORDINATE LOCATION WITH OWNER. (DEHUMIDIFIER D-1 AND D-2 PROVIDED AND INSTALLED BY VC.)
- 5. CONNECT NEW HEATING PIPING TO EXISTING RUNOUTS TO EXISTING IN-FLOOR HEAT MANIFOLDS AT THIS APPROXIMATE LOCATION. SEE MODIFICATIONS TO EXISTING IN-FLOOR HEAT MANIFOLD CONTROL & PIPING DIAGRAM.
- 6. SPRING 2026 DEMO TEMPORARY 1-1/2" DCW PIPING AND CAP AT RELOCATED.

W-W-F

<u>KEYPLAN</u>

SOUTH



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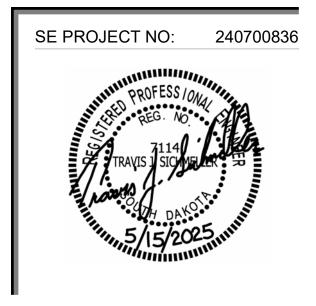
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PROJECT:


NORTHERN ELECTRIC
COOPERATIVE


ABERDEEN, SOUTH DAKOTA


SHEET TITLE:

ABOVE GRADE PLUMBING &
HYDRONICS PLAN - NORTH

M401.N

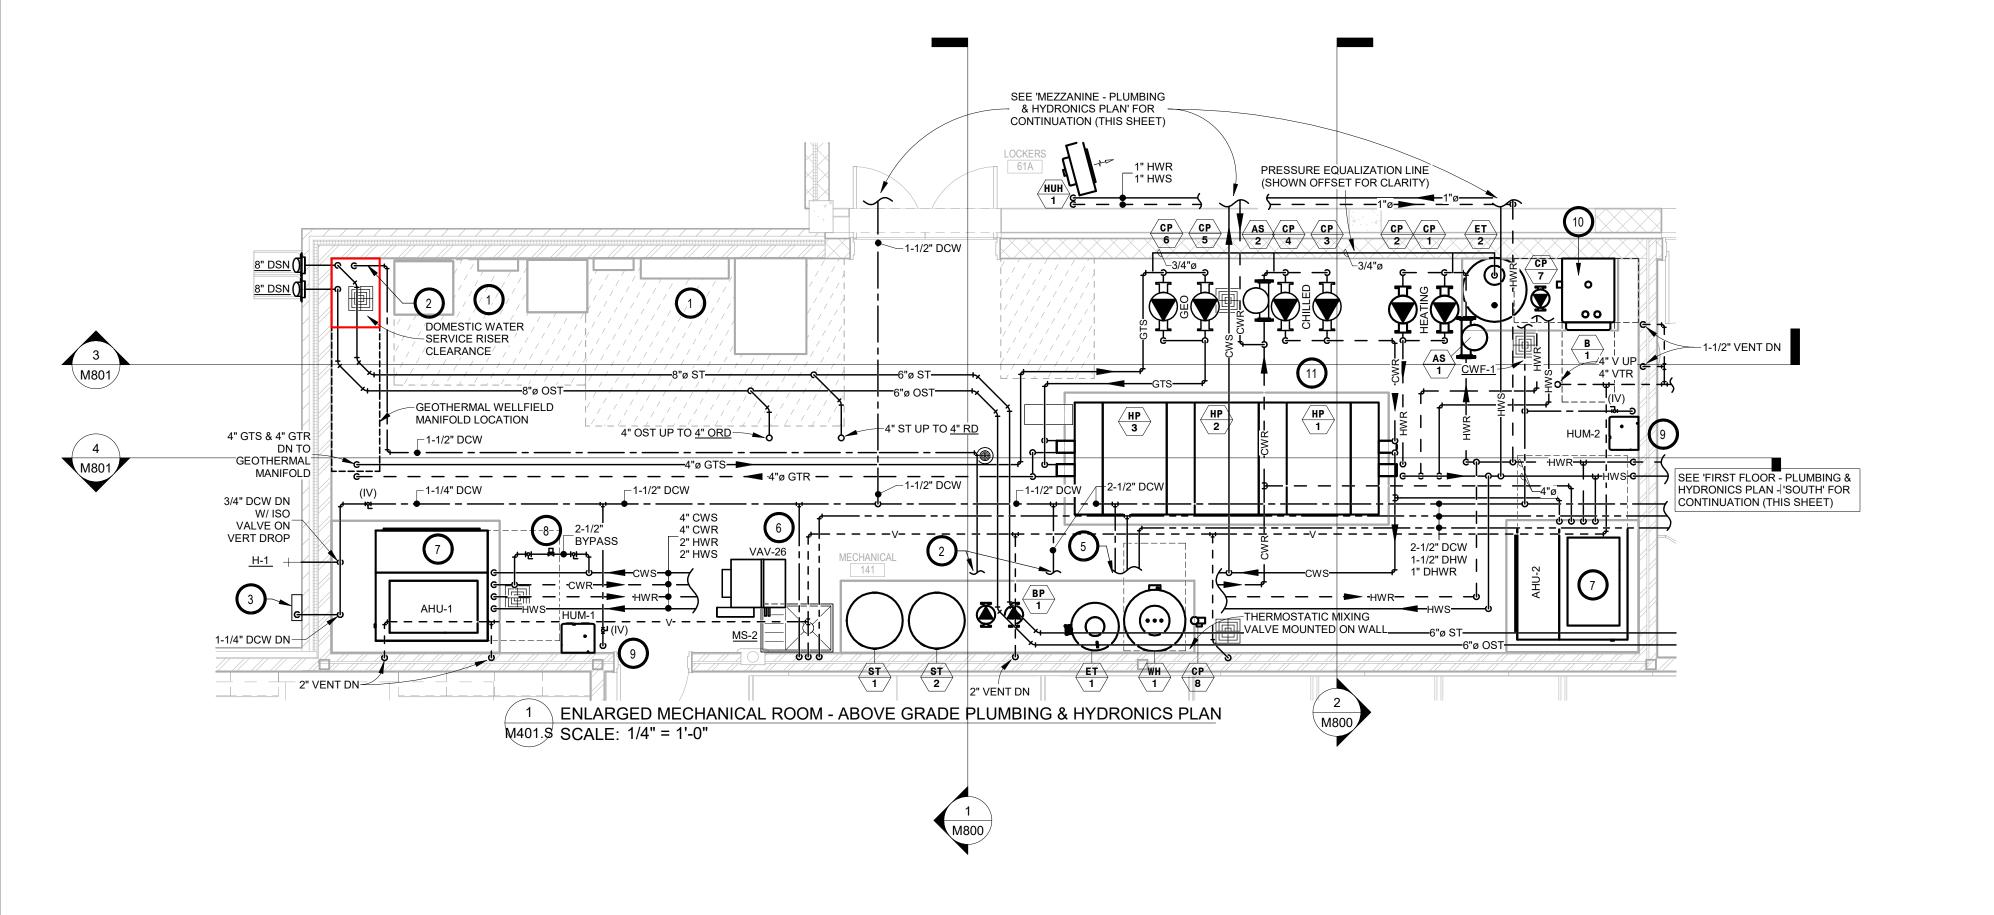

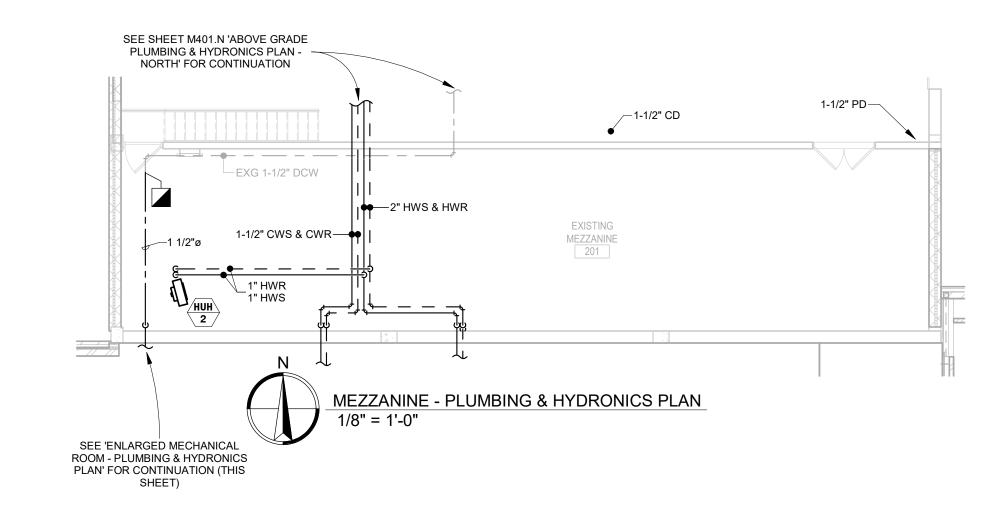

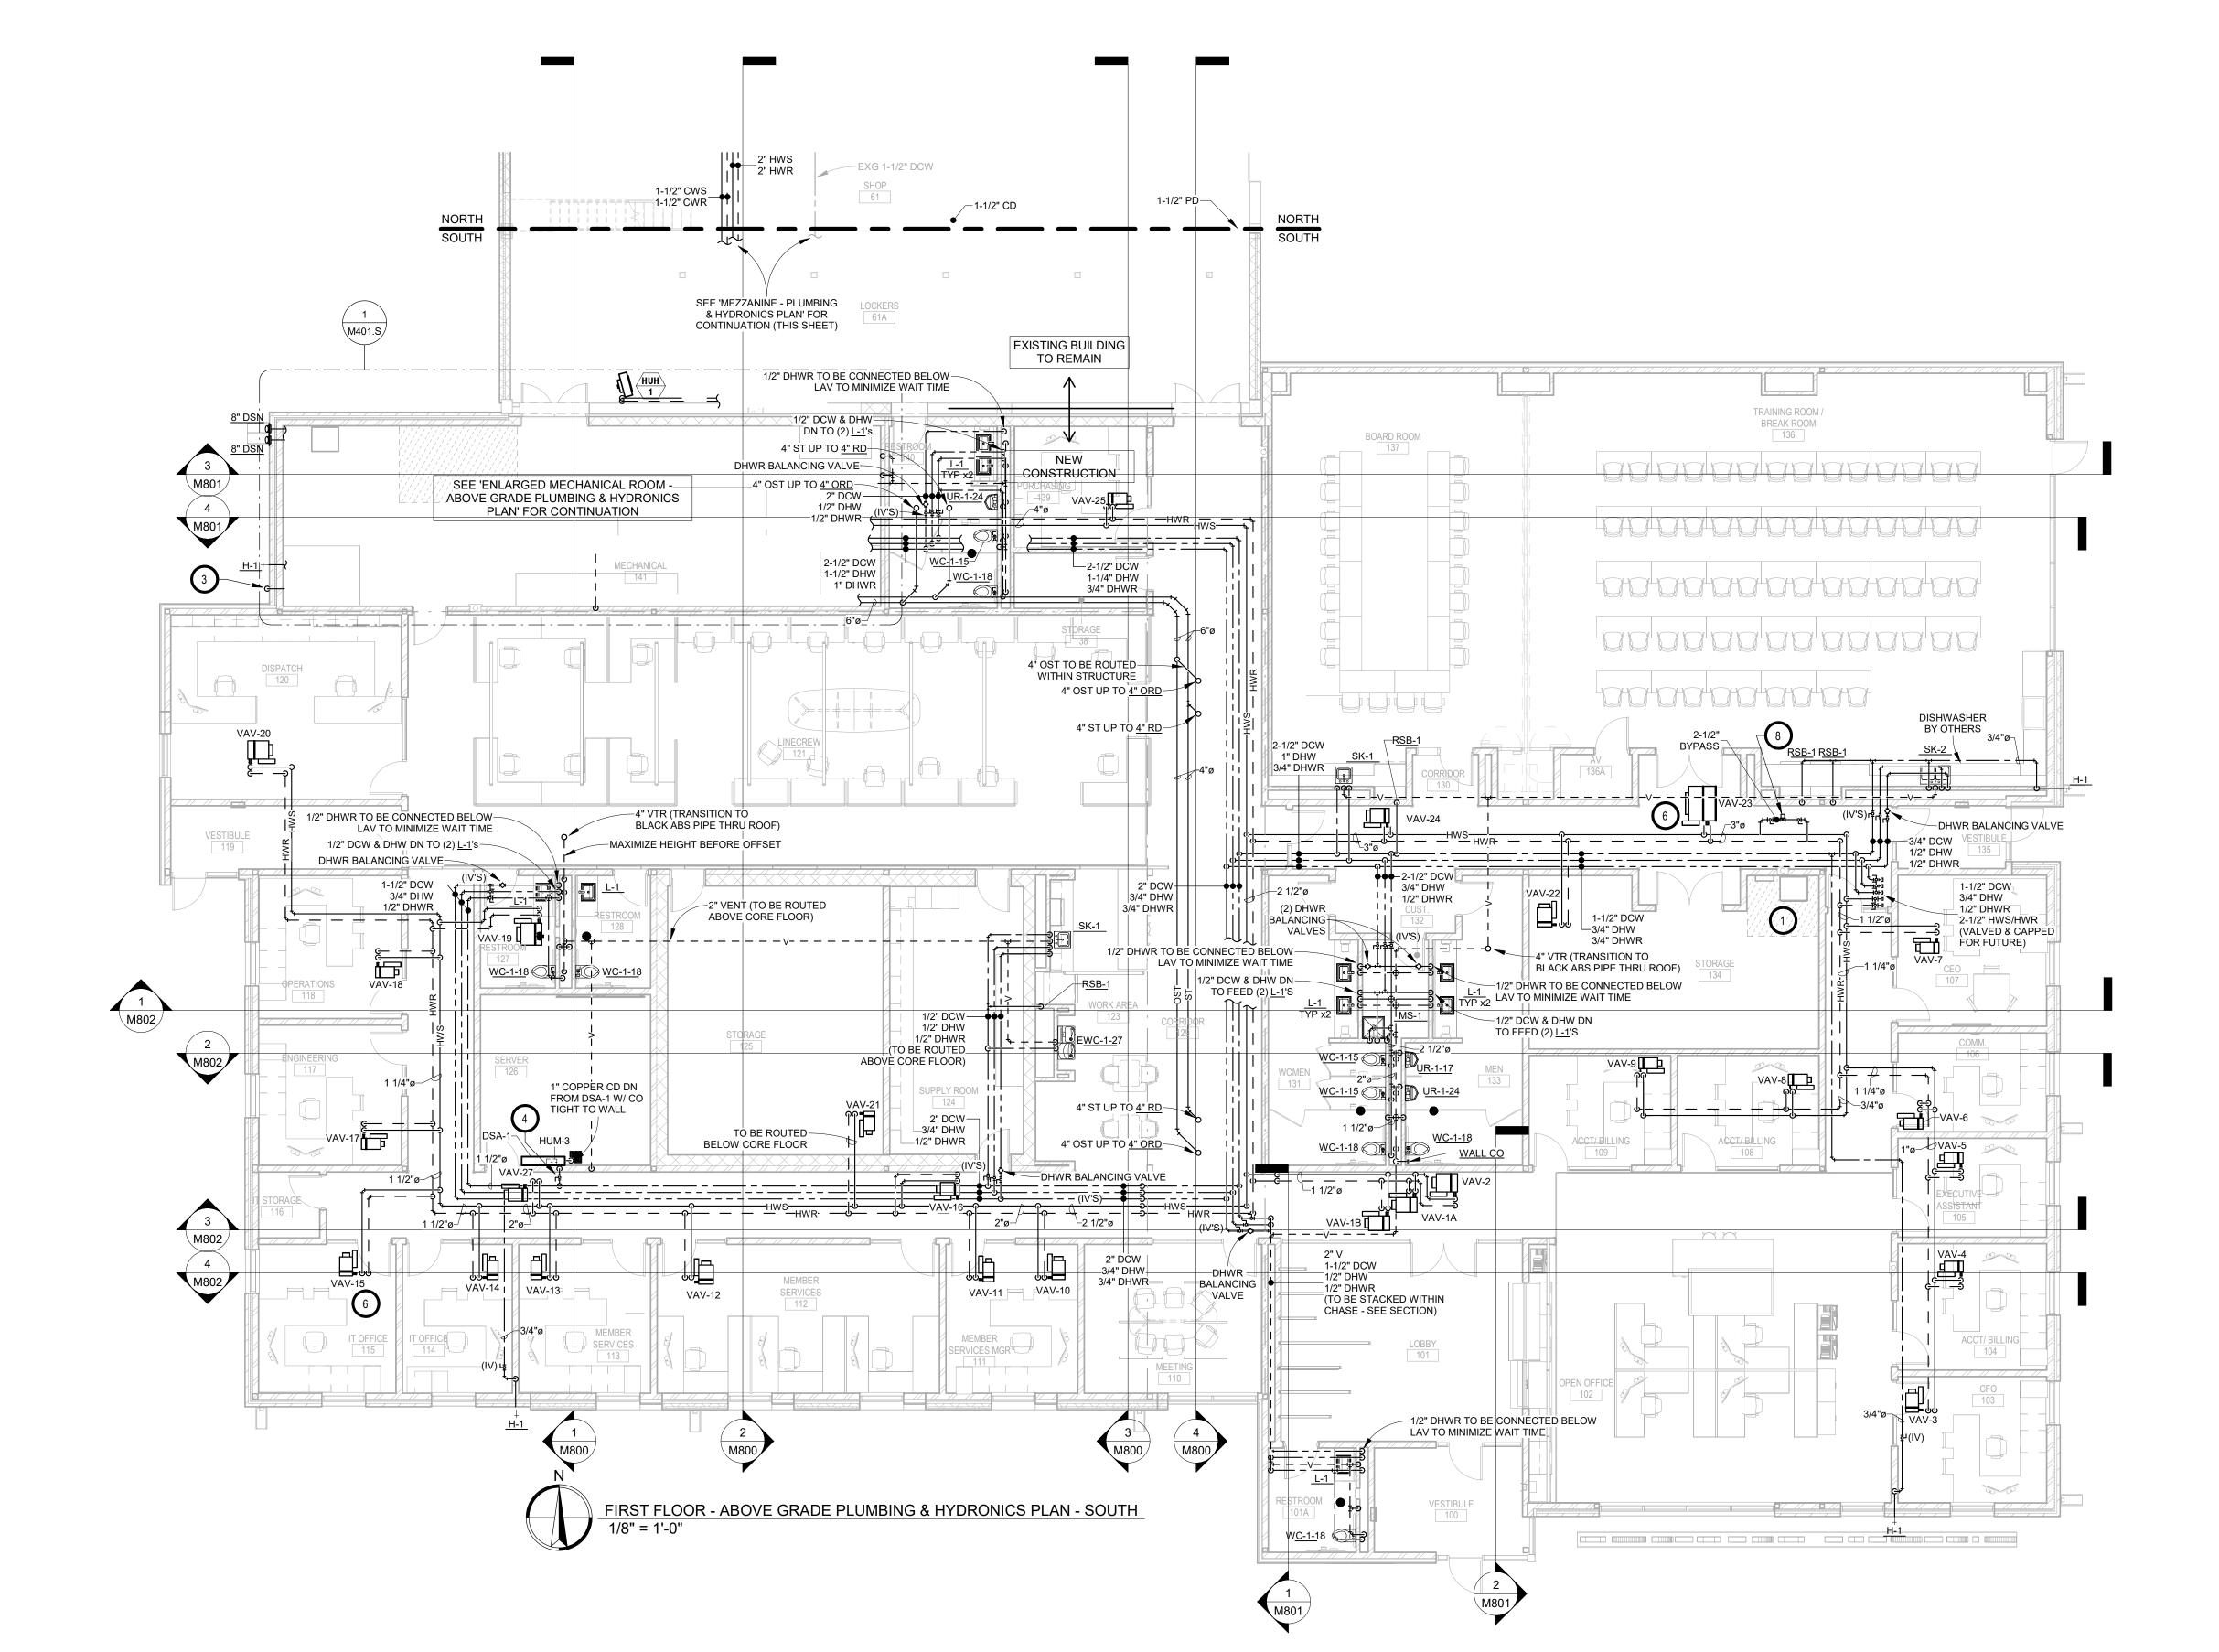

- A. ALL WORK SHALL BE PERFORMED IN A CLEAN AND WORKMANLIKE MANNER.
- B. THE MECHANICAL CONTRACTOR SHALL BE RESPONSIBLE FOR PATCHING ANY OPENINGS LEFT IN FLOORS, WALLS, AND CEILINGS THAT WERE CAUSED BY HIS/HER ACTIONS. PATCHING SHALL MATCH EXISTING SURFACE IN COLOR, TEXTURE AND QUALITY SO THAT PATCH IS INDISTINGUISHABLE FROM ORIGINAL SURFACE.
- C. ALL PENETRATIONS THROUGH DRAFT STOPS AND OTHER FIRE-RATED PARTITIONS SHALL BE FIRE STOPPED AS PER SPECIFICATIONS AND LOCAL CODES.
- D. ALL MECHANICAL WORK SHALL BE INSTALLED IN STRICT ACCORDANCE WITH ALL APPLICABLE LOCAL, STATE, NATIONAL PLUMBING REGULATIONS, AND THE AUTHORITY HAVING JURISDICTION.
- E. THE MECHANICAL DRAWINGS SHOW GENERAL ARRANGEMENT ONLY. EXACT LOCATION SHALL AVOID INTERFERENCE WITH ELECTRICAL EQUIPMENT & REQUIRED ELECTRICAL CLEARANCES.
- REQUIRED ELECTRICAL CLEARANCES.

 F. CONTRACTOR SHALL COORDINATE ALL PLUMBING WITH LIGHT FIXTURES, HVAC, AND STRUCTURAL TO
- G. FRESH AIR INTAKES TO BE MINIMUM 10' FROM ANY EXHAUST TERMINATION.

ACCOMMODATE LIMITED CEILING SPACE.

- H. CONTRACTOR SHALL VISIT THE SITE AND VERIFY ALL EXISTING CONDITIONS AND DIMENSIONS. NOTIFY THE A/E IMMEDIATELY OF ANY DISCREPANCIES.
- I. COORDINATE NEW SERVICES WITH LOCAL UTILITIES.
- J. PLUMBING CONTRACTOR TO PROVIDE VENTING FOR ALL FLOOR DRAINS, TRENCH DRAINS, AND FLOOR SINKS AS SHOWN OR AS REQUIRED BY CODE.
- K. THE MECHANICAL CONTRACTOR IS RESPONSIBLE FOR THE TESTING & CLEANING OF EACH RESPECTIVE SYSTEM IN ACCORDANCE WITH APPLICABLE STATE & LOCAL CODES. TESTS SHALL BE PERFORMED IN THE PRESENCE OF THE AUTHORITY HAVING JURISDICTION. WRITTEN NOTIFICATION OF TEST, DATE, AND RESULTS SHALL BE FURNISHED TO THE ENGINEER BEFORE CONCEALING OR COVERING THE INSTALLATION. TESTS SHALL BE REPEATED UNTIL EACH SYSTEM IS PROVEN ACCEPTABLE.

KEYNOTE

- THIS SPACE IS RESERVED FOR ELECTRICAL GEAR. PIPING AND EQUIPMENT SHALL NOT BE LOCATED IN FRONT OF OR ROUTED ABOVE ELECTRICAL PANELS. COORDINATE WITH DIVISION 26.
- SEE DOMESTIC WATER HEADER & BOOSTER PUMP PIPING DIAGRAM.
- 3. PLUMBING CONTRACTOR TO PROVIDE & INSTALL LAWN IRRIGATION VACUUM BREAKER AT THIS LOCATION, SEE PRESSURE VACUUM BREAKER DETAIL. LAWN IRRIGATION TO BE BY OTHERS. CONTROLLER IN MECHANICAL 141 BY OWNER.
- 4. 1/2" DCW DN TO HUM-3. ISOLATION VALVE TO BE MOUNTED NEXT TO HUM-3 (SHOWN HERE FOR CLARITY)SEE HUMIDIFIER HUM-3 PIPING DETAIL.
- SEE ELECTRIC WATER HEATER CONTROL & PIPING DIAGRAM.
- TYPICAL SEE VAV HEATING COIL PIPING DETAIL.
 ROUTE 2-1/2" CWS/CWR AND 2" HWS/HWR DOWN TO AIR HANDLING UNIT. SEE TYPICAL AHU HEATING COIL PIPING DETAIL AND TYPICAL AHU COOLING COIL PIPING DETAIL
- 8. SEE 2-WAY MODULATING BYPASS VALVE DETAIL.

 9. SEE HUMDIEIER HUM-1 & 2 PIPING DETAIL
- 9. SEE HUMIDIFIER HUM-1 & 2 PIPING DETAIL
- 10. SEE BOILER PIPING DIAGRAM.
- 11. SEE CENTRAL GEOTHERMAL/HEATING/CHILLED WATER SYSTEM CONTROL & PIPING DIAGRAM FOR ADDITIONAL PIPE SIZING.



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SPECIAL NOTES:

- A. ALL MECHANICAL SYSTEMS, EXCLUDING DROPS, TO BE INSTALLED AS HIGH AS POSSIBLE TO PROVIDE MAXIMUM CLEARANCES FOR OWNER.
- B. CONDENSATE PIPING WORK SHALL BE BY VC AND NOT THIS CONTRACTOR. SEE HVAC PLANS SHOWING EXISTING CONDENSATE PIPING.

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PROJECT:
NORTHERN ELECTRIC

ABERDEEN, SOUTH DAKOTA

SHEET TITLE:

ABOVE GRADE PLUMBING &
HYDRONICS PLAN - SOUTH

COOPERATIVE


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NORTH

KEYPLAN

SOUTH


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- F. COORDINATE INSTALLATION OF ALL HVAC WITH PLUMBING, LIGHT FIXTURES, AND STRUCTURE TO ACCOMMODATE LIMITED CEILING SPACE.
- G. FOR SIMPLICITY DUCT INSULATION NOT SHOWN, DUCT SIZES INDICATED ON DRAWING ARE INTERNAL DIMENSIONS. AS NEEDED ADJUST ACTUAL SIZE FOR INSULATION THICKNESS AS SPECIFIED.
- H. ALL FLEXIBLE DUCTWORK AND CONNECTORS
 BETWEEN THE LOW PRESSURE DUCTWORK AND THE
 DIFFUSERS SHALL BE THE SIZE OF THE DIFFUSER
 INLET.
- I. PROVIDE & INSTALL VIBRATION ISOLATION ON ALL HANGING EQUIPMENT. PROVIDE & INSTALL VIBRATION ABSORPTION MOUNTING PADS ON ALL EQUIPMENT MOUNTED ON FLOOR.
- J. PROVIDE AND INSTALL DURODINE FLEX DUCT CONNECTORS AT ALL EQUIPMENT CONNECTIONS.
- K. ALL DUCTWORK TO BE SEALED AIRTIGHT.
- FRESH AIR INTAKES TO BE MINIMUM 10' FROM ANY EXHAUST TERMINATION.

KEYNOTES:

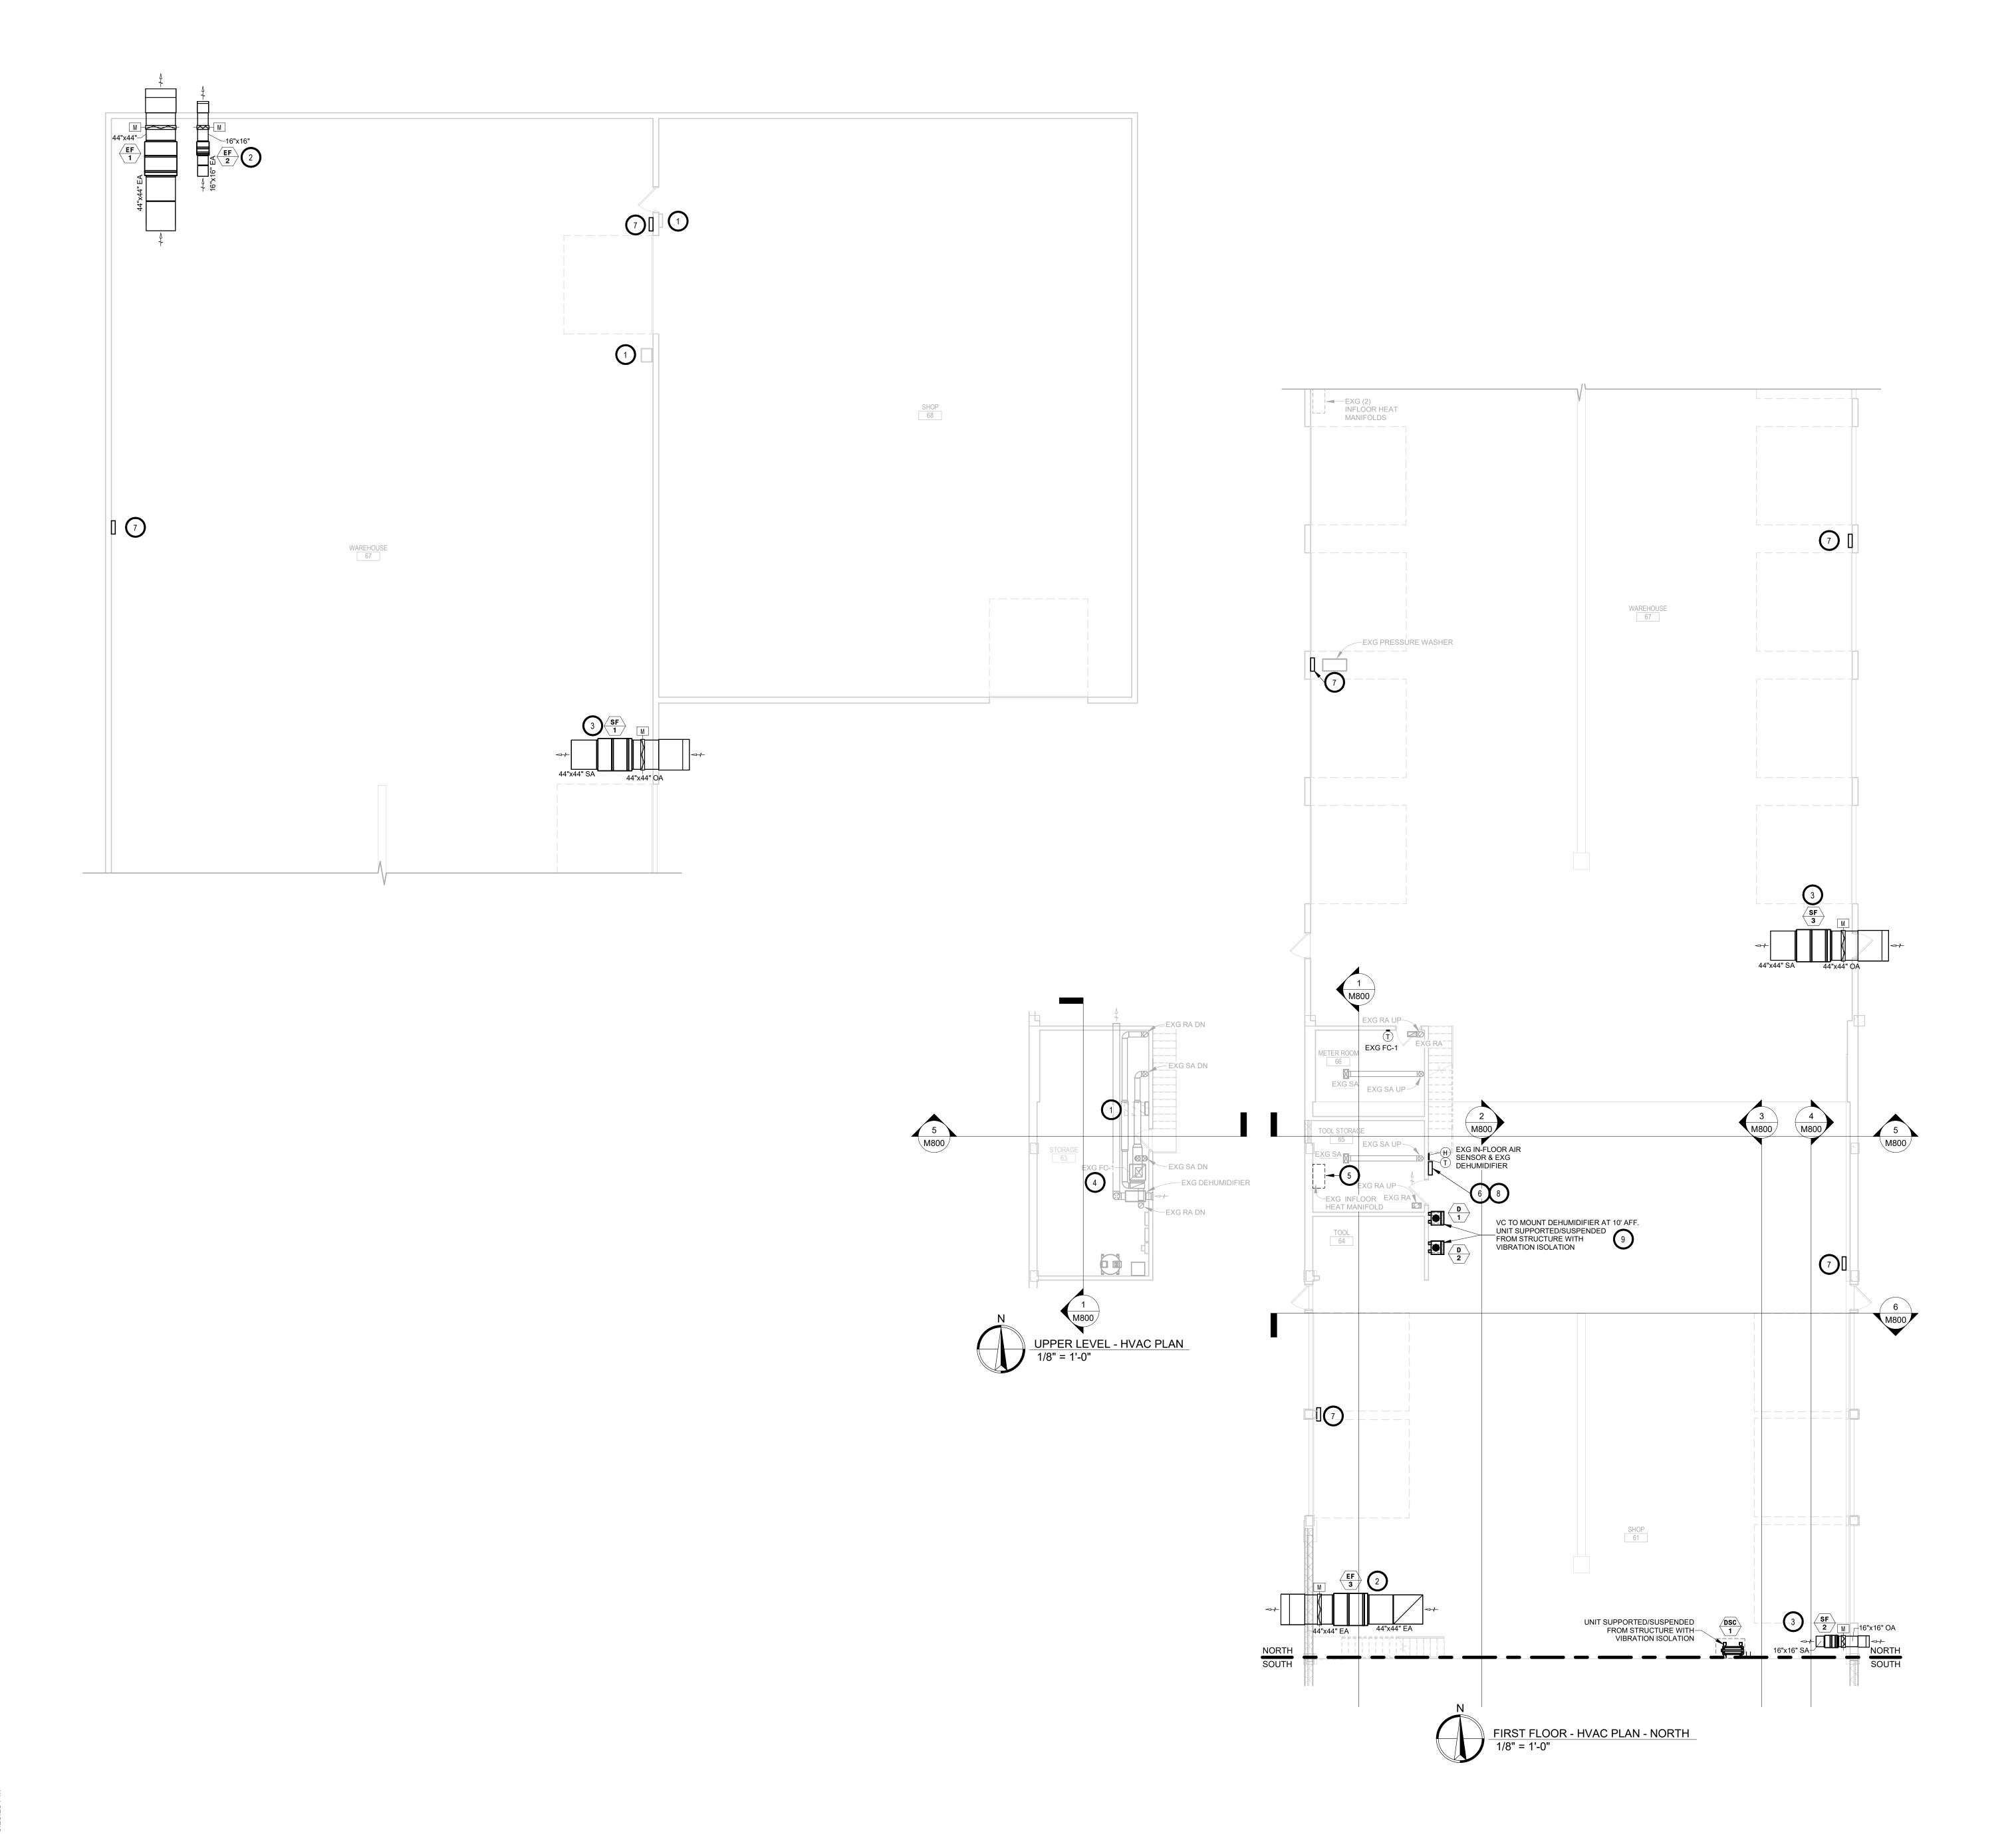- THIS SPACE IS RESERVED FOR ELECTRICAL GEAR. PIPING AND EQUIPMENT SHALL NOT BE LOCATED IN FRONT OF OR ROUTED ABOVE ELECTRICAL PANELS. COORDINATE WITH DIVISION 26.
- 2. TYPICAL VC TO PROVIDE & INSTALL IN-LINE EXHAUST FAN MOUNTED AS HIGH AS POSSIBLE FROM ROOF STRUCTURE. PROVIDE FULL SIZE DUCT WITH ELBOW UP AND EXPANDED METAL SCREEN FOR AIR INLET. PROVIDE & INSTALL FULL SIZE 45 DEGREE HOOD WITH EXPANDED METAL SCREEN ON BUILDING EXTERIOR FOR AIR DISCHARGE. ARCHITECT TO SELECT HOOD COLOR. SEE EXHAUST/SUPPLY FAN SCHEDULE FOR ADDITIONAL REQUIREMENTS.
- 3. TYPICAL VC TO PROVIDE & INSTALL IN-LINE SUPPLY FAN MOUNTED AS HIGH AS POSSIBLE FROM ROOF STRUCTURE. PROVIDE & INSTALL FULL SIZE 90 DEGREE HOOD WITH EXPANDED METAL SCREEN ON BUILDING EXTERIOR FOR AIR INTAKE. ARCHITECT TO SELECT HOOD COLOR. PROVIDE FULL SIZE DUCT WITH EXPANDED METAL SCREEN FOR AIR DISCHARGE. SEE EXHAUST/SUPPLY FAN SCHEDULE FOR ADDITIONAL REQUIREMENTS.
- 4. SEE EXISTING FAN COIL UNIT COIL PIPING DETAIL.
- TC CONTRACTOR TO INSTALL NEW SLAB STAT. UTILIZE EXISTING SLEEVE. SEE SLAB STAT DETAIL.
- TC CONTRACTOR TO PROVIDE & INSTALL BRASCH GDCP-TOUCH N02 & CO GAS DETECTOR CONTROL PANEL. SEE CONTROL SEQUENCES IN SPECIFICATIONS.
- 7. TC CONTRACTOR TO PROVIDE & INSTALL BRASCH GEN2-NCM-REMOTE EXPANSION PACK REMOTE DETECTOR WITH INTEGRAL N02 & CO SENSORS. INSTALL 5'-7" AFF. WHERE INSTALLED BEHIND PALLET RACKING, PROVIDE & INSTALL METAL WIRE SHIELDING CAGE AROUND THE UNIT FOR PROTECTION.
- 8. TC CONTRACTOR TO PROVIDE & INSTALL LIGHTED PILOT SWITCH NEAR MAIN DETECTOR TO OVERRIDE
- VC TO PROVIDE & INSTALL DEHUMIDIFIER D-1 AND D-2. PC TO PIPE CONDENSATE FROM D-1 & D-2 TO EXISTING MOP SINK.



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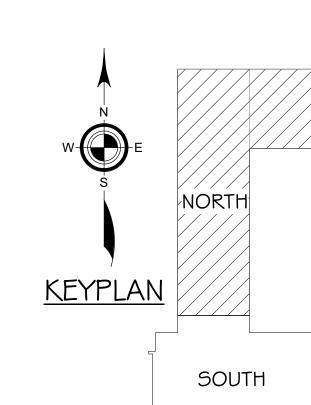
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SPECIAL NOTES:

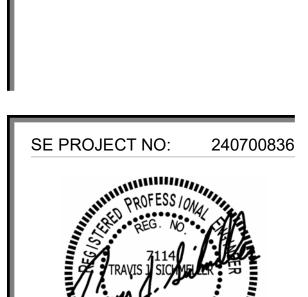
- A. ALL MECHANICAL SYSTEMS, EXCLUDING DROPS, TO BE INSTALLED AS HIGH AS POSSIBLE TO PROVIDE MAXIMUM CLEARANCES FOR OWNER.
- B. ALL TRANSFERS TO BE 12"x12", UNLESS OTHERWISE NOTED.





PROJECT:
NORTHERN ELECTRIC
COOPERATIVE
ABERDEEN, SOUTH DAKOTA

SHEET TITLE: HVAC PLAN - NORTH

M500.N

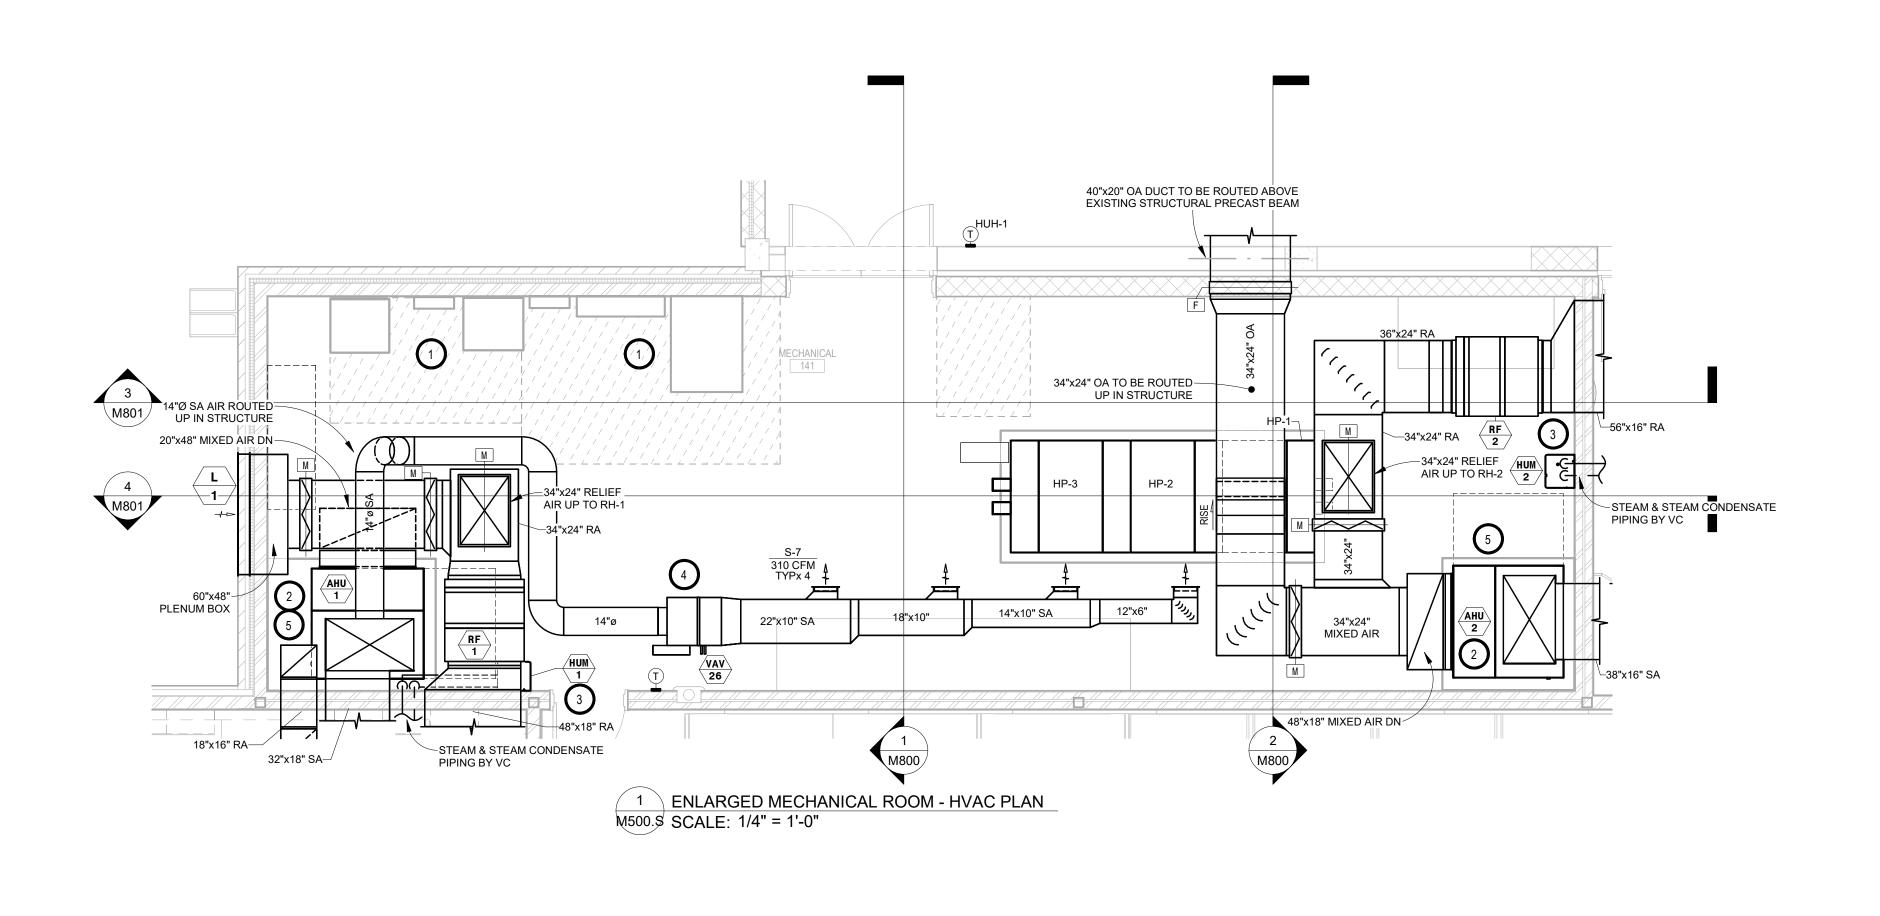

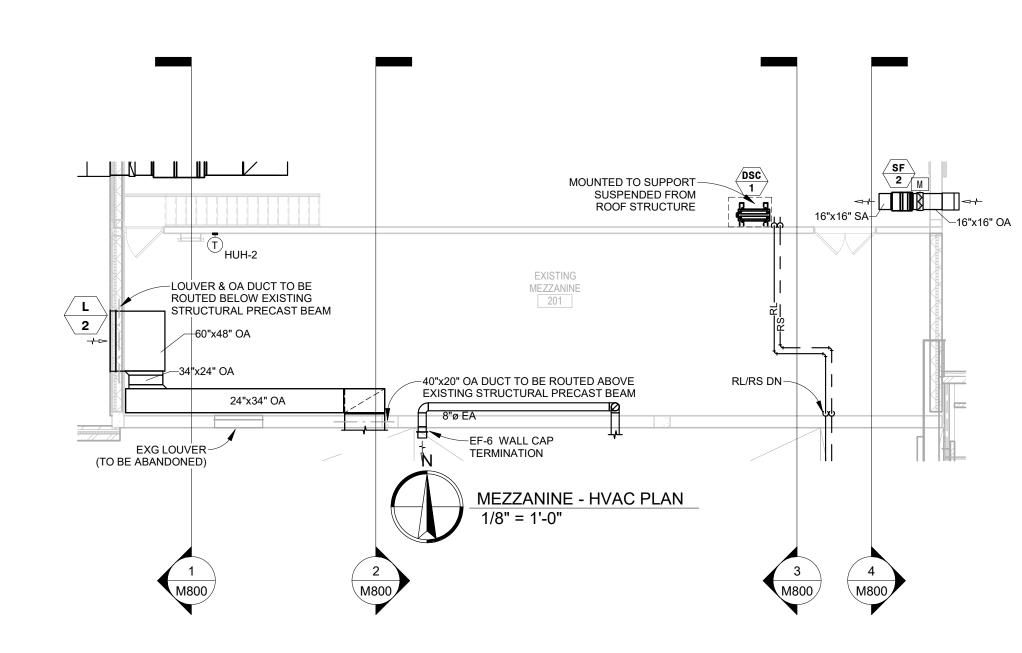

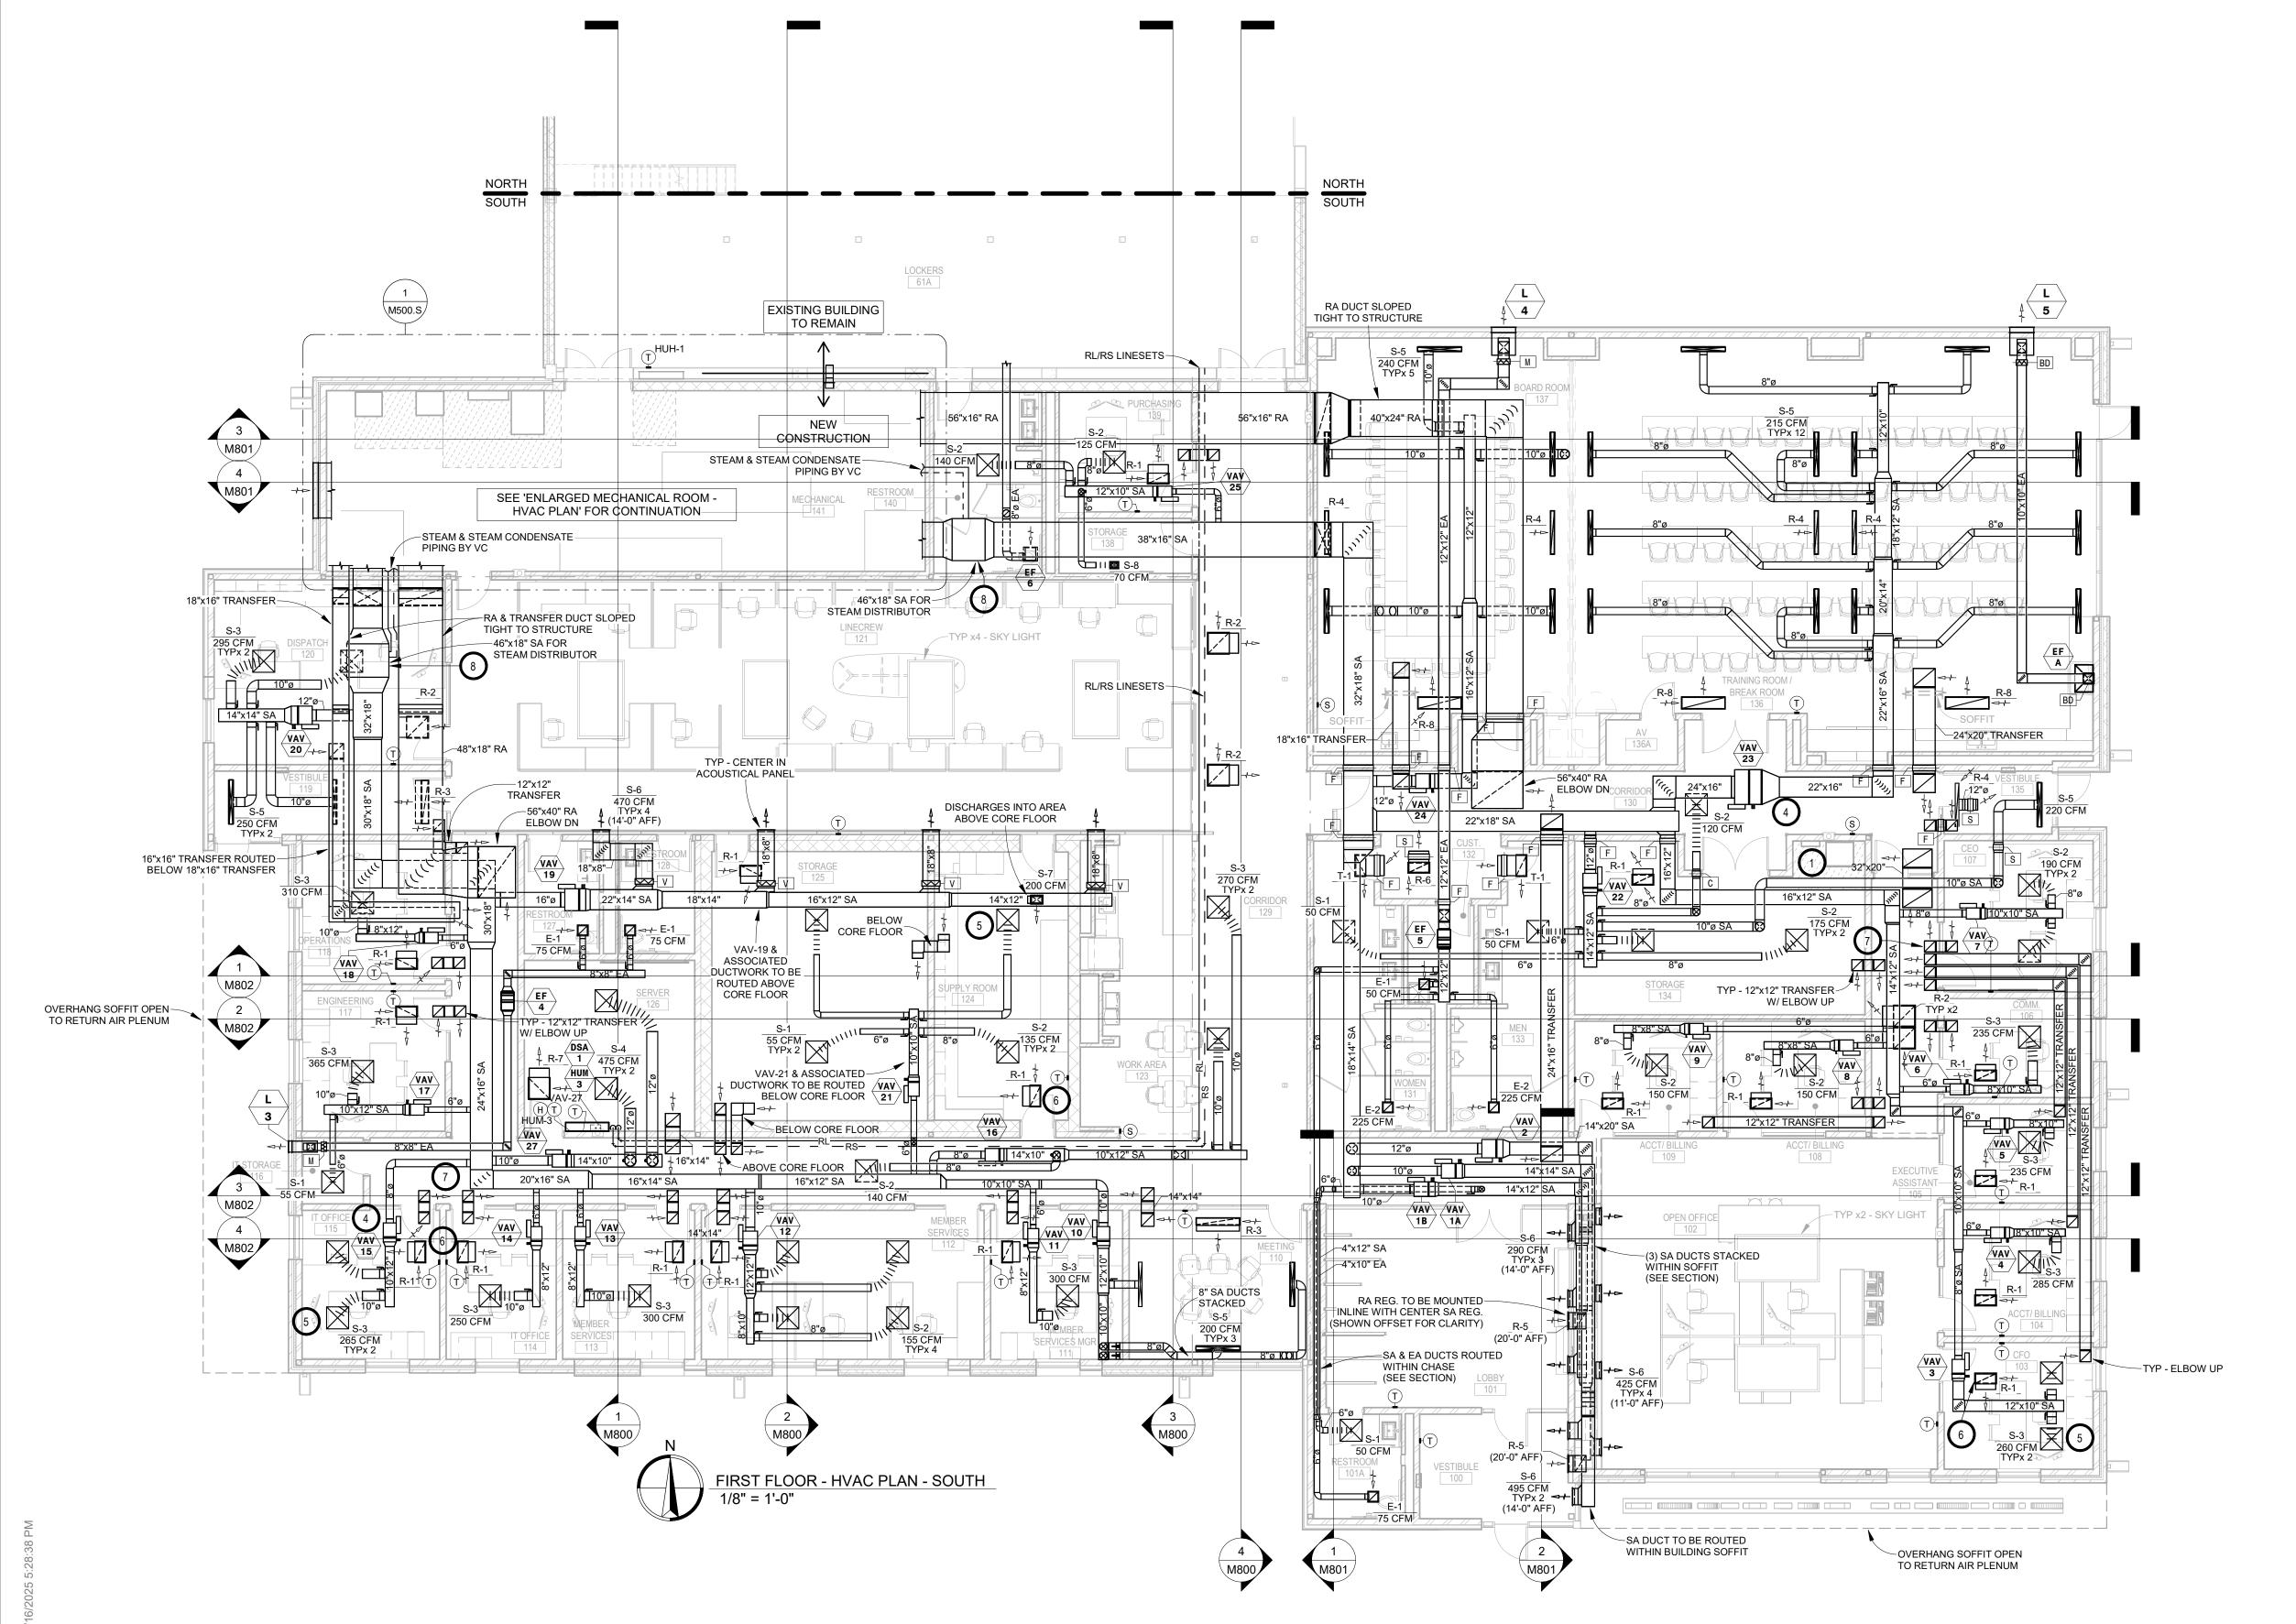

- A. ALL WORK SHALL BE PERFORMED IN A CLEAN AND WORKMANLIKE MANNER.
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- AUTHORITY HAVING JURISDICTION.

 E. THE MECHANICAL DRAWINGS SHOW GENERAL ARRANGEMENT ONLY. EXACT LOCATION SHALL AVOID
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 F. COORDINATE INSTALLATION OF ALL HVAC WITH PLUMBING, LIGHT FIXTURES, AND STRUCTURE TO
- G. FOR SIMPLICITY DUCT INSULATION NOT SHOWN, DUCT SIZES INDICATED ON DRAWING ARE INTERNAL DIMENSIONS. AS NEEDED ADJUST ACTUAL SIZE FOR INSULATION THICKNESS AS SPECIFIED.

ACCOMMODATE LIMITED CEILING SPACE.

- H. ALL FLEXIBLE DUCTWORK AND CONNECTORS
 BETWEEN THE LOW PRESSURE DUCTWORK AND THE
 DIFFUSERS SHALL BE THE SIZE OF THE DIFFUSER
 INLET.
- I. PROVIDE & INSTALL VIBRATION ISOLATION ON ALL HANGING EQUIPMENT. PROVIDE & INSTALL VIBRATION ABSORPTION MOUNTING PADS ON ALL EQUIPMENT
- J. PROVIDE AND INSTALL DURODINE FLEX DUCT CONNECTORS AT ALL EQUIPMENT CONNECTIONS.
- K. ALL DUCTWORK TO BE SEALED AIRTIGHT.

MOUNTED ON FLOOR.

 FRESH AIR INTAKES TO BE MINIMUM 10' FROM ANY EXHAUST TERMINATION.

KEYNOTES:

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- VC TO PROVIDE & INSTALL VERTICAL AIR HANDLING UNIT SET ON CONCRETE EQUIPMENT PAD BY GC.
- 3. VC TO PROVIDE & INSTALL WALL MOUNTED ELECTRIC STEAM HUMIDIFIER SYSTEM. ROUTE/INSTALL ALL STEAM, STEAM CONDENSATE AND DRAINAGE TO FLOOR SINK AS PER THE MANUFACTURER'S INSTRUCTIONS (GENERAL ROUTING SHOWN) FOR A COMPLETE AND OPERATING SYSTEM. VC TO PROVIDE WATER FILTER, PC TO INSTALL.

4. TYPICAL - SEE VAV BOX DUCT CONNECTION DETAIL.

- 5. TYPICAL SEE TYPICAL DIFFUSER CONNECTION
- 6. TYPICAL SEE INSULATED RETURN ELBOW DETAIL.
- 7. TYPICAL SEE INSULATED TRANSFER DUCT DETAIL.
- 8. SEE HUMIDIFIER DISTRIBUTOR & CONDENSATE DRAIN DETAIL.
 9. TYPICAL POURED 4" HIGH CONCRETE HOUSEKEEPING PADS BY GC. MECHANICAL

CONTRACTORS TO COORDINATE EXACT SIZE AND



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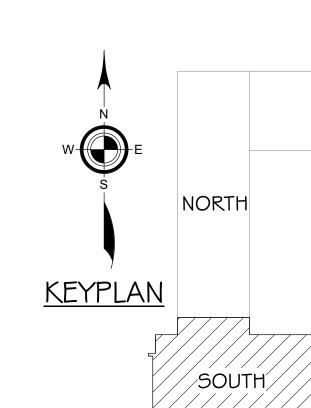
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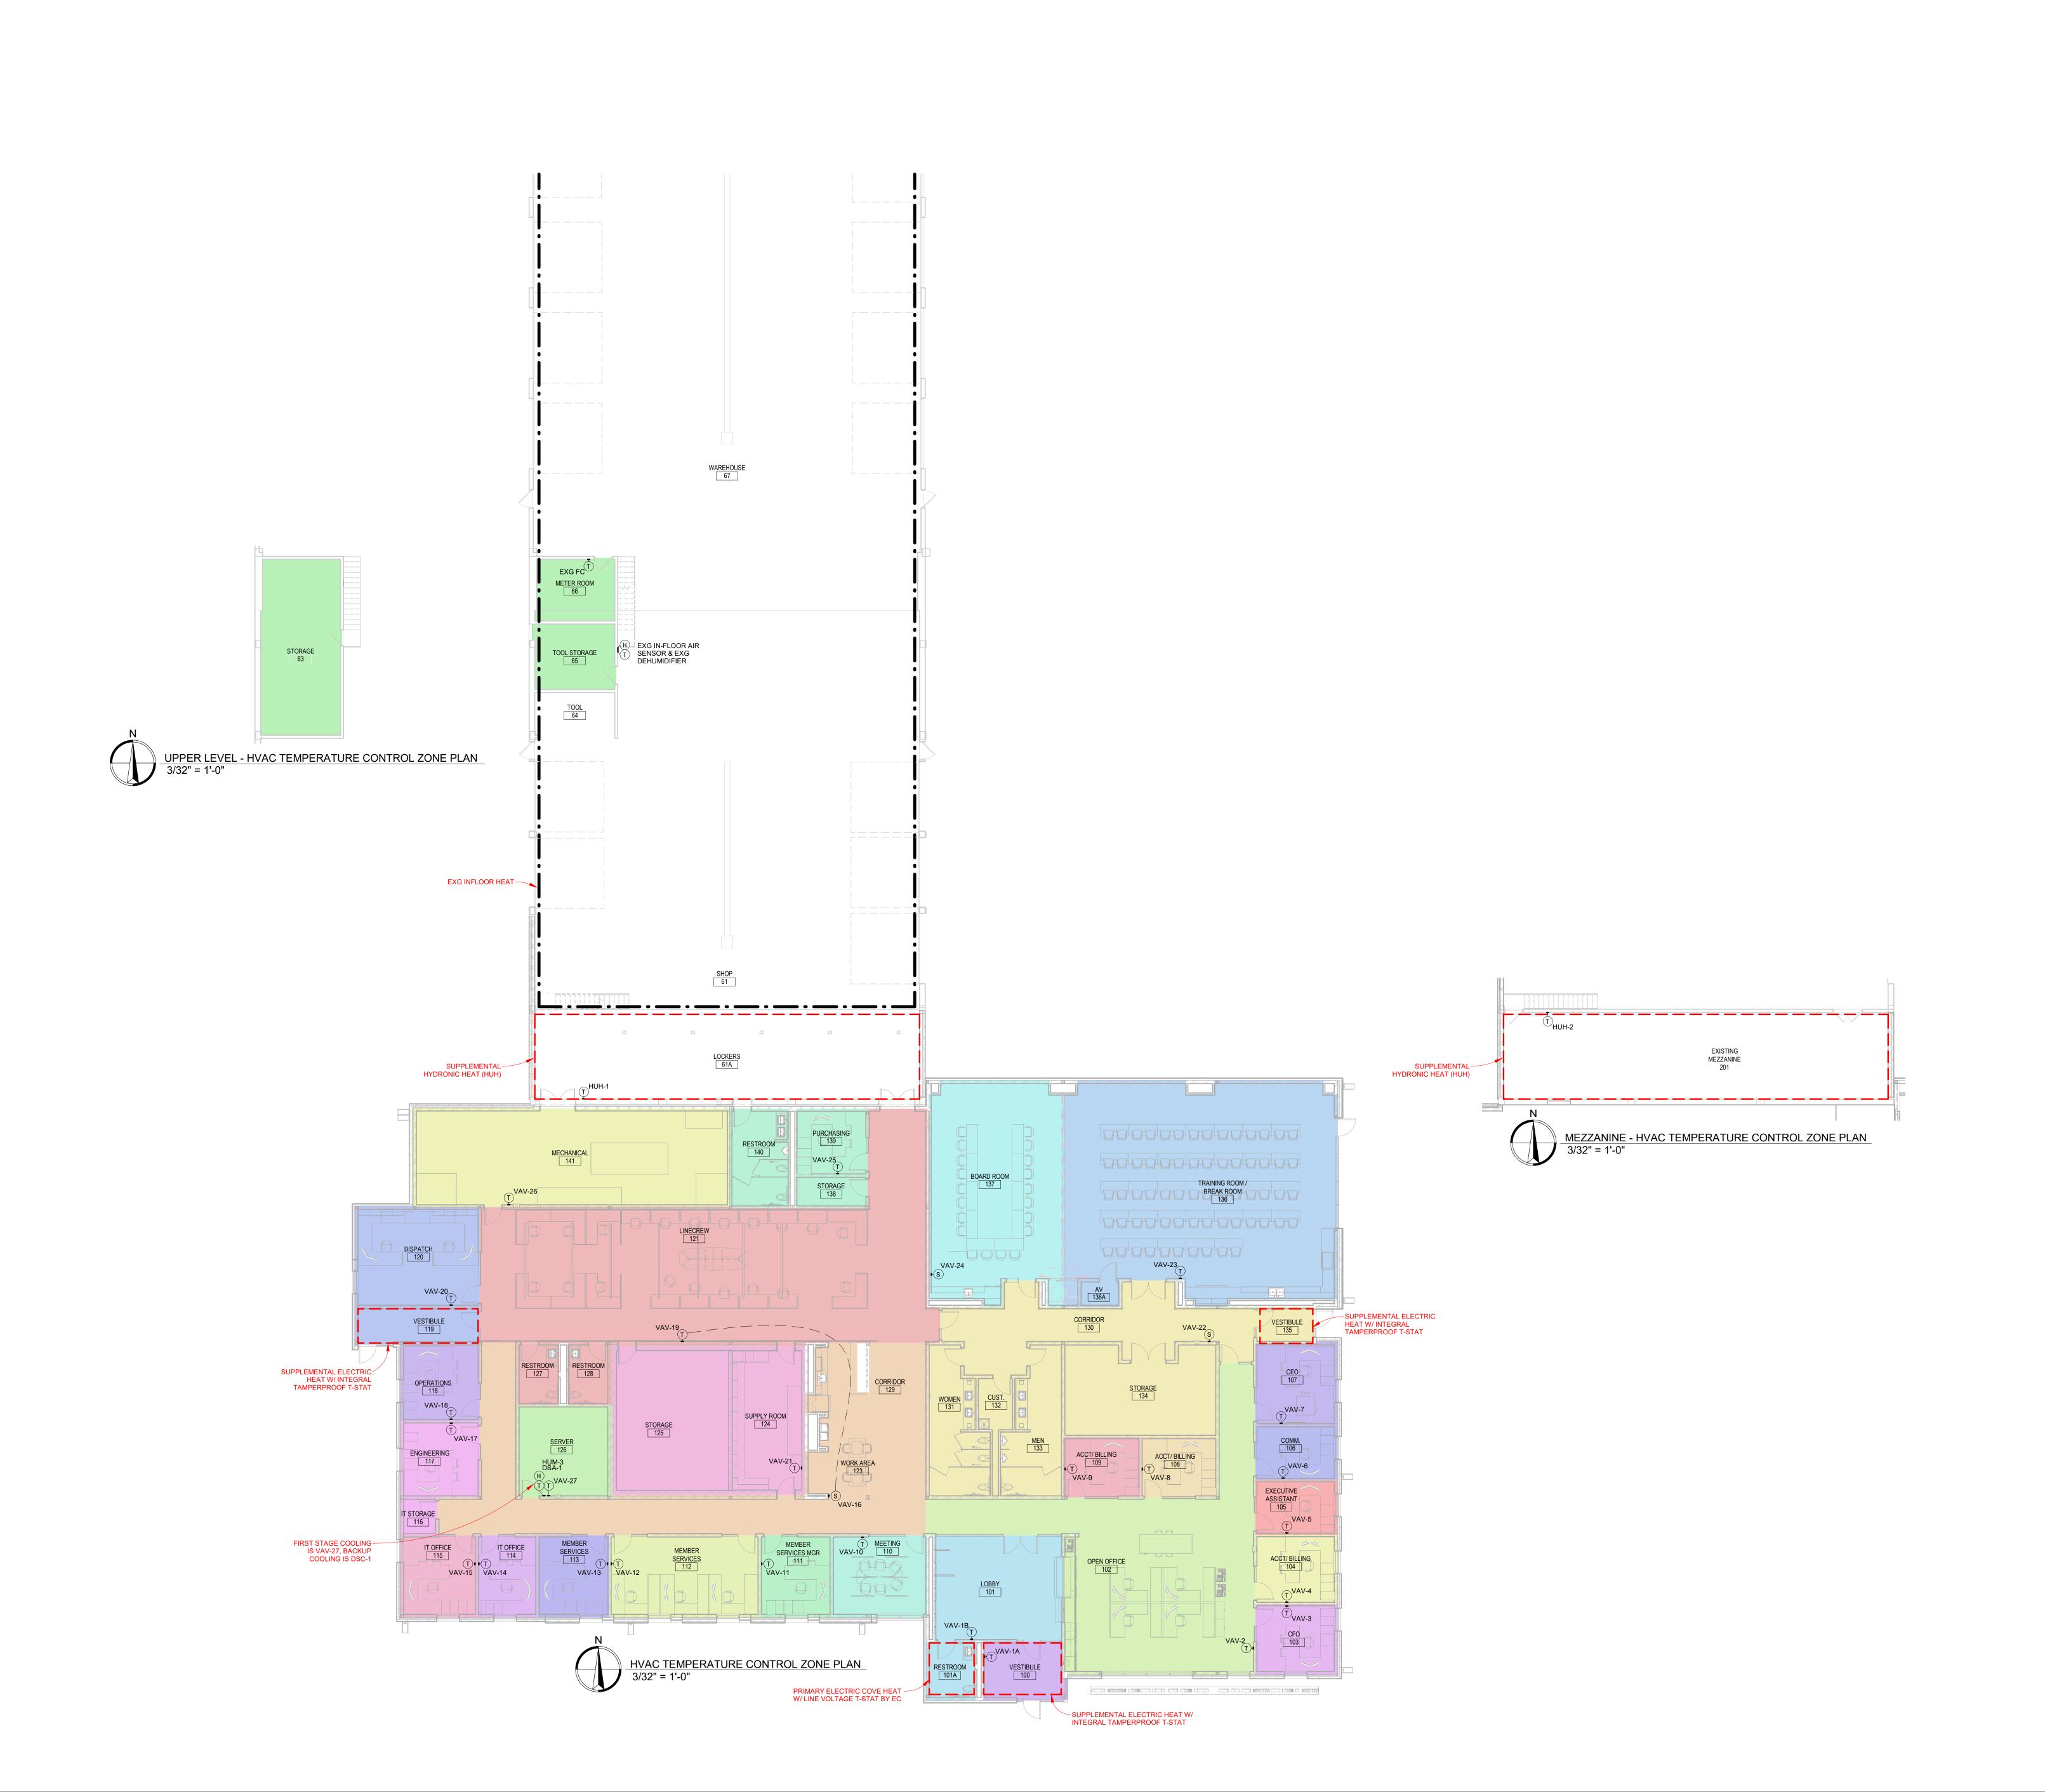



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ABERDEEN, SOUTH DAKOTA

SHEET TITLE:
HVAC PLAN - SOUTH

ISSUE:

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ABERDEEN, SOUTH DAKOTA

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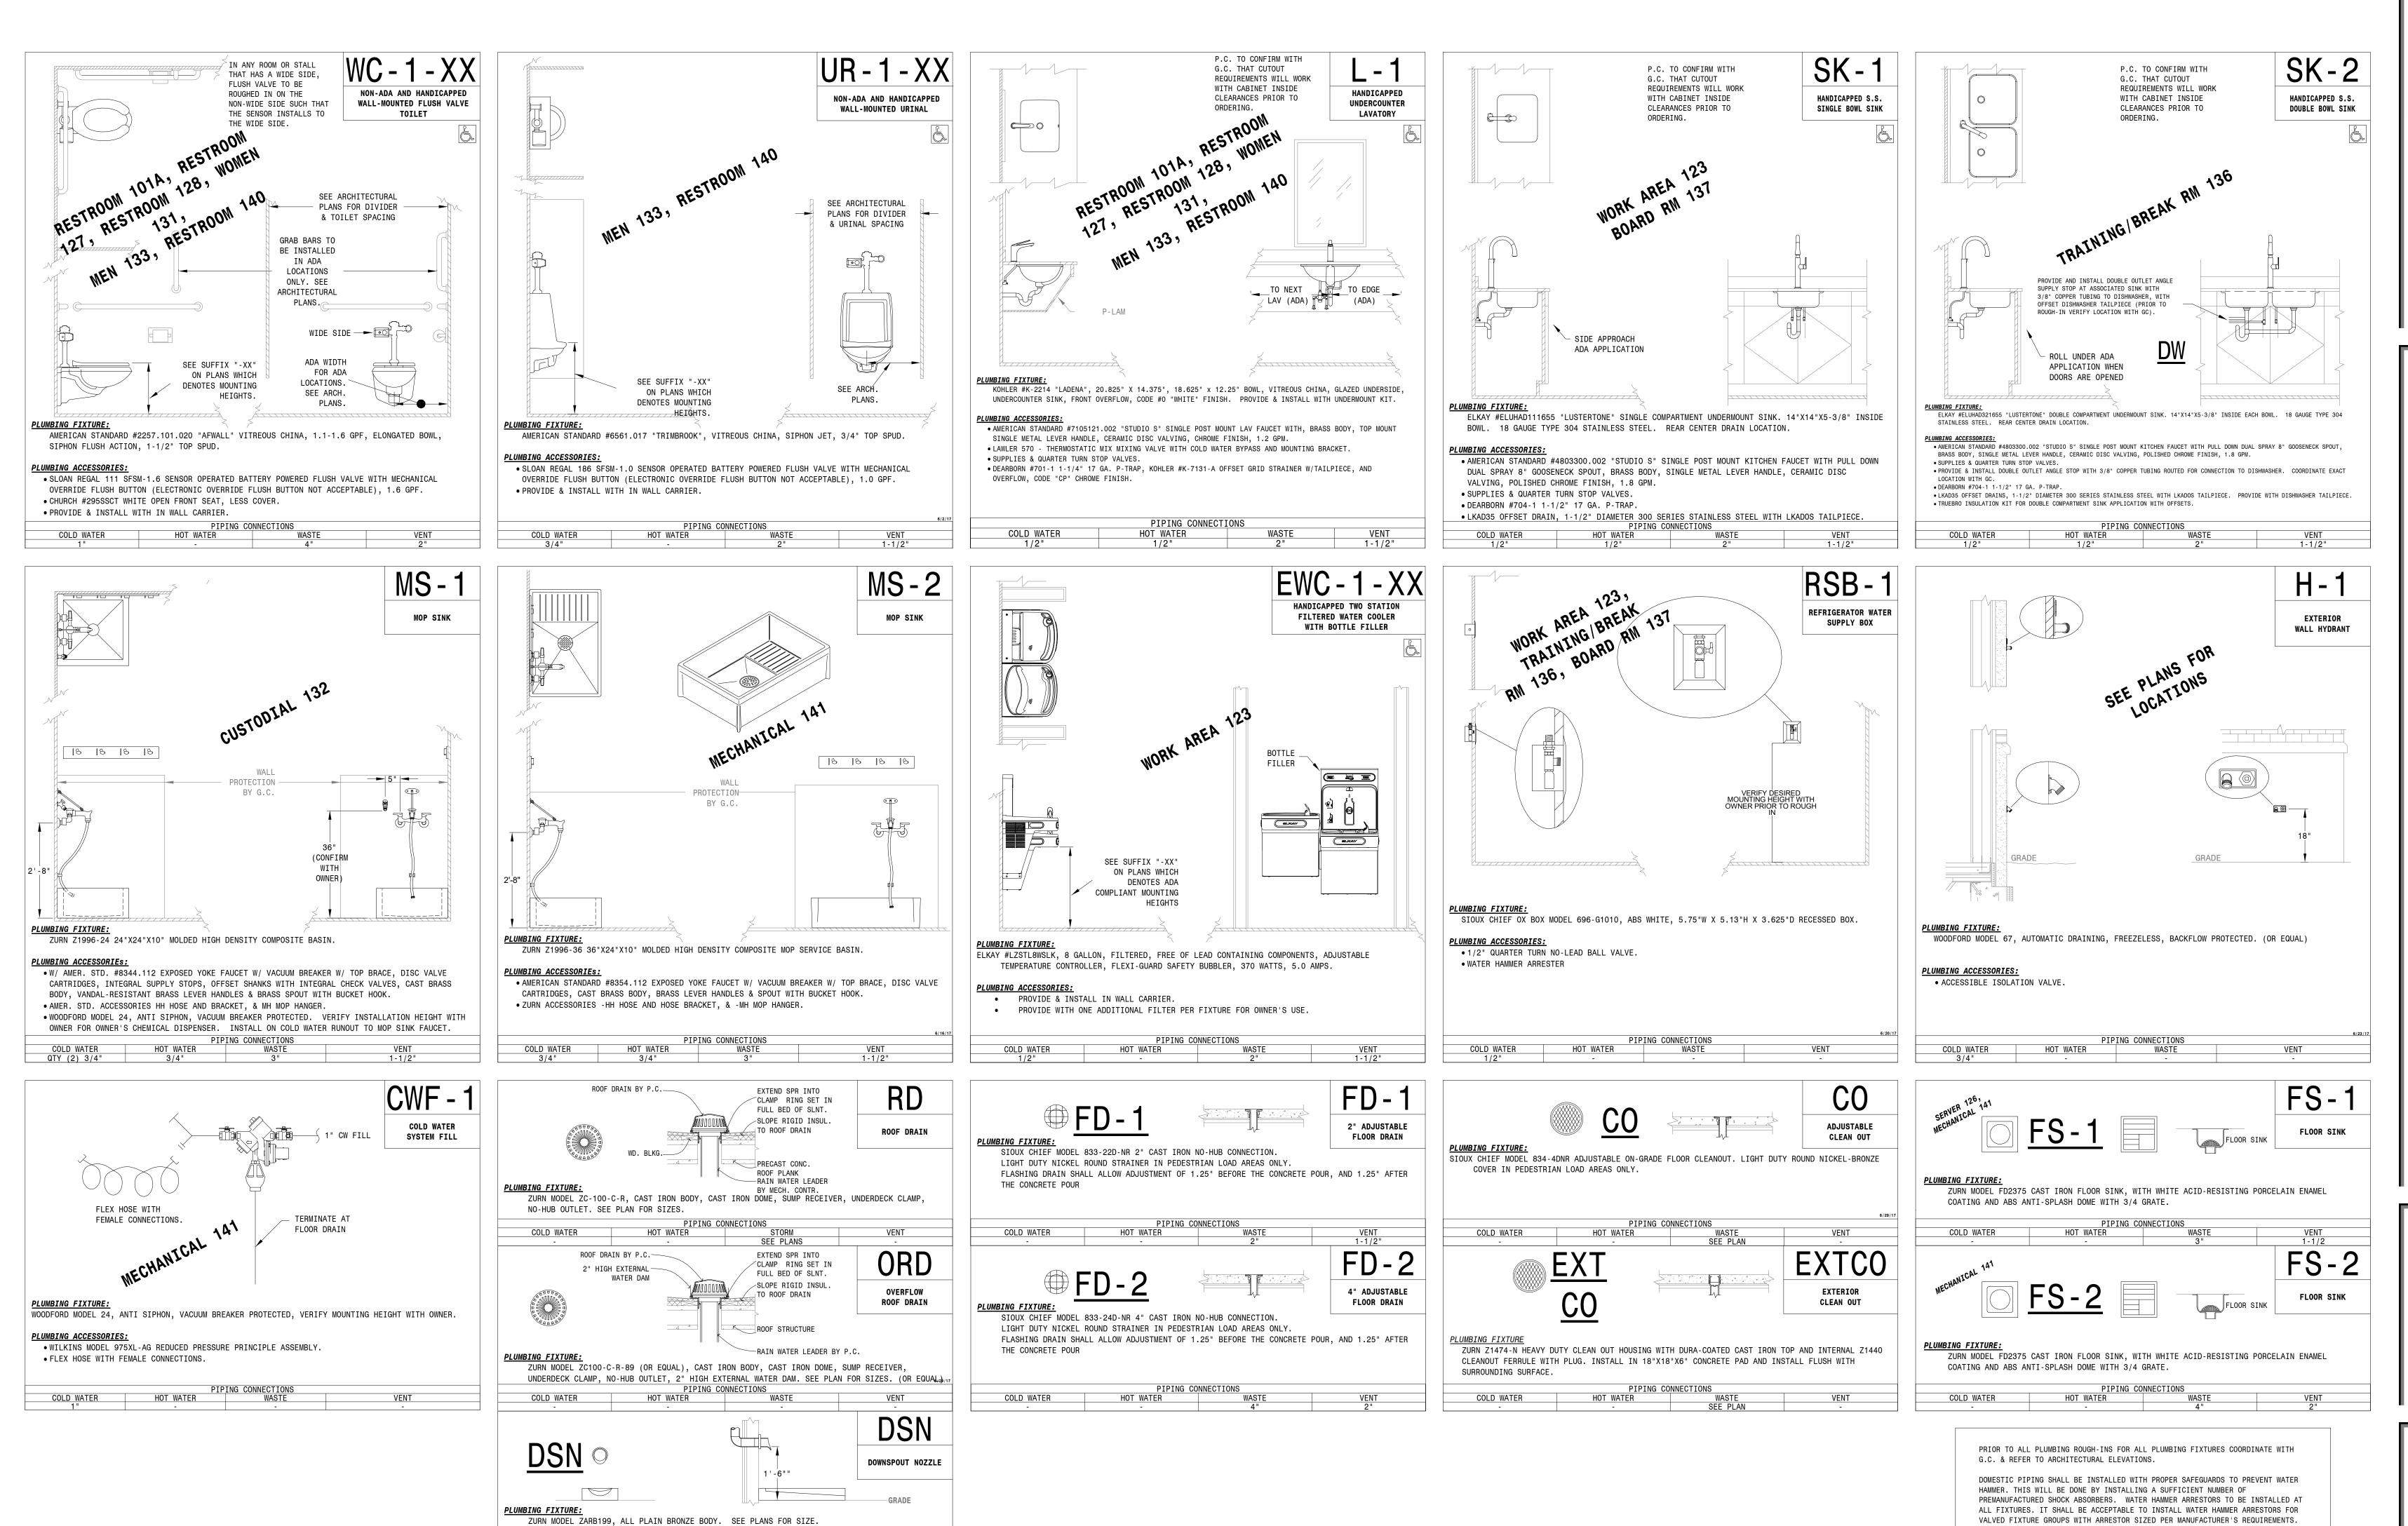
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SOUTH

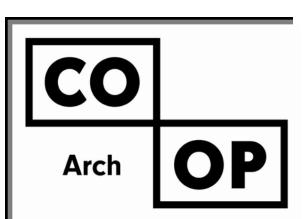SHEET TITLE:

HVAC TEMPERATURE

CONTROL ZONE PLAN



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SHOCK ABSORBERS SHALL BE WATTS OR EQUAL. EXACT MODEL TO BE INSTALLED PER


MANUFACTURER'S INSTALLATION INSTRUCTIONS.

PROJECT: NORTHERN ELECTRIC COOPERATIVE ABERDEEN, SOUTH DAKOTA


SHEET TITLE: PLUMBING FIXTURE SCHEDULE

PLUMBING ACCESSORIES:

CONCRETE SPLASH BLOCK BY PC

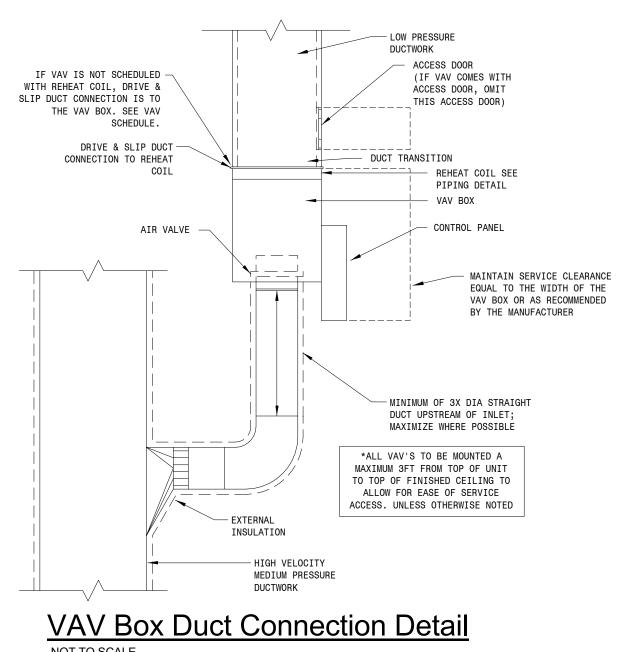




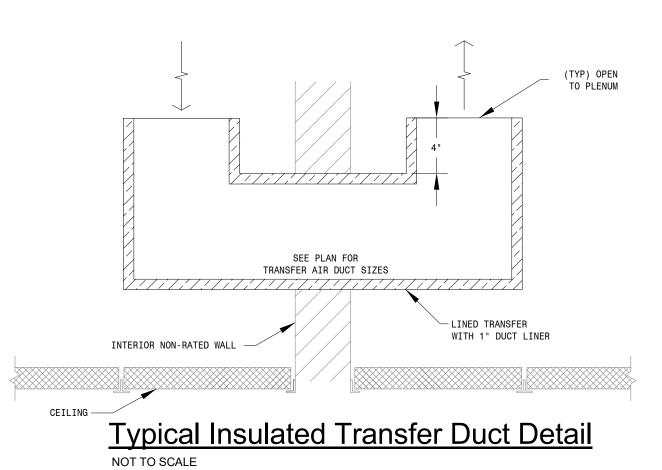


Stationary Louver Detail

SOLDERED WATERTIGHT

SLOPE FINAL 6" OF ADJACENT -DUCT TO LOUVER AND SEAL BOTTOM 3" WATERTIGHT

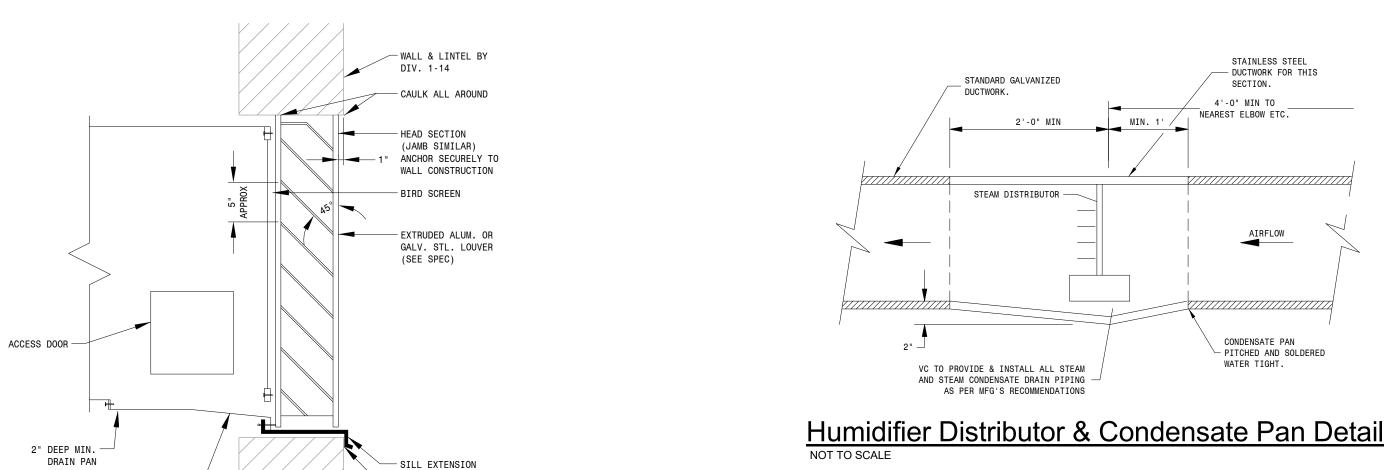

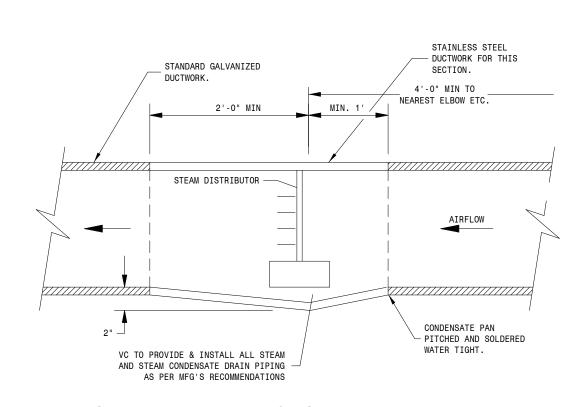

NOT TO SCALE

DUCT SUPPORT HANGER —

CEILING DIFFUSER

Typical Diffuser Connection Detail

FLEX DUCT MAX. 6'-0"

FLEX DUCT SIZE SHALL

MATCH NECK SIZE

OPPOSED BLADE

DAMPER

45° OR 90° ELBOW

WITH INSULATED FLEX

DUCT STRETCHED OVER

CEILING \neg


ENTIRE PIPE


RETANGULAR


SUPPLY DUCT


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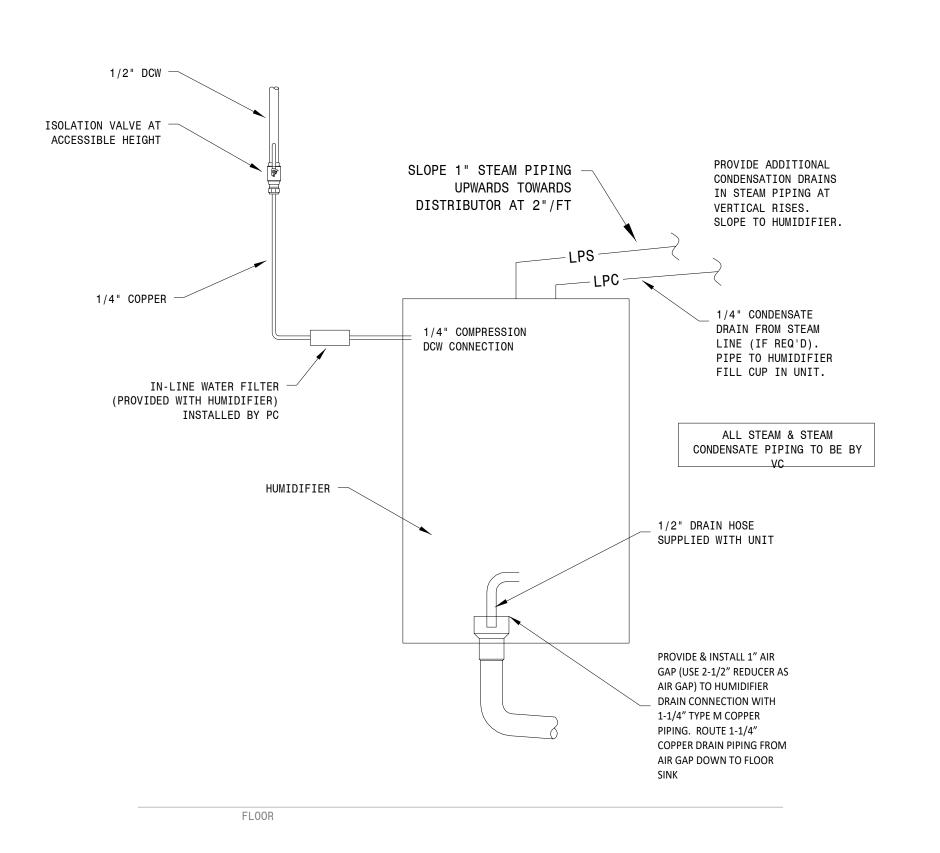
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PROJECT: NORTHERN ELECTRIC COOPERATIVE ABERDEEN, SOUTH DAKOTA

SHEET TITLE: MECHANICAL DETAILS - 1 OF 4

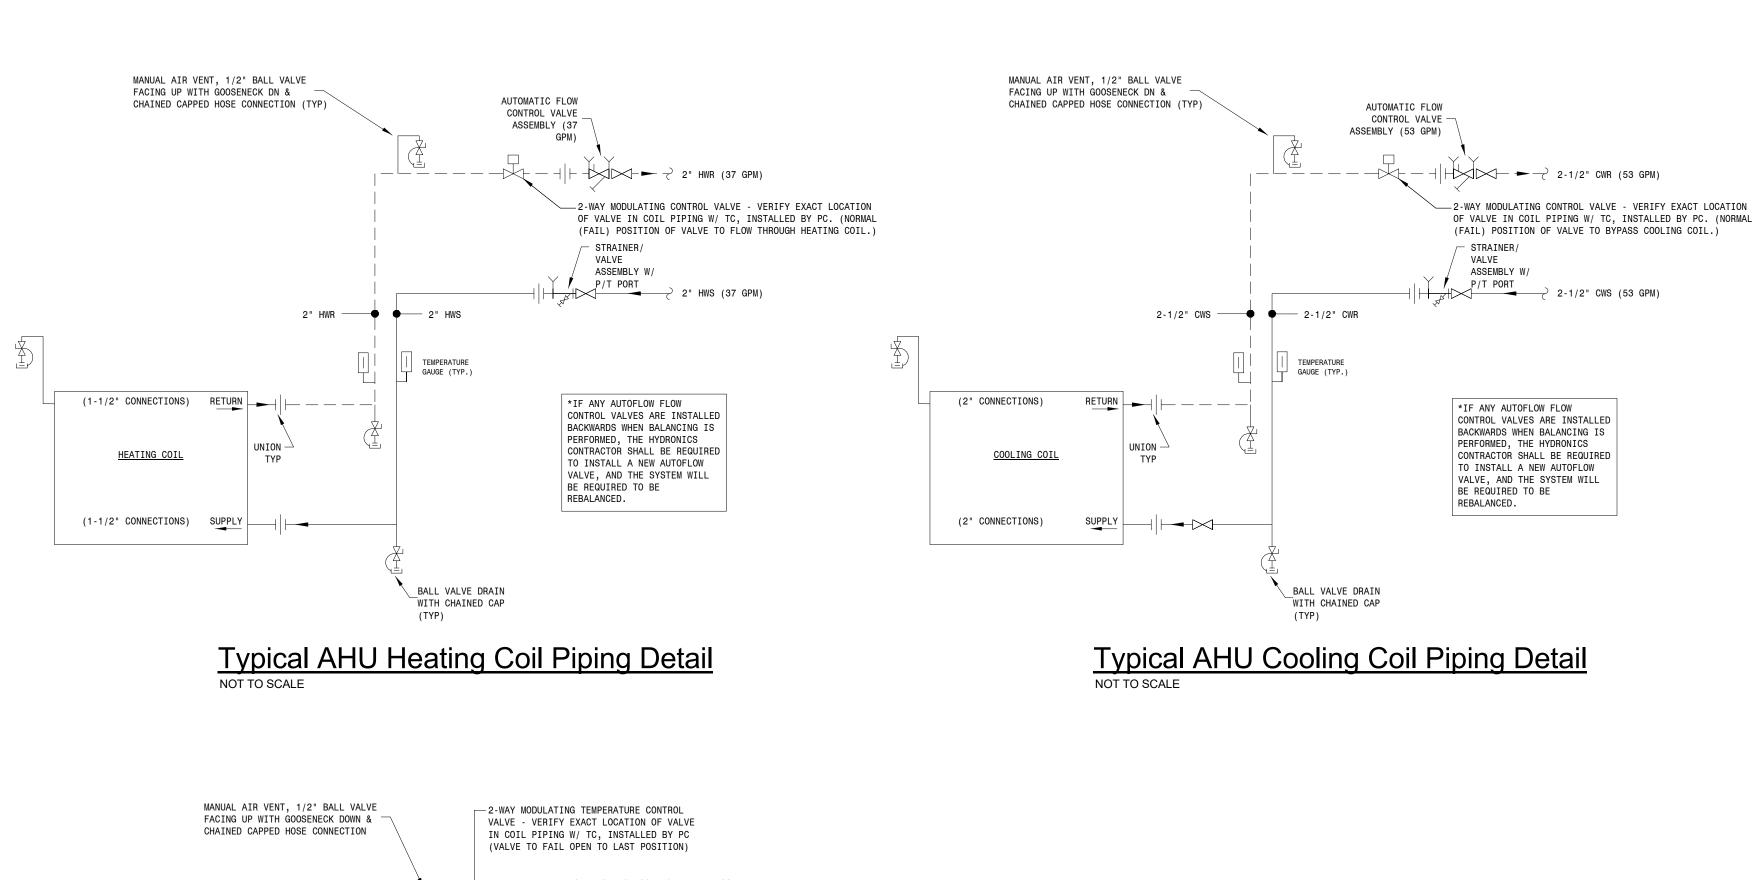

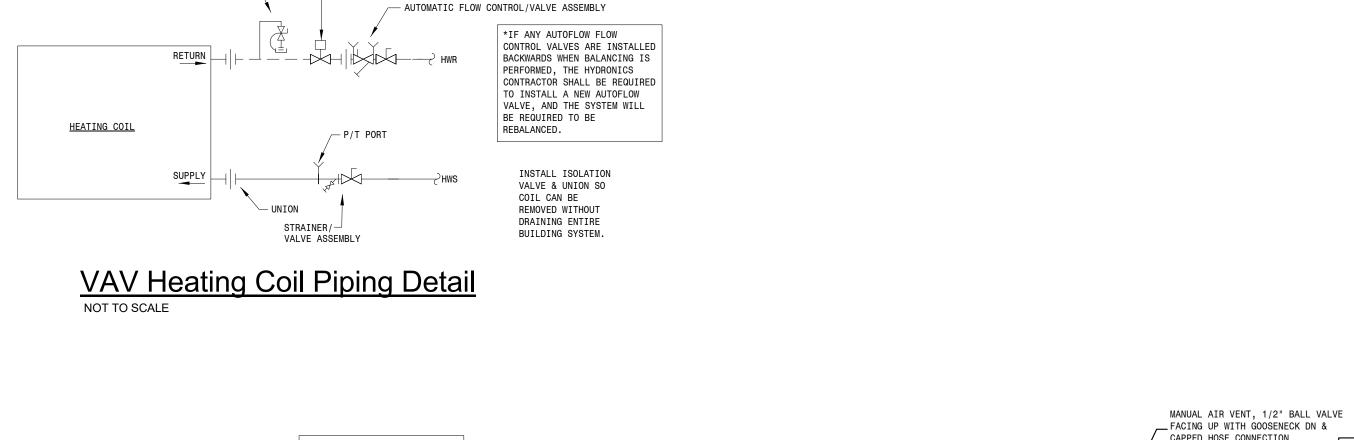SLOPE STEAM PIPING
UPWARDS TOWARDS
DISTRIBUTOR AT
2"/FT

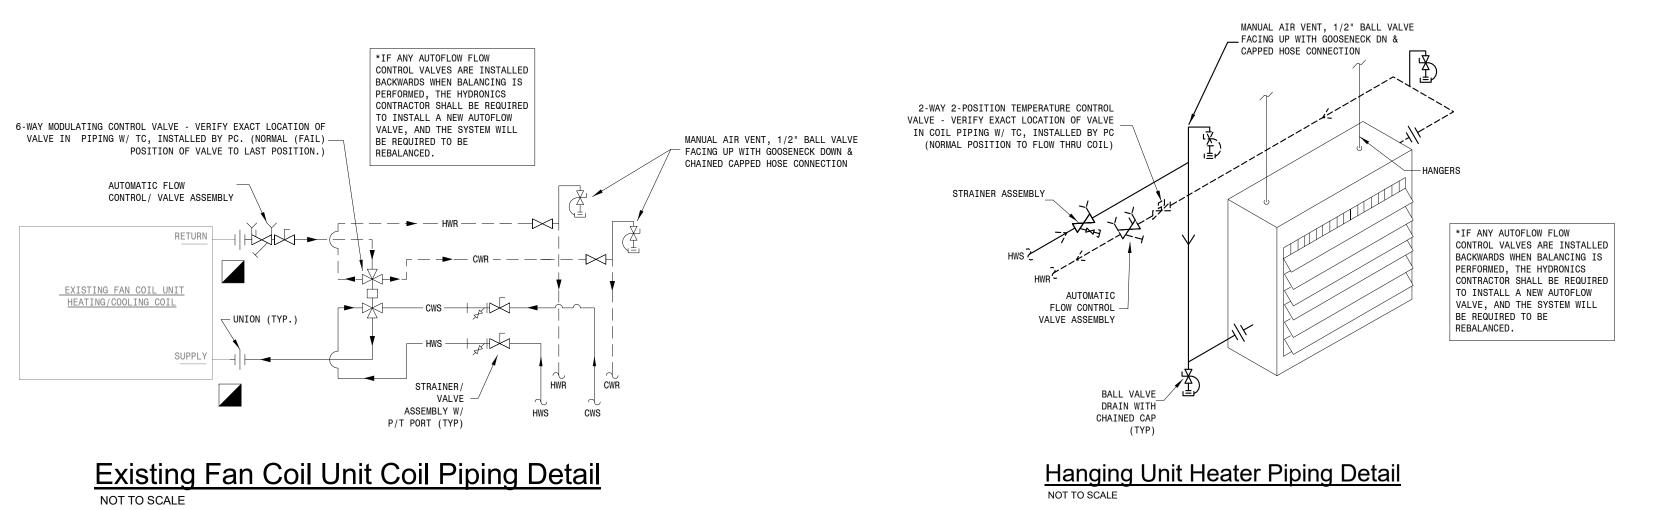1" LPS

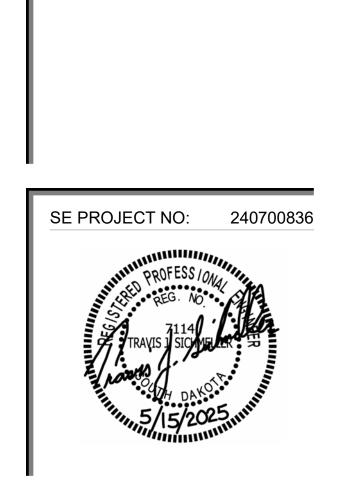1/4" LPC

MANIFOLD SUPPORT

SLOPE CONDENSATE PIPING
DOWNWARDS AT 1IN PER
4FT

ALL STEAM & STEAM
CONDENSATE PIPING TO BE BY

1/4" CONDENSATE TO DRAIN

Steam Humidifier Piping Detail


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1/2" DCW -ISOLATION VALVE AT — ACCESSIBLE HEIGHT 1/4" COPPER -1/4" COMPRESSION DCW CONNECTION IN-LINE WATER FILTER — (PROVIDED WITH HUMIDIFIER) INSTALLED BY PC HUMIDIFIER W/ -INTEGRAL BLOWER _ 1/2" DRAIN HOSE SUPPLIED WITH UNIT ALL STEAM & STEAM CONDENSATE PIPING TO BE BY PROVIDE & INSTALL 1" AIR GAP (USE 2-1/2" REDUCER AS AIR GAP) TO HUMIDIFIER _ DRAIN CONNECTION WITH 1-1/4" TYPE M COPPER PIPING. ROUTE 1-1/4" SERVER 126 COPPER DRAIN PIPING FROM AIR GAP DOWN TO FLOOR


Humidifier (HUM-3) Piping Detail
NOT TO SCALE

FLOOR

Humidifier (HUM-1 & 2) Piping Detail

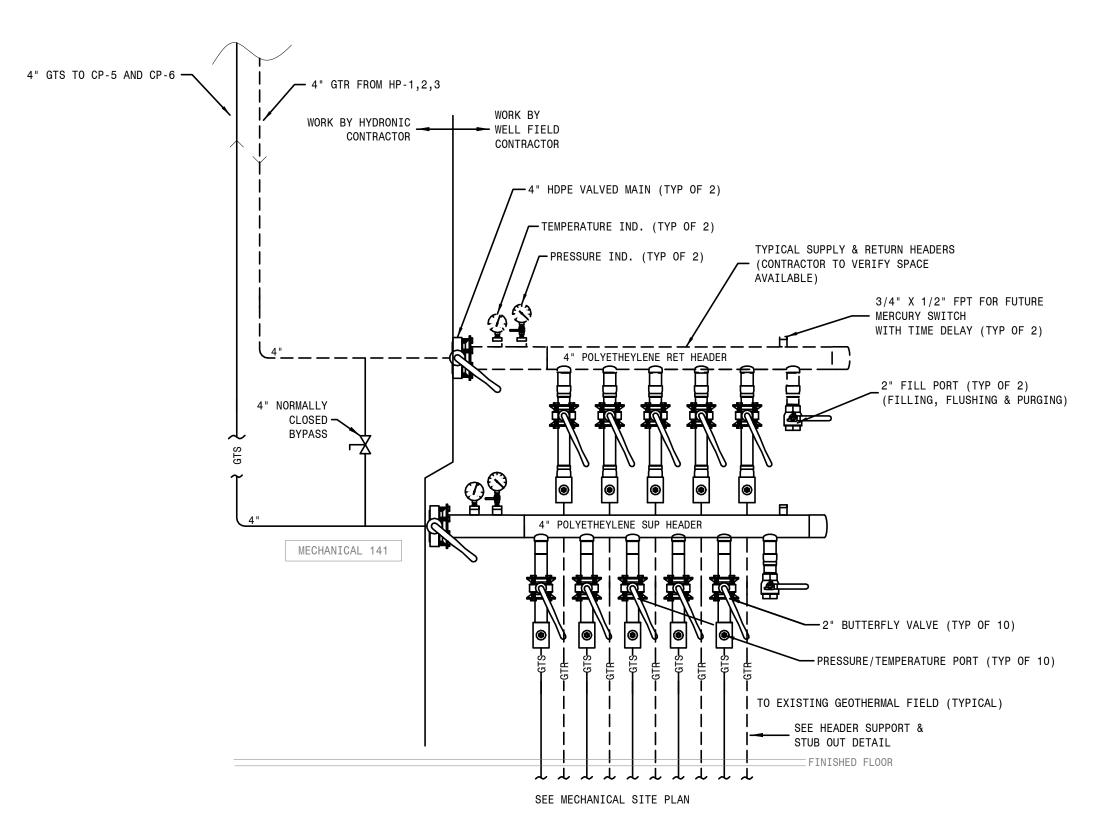

Ground-Coupled Heat Exchanger Header (Front View) Detail

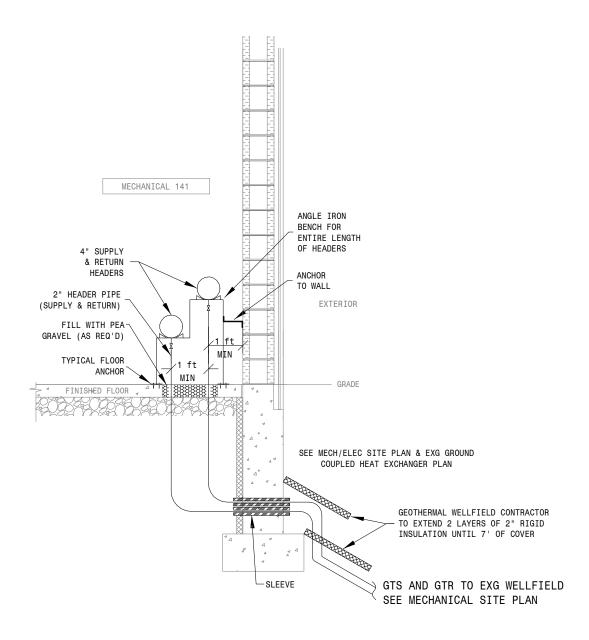

Header Support & Stub Out Detail
NOT TO SCALE



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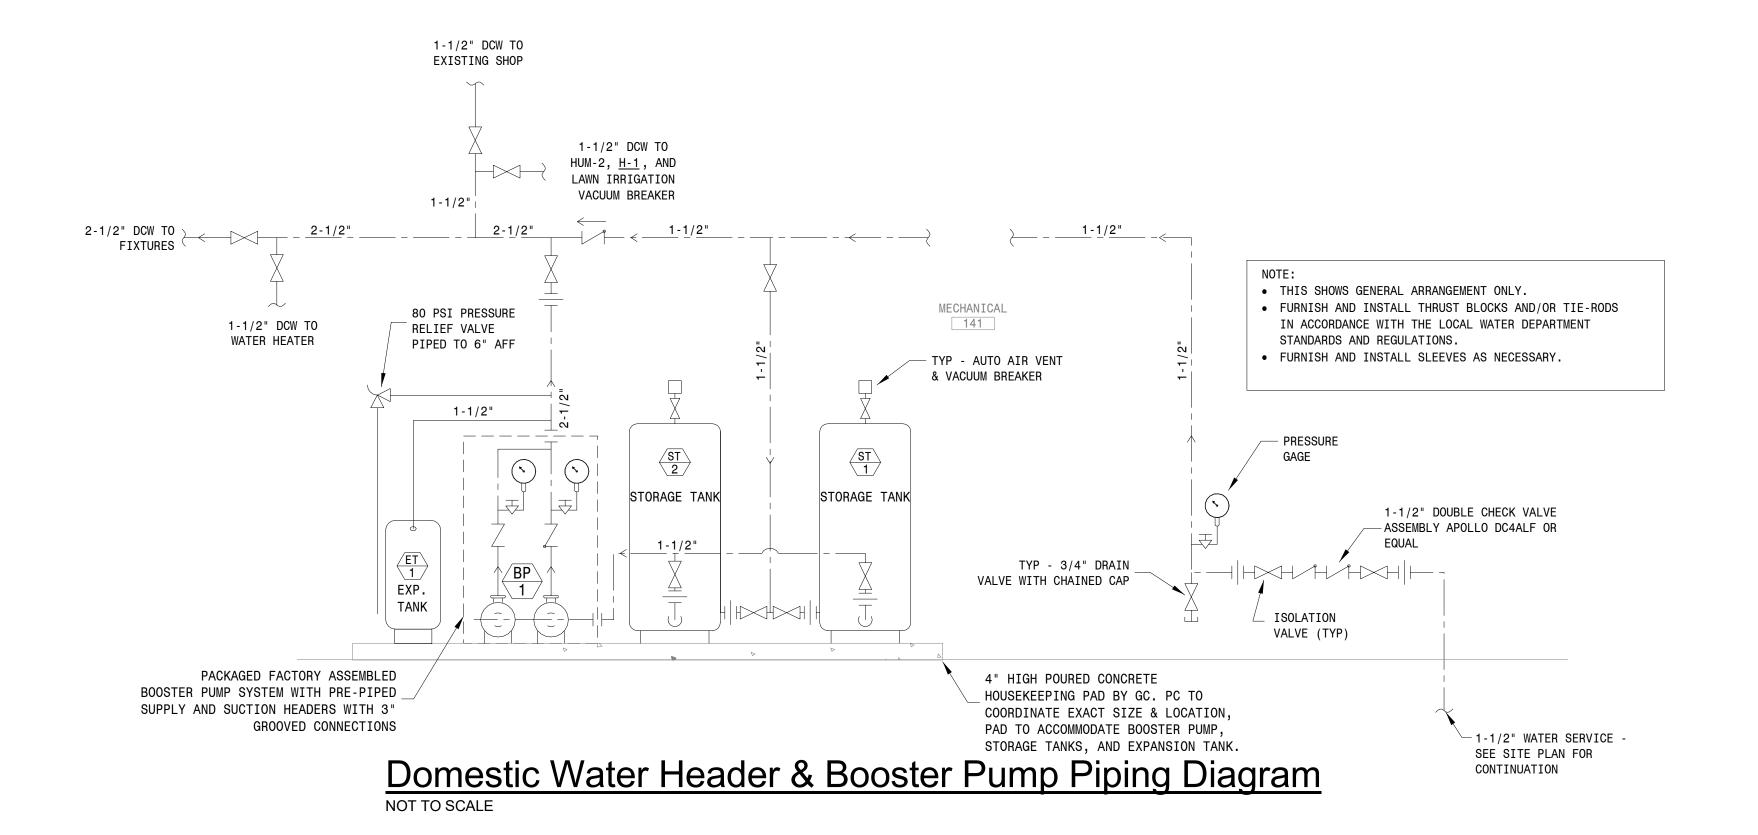
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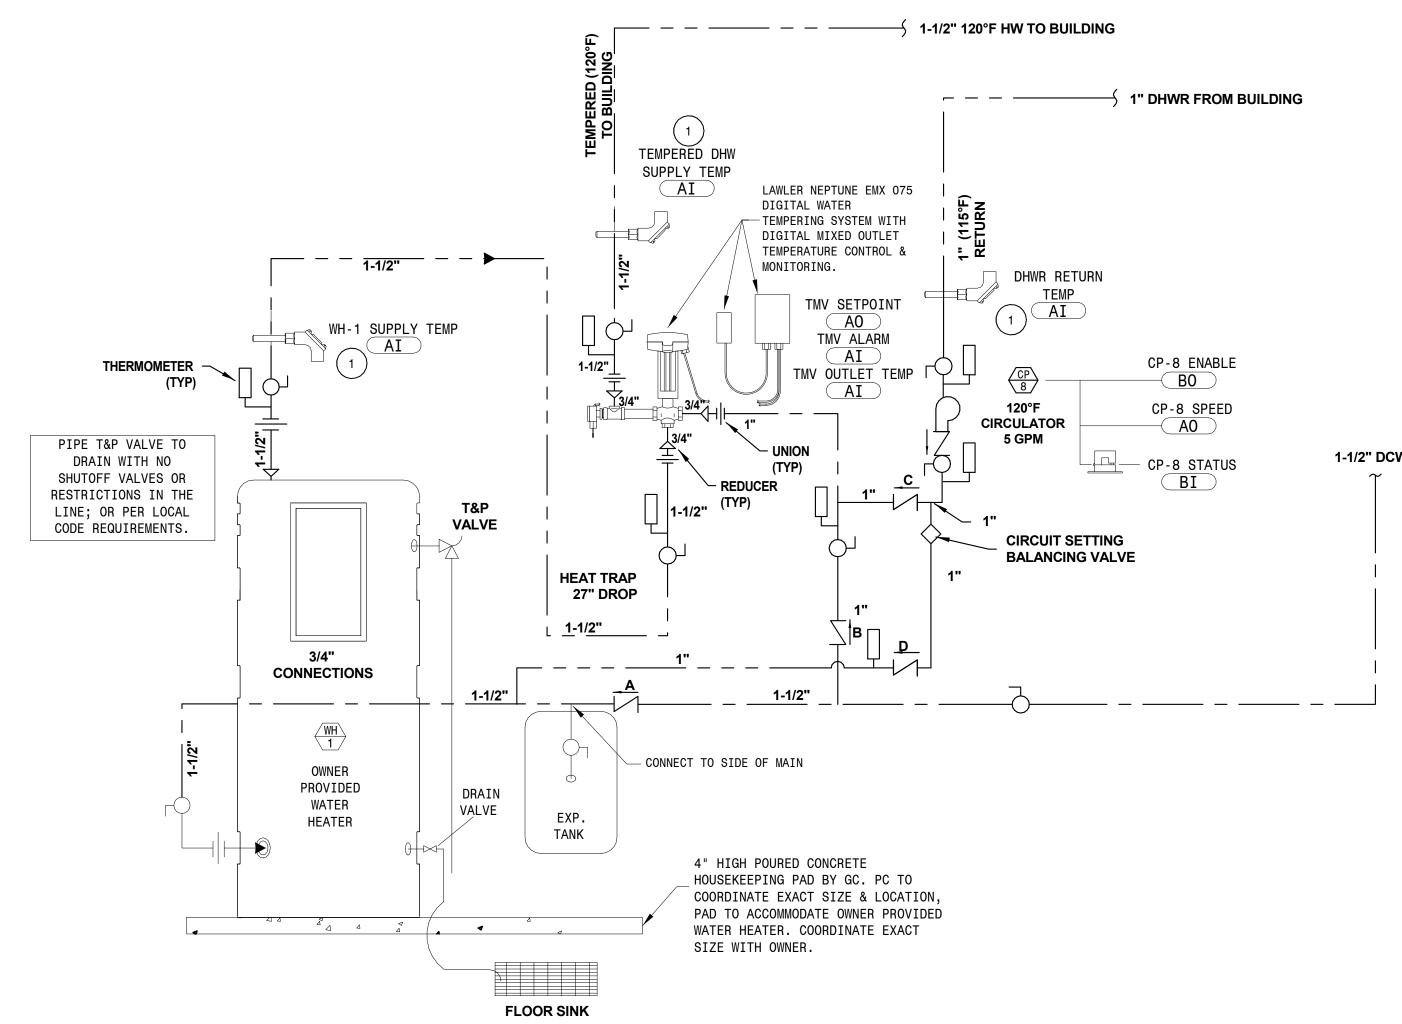
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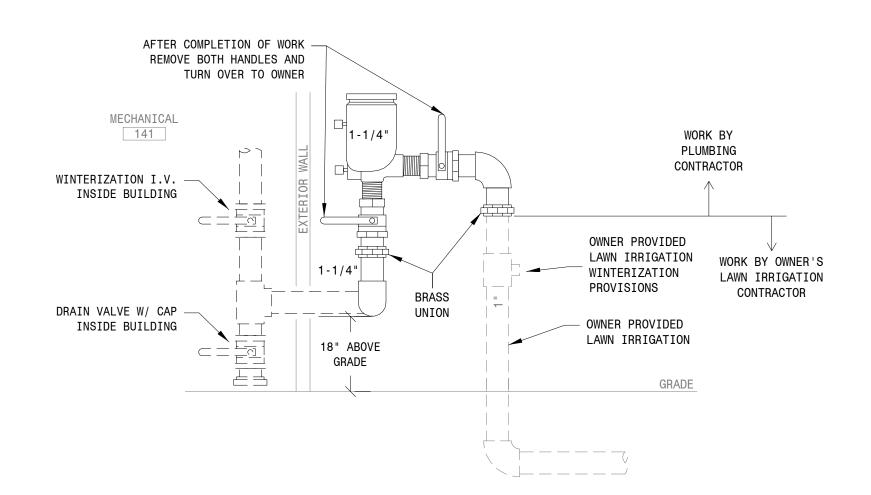
PROJECT:
NORTHERN ELECTRIC
COOPERATIVE
ABERDEEN, SOUTH DAKOTA

<u>SHEET TITLE:</u> MECHANICAL DETAILS - 2 OF 4







Electric Water Heater Control & Piping Diagram
NOT TO SCALE




Pressure Vacuum Breaker Detail (For Lawn Irrigation)

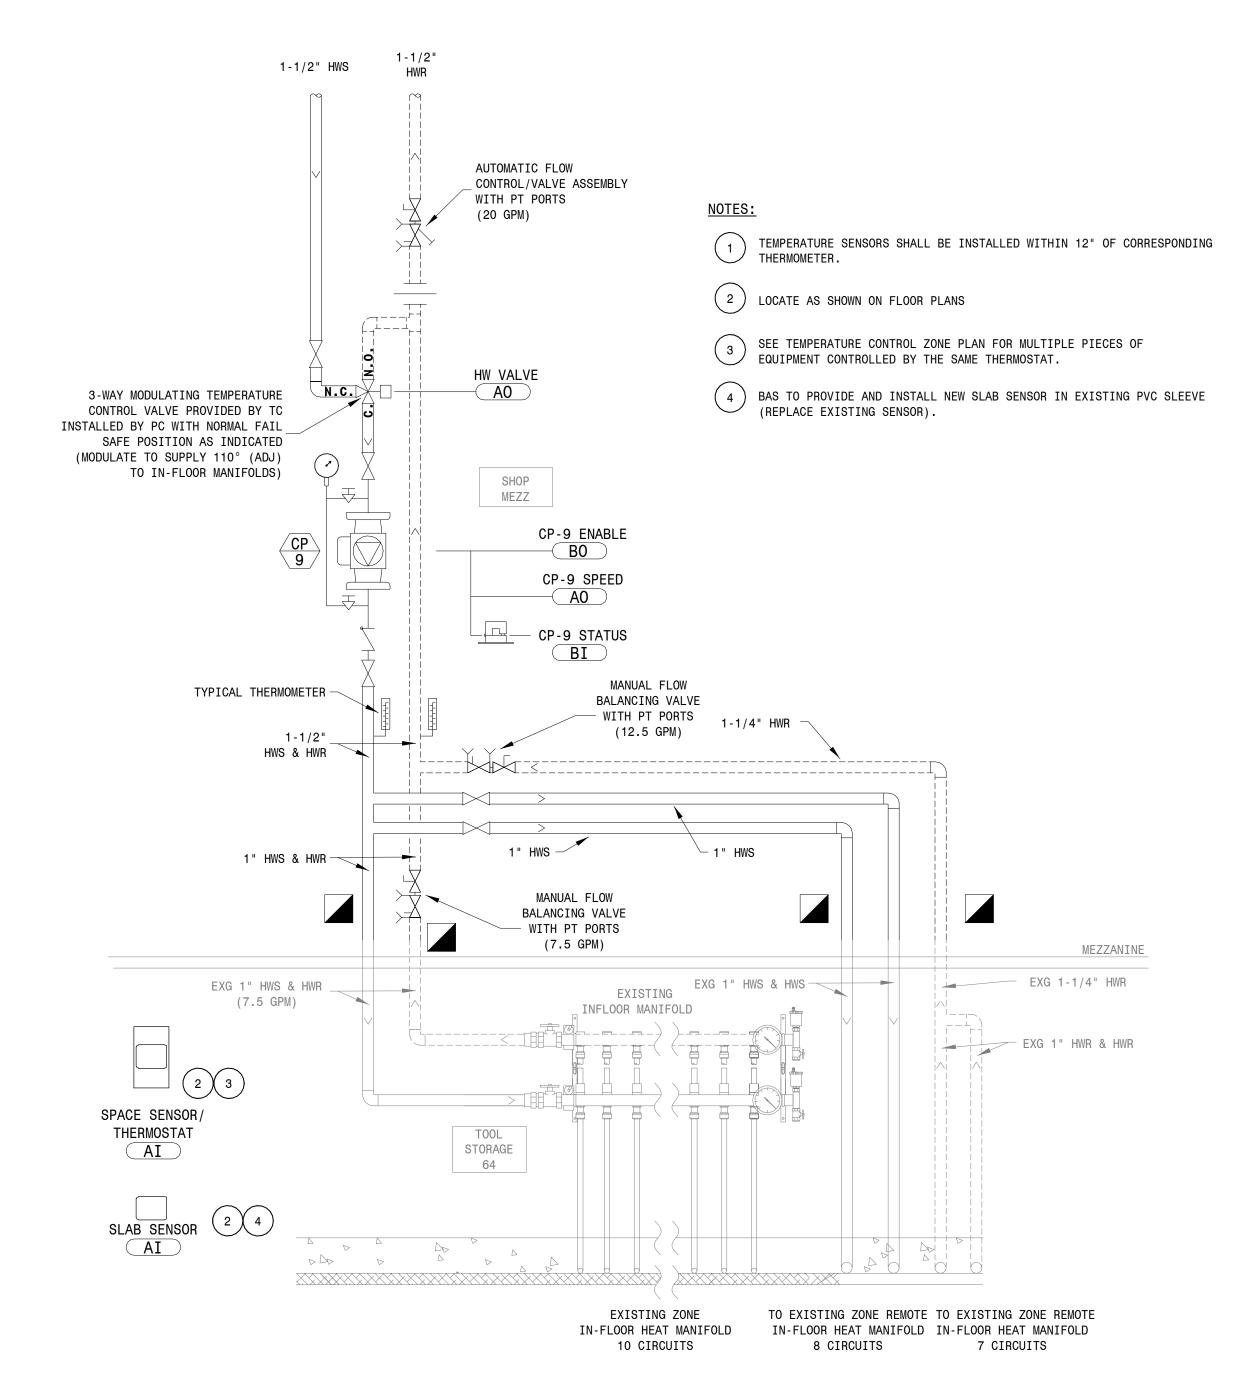


Modifications To Existing In-Floor Heat Manifold Control & Piping Diagram

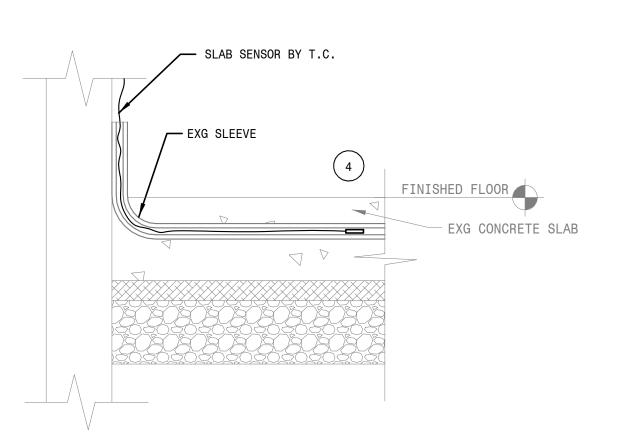

Slab Stat Detail
NOT TO SCALE

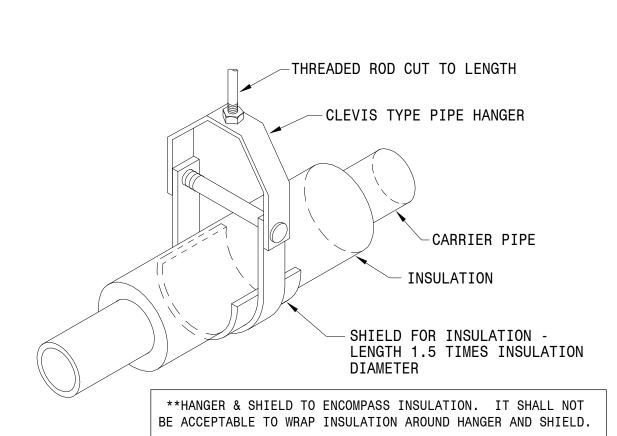

Clevis Type Pipe Hanger
For Insulated Pipe Detail

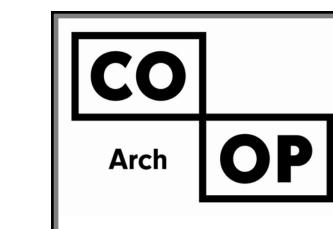

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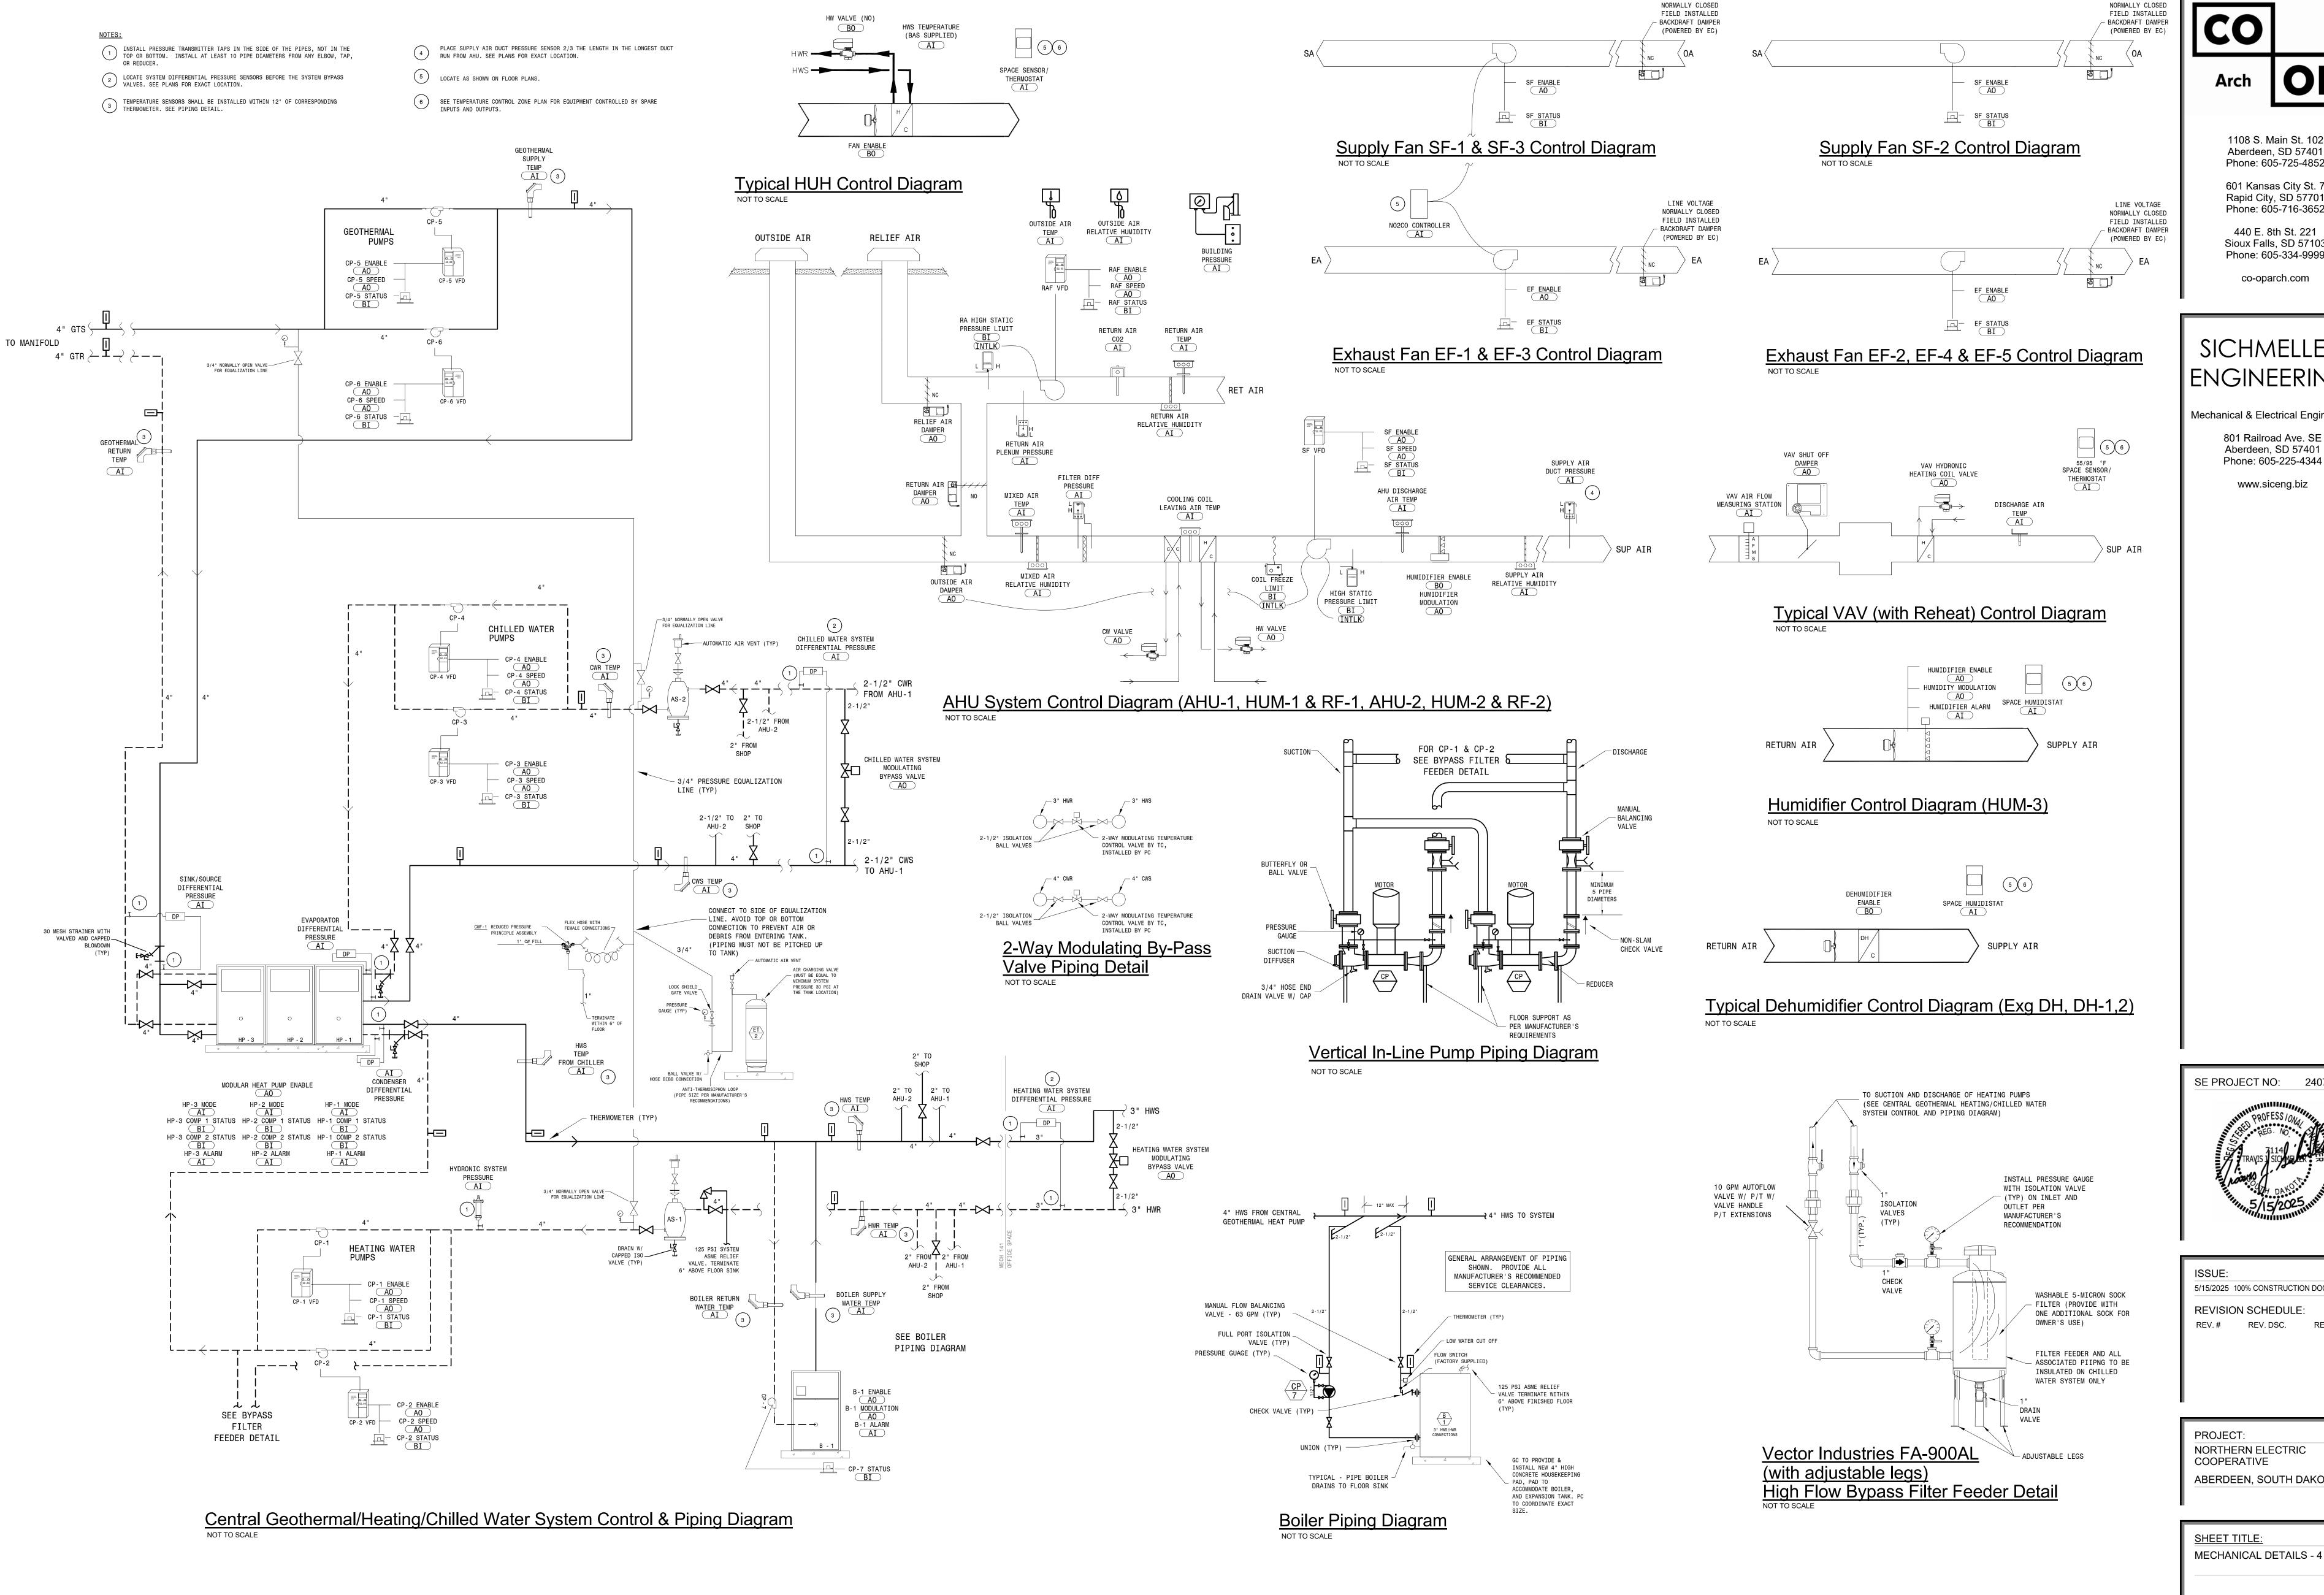
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SHEET TITLE:

MECHANICAL DETAILS - 3 OF 4



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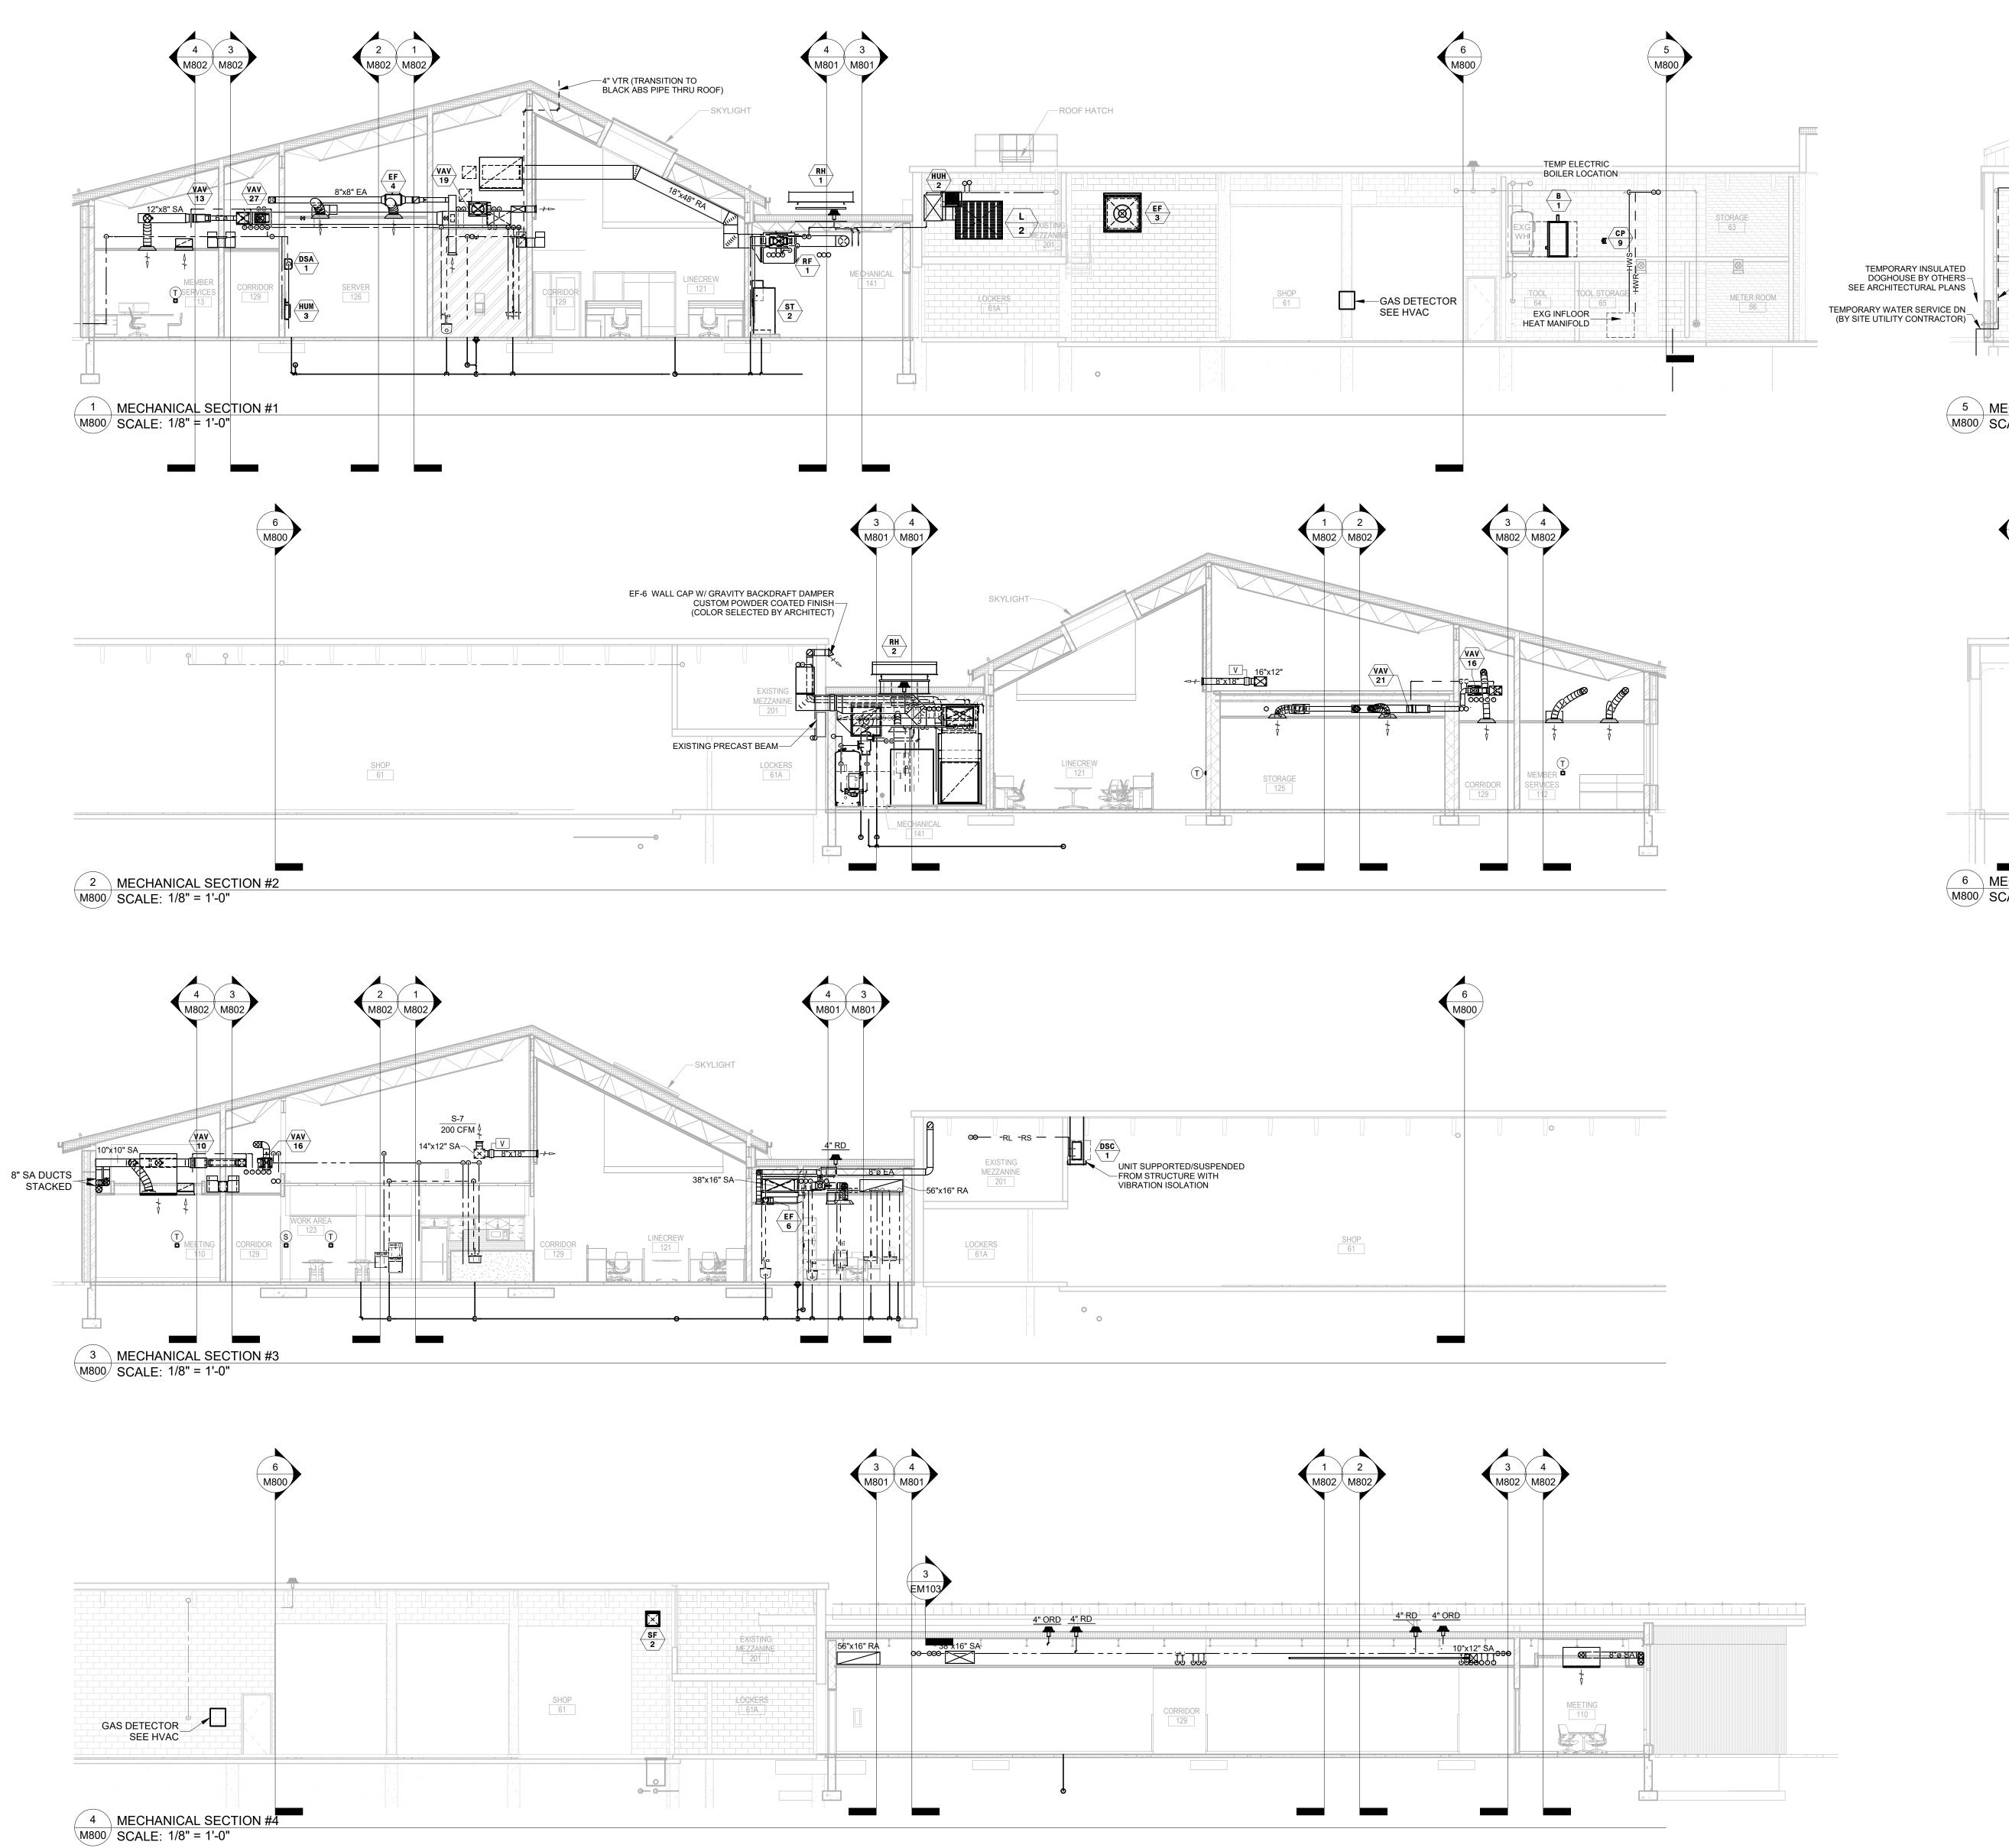
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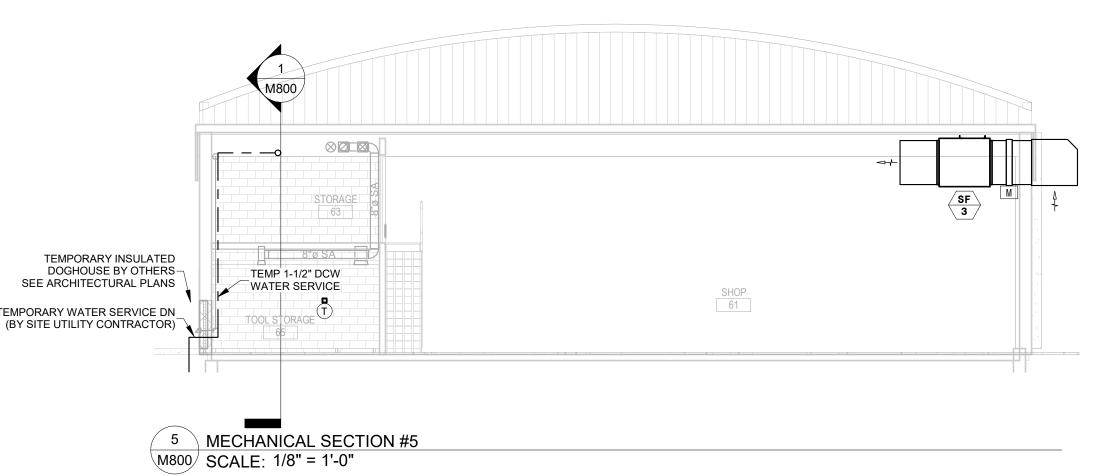
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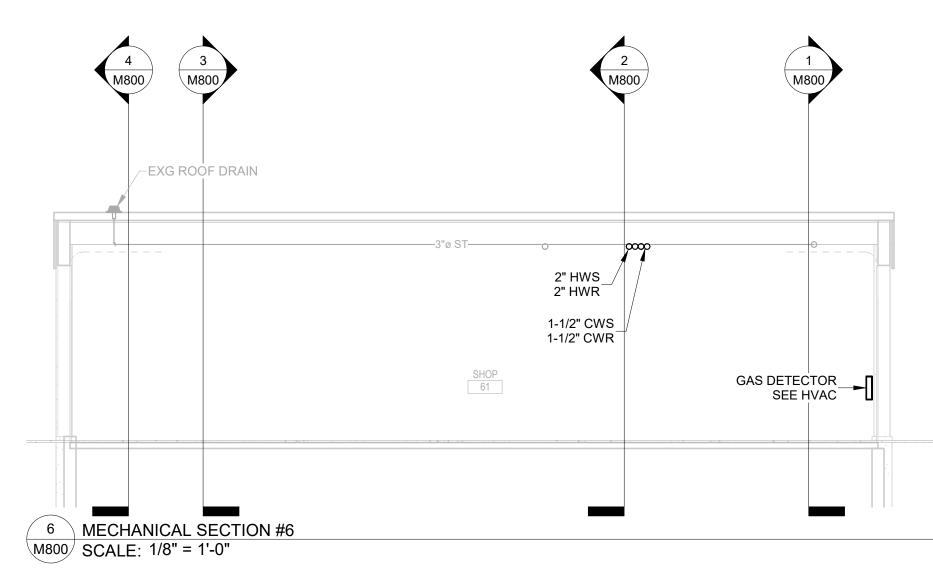
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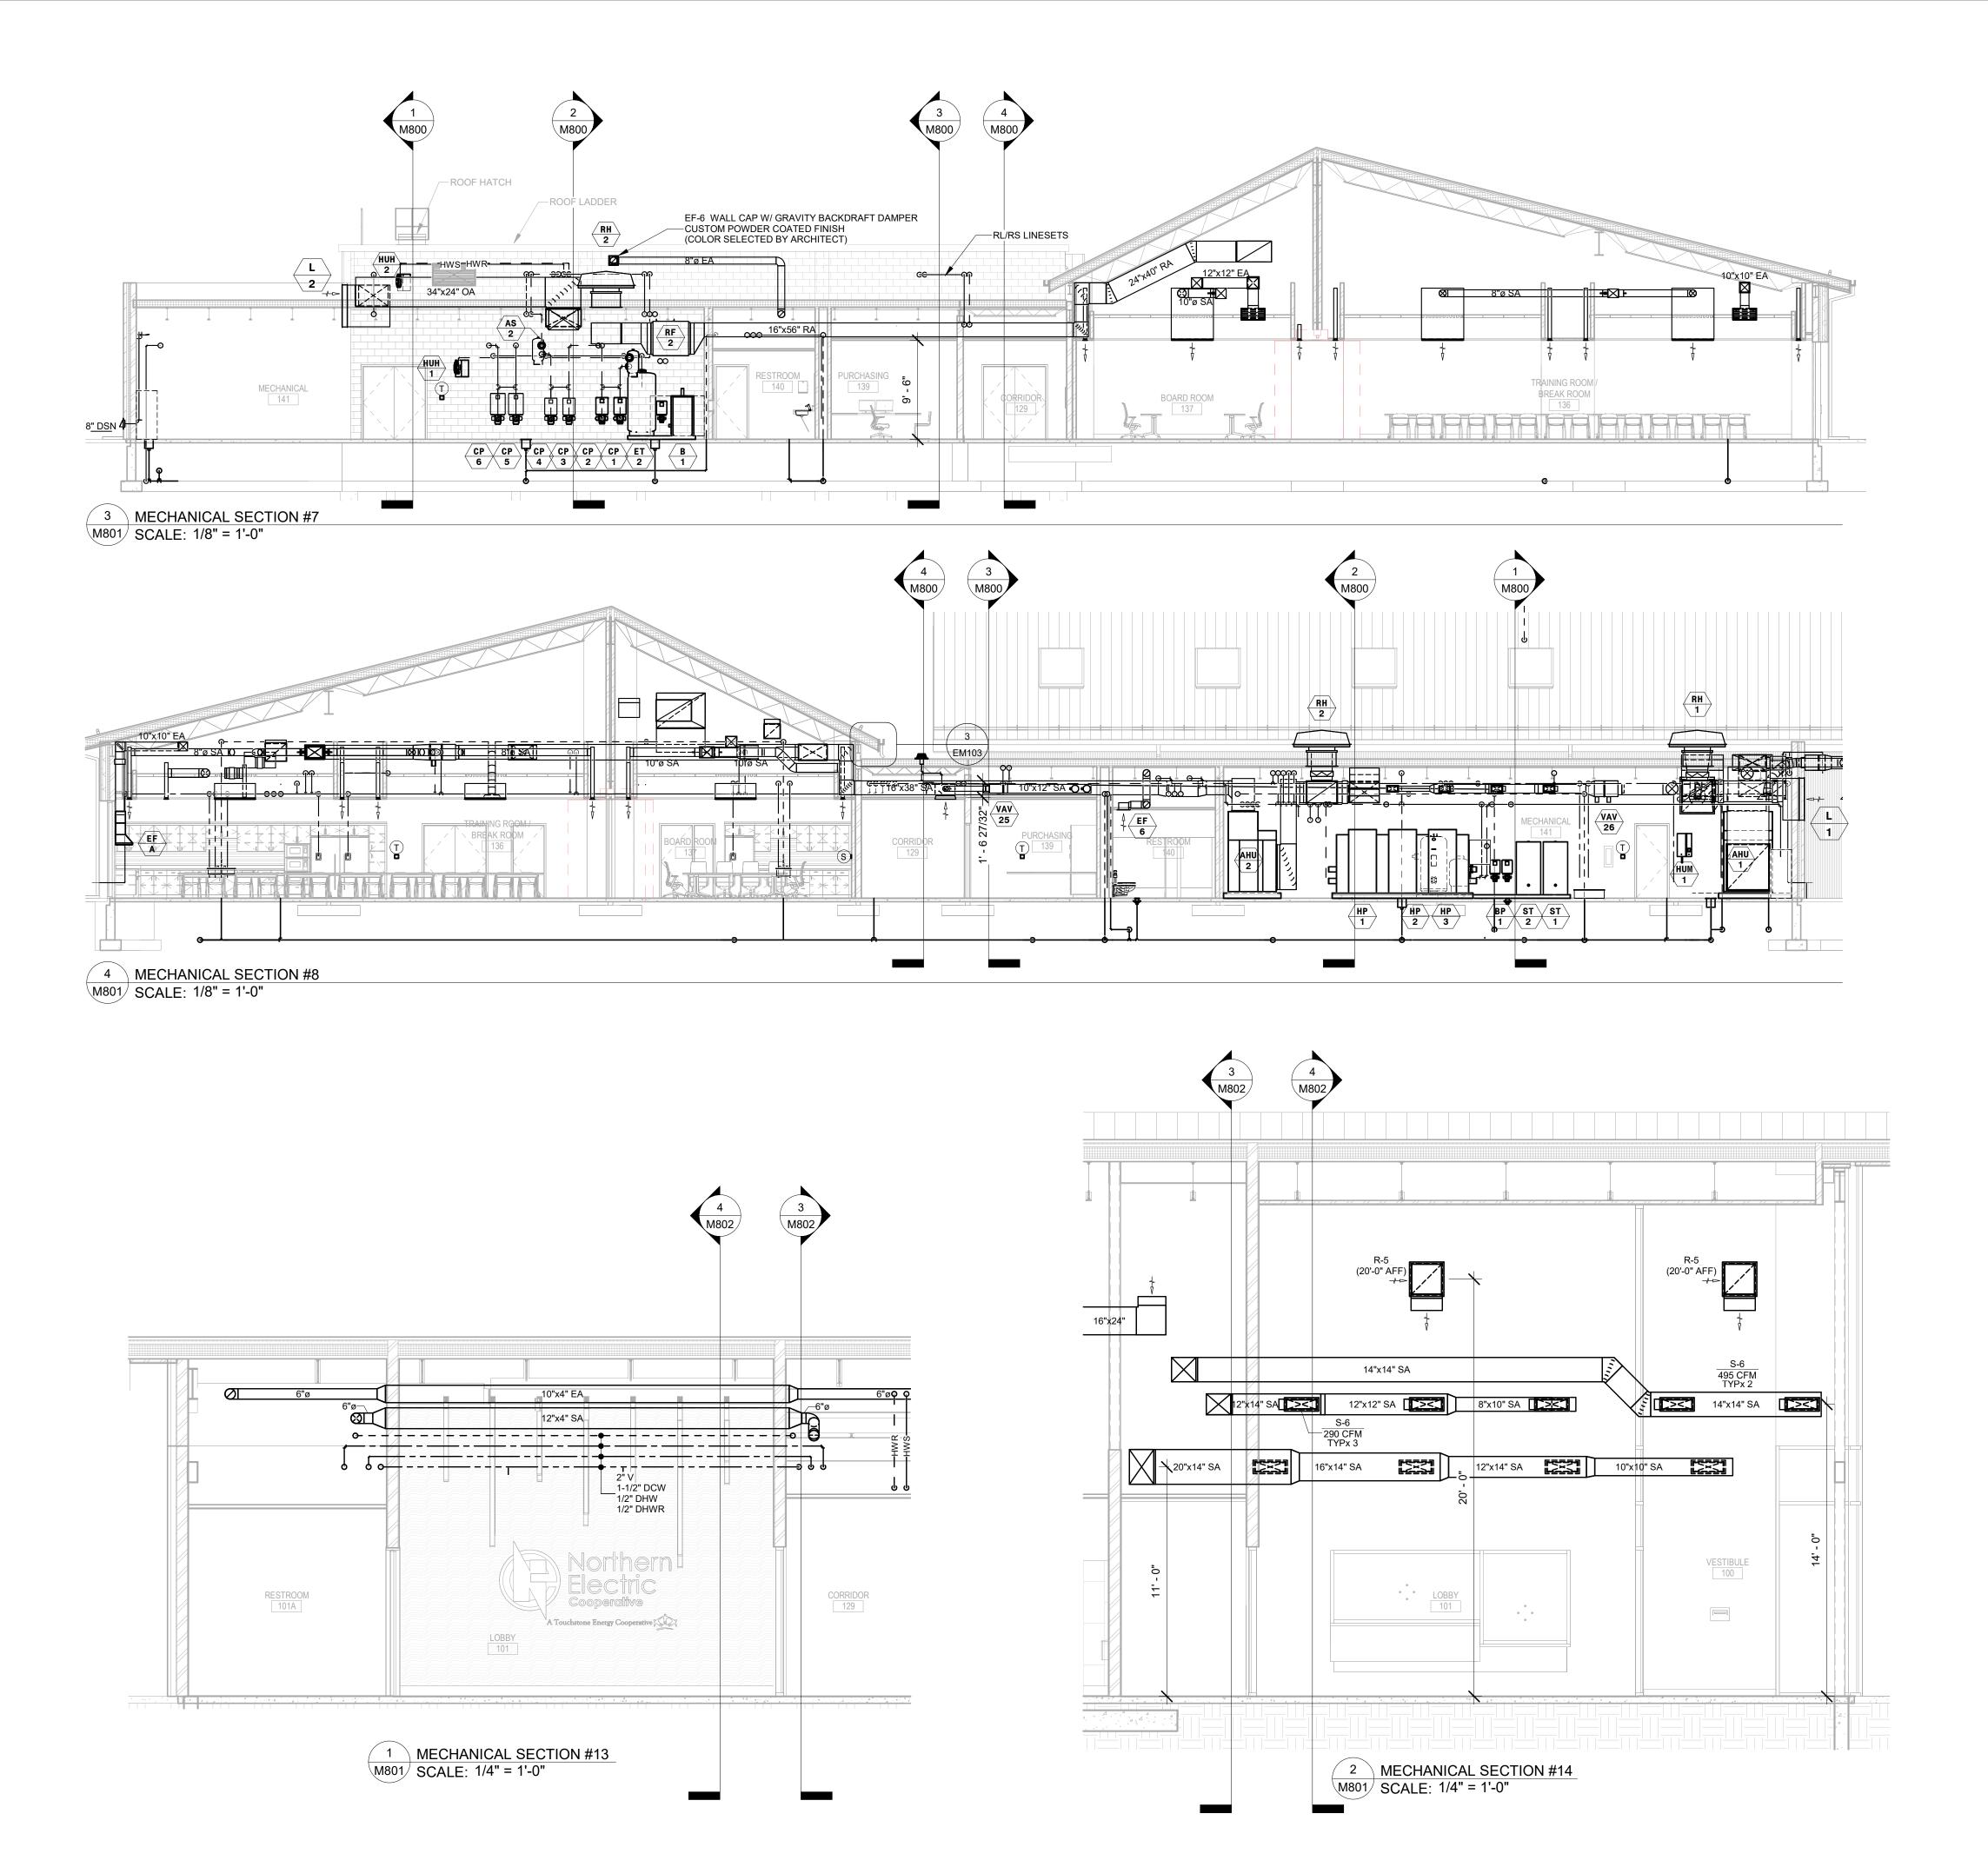
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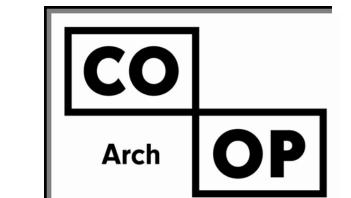
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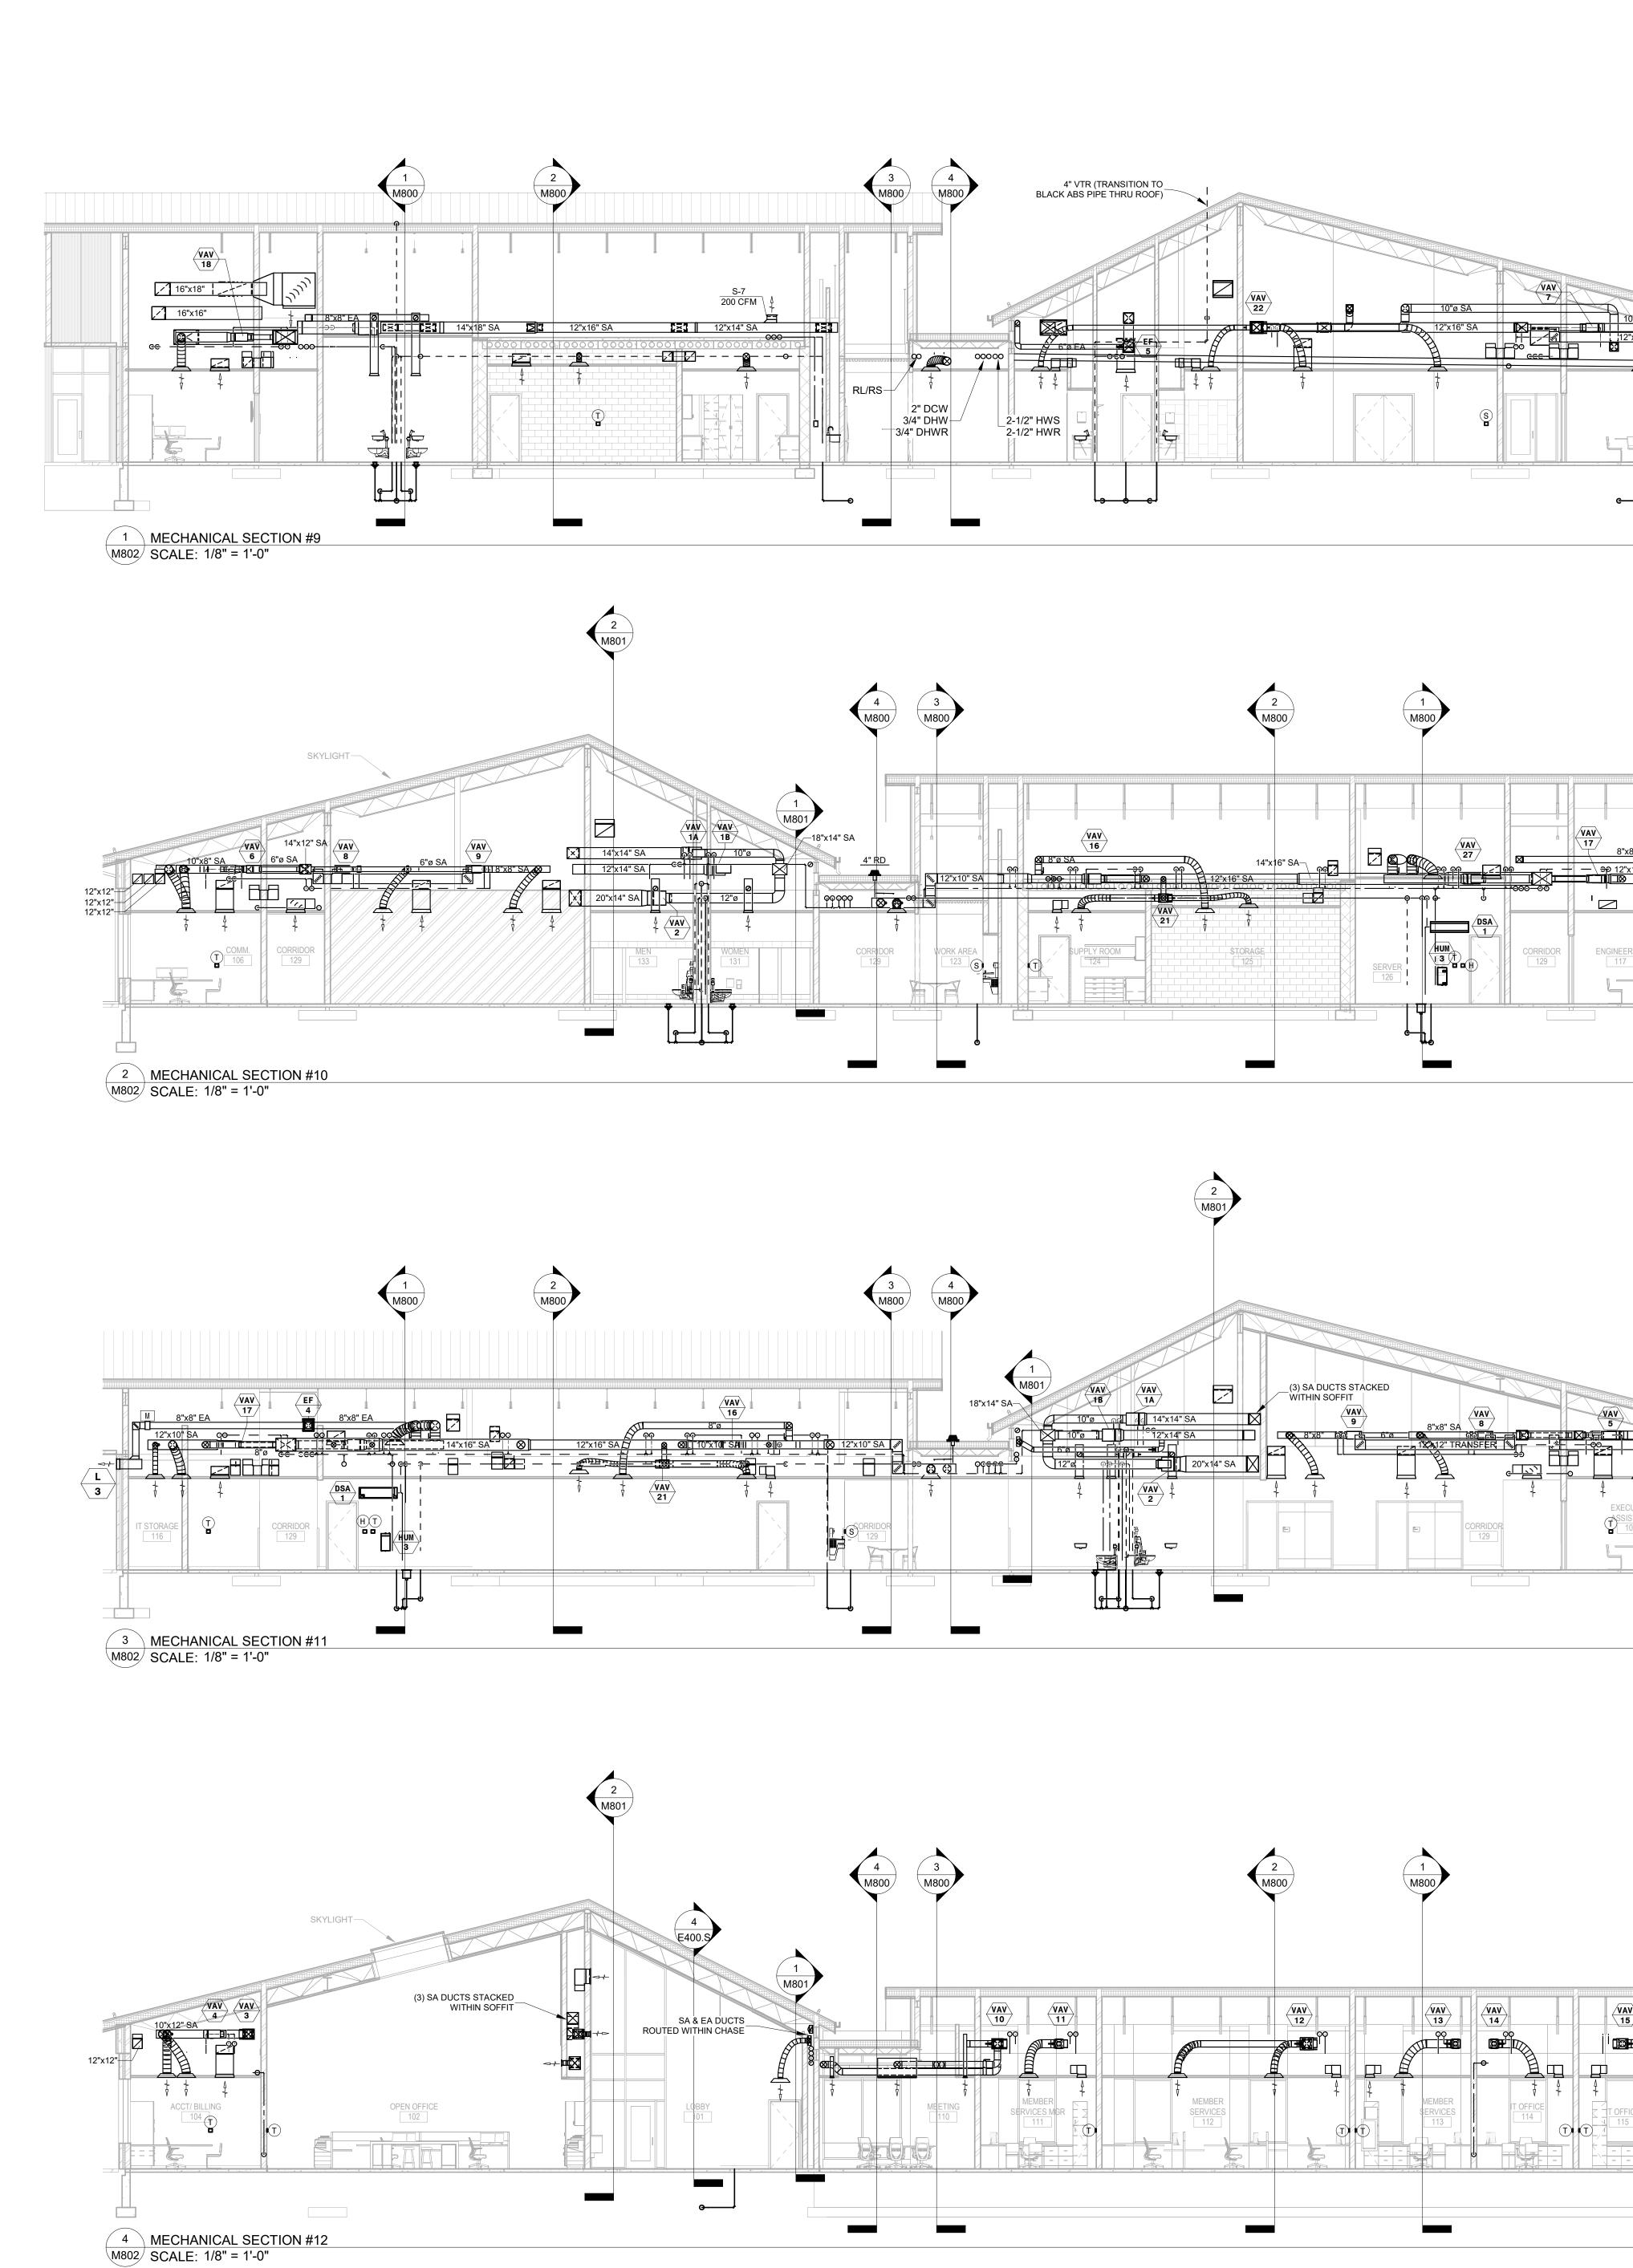
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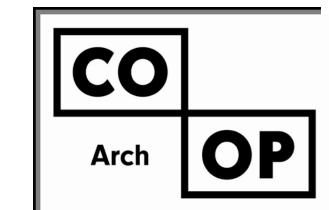
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ABERDEEN, SOUTH DAKOTA

SHEET TITLE:
MECHANICAL SECTIONS - 3 OF

												AIR	H/	NDLIN	IG U	TINI	S	CHEDU	JLE																AHU
							MINIMUM					SUPPLY FAN	/MOTOR	I						COOLING	COIL CAP	(EWT=4	4°F)					HEATING	COIL CA	NP. (EWT=130	°F)				
EQUIP.	MANUFACTURER & MODEL	LOCATION	SERVING			HEATING AIRFLOW	0.4	CFM	ESP	МНР	ВНР	SIZE/TYPE	FAN RPM	V./PH./CY.	FLA	MCA	МОСР	TOTAL COOLING	EAT DB/WB	LAT DB/WB (°F)	FV	LWT	GPM	WPD -	TOTAL CONNECTIONS	TOTAL HEATING	EAT	LAT		LWT	WDD	CONNEC		OPER. WT.	NOTES
				(CFM)	(CFM)	(CFM)	(CFM)	OFIN	(IN W.G.)	mnr	DIT	SIZE/TIFE	RPM	V./FH./01.	FLA	IIIOA	MOOF	МВН	(°F)	(°F)	(FPM)	(°F)	GFM .	WFD	QTY SIZE (IN)	MBH	(°F)	(°F)	(°F) GPM	WFD	QTY	SIZE (IN)	(LBS)	
AHU-1	AAON V3-ERB-3-0-26HC-62Q	MECH 141	WEST OFFICE VAV SYSTEM	8,400	4,065	6,120	990	8,400	2.15	(2) 5	(2) 4.03	18.5"/PL	2212	480/3/60	10.0	12.0	15	205.1	75.9/63.2	54.9/54.8	466.7	52.4	53.0 2	25.4	2 2.0	324.3	60.0	95.0	478.1 1	11.2 37.0	21.7	2	1.5	850	1,2,3,4,5,6,7
AHU-2	AAON V3-ERB-3-0-26HC-62Q	MECH 141	EAST OFFICE VAV SYSTEM	8,400	5,345	6,660	1,275	8,400	2.25	(2) 5	(2) 4.12	18.5"/PL	2226	480/3/60	10.0	12.0	15	215.0	76.5/63.6	54.9/54.8	466.7	52.5	55.0 2	26.8	2 2.0	324.3	60.0	95.0	478.1 1	11.2 37.0	21.7	2	1.5	850	1,2,3,4,5,6,7

NOTES: 1. DISCONNECT BY EC. 2. PROVIDE UNIT CONFIGURED FOR FIELD INSTALLED CONTROLS.

7. PROVIDE WITH COMPRESSOR SOUND BLANKETS AND ACOUSTICAL PANEL ENCLOSURE.

3. UNIT SHALL BE A VERTICAL, FLOOR MOUNTED, VARIABLE VOLUME UNIT AND SHALL INCLUDE FILTER SECTION, CHILLED WATER COOLING COIL, HOT WATER HEATING COIL (DOWNSTREAM OF COOLING COIL) AND SUPPLY AIR FAN WITH DISCHARGE OUT THE TOP OF UNIT. 4. PROVIDE WITH FACTORY INSTALLED VFD FOR EACH SUPPLY FAN MOTOR (QTY 2) AND FACTORY INSTALLED PHASE & BROWNOUT PROTECTION.

5. COOLING AND HEATING COIL PERFORMANCE BASED ON 35% PROPYLENE GLYCOL. SEE AHU COIL PIPING DETAILS. 6. PROVIDE FLAT FILTER BANK WITH 2" MERV 8 PLEATED FILTERS. VC TO PROVIDE 1 EXTRA SET OF FILTERS FOR THE OWNER. 7. GC TO PROVIDE & INSTALL 4" POURED CONCRETE HOUSEKEEPING PAD. VC TO COORDINATE PAD SIZE & LOCATION REQUIREMENTS WITH GC.

					RETU	IRN F	AN SC	HEDU	LE						RF
EQUIP.	MANUFACTURER & MODEL					LOW	STATIC	MAX			МОТ)R		UNIT	
NO.	(STYLE)	SERVING	LOCATION	TYPE	CFM	SPEED CFM	PRESS. (IN W.G.)	SONES	WATTS	НР	FRPM	VOLT./PH./CY.	FLA	WEIGHT (LBS)	NOTES
RF-1	COOK SQN-D VF 270SQN17D(VF2)	AHU-1 RETURN AIR	MECH 141	INLINE	8,400	-	1.50	21	-	7-1/2	954	460/3/60	11.0	512	1,2,3
RF-2	COOK SQN-D VF 270SQN17D(VF2)	AHU-2 RETURN AIR	MECH 141	INLINE	8,400	-	1.50	21	-	7-1/2	954	460/3/60	11.0	512	1,2,3
NOTES:	2. PROVIDE WITH EC MOTOR	COMBINATION MOTOR STARTER DI RATED FOR VARIABLE SPEED APPI NG VIBRATION ISOLATION & FLEX	ICATION WITH FIELD		IR BALANCE	KIT FOR I	NTERFACE WITH	THE BAS.	1			1	1	,	

										COOLING	PERFORMAI	NCE								HEATING	PERFORMA	NCE				CONN	. SIZE	E	LECTRICAL	DATA			
EQUIP. NO.	MANUFACTURER & MODEL	LOCATION	NOMINAL TONS	REFRIG. Type	STAGES		EVAP	ORATOR			COND	ENSER		CAPACITY			EVAP	ORATOR			COND	ENSER		CAPACITY		EVAP.	COND.					WEIGHT (LBS)	NOTES
	W MODEL		15115			EWT (°F)	LWT (°F)	GPM	WPD (PSI)	EWT (°F)	LWT (°F)	GPM	WPD (PSI)	(MBH)	COP	EWT (°F)	LWT (°F)	GPM	WPD (PSI)	EWT (°F)	LWT (°F)	GPM	WPD (PSI)	(MBH)	COP	(IN)	(IN)	V./PH./CY.	FLA	MCA	MOCP	(150)	
HP - 1	MULTISTACK MSH020KNHC	MECH 141	20	R-454B	2																							480/3/60	41.4	47.0	70		1,2,3,4,5,6,
HP-2	MULTISTACK MSH020KNHC	MECH 141	20	R-454B	2																					6" DIA	6" DIA	480/3/60	41.4	47.0	70	7,440	1,2,3,4,5,6,
HP-3	MULTISTACK MSH020KNHC	MECH 141	20	R-454B	2	56	44	134.0	5.54	85	95	192.0	6.25	905.1	4.78	50	41	141.0	6.25	110	130	86.0	2.60	813.4	3.59	GROOVE	GROOVE	480/3/60	41.4	47.0	70	+ WATER	1,2,3,4,5,6,
	MULTISTACK (4)VMEBADH+DADADA2	MECH 141																										120/1/60	3.0 TOTAL	4.0 TOTAL	15 TOTAL		

								EXIS	STI	NG	FAN	1 C	OIL	UN	IT S	CHE	DUL	.E												EXG FC
								COOLING	COIL CA	P. (EWT	=44°F)						HEATI	G COIL	CAP. (WT=130°	F)		M	OTOR	1	LECTRIC	AL			
EQUIP.	MANUFACTURER & MODEL	LOCATION	SERVING	AIRFLOW (CFM)	ESP (IN H20)	TOTAL	EAT DB/WB	LAT DD /WD	FV	LWT	CDM	wnn		TAL CTIONS	TOTAL	EAT	LAT	FV	LWT	GPM		TOTAL CONNECTION	S	ш	V /BIL /CV	FLA	МСА	MOCD	OPER. WT.	NOTES
				(22)	(===,	COOLING MBH	(°F)	DB/WB (°F)	FV (FPM)	(°F)	GPM	WPD	QTY	SIZE (IN)	HEATING MBH	EAT (°F)	(°F)	(FPM)	(°F)	GPW	WPD	QTY SI		HP	V./PH./CY.	FLA	MCA	MOCP	(LBS)	
EXG FC	HYDRON MODULE MPH024A1MM1S	STORAGE 63	STORAGE 63, TOOL STORAGE 65 & METER ROOM 66		0.25	20.4	75.0/63.0	59.3/59.1	260.7	54.0	6.0	8.74	2	3/4	36.3	70.0	109.1	260.7	115.4	6.0	8.11		1	1/3	208-240/1/60	3.9	4.9	15	155	1
NOTES: 1	. FOR REFERENCE ONLY		•		,		'				1										'	'	'	'						

						MAX	MAX	MAX			HEAT	ING COIL (EWT = 13	D°F)			COIL			
EQUIP. NO.	MANUFACTURER & MODEL	SERVED BY	INLET SIZE	MAX CFM	MIN CFM	TERM APD	RAD NC	DISCH	CFM	MIN MBH	EAT (°F)	LAT (°F)	GPM	LWT (°F)	WPD (FT)	ROWS	CONN. SIZE	RUNOUT SIZE	WEIGHT (LBS.)	NOTES
VAV-1A	PRICE SDV-0S	AHU-2	10	990	350	0.34			490	23.3	55.0	98.8	4.0	117.2	5.00	2	7/8"	1"	36.0	1,2,3,4,
VAV-1B	PRICE SDV-OS	AHU-2	10	920	465	0.30			630	27.0	55.0	94.5	4.0	115.2	5.02	2	7/8"	1"	36.0	1,2,3,4,
VAV-2	PRICE SDV-0S	AHU-2	12	1700	1200	0.53			1200	55.2	55.0	97.4	7.0	112.8	4.57	3	7/8"	1"	55.0	1,2,3,4
VAV-3	PRICE SDV-OS	AHU-2	8	520	185	0.23		21	355	16.9	55.0	98.6	1.5	105.4	0.38	3	7/8"	3/4"	34.0	1,2,3,4
VAV-4	PRICE SDV-OS	AHU-2	6	285	100	0.17		25	195	9.3	55.0	98.8	3.0	123.2	1.89	2	7/8"	3/4"	22.0	1,2,3,4
VAV-5	PRICE SDV	AHU-2	6	235	90	0.15		22	160	7.4	55.0	97.2	2.5	123.5	1.06	2	7/8"	3/4"	19.0	1,2,3,4
VAV-6	PRICE SDV	AHU-2	6	235	90	0.15		22	160	7.7	55.0	98.6	5.0	126.7	3.68	2	7/8"	1"	19.0	1,2,3,4
VAV-7	PRICE SDV	AHU-2	8	375	160	0.21			255	12.4	55.0	99.6	3.0	121.0	1.90	2	7/8"	3/4"	23.0	1,2,3,4
VAV-8	PRICE SDV	AHU-2	6	150	90	0.04			90	2.6	55.0	80.1	0.5	118.9	0.23	1	7/8"	3/4"	17.0	1,2,3,
VAV-9	PRICE SDV	AHU-2	6	150	90	0.04			90	2.6	55.0	80.1	0.5	118.9	0.23	1	7/8"	3/4"	17.0	1,2,3,
VAV - 10	PRICE SDV	AHU - 1	10	600	265	0.20			285	13.9	55.0	99.9	5.5	124.5	7.16	2	7/8"	1"	29.0	1,2,3,4
VAV - 11	PRICE SDV-OS	AHU-1	6	300	105	0.19		22	205	9.3	55.0	96.5	2.0	119.8	0.92	2	7/8"	3/4"	22.0	1,2,3,4
VAV-12	PRICE SDV-OS	AHU - 1	10	620	215	0.16			420	20.3	55.0	99.5	3.0	115.2	2.99	2	7/8"	3/4"	36.0	1,2,3,
VAV - 13	PRICE SDV-OS	AHU - 1	6	300	105	0.19		22	205	9.8	55.0	98.5	3.5	123.9	2.50	2	7/8"	3/4"	22.0	1,2,3,
VAV - 14	PRICE SDV-OS	AHU - 1	6	250	90	0.14		24	175	8.4	55.0	98.8	2.0	120.8	0.92	2	7/8"	3/4"	22.0	1,2,3,4
VAV - 15	PRICE SDV-OS	AHU - 1	8	530	190	0.21		21	360	17.1	55.0	98.5	3.0	117.6	2.43	2	7/8"	3/4"	29.0	1,2,3,
VAV-16	PRICE SDV-OS	AHU - 1	8	680	510	0.24		25	510	17.3	55.0	86.2	2.0	111.0	1.19	2	7/8"	3/4"	29.0	1,2,3,
/AV - 17	PRICE SDV-OS	AHU - 1	6	420	160	0.35	21	28	285	12.5	55.0	95.3	7.0	126.1	8.71	2	7/8"	1"	22.0	1,2,3,
VAV - 18	PRICE SDV-OS	AHU - 1	6	310	110	0.20		22	215	10.2	55.0	98.2	4.0	124.4	3.17	2	7/8"	1"	22.0	1,2,3,
VAV - 19	PRICE SDV	AHU - 1	16	2080	1040	0.52			1415	68.0	55.0	99.3	10.0	115.1	6.28	3	7/8"	1 1/4"	64.0	1,2,3,4
VAV-20	PRICE SDV-OS	AHU - 1	12	1090	385	0.23			745	35.7	55.0	99.1	6.0	117.0	4.60	2	7/8"	1"	47.0	1,2,3,
VAV-21	PRICE SDV-OS	AHU - 1	6	380	305	0.29	20	26	305	12.9	55.0	93.8	5.0	124.4	4.75	2	7/8"	1"	22.0	1,2,3,
VAV-22	PRICE SDV	AHU-2	12	790	595	0.24			595	26.7	55.0	96.2	4.5	117.0	6.18	2	7/8"	1"	36.0	1,2,3,
VAV-23	PRICE SDV	AHU-2	24X16	2580	1185	0.39	25	23	1585	76.0	55.0	99.2	6.0	102.3	2.93	3	7/8"	1"	107.0	1,2,3,
VAV-24	PRICE SDV	AHU-2	12	1200	625	0.36			625	25.9	55.0	93.1	7.0	121.9	13.63	2	7/8"	1"	36.0	1,2,3,
/AV-25	PRICE SDV-OS	AHU-2	6	335	120	0.27		24	230	11.1	55.0	99.2	2.0	117.9	0.92	2	7/8"	3/4"	23.0	1,2,3,4
/AV-26	PRICE SDV-0S	AHU - 1	14	1240	435	0.20			845	40.6	55.0	99.2	6.0	115.2	4.90	2	7/8"	1"	55.0	1,2,3,
/AV-27	PRICE SDV	AHU-1	10	950	335	0.40			335	11.7	55.0	86.9	1.0	104.5	0.35	2	7/8"	3/4"	29.0	1,2,3,

QUIP.	MANUFACTURER				S.P.	FACE	THROAT	THROAT	UNIT	BIRD/	
NO.	& MODEL	LOCATION	SERVING	CFM	(IN. H ₂ 0)	VELOCITY (FPM)	SIZE	VELOCITY (FPM)	WEIGHT (LBS)	INSECT SCREEN	NOTES
RH-1	LOREN COOK 30X60GR	NEW ROOF	AHU-1 RELIEF	8,400	0.09	840	30X60	672	254	Y/N	1,2,3
RH-2	LOREN COOK 30X60GR	NEW ROOF	AHU-2 RELIEF	8,400	0.09	840	30X60	672	254	Y/N	1,2,3

				LOUVE	ER SCHED	ULE			<u> </u>
EQUIP. NO.	MANUFACTURER & MODEL	FUNCTION	SIZE (W"XH"XD")	CFM	S.P. (IN W.G.)	FREE AREA (SQ. FT.)	FREE AREA VELOCITY (FPM)	SCREEN (BIRD/INSECT)	NOTES
LV - 1	RUSKIN ELF6375DX	AHU-1 FRESH AIR	60"X48"X6"	8,400	0.09	11.45	734	YES/NO	1,2,3
LV-2	RUSKIN ELF6375DX	AHU-2 FRESH AIR	60"X48"X6"	8,400	0.09	11.45	734	YES/NO	1,2,3
LV-3	RUSKIN ELF6375DX	EF-4 EXHAUST	12"X12"X6"	150	0.03	0.30	502	YES/NO	1,2,3
LV-4	RUSKIN ELF6375DX	EF-5 EXHAUST	26"X12"X6"	575	0.09	0.72	801	YES/NO	1,2,3
LV-5	RUSKIN ELF6375DX	RANGE HOOD EF-A EXHAUST	26"X12"X6"	290	0.02	0.72	404	YES/NO	1,2,3

QUIP.			COOLING	HEATING	REFRIGERANT	REFRIGERA	ANT PIPING	ELEC	CTRICAL			DIMENSIONS		UNIT	
NO.	MANUFACTURER & MODEL	SERVING	CAPACITY (BTU/HR.)	CAPACITY (BTU/HR @47F)	TYPE	LIQUID	SUCTION	V./PH./CY.	FLA	MOCP	HEIGHT	WIDTH	DEPTH	WEIGHT (LBS)	NOTES
DSA-1	DAIKIN FTXC18AXVJU (WALL MOUNT)	SERVER 126	18,100	18,000	R-32	1/4"	1/2"	208/1/60	N/A	N/A	11-11/16"	39-9/16"	11-1/3"	30.5	1,2,3,4

			l	DUG I LI	ESS SP	LTI 2	SIE	IVI OU	וטטע ו	t U	ИΤΙ	SCH	EDUL	.E		
EQUIP.	MANUFACTURER	SERVING	LOCATION	COOLING CAPACITY	HEATING CAPACITY	REFRIGERANT	REFRIGERA	ANT PIPING	ELEC	TRICAL			DIMENSIONS		UNIT WEIGHT	NOTES
NO.	& MODEL			(BTU/HR)	(BTU/HR @47F)	TYPE	LIQUID	SUCTION	V./PH./CY.	MCA	MOCP	HEIGHT	WIDTH	DEPTH	(LBS)	
DSC-1	DAIKIN RXC18AXVJU	DSA-1	SHOP 61	6,900- 20,000	5,800- 22,500	R-32	1/4"	1/2"	208/1/60	16.4	20	27-13/32"	36-5/8"	13-13/16"	101	1,2,3

			EX	CHAUS	T/SU	PPL	FAN	SCHE	DULE						EF SF
EQUIP.	MANUFACTURER & MODEL					LOW	STATIC	MAX			МОТ	DR		UNIT	
NO.	(STYLE)	SERVING	LOCATION	TYPE	CFM	SPEED CFM	PRESS. (IN W.G.)	SONES	WATTS	НР	FRPM	VOLT./PH./CY.	FLA	WEIGHT (LBS)	NOTES
SF - 1	COOK SQN-D VF 330SQN17D(VF2)	MAKE-UP AIR - SHOP NO2CO	SHOP 61	IN-LINE	13415	-	0.25	18.5	-	10	614	460/3/60	14.0	691	1,3,4,7,8,9
SF-2	COOK SQN-D VF 120SQN17D(VF)	GENERAL MAKE-UP - SHOP	SHOP 61	IN-LINE	900	-	0.25	6.6	-	1/8	1084	120/1/60	1.9	100	2,3,5,7,8,9
SF-3	COOK SQN-D VF 330SQN17D(VF2)	MAKE-UP AIR - SHOP NO2CO	SHOP 61	IN-LINE	13415	-	0.25	18.5	-	10	614	460/3/60	14.0	691	1,3,4,7,8,9
EF - 1	COOK SQN-D VF 330SQN17D(VF2)	EXHAUST - SHOP NO2CO	SHOP 61	IN-LINE	13415	-	0.25	18.5	-	10	614	460/3/60	14.0	691	1,3,4,7,8,9
EF-2	COOK SQN-D VF 120SQN17D(VF)	GENERAL EXHAUST - SHOP	SHOP 61	IN-LINE	900	-	0.25	6.6	-	1/8	1084	120/1/60	1.9	100	2,3,5,7,8,9
EF-3	COOK SQN-D VF 330SQN17D(VF2)	EXHAUST - SHOP NO2CO	SHOP 61	IN-LINE	13415	-	0.25	18.5	-	10	614	460/3/60	14.0	691	1,3,4,7,8,9
EF-4	COOK SQN-D VF 100SQN17DL(VF)	GENERAL EXHAUST - OFFICE AREA	CORRIDOR 129	IN-LINE	150	-	0.75	6.8	-	1/8	1574	120/1/60	1.9	73	2,3,5,7,8
EF-5	COOK SQN-D VF 100SQN28D(VF)	GENERAL EXHAUST - OFFICE AREA	CUST. 132	IN-LINE	575	-	0.75	10.9	-	1/3	1822	120/1/60	4.4	81	2,3,5,7,8
EF-6	COOK GEMINI GNVF-500	EXHAUST - RESTROOM 140	RESTROOM 140	CEILING	225	-	0.65	4.0	50	-	1552	120/1/60	1.2	41	2,6,7,8,10
EF-A	ZEPHYR VENEZIA ACT 290 ZVE-E30DS	TRANSITION E110	TRANSITION E110	RANGE HOOD	250-290		0.10	5.8	480	-	-	120/1/60	4.0	-	11,12,13,14,1

2. PROVIDE WITH FACTORY INSTALLED DISCONNECT. 3. PROVIDE AND INSTALL LINE VOLTAGE, ALUMINUM MOTORIZED BACKDRAFT DAMPER TO BE INSTALLED IN THE DUCT WITH THE ACTUATOR OUTSIDE OF THE AIR STREAM. DAMPER TO BE WIRED WITH FAN OPERATION BY EC. 4. T.C. TO PROVIDE & INSTALL GAS DÉTECTOR CONTROL PANEL AND REMOTE SENSORS WHERE SHOWN ON PLANS (CONTROL PANEL AND REMOTE SENSORS ONLY REQUIRE LOW VOLTAGE POWER WIRING BY TC, NO LINE VOLTAGE WIRING BY EC).

SEE HVAC PLANS FOR MODEL NUMBERS. LIGHTED PILOT SWITCH BY TC (AUTO/ON) TO MANUALLY OVERRIDE FANS ON. 5. FAN TO OPERATE AS SCHEDULED BY THE BAS.

6. FAN TO OPERATE WITH THE LIGHTS WITH A TIME DELAYED SHUT-OFF BY E.C. 7. PROVIDE WITH EC MOTOR WITH FACTORY WIRED FAN SPEED CONTROLLER FOR BALANCING. 8. PROVIDE & INSTALL SPRING VIBRATION ISOLATION HANGERS & FLEXIBLE DUCT CONNECTIONS.

9. VC TO PROVIDE & INSTALL FIELD FABRICATED WEATHER HOOD (45 DEGREE FOR EXHAUST, 90 DEGREE FOR SUPPLY) WITH EXPANDED METAL SCREEN TO BE FIELD PAINTED. SIZE SHALL MATCH DUCTWORK SIZE. ARCHITECT TO SELECT COLOR. 10. PROVIDE WITH INTEGRAL BACKDRAFT DAMPER AND EXTERIOR WALL CAP W/ GRAVITY BACKDRAFT DAMPER WITH CUSTOM POWDER COATED FINISH (COLOR SELECTED BY ARCHITECT) 11. SCHEDULED RANGEHOOD IS 30" WIDTH AND STAINLESS STEEL FINISH.

12. RANGEHOOD TO BE INSTALLED 26" ABOVE COUNTERTOP. 13. TERMINATE AT LOUVER PLENUM WITH GRAVITY BACKDRAFT DAMPER.

14. PROVIDE WITH OPTIONAL RF WIRELESS REMOTE CONTROL ACCESSORY MODEL #RC-0001 DCBL WITH ELECTRICAL OUTLET MOUNTED REMOTE HOLDER TO STORE UNIT ON ELECTRICAL OUTLET ABOVE COUNTER FOR ADA ACCESS (REMOTE HOLDER DOES NOT CHARGE REMOTE).

15. PROVIDE WITH STAINLESS STEEL FINISH, DUCT COVER (PROVIDE WITH CUSTOM STAINLESS STEEL SHROUD EXTENSION DUCT COVER TO CEILING, SEE ARCHITECTURAL ELEVATIONS AND REFLECTED CEILING PLAN FOR CEILING HEIGHT), BACKDRAFT DAMPER, DUAL LEVEL DIRECTIONAL LED LIGHTING, ELECTRONIC LCD CONTROLS, 5 MIN AUTO DELAY-OFF TIMER, FILTER CLEAN REMINDER, 6-SPEED CENTRIFUGAL BLOWER, AND FACTORY INSTALLED CORD CONNECTION. UNIT MUST BE FIELD CONFIGURED FOR A MAXIMUM OF 290 CFM.

EQUIP.	MANUFACTURER & MODEL	NOMINAL SIZE	THROAT SIZE	MAX CFM	MAX APD	THROW (50 FPM)	NC	FRAME	FINISH	NOTES
S-1	PRICE SCD	24X24	6"Ø	110	0.03	5	< 15	LAY-IN	WHITE	1
S-2	PRICE SCD	24X24	8"Ø	230	0.05	8	< 15	LAY-IN	WHITE	1
S-3	PRICE SCD	24X24	10"Ø	420	0.07	11	20	LAY-IN	WHITE	1
S-4	PRICE SCD	24X24	12"Ø	560	0.07	12	20	LAY-IN	WHITE	1,2
S-5	PRICE SDS100 2-SLOT	48" X 4-1/4"	48" X 4-1/4"	300	0.09	31	24	SURFACE	WHITE	1,3
S-6	PRICE 520	20X10	18X8	520	0.06	33	17	SURFACE	WHITE, SEE NOTE 7	1,4,6,7
S-7	PRICE 520	14X10	12X8	310	0.05	25	< 15	SURFACE	WHITE	1,4,6
S-8	PRICE 520	10X6	8X4	100	0.06	14	< 15	SURFACE	WHITE	1,4
R-1	PRICE 530	24X12	22X10	700	0.08		21	LAY-IN	WHITE	1,5
R-2	PRICE 530	24X24	22X22	1600	0.08		23	LAY-IN	WHITE	1,5
R-3	PRICE SDR100 4-SLOT	48" X 7-3/4"	48" X 7-3/4"	600	0.08		19	SURFACE	WHITE	1,3
R-4	PRICE SDR100 2-SLOT	48" X 4-1/4"	48" X 4-1/4"	300	0.08		16	SURFACE	WHITE	1,3
R-5	PRICE 530	20X20	18X18	1000	0.07		20	SURFACE	WHITE	1,5
R-6	PRICE 530	24X12	22X10	700	0.08		21	LAY-IN	WHITE	1,2,5
R-7	PRICE 530	24X24	22X22	1600	0.08		23	LAY-IN	WHITE	1,2,5
R-8	PRICE SDR100 7-SLOT	48" X 13"	48" X 13"	1000	0.08		20	SURFACE	WHITE	1,3
E-1	PRICE 530	10X10	8X8	150	0.05		< 15	SURFACE	WHITE	1,5
E-2	PRICE 530	12X12	10X10	225	0.05		< 15	SURFACE	WHITE	1,5
T-1	PRICE 530	24X10	22X10	700	0.08		21	LAY-IN	WHITE	1,5

NOTES: 1. V.C. SHALL COORDINATE MOUNTING AND SURFACE CONSTRUCTION PRIOR TO FURNISHING MATERIAL. V.C. SHALL ALSO COORDINATE EXACT LOCATION OF EQUIPMENT. 2. PROVIDE WITH PLASTER FRAME FOR MOUNTING IN GYPSUM BOARD CEILING.

3. PROVIDE WITH FACTORY LINED PLENUM BOX CONFIGURED FOR FIELD CUT OPENING AND FLUSH PLASTER FRAME FOR CONCEALED MOUNTING. 4. PERFORMANCE BASED ON 22.5 DEGREE DEFLECTION.

5. PERFORMANCE BASED ON 45 DEGREE DEFLECTION.

PROVIDE WITH OPPOSED BLADE BALANCING DAMPER. 7. IN LINECREW 121, PROVIDE SIDEWALL DIFFUSERS WITH CUSTOM FINISH - BRAINSTONE BRONZE SW7033.

3. ALL SYSTEMS TO BE COMPLETELY INSULATED UNLESS OTHERWISE NOTED.

	DUC	CTWORK					INSULAT	ION THICKNE	SS (EXTERIOR	R WRAP UNLES	SS OTHERWIS	E NOTED)			
SYSTEM	MAX DIMENSION OF RECTANGULAR DUCTS OR DIAMETER OF ROUND DUCTS	GALVANIZED SHEET METAL GAUGE NUMBER	PRESSURE RATING	CONSTRUCTION	RECTANGULAR SUPPLY AIR BEFORE VAV	ROUND SUPPLY AIR BEFORE VAV	RECTANGULAR SUPPLY AIR AFTER VAV	ROUND SUPPLY AIR AFTER VAV	SUPPLY FAN SUPPLY AIR (SHOP AREA)	RETURN AIR	EXHAUST AIR	TRANSFER AIR	OUTSIDE AIR	RELIEF AIR	NOTE
	UP THRU 12"	26		WHEN LONGEST SIDE IS 36"											
	OVER 12" THRU 30"	24		OR GREATER, SHALL BE											
LOW PRESSURE	OVER 30" THRU 54"	22	2" W.G.	CONSTRUCTED USING			1/2" LINER	1-1/2"	1-1/2"	1/2" LINER	1-1/2", SEE NOTE 6	1" LINER	2"	2"	1,2, 4,5,
DUCTWORK	OVER 54" THRU 84"	20	_	DUCTMATE							SEE NOTE O				4,5,
	OVER 84"	18		35/25 SLIDE ON SYSTEM,											
	UP THRU 18"	24		T SH AELA NG E CONSTRUCTED											
MEDIUM	OVER 19" THRU 48"	22		USING											1,2,
PRESSURE DUCTWORK	OVER 48" THRU 72"	20	3" W.G.	DUCTMATE 35/25 SLIDE	1-1/2"	1-1/2"	-	-	-	-	-	-	-	-	4,5
	OVER 73" THRU 96"	18		ON SYSTEMS, TDF FLANGE											
HUMIDIFIER PIPING	-	-	-	-	-	-	-	-	-	-	-	-	-	-	7

						HUMID	IFIE	R SO	CHED	ULE				HUM
EQUIP.							E	LECTRICAL			DU	СТ	UNIT	
NO.	MANUFACTURER & MODEL	LOCATION	SERVING	QUANTITY	LBS/HR	V./PH./CY.	FLA	MCA	MOCP	INPUT (KW)	W (IN)	H (IN)	l	NOTES
HUM-1	CONDAIR EL 030	MECH 141	AHU - 1	1	26.4	480/3/60	13.5	16.9	20	11.2	46	18	55	1,2,3,4,5,6,7

1,2,3,4,5,6,7

1,2,3,6,7,8

4. CONCEALED DUCTS MAY BE INSULATED WITH RIGID BOARD OR FLEXIBLE FIBERGLASS INSULATION. EXPOSED DUCTS SHALL BE INSULATED WITH RIGID BOARD FIBERGLASS INSULATION ONLY. DUCTS ROUTED IN EXPOSED CEILINGS WITH ACOUSTICAL

5. ALL EXPOSED DUCTWORK WITH NO EXTERIOR INSULATION SHALL BE PAINTGRIP DUCT (SPIRAL WHERE ROUND).
6. ALL EXHAUST DUCTWORK SERVING INLINE EXHAUST FANS SHALL BE INSULATED BETWEEN INLINE EXHAUST FAN AND LOUVER TERMINATION. DUCTWORK BEFORE EXHAUST FANS TO BE UNINSULATED, PAINTGRIP WHERE EXPOSED.
7. ALL HUMIDIFIER STEAM, STEAM CONDENSATE AND DRAINAGE PIPING SHALL BE INSULATED WITH 1" THICK EXTERIOR PIPE INSULATION.

 HUM-3
 CONDAIR RH2+ SPACE
 SERVER 126
 1
 6.9
 208/1/60
 12.7
 15.8
 20
 2.6
 22.0
 NOTES: 1. DISCONNECT BY EC.

3: 1. DISCONNECT BY EC.
2. PROVIDE WITH INTERFACE TO BAS SYSTEM. TC TO PROVIDE DEMAND SIGNAL.
3. PROVIDE WITH IN-LINE WATER FILTER C/W 5 MICRON FILTER AND DOUBLE CHECK VALVE FOR PC TO INSTALL ON WATER INLET.
4. PROVIDE & INSTALL STAINLESS STEEL SHORT ABSORPTION MANIFOLD, DRAIN WATER COOLER, AND ALL STEAM, STEAM CONDENSATE AND DRAINAGE PIPING.
5. PROVIDE WITH AIRFLOW PROVING SWITCH TO BE INSTALLED IN THE SUPPLY AIR DUCT.

 HUM-2
 CONDAIR EL 050
 MECH 141
 AHU-2
 1
 34.4
 480/3/60
 22.5
 28.2
 30
 18.7
 46
 18
 150

6. INSTALL PER MANUFACTURER'S RECOMMENDATIONS.

7. PROVIDE EXTRA HUMIDIFICATION CYLINDER TO OWNER. 8. UNIT SHALL INCLUDE INTEGRAL BLOWER PACK FOR DIRECT SPACE HUMIDIFICATION AND INTERNAL DRAIN WATER TEMPERING.

BAFFLES ARE CONSIDERED EXPOSED AND MUST BE WRAPPED WITH RIGID INSULATION WHERE INDICATED TO BE WRAPPED.

			HIGH	-EFFI	CIENCY	DEHUMI	DIFIER	SCHE	DULE	D
EQUIP.	MANUFACTURER & MODEL	SERVING	LOCATION	CFM	WATER REMOVAL (PINTS/DAY)	WATTS	MOTOR VOLT./PH./CY.	FLA	UNIT WEIGHT (LBS)	NOTES
D-1	HI-E DRY 195	WAREHOUSE 101	WAREHOUSE 101	540	192	1250	120/1/60	12.0	180	1,2,3,4,5
D-2	HI-E DRY 195	WAREHOUSE 101	WAREHOUSE 101	540	192	1250	120/1/60	12.0	180	1,2,3,4,5

NOTES: 1. PROVIDE WITH FACTORY INSTALLED 6'-0" POWER CORD, 115 VOLT WITH GROUND, WITH INTEGRAL CONTROLS. 2. PROVIDE WITH INTERNAL CONDENSATE PUMP AND 20'-0" CONDENSATE HOSE TO SECOND REMOTE CONDENSATE PUMP.

3. PROVIDE & INSTALL SUPPORT STRUCTURE SUSPENDED FROM EXISTING SHOP ROOF STRUCTURE WITH VIBRATION ISOLATION FOR INSTALLATION IN SHOP 61. DO NOT USE WALL MOUNT BRACKET.

4. PROVIDE WITH 2 EXTRA SETS OF 16"X16"X2" MERV-6 PLEATED FILTERS. 5. WATER REMOVAL CAPACITY IS BASED ON 80°F AIR TEMPERATURE AND 60% RELATIVE HUMIDITY.

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SE PROJECT NO: 240700836

ISSUE: 5/15/2025 100% CONSTRUCTION DOCUMENTS REVISION SCHEDULE: REV. # REV. DSC. REV. DATE

PROJECT: NORTHERN ELECTRIC COOPERATIVE ABERDEEN, SOUTH DAKOTA

SHEET TITLE: MECHANICAL SCHEDULES

					ELE(CTRIC B	OILER	SCHED	ULE							B
				PRESSURE					MAIN ELECT	RICAL		CONTROL CIRC	JIT ELEC			
EQUIP. NO.	MANUFACTURER & MODEL	LOCATION	MEDIA	RELIEF (PSI)	KW	STAGES @ (KW)	BTU/HR	V./PH./CY.	TOTAL FLA	FEED #1 FLA (100KW)	FEED #2 FLA (80KW)	V./PH./CY.	FLA	SCCR (KAIC)	WEIGHT (LBS)	NOTES
B-1	ELECTRO INDUSTRIES EB-NB-180-480	MECH 141	35% PROPYLENE GLYCOL	125	180	9@(20)	614,185	480/3/60	216.5	120.3	96.2	120/1/60	15.0	100	705 + FLUID	1,2,3,4,5, 6,7,8,9,10

NOTES: 1. DISCONNECT PROVIDED & INSTALLED BY EC.

2. INSTALL TO PROVIDE MINIMUM CLEARANCE FOR SERVICING & ELEMENT CHANGE OUT PER MANUFACTURERS RECOMMENDATIONS.

3. UNITS SHALL BE COMPLETE WITH ALL NECESSARY SAFETIES AND CONTROL TO MEET OR EXCEED U.L. AND SOUTH DAKOTA CODE REQUIREMENTS. 4. PROVIDE BOILER WITH FACTORY INSTALLED LOW WATER CUT OFF W/ MANUAL RESET, HIGH TEMP LIMIT SWITCH, SAFETY DOOR INTERLOCK & LOCKABLE DOOR LATCH, BMS REMOTE SETPOINT CONTROL, GROUND FAULT DETECTION AND AUTO AIR VENT. 5. PERFORMANCE BASED ON 35% PROPYLENE GLYCOL.

6. SEE BOILER PIPING DIAGRAM.

7. PROVIDE W/ OPTIONAL 125 PSI VESSEL & 125 PSI RELIEF VALVE & BAS INTERFACE.

8. PROVIDE FIELD INSTALLED EXTERNAL WATER FLOW SWITCH & OTHER ACCESSORIES AS REQUIRED. TC TO WIRE FLOW SWITCH. 9. PC TO INSTALL TEMPORARILY IN EXG STORAGE 63 FIR TEMP HEAT IN SHOP OVER WINTER OF 2025/2026 BY UTILIZING FEED #2 (80KW) ONLY FOR TEMP LOCATION. PC TO REMOVE & REINSTALL INTO FINAL LOCATION IN

MECH 141 AFTER HEATING SEASON. COORDINATE WITH OTHER TRADES. SEE TEMPORARY HYDRONIC SYSTEM PIPING DIAGRAM. 10. GC TO PROVIDE & INSTALL 4" POURED CONCRETE HOUSEKEEPING PAD. PC TO COORDINATE PAD SIZE & LOCATION REQUIREMENTS WITH GC.

		OWNER	PROVI	DED HYE	BRID ELI	ECTRIC	WATE	R HE	ATER	SCHE	DULE			WH
EQUIP. NO.	MANUFACTURER & MODEL	SERVING	LOCATION	STORAGE Capacity	RECOVERY @ 90F RISE	V./PH./CY.	ELECTRICAL	AMPS	PIPING CO	DNNECTIONS H.W.	DIMEN	DIAMETER	WEIGHT (LBS.)	NOTES
WH - 1	(OWNER PROVIDED) RHEEM PRESTIGE PROTERRA PROPH80 RH400-30	DOMESTIC HOT WATER	MECH 141	80 GAL.	27 GAL/HR	208/1/60	4500	21	3/4"	3/4"	76-13/16"	24-1/4"	306 + WATER	1,2,3,4,5

NOTES: 1. WATER HEATER PROVIDED BY OWNER, INSTALLED BY PC. EC TO PROVIDE AND INSTALL DISCONNECT.

2. PROVIDE & INSTALL AMTROL ST-12C-DD EXPANSION TANK.

3. GC TO PROVIDE & INSTALL 4" POURED CONCRETE HOUSEKEEPING PAD. PC TO COORDINATE PAD SIZE & LOCATION REQUIREMENTS WITH GC.

4. SEE ELECTRIC WATER HEATER PIPING & CONTROL DIAGRAM. 5. PROVIDE & INSTALL LAWLER NEPTUNE EMX 075 THERMOSTATIC MIXING VALVE.

		DOMES	TIC COLD V	WATER ST	TORAGE TAI	NK SCH	EDULE			ST
EQUIP.							PIPING CONNECTIO	NS	SHIPPING	
NO.	MANUFACTURER & MODEL	SERVING	FUEL SOURCE LOCATION STORAGE CAPACITY		VENT	CW IN/OUT	RECIRC OUT	WEIGHT (LBS)	NOTES	
ST-1	PENTAIR 30X60 COMP	DOMESTIC COLD WATER	-	MECH 141	151 GAL.	2.5"	2.5"	-	205	1,2,3
ST-2	PENTAIR 30X60 COMP	DOMESTIC COLD WATER	-	MECH 141	151 GAL.	2.5"	2.5"	-	205	1,2,3
NOTES:	1. SEE WATER HEADER DIAGRA	AM.					•			

2. GC TO PROVIDE & INSTALL 4" POURED CONCRETE HOUSEKEEPING PAD. PC TO COORDINATE PAD SIZE & LOCATION REQUIREMENTS WITH GC. 3. PROVIDE WITH MINIMUM 75 PSI WORKING PRESSURE, VACUUM BREAKER, AND AUTOMATIC AIR VENT.

			P	PUMP	SCHE	DULE							CP
EQUIP.	MANUFACTURER & MODEL	SERVING	LOCATION	GPM	HEAD	FLUID TEMP	TYPE		ELE	CTRICAL		WEIGHT	NOTES
NO.	MANOFACIONEN & MODEL	SERVING	LUCATION	GFW	(FT)	(°F)	IIFE	HP/W	RPM	V./PH./CY.	FLA	(LBS.)	NOTES
CP-1	BELL & GOSSETT 80-SC 3X3X9.5C	PRIMARY HEATING WATER	MECH 141	220	65	110.0	IN LINE	7.5	1750	480/3/60	11.0	345	1,2,3,4,5
CP-2	BELL & GOSSETT 80-SC 3X3X9.5C	BACKUP HEATING WATER	MECH 141	220	65	110.0	IN LINE	7.5	1750	480/3/60	11.0	345	1,2,3,4,5
CP-3	BELL & GOSSETT 80-SC 3X3X11B	PRIMARY CHILLED WATER	MECH 141	140	90	44.0	IN LINE	10	1750	480/3/60	14.0	430	1,2,3,4,5
CP-4	BELL & GOSSETT 80-SC 3X3X11B	BACKUP CHILLED WATER	MECH 141	140	90	44.0	IN LINE	10	1750	480/3/60	14.0	430	1,2,3,4,5
CP-5	BELL & GOSSETT 80-SC 3X3X11B	PRIMARY WELL FIELD	MECH 141	192	90	35.0	IN LINE	15	1750	480/3/60	21.0	485	1,2,3,4,5
CP-6	BELL & GOSSETT 80-SC 3X3X11B	BACKUP WELL FIELD	MECH 141	192	90	35.0	IN LINE	15	1750	480/3/60	21.0	485	1,2,3,4,5
CP-7	BELL & GOSSETT PL-130/2"	CIRCULATOR FOR B-1	MECH 141	60	10	110.0	IN-LINE	2/5	3200	120/1/60	4.8	22.0	1,2,7
CP-8	BELL & GOSSETT NBF-36	DOM HW RECIRC.	MECH 141	4.5	20	120.0	IN LINE	(270)	3300	120/1/60	2.3	13.1	1,6,7
CP-9	BELL & GOSSETT PL-45/1-1/2"	IN-FLOOR HEAT CIRCULATOR	STORAGE 63	20	15	110.0	IN-LINE	1/6	3300	120/1/60	2.1	14.5	1,2,7

NOTES: 1. PUMP SHALL HAVE PRESSURE GAUGE ACROSS PUMP SUCTION & DISCHARGE FOR BALANCING PURPOSES. SEE IN-LINE PUMP DETAIL. PERFORMANCE BASED ON 35% PROPYLENE GLYCOL.

3. PROVIDE & INSTALL NON-SLAM CHECK VALVE, MANUAL BALANCING VALVE & SUCTION DIFFUSER.

4. T.C. TO PROVIDE VFD, E.C. TO INSTALL. 5. PROVIDE & INSTALL 60 MESH STRAINER WITH VALVE BLOWDOWN.

6. PUMP SHALL BE OF LEAD FREE BRONZE CONSTRUCTION PROVIDED WITH SHUT-OFF FLANGES. CONTROL BY TC. SEE ELECTRIC WATER HEATER PIPING & CONTROL DIAGRAM. 7. PROVIDE WITH FACTORY CORD CONNECTION.

			ŀ	TOF	WATE	ER H	ANG]	ING	UNIT	HE	ATER					HUH
EQUIP. NO.	MANUFACTURER & MODEL	LOCATION	CFM	МВН	GPM	LAT	EWT	LWT	WPD	НР	ELECT V/PH/CY	RICAL RPM	FLA	RUNOUT SIZE	UNIT WEIGHT (LBS)	NOTES
HUH-1	SIGMA CORP 084H	LOCKERS 61A	1610	32.6	4.0	79.7	130.0	110.5	0.80	1/6	120/1/60	1625	1.8	1"	76.0 + WATER	1,2,3,4
HUH-2	SIGMA CORP 084H	EXG MEZZANINE 201	1610	32.6	4.0	79.7	130.0	110.5	0.80	1/6	120/1/60	1625	1.8	1"	76.0 + WATER	1,2,3,4

NOTES: 1. UNIT SHALL BE HORIZONTAL, PROPELLER UNIT HEATER. 2. PERFORMANCE BASED ON 35% PROPYLENE GLYCOL.

3. PROVIDE WITH UNIT MOUNTED 3 SPEED SWITCH. DISCONNECT BY EC. 4. SEE HOT WATER UNIT HEATER PIPING DETAIL.

EXPANSION TANK SCHEDULE

QUIP. NO.	MANUFACTURER & MODEL	LOCATION	SERVING	CALCULATED SYSTEM VOLUME	SYSTEM VOLUME WITH SAFETY		RANGE F)		RE RANGE	REQ'D TANK Volume	REQ'D ACCEPTANCE VOLUME	ACTUAL TANK VOLUME	ACTUAL ACCEPTANCE VOLUME	WEIGHT (LBS)	NOTES
NO.				(GAL)	FACTOR (GAL)	MAX	MIN	MAX	MIN	(GAL)	(GAL)	(GAL)	(GAL)	(LBS)	
ET-1	WESSELS FXA-200	MECH 141	DOMESTIC WATER	-		60	40	60	40	41	41	53	53	210 + WATER	1,2,4
ET-2	BELL & GOSSETT B-800	MECH 141	ALL HYDRONIC PIPING SYSTEMS	2220	3330	130	40	70.0	16.9	164.8	103.1	211.0	211.0	475 + WATER	3,4,5,6,7

NOTES: 1. PROVIDE POTABLE WATER ASME RATED FULL ACCEPTANCE REPLACEABLE BLADDER STYLE UNIT, DIAPHRAGM STYLE SHALL NOT BE ACCEPTABLE. 2. SEE DOMESTIC WATER HEADER AND BOOSTER PUMP PIPING DIAGRAM.

3. UNIT TO BE FLOOR MOUNTED, VERTICAL ASME PRE-CHARGED BLADDER STYLE EXPANSION TANK.

4. GC TO PROVIDE & INSTALL 4" POURED CONCRETE HOUSEKEEPING PAD. PC TO COORDINATE PAD SIZE & LOCATION REQUIREMENTS WITH GC. 5. THE EXPANSION TANK HAS BEEN SIZED FOR 3330 GALLONS, WHICH IS 1.5 TIMES THE CALCULATED VOLUME OF 2220 GALLONS.

6. PERFORMANCE BASED ON 35% PROPYLENE GLYCOL. 7. SEE CENTRAL GEOTHERMAL HEATING/CHILLED WATER SYSTEM CONTROL & PIPING DIAGRAM.

			AIR SEP	ERATOR SCHED	ULE		AS
EQUIP. NO.	MANUFACTURER & MODEL	LOCATION	SERVING	SYSTEM FLOW (GPM)	PRESSURE DROP (FT. W.G.)	WEIGHT (LBS)	NOTES
AS-1	BELL & GOSSETT ROLAIRTROL R-4	MECH 141	HOT WATER HEATING LOOP	220	1.73	278	1,2
AS-2	BELL & GOSSETT ROLAIRTROL R-4	MECH 141	CHILLED WATER LOOP	140	0.71	278	1,2

NOTES: 1. TANGENTIAL FLOW THROUGH TYPE AIR SEPERATOR WITH STRAINER. PROVIDE WITH MANUAL BLOW DOWN VALVE AND VALVED HIGH CAPACITY AIR VENT.

PACKAGED DOMESTIC WATER SERVICE BOOSTER PUMP SYSTEM SCHEDULE

ET

EQUIP.	MANUFACTURER & MODEL	LOCATION	GPM HEA			ľ	MOTOR		SHIPPING WEIGHT	NOTES
NO.	MAROI AOTORER & MODEL	LOCATION	(PSI) PRESSURE (PSI)	НР	RPM	V./PH./CY.	FLA	(LBS)	NOTES
DD 1	GOULDS 22SV3GH4F60	MECH 141	95	50	7-1/2	3600	400 / 2 / 60	00	1667 + WATER	10045670
BP - 1	GOULDS 22SV3GH4F60	MECH 141	95	50	7-1/2	3600	480/3/60	23	1667 + WATER	1,2,3,4,5,6,7,8

NOTES: 1. UNIT SHALL BE PROVIDED WITH PRESSURE RELIEF VALVE, STAINLESS STEEL PUMPS, SHUT-OFF VALVES ON SUCTION AND DISCHARGE OF PUMP. 2. HEADER AND INTERCONNECTING PIPES SHALL BE STAINLESS STEEL 304.

3. PROVIDE CONTROL PANEL: THE CONTROL PANEL SHALL BE NEMA 1 RATED. THE PANEL FEATURES SHALL INCLUDE A CONTROL POWER TRANSFORMER, HAND-OFF-AUTO SWITCH FOR PUMP, A GREEN LIGHT FOR PUMP RUN INDICATION, AND A RED LIGHT TO INDICATE UNIT SHUT-DOWN. PROVIDE SYSTEM WITH SINGLE POINT POWER

CONNECTION & FACTORY INSTALLED DISCONNECT. PROVIDE VARIABLE SPEED DRIVES WITH VARIABLE SPEED PUMP CONTROLLER. 4. BOOSTER SYSTEM TO CONSIST OF 2 PUMPS. LOW NPSH SUCTION (SUPPLY) PRESSURE FROM GROUND LEVEL STORAGE TANK.

PROVIDE FACTORY AUTHORIZED STARTUP.

6. SEE DOMESTIC WATER HEADER AND BOOSTER PUMP PIPING DIAGRAM. 7. GC TO PROVIDE & INSTALL 4" POURED CONCRETE HOUSEKEEPING PAD. PC TO COORDINATE PAD SIZE & LOCATION REQUIREMENTS WITH GC.

8. PC TO PROVIDE AND INSTALL FLANGED FLEX CONNECTIONS.

DOMESTIC &	HYDRONIC	PIPING	MATERIAL	&	INSULATION	SCHEDULE

	PIPING			INSULATION THICKNESS		
SYSTEM	TYPE/MATERIAL	FITTINGS	PIPE SIZES 1" OR SMALLER	PIPE SIZES 1-1/4" TO 2"	PIPE SIZES 2-1/2" AND LARGER	NOTES
DOMESTIC COLD, HOT, AND HOT RECIRC	TYPE L COPPER, UPONOR PEX-A	SOLDER, PRO-PRESS, UPONOR F1960 EXPANDABLE FITTINGS	1/2"	1"	1-1/2"	1,2,4
ABOVE GRADE STORM PIPING	SEE SPECIFICATIONS (SCH 40 PVC WHERE PERMITTED)	SEE SPECIFICATIONS (SCH 40 DWV SOLVENT WELD WHERE PERMITTED)		1"		1,3
BELOW GRADE SANITARY WASTE & VENT PIPING	SEE SPECIFICATIONS (SCH 40 PVC WHERE PERMITTED)	SEE SPECIFICATIONS (SCH 40 DWV SOLVENT WELD WHERE PERMITTED)		NONE		1
ABOVE GRADE SANITARY WASTE & VENT PIPING	SEE SPECIFICATIONS (SCH 40 PVC WHERE PERMITTED)	SEE SPECIFICATIONS (SCH 40 DWV SOLVENT WELD WHERE PERMITTED)		NONE		1,3
CHILLED WATER SUPPLY & RETURN & AIR SEPARATOR	TYPE L COPPER, SCH 40 BLACK STEEL	SOLDER, PRO-PRESS, SEE SPECS FOR STEEL FITTINGS	1/2"	1"	1-1/2"	1,2,4
HEATING WATER SUPPLY & RETURN & AIR SEPARATOR & BYPASS FILTER FEEDER	TYPE L COPPER, SCH 40 BLACK STEEL	SOLDER, PRO-PRESS, SEE SPECS FOR STEEL FITTINGS	1/2"	1"	1-1/2"	1,2,4
BELOW GRADE GEOTHERMAL SUPPLY & RETURN	SEE SPECIFICATION	SEE SPECIFICATIONS		NONE		1,2
ABOVE GRADE GEOTHERMAL SUPPLY & RETURN	SEE SPECIFICATION	SEE SPECIFICATIONS	1	П	1-1/2"	1,2
CONDENSATE DRAIN PIPING/ VENTING	TYPE M COPPER, (SCH 40 PVC WHERE PERMITTED)	SOLDER, PRO-PRESS, (SCH 40 DWV SOLVENT WELD WHERE PERMITTED)		1/2"		1,3

NOTES: 1. SEE SPECIFICATIONS.

2. IF USING UPONOR PEX-A PIPING, NO CRIMP FITTINGS SHALL BE ACCEPTED. CONTRACTOR MUST BE TRAINED AND FOLLOW ALL MANUFACTURER'S RECOMMENDATIONS AND MUST FULFILL ALL AVAILABLE UPONOR 25 YEAR FITTING AND PIPE SYSTEM WARRANTY COVERAGE.

3. NO UNINSULATED PVC PIPING ALLOWED IN SUPPLY/RETURN AIR PLENUMS. PIPING MUST BE CAST IRON WHERE ROUTED THROUGH RETURN AIR PLENUMS, INSULATED PVC WILL NOT BE ACCEPTABLE. SEE HVAC PLANS FOR PLENUM LOCATIONS, COORDINATE WITH VC.

4. PIPING MUST BE COPPER OR STEEL WHERE ROUTED EXPOSED IN THE BUILDING. PEX PIPING WITH STRAIGHTENERS WILL NOT BE PERMISSIBLE IN THESE AREAS, BUT WILL BE PERMISSIBLE WHERE ROUTED IN MECHANICAL ROOMS AND WHERE CONCEALED ABOVE CEILINGS AND IN WALLS.

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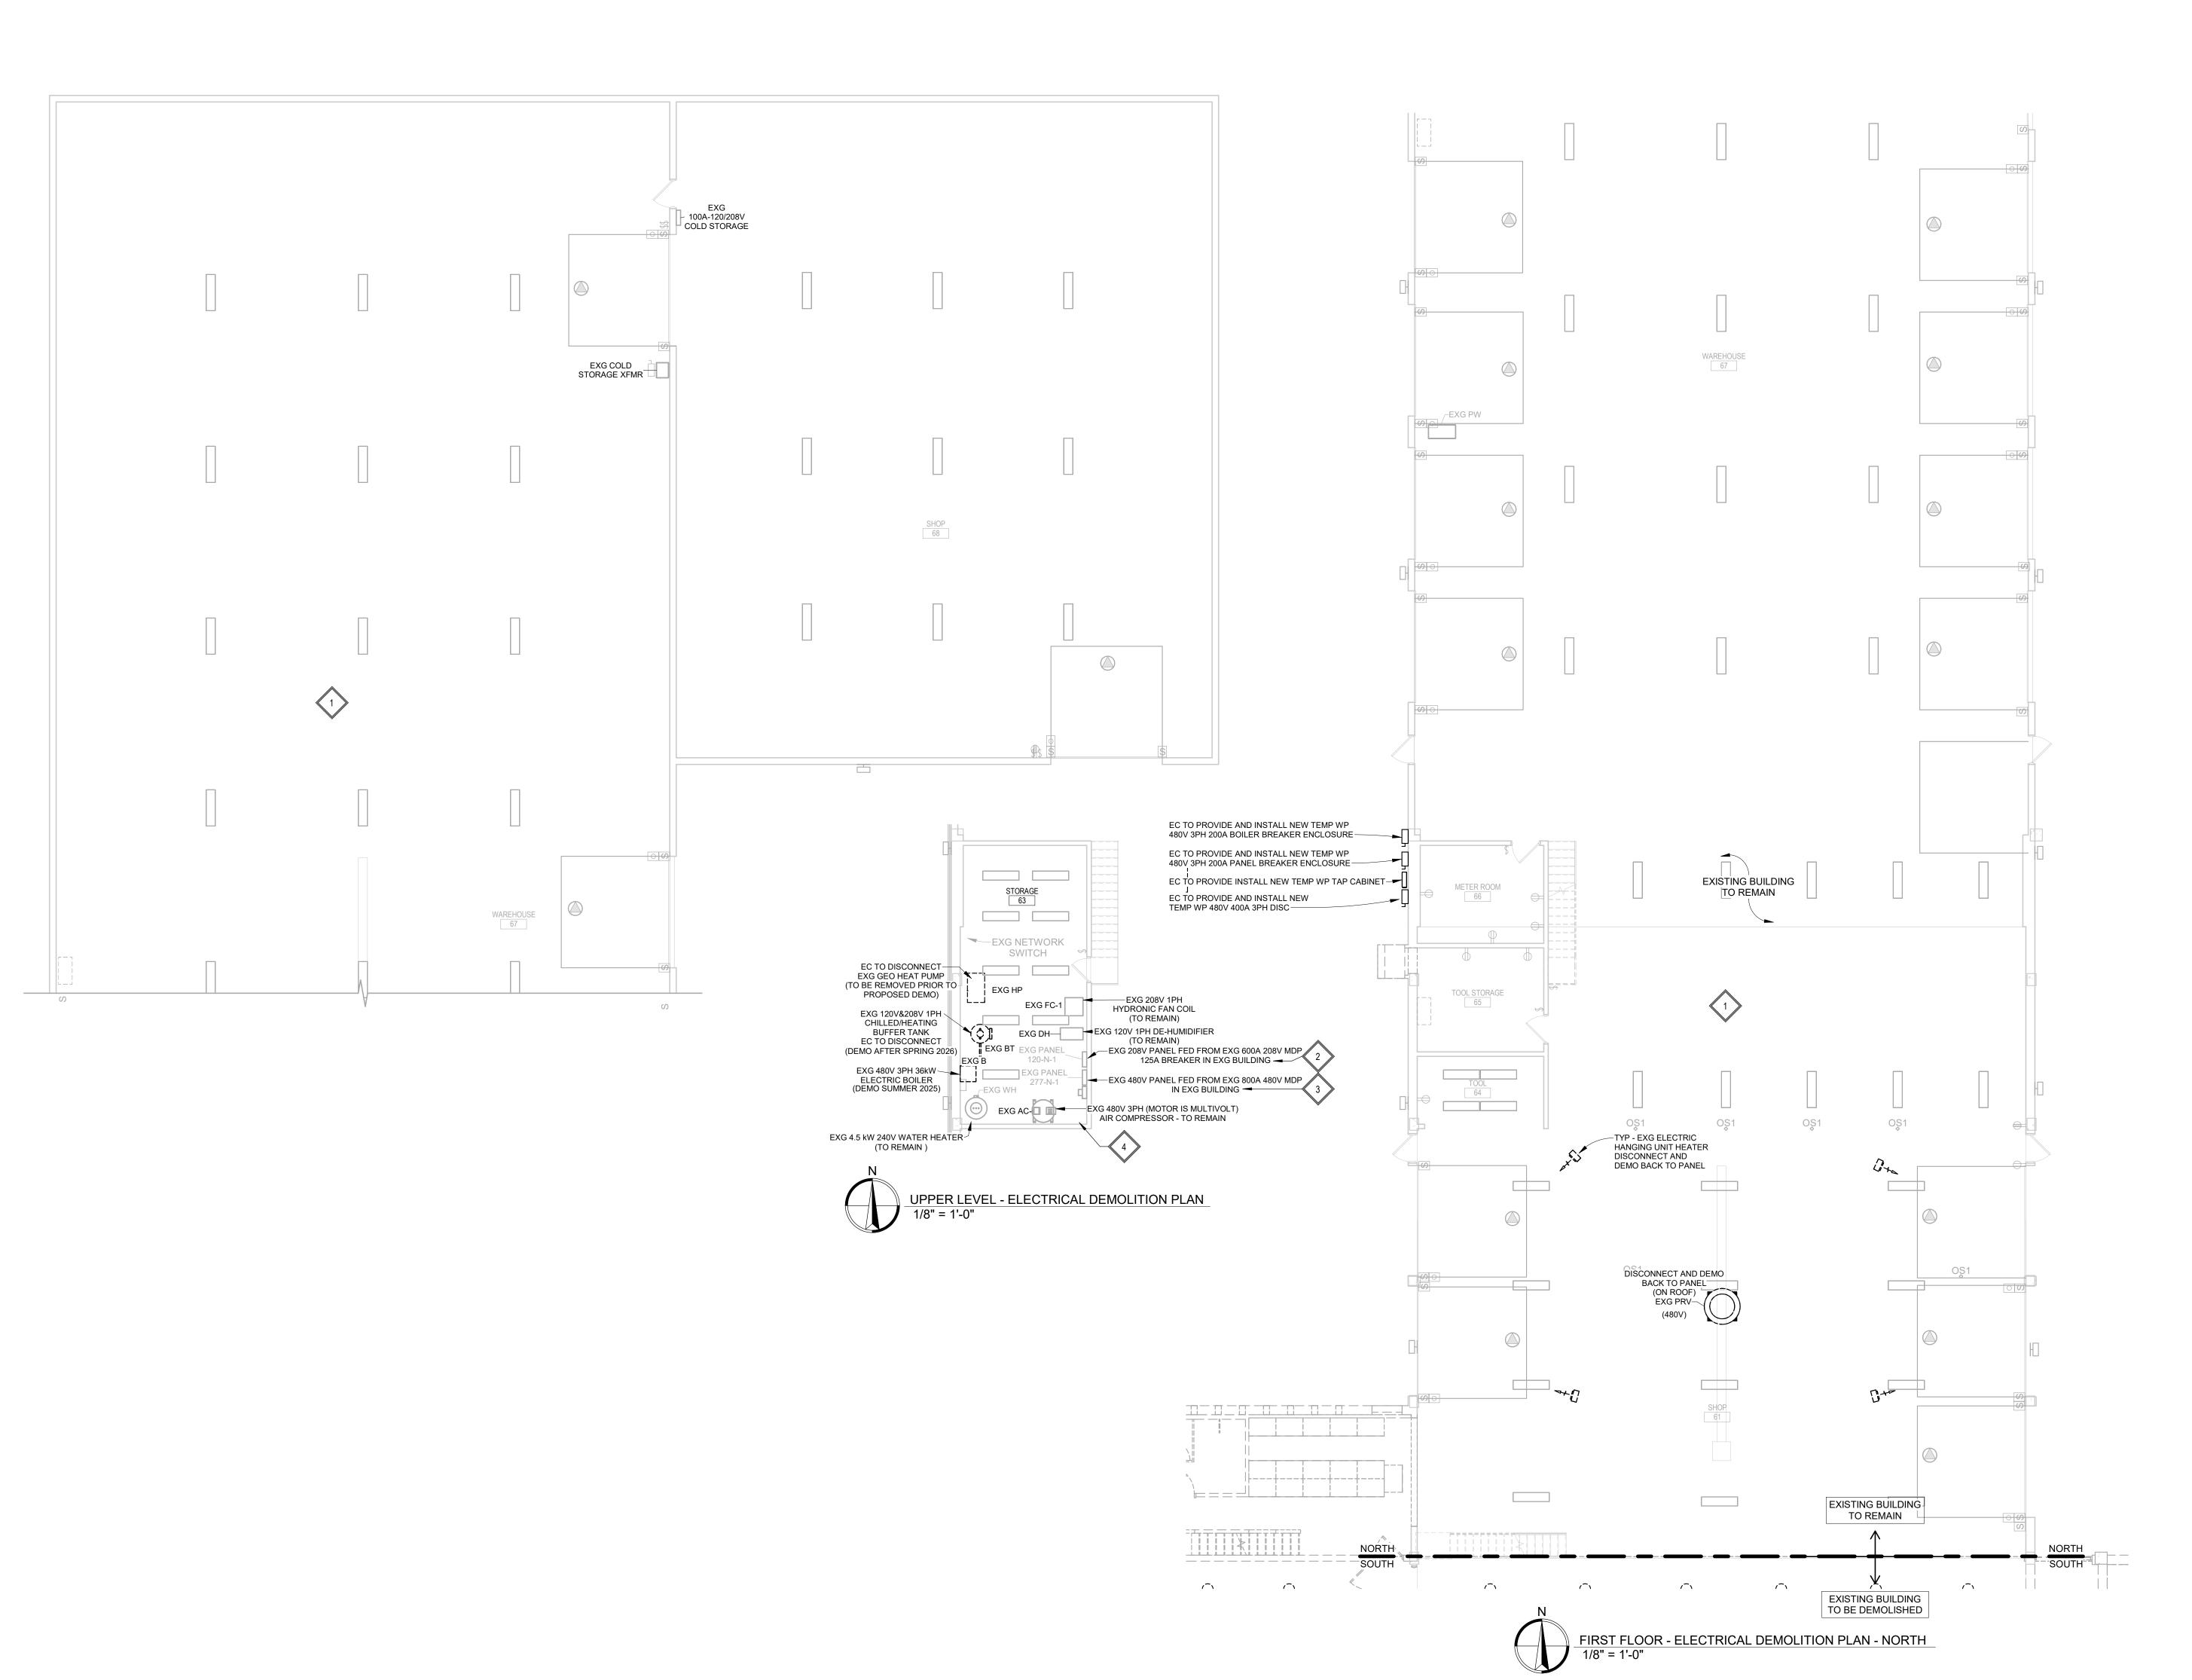
SE PROJECT NO: 240700836



5/15/2025 100% CONSTRUCTION DOCUMENTS REVISION SCHEDULE: REV. # REV. DSC. REV. DATE

PROJECT: NORTHERN ELECTRIC COOPERATIVE ABERDEEN, SOUTH DAKOTA

SHEET TITLE: MECHANICAL SCHEDULES -CONTINUED



GENERAL DEMOLITION NOTES:

- A. PERFORM ALL DEMOLITION WORK AS REQUIRED AND REMODELING WORK AS SHOWN ON THE DRAWINGS INCLUDING MINOR ITEMS OF MATERIAL OR EQUIPMENT NECESSARY TO MEET THE REQUIREMENTS AND INTENT OF THE
- B. PRIOR TO SUBMITTING BID, CONTRACTOR SHALL EXAMINE ALL GENERAL CONSTRUCTION DRAWINGS AND SHALL HAVE HAD VISITED THE CONSTRUCTION SITE. THE CONTRACTOR SHALL BE FAMILIAR WITH THE EXISTING CONDITIONS UNDER WHICH HE/SHE WILL HAVE TO OPERATE AND WHICH WILL IN ANY WAY AFFECT THE WORK UNDER THIS CONTRACT IN BEHALF OF THE CONTRACTOR FOR ANY ERROR OR NEGLIGENCE ON HIS/HER PART.
- C. CERTAIN REMODELING OF ELECTRICAL FACILITIES WILL BE REQUIRED IN THE EXISTING BUILDING. EXISTING CONDUIT RUNS ARE GENERALLY NOT SHOWN, ALTHOUGH A FULL ATTEMPT HAS BEEN MADE TO SHOW SOME OF EXISTING CONDITIONS, OF WHICH INFORMATION HAS BEEN TAKEN FROM EXISTING RECORD DRAWINGS OF THIS PROJECT. THE DRAWINGS SHOWING LOCATIONS OF EXISTING EQUIPMENT, OUTLETS, FIXTURES, ETC. IN EXISTING AREA ARE APPROXIMATE ONLY (FIELD VERIFY).
- D. BRANCH CIRCUITS SHALL BE REUSED WHERE PRACTICAL AND SHALL, IN ADDITION, BE REMODELED AS REQUIRED. THE CONTRACTOR SHALL CONCEAL ALL WORK WHERE POSSIBLE. WHERE EXPOSED WORK IS REQUIRED IN FINISHED AREAS, THE CONTRACTOR SHALL USE SURFACE MOUNTED, MULTI-OUTLET RACEWAY, PANDUIT T70 SERIES. EXISTING RUNS SHALL BE VERIFIED.
- E. EXISTING ELECTRICAL WIRING WHICH WILL NOT BE MADE OBSOLETE AND WHICH WILL BE DISTURBED DUE TO CONSTRUCTION CHANGES REQUIRED BY THIS CONTRACT SHALL BE RESTORED TO OPERATION CONDITION. AS REQUIRED AND/OR DIRECTED. WHERE REQUIRED, SHOW AND/OR DIRECTED, OUTLETS AND CONDUIT RUNS SHALL BE RELOCATED. IN SOME CASE, IT MAY BE NECESSARY TO EXTEND CONDUITS AND PULL IN NEW WIRING OR INSTALL JUNCTION BOXES AND SPLICE IN NEW WIRING OR REPLACE OLD WIRING WITH NEW.
- F. OUTLETS FROM WHICH FIXTURES, SWITCHES, RECEPTACLES, AND/OR OTHER ELECTRICAL DEVICES ARE MOVED AND WHICH ARE NO REPLACED OR REUSED SHALL BE REMOVED. WHERE OUTLETS, BOXES, ETC. ARE COMPLETELY REMOVED, THE CONTRACTOR SHALL CUT OFF CONDUITS AND REMOVE WIRING. CONTRACTORS RESPONSIBILITY FOR LEGAL DISPOSAL.
- G. WHERE EXISTING LIGHT FIXTURES ARE TO BE RE-USED, THE CONTRACTOR SHALL CLEAN THE FIXTURE, REPLACE LAMPS, AND REPAIR OR REPLACE DEFECTIVE PARTS, INCLUDING LENSES, BALLASTS, ETC. AS REQUIRED.
- H. WHERE CONDUCTORS EXTENDING THOUGHT THE FLOORS ARE TO BE ABANDONED, THE CONTRACTOR SHALL CUT AN CAP OR PLUG CONDUIT, SO THAT IT WILL NOT PROTRUDE ABOVE THE FLOOR.
- I. WHERE EXISTING CONDUIT IS ABANDONED, THE CONDUIT SHALL BE REMOVED IF IT IS EXPOSED, INTO A CRAWL SPACE OR ACCESSIBLE CEILING. WHERE IT IS IMPOSSIBLE TO REMOVE THE CONDUIT, IT SHALL BE CUT OFF AND CAPPED OR PLUGGED.
- J. THE CONTRACTOR SHALL BE HELD RESPONSIBLE FOR THE PROPER RESTORATION OF ALL EXISTING SURFACES REQUIRING PATCHING, PLASTERING, PAINTING AND/OR OTHER REPAIR DUE TO THE INSTALLATION OF ELECTRICAL WORK UNDER THE TERMS OF THIS CONTRACT. CLOSE ALL OPENINGS, REPAIR ALL SURFACES, ETC. AS REQUIRED.
- K. THE CONTRACTOR SHALL EMPLOY QUALIFIED AND EXPERIENCED WORKMEN FOR THIS WORK. ALL RESTORATION WORK SHALL BE SUBJECT TO THE APPROVAL OF THE ARCHITECT AND/OR THE OWNER.
- L. ALL TEMPORARY AND REMODELING WORK SHALL BE CONSIDERED A PART OR THIS CONTRACT AND NO EXTRA CHARGES WILL BE ALLOWED. THIS SHALL INCLUDE MINOR ITEMS OF MATERIAL OR EQUIPMENT NECESSARY TO MEET THE REQUIREMENTS AND INTENT OF THE PROJECT.
- M EXAMINE ARCHITECTURAL STRUCTURAL AND MECHANICAL DRAWINGS AND SPECIFICATIONS TO DETERMINE THE SEQUENCE OF CONSTRUCTION THROUGHOUT THE PROJECT, INCLUDING EXISTING, TEMPORARY, REMODELED AND NEW AREAS.
- N. THE OWNER RESERVES THE RIGHT TO RETAIN ANY SELECTED SALVAGED ITEMS, ALL OTHER ITEMS SHALL BE THE CONTRACTORS RESPONSIBILITY FOR LEGAL

KEYNOTES:

- 1. BY ADD ALTERNATE TYPICAL FOR ALL NEW LIGHT FIXTURES SHOWN ON PROPOSED. EC TO DISCONNECT & REMOVE EXG LIGHT FIXTURE TO ALLOW FOR NEW LED LIGHTS.
- 2. DEMO EXG CONDUCTORS AND CONDUITS SERVING EXG PANEL 120-N-1 FROM EXG SOUTH BUILDING MCC. PANEL TO BE RE-SUPPLIED FROM NEW TEMPORARY CIRCUIT BREAKER DISCONNECT AND NEW 75kVA TRANSFORMER MOUNTED TO EXTERIOR OF EXG SHOP.
- 3. DEMO EXG CONDUCTORS AND CONDUITS SERVING EXG PANEL 277-N-1 FOR EXG SOUTH BUILDING MCC. PANEL TO BE RE-SUPPLIED FROM NEW TEMPORARY CIRCUIT BREAKER DISCONNECT ENCLOSURE MOUNTED TO EXTERIOR OF EXG
- 4. ELECTRICAL CONTRACTOR TO TEMORARILY RELOCATE EXG GENERATOR TO SERVE EXG SHOP DURING CONSTRUCTION. REWORK CONDUIT AND CONDUCTORS AS REQUIRED TO SUPPLY EXG PANEL 120-N-1 WITH TEMPORARY RELOCATED EXG ATS.

<u>KEYPLAN</u>

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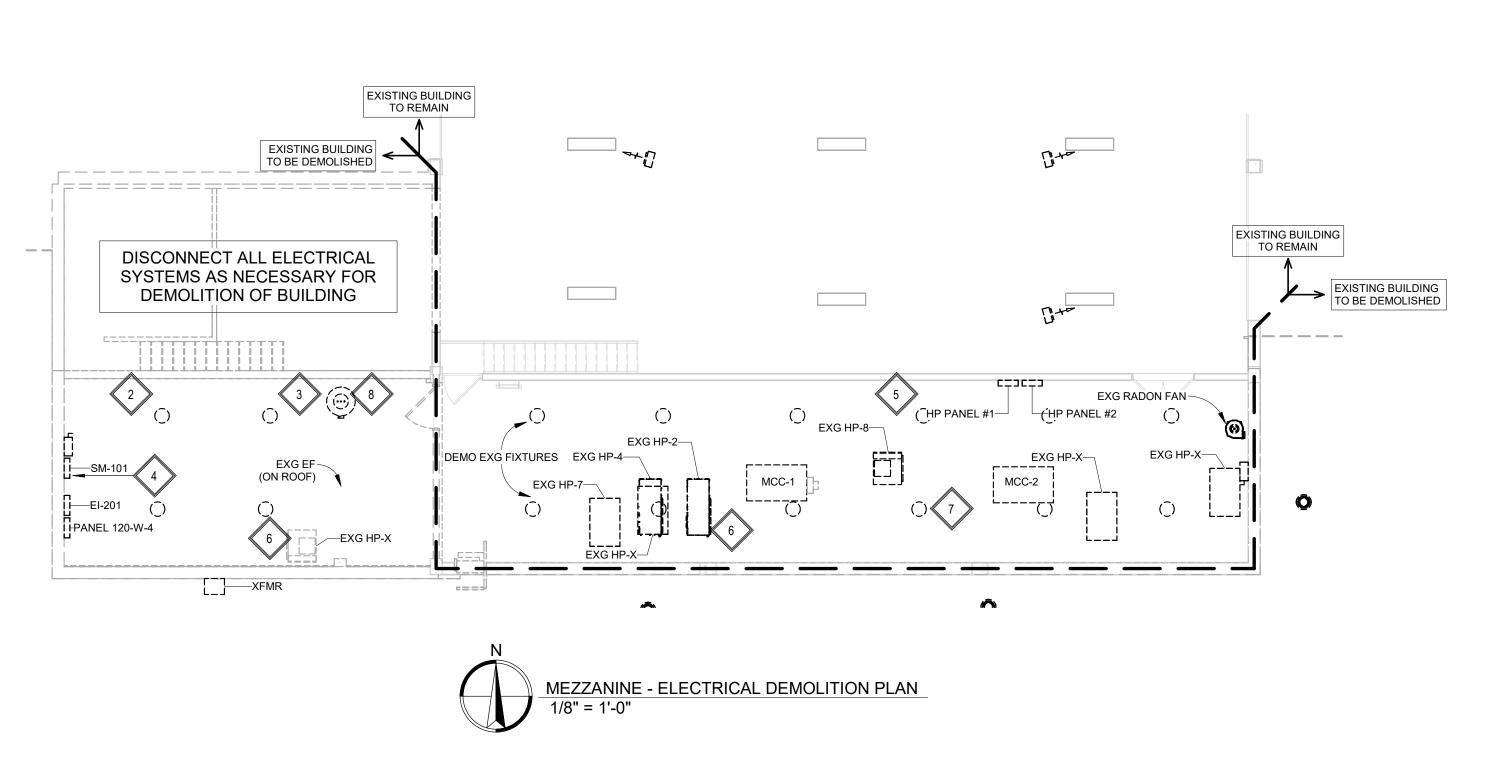
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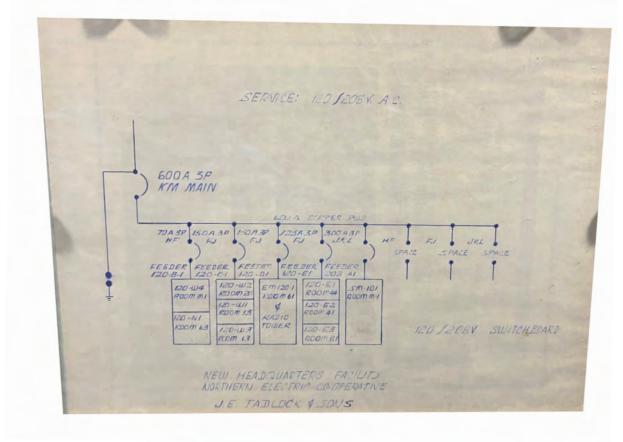
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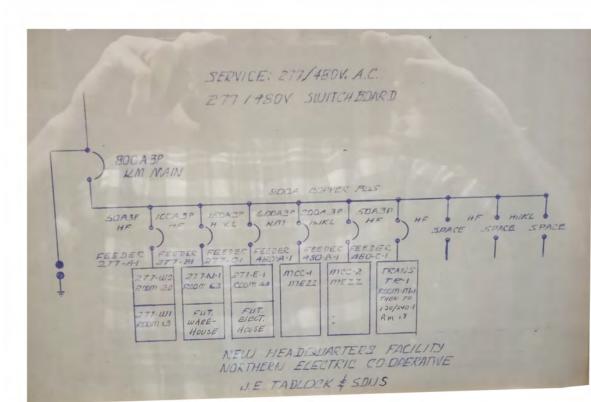
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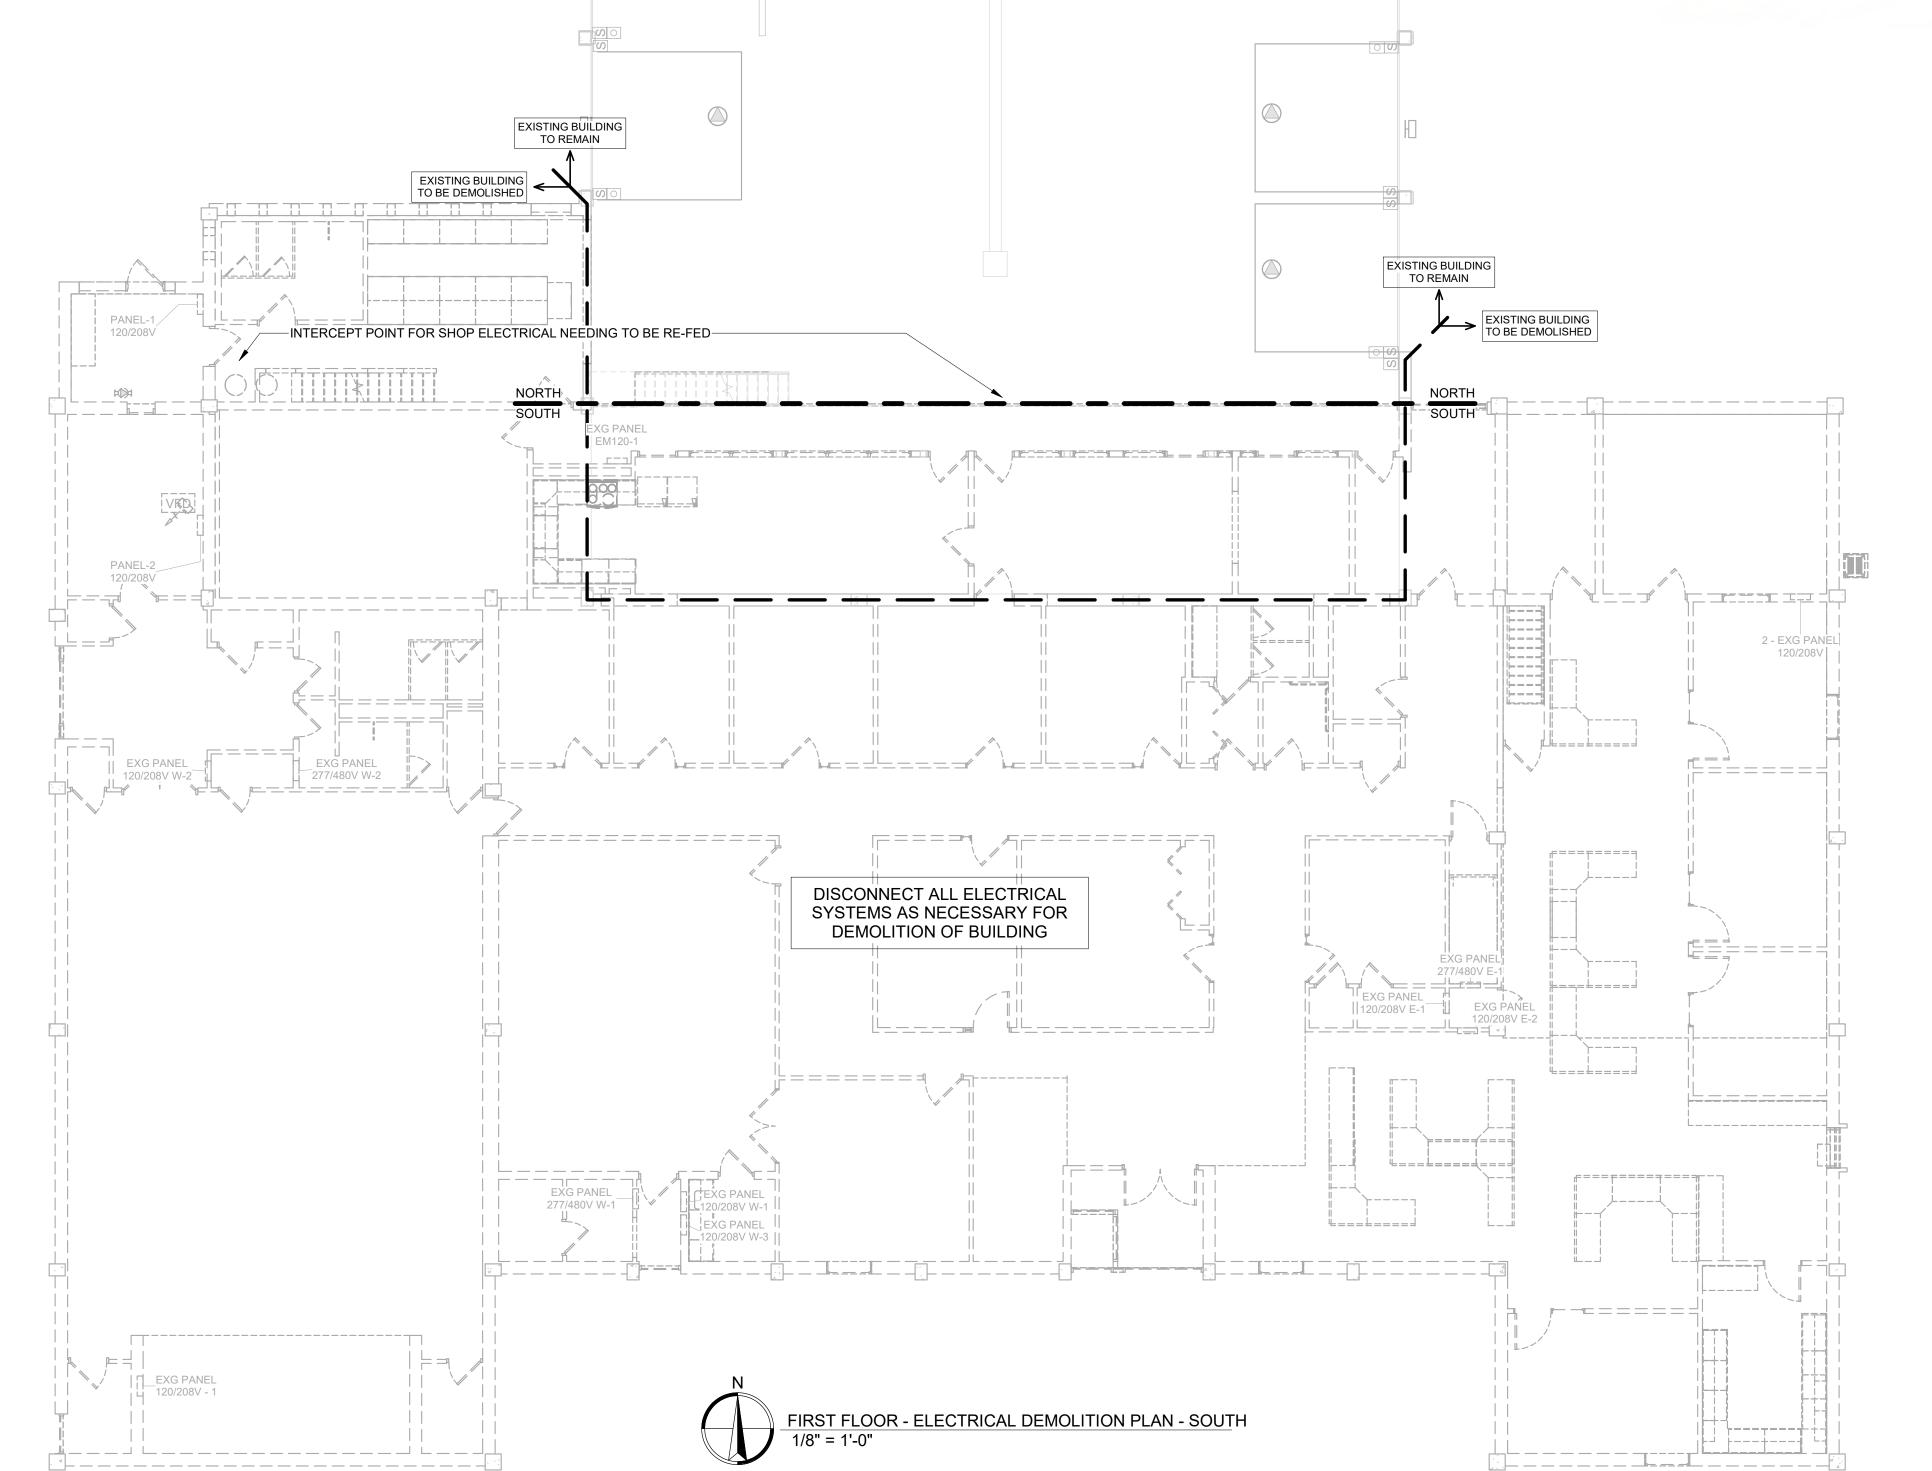
SHEET TITLE: ELECTRICAL DEMOLITION PLAN


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GENERAL DEMOLITION NOTES:

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- E. EXISTING ELECTRICAL WIRING WHICH WILL NOT BE MADE OBSOLETE AND WHICH WILL BE DISTURBED DUE TO CONSTRUCTION CHANGES REQUIRED BY THIS CONTRACT SHALL BE RESTORED TO OPERATION CONDITION, AS REQUIRED AND/OR DIRECTED. WHERE REQUIRED, SHOW AND/OR DIRECTED, OUTLETS AND CONDUIT RUNS SHALL BE RELOCATED. IN SOME CASE, IT MAY BE NECESSARY TO EXTEND CONDUITS AND PULL IN NEW WIRING OR INSTALL JUNCTION BOXES AND SPLICE IN NEW WIRING OR REPLACE OLD WIRING WITH NEW.
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- M. EXAMINE ARCHITECTURAL, STRUCTURAL AND MECHANICAL DRAWINGS AND SPECIFICATIONS TO DETERMINE THE SEQUENCE OF CONSTRUCTION THROUGHOUT THE PROJECT, INCLUDING EXISTING, TEMPORARY, REMODELED AND NEW AREAS.
- N. THE OWNER RESERVES THE RIGHT TO RETAIN ANY SELECTED SALVAGED ITEMS, ALL OTHER ITEMS SHALL BE THE CONTRACTORS RESPONSIBILITY FOR LEGAL

KEYNOTES

- ELECTRICAL CONTRACTOR TO TEMORARILY RELOCATE EXG GENERATOR TO SERVE EXG SHOP DURING CONSTRUCTION. REWORK CONDUIT AND CONDUCTORS AS REQUIRED TO SUPPLY EXG PANEL 120-N-1 WITH
- 2. DISCONNECT EXG CONDUCTORS SERVING 120-N-1 AND CONNECT TO NEW
- 3. DISCONNECT EXG CONDUCTORS SERVING 277-N-1 AND CONNECT TO
- 4. DISCONNECT ALL CONDUCTORS FEEDING EXTERIOR PANELS AND
- 5. DISCONNECT CONDUITS AND SERVING SHOP EQUIPMENT. RE-FEED SHOP EQUIPMENT AS REQUIRED FORM EXG PANELS 277-N-1 AND 120-N-1.
- 7. DISCONNECT AND REMOVE MEZZANINE LIGHTING BY MATCH LINE FOR
- 8. COORDINATE WITH VC FOR DISCONNECTION OF ANY HVAC EQUIPMENT IN EXG MEZZANINE.

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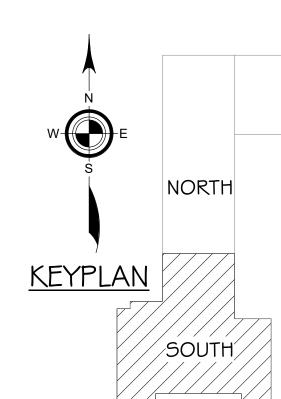
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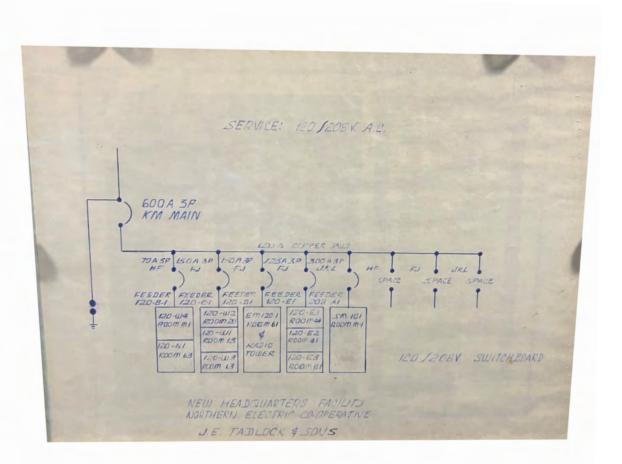
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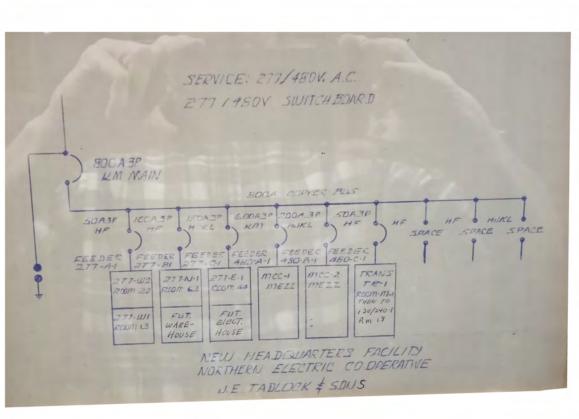
PROJECT: NORTHERN ELECTRIC COOPERATIVE ABERDEEN, SOUTH DAKOTA

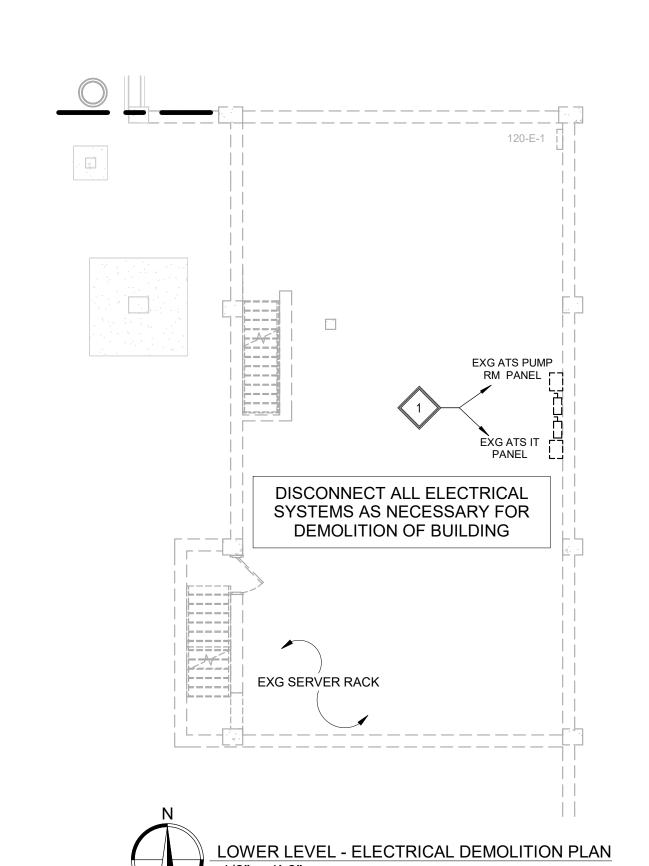SHEET TITLE: **ELECTRICAL DEMOLITION PLAN**

E200.S







TEMPORARY RELOCATED EXG ATS.

120/208V XFMR FOR POWER PROVISIONS DURING CONSTRUCTION.


TEMPORARY 277/480V XFMR FOR POWER PROVISIONS DURING CONSTRUCTION.

CHRISTMAS LIGHTING PANELS.

6. DISCONNECT AND REMOVE ALL ELECTRICAL EQUIPMENT IN MEZZANINE AREA (OTHER THAN EXG SHOP MEZZ) FOR BUILDING DEMOLITION. SEE PROPOSED.

INSTALLATION OF NEW LIGHTING. SEE PROPOSED.

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- A. ALL WORK SHALL BE PERFORMED IN A CLEAN AND WORKMANLIKE MANNER.
- B. THE ELECTRICAL CONTRACTOR SHALL BE RESPONSIBLE FOR PATCHING ANY OPENINGS LEFT IN FLOORS, WALLS, AND CEILINGS THAT WERE CAUSED BY HIS/HER ACTIONS. PATCHING SHALL MATCH EXISTING SURFACE IN COLOR, TEXTURE AND QUALITY SO THAT PATCH IS INDISTINGUISHABLE FROM ORIGINAL SURFACE.
- C. ALL PENETRATIONS THROUGH DRAFT STOPS AND OTHER FIRE-RATED PARTITIONS SHALL BE FIRE STOPPED AS PER SPECIFICATIONS AND LOCAL CODES.
- D. ALL ELECTRICAL WORK SHALL BE INSTALLED IN STRICT ACCORDANCE WITH ALL APPLICABLE LOCAL, STATE, NATIONAL ELECTRIC CODE, AND THE AUTHORITY HAVING JURISDICTION.
- E. THE ELECTRICAL DRAWINGS SHOW GENERAL ARRANGEMENT ONLY. EXACT LOCATION SHALL AVOID INTERFERENCE WITH ELECTRICAL EQUIPMENT & REQUIRED ELECTRICAL CLEARANCES.
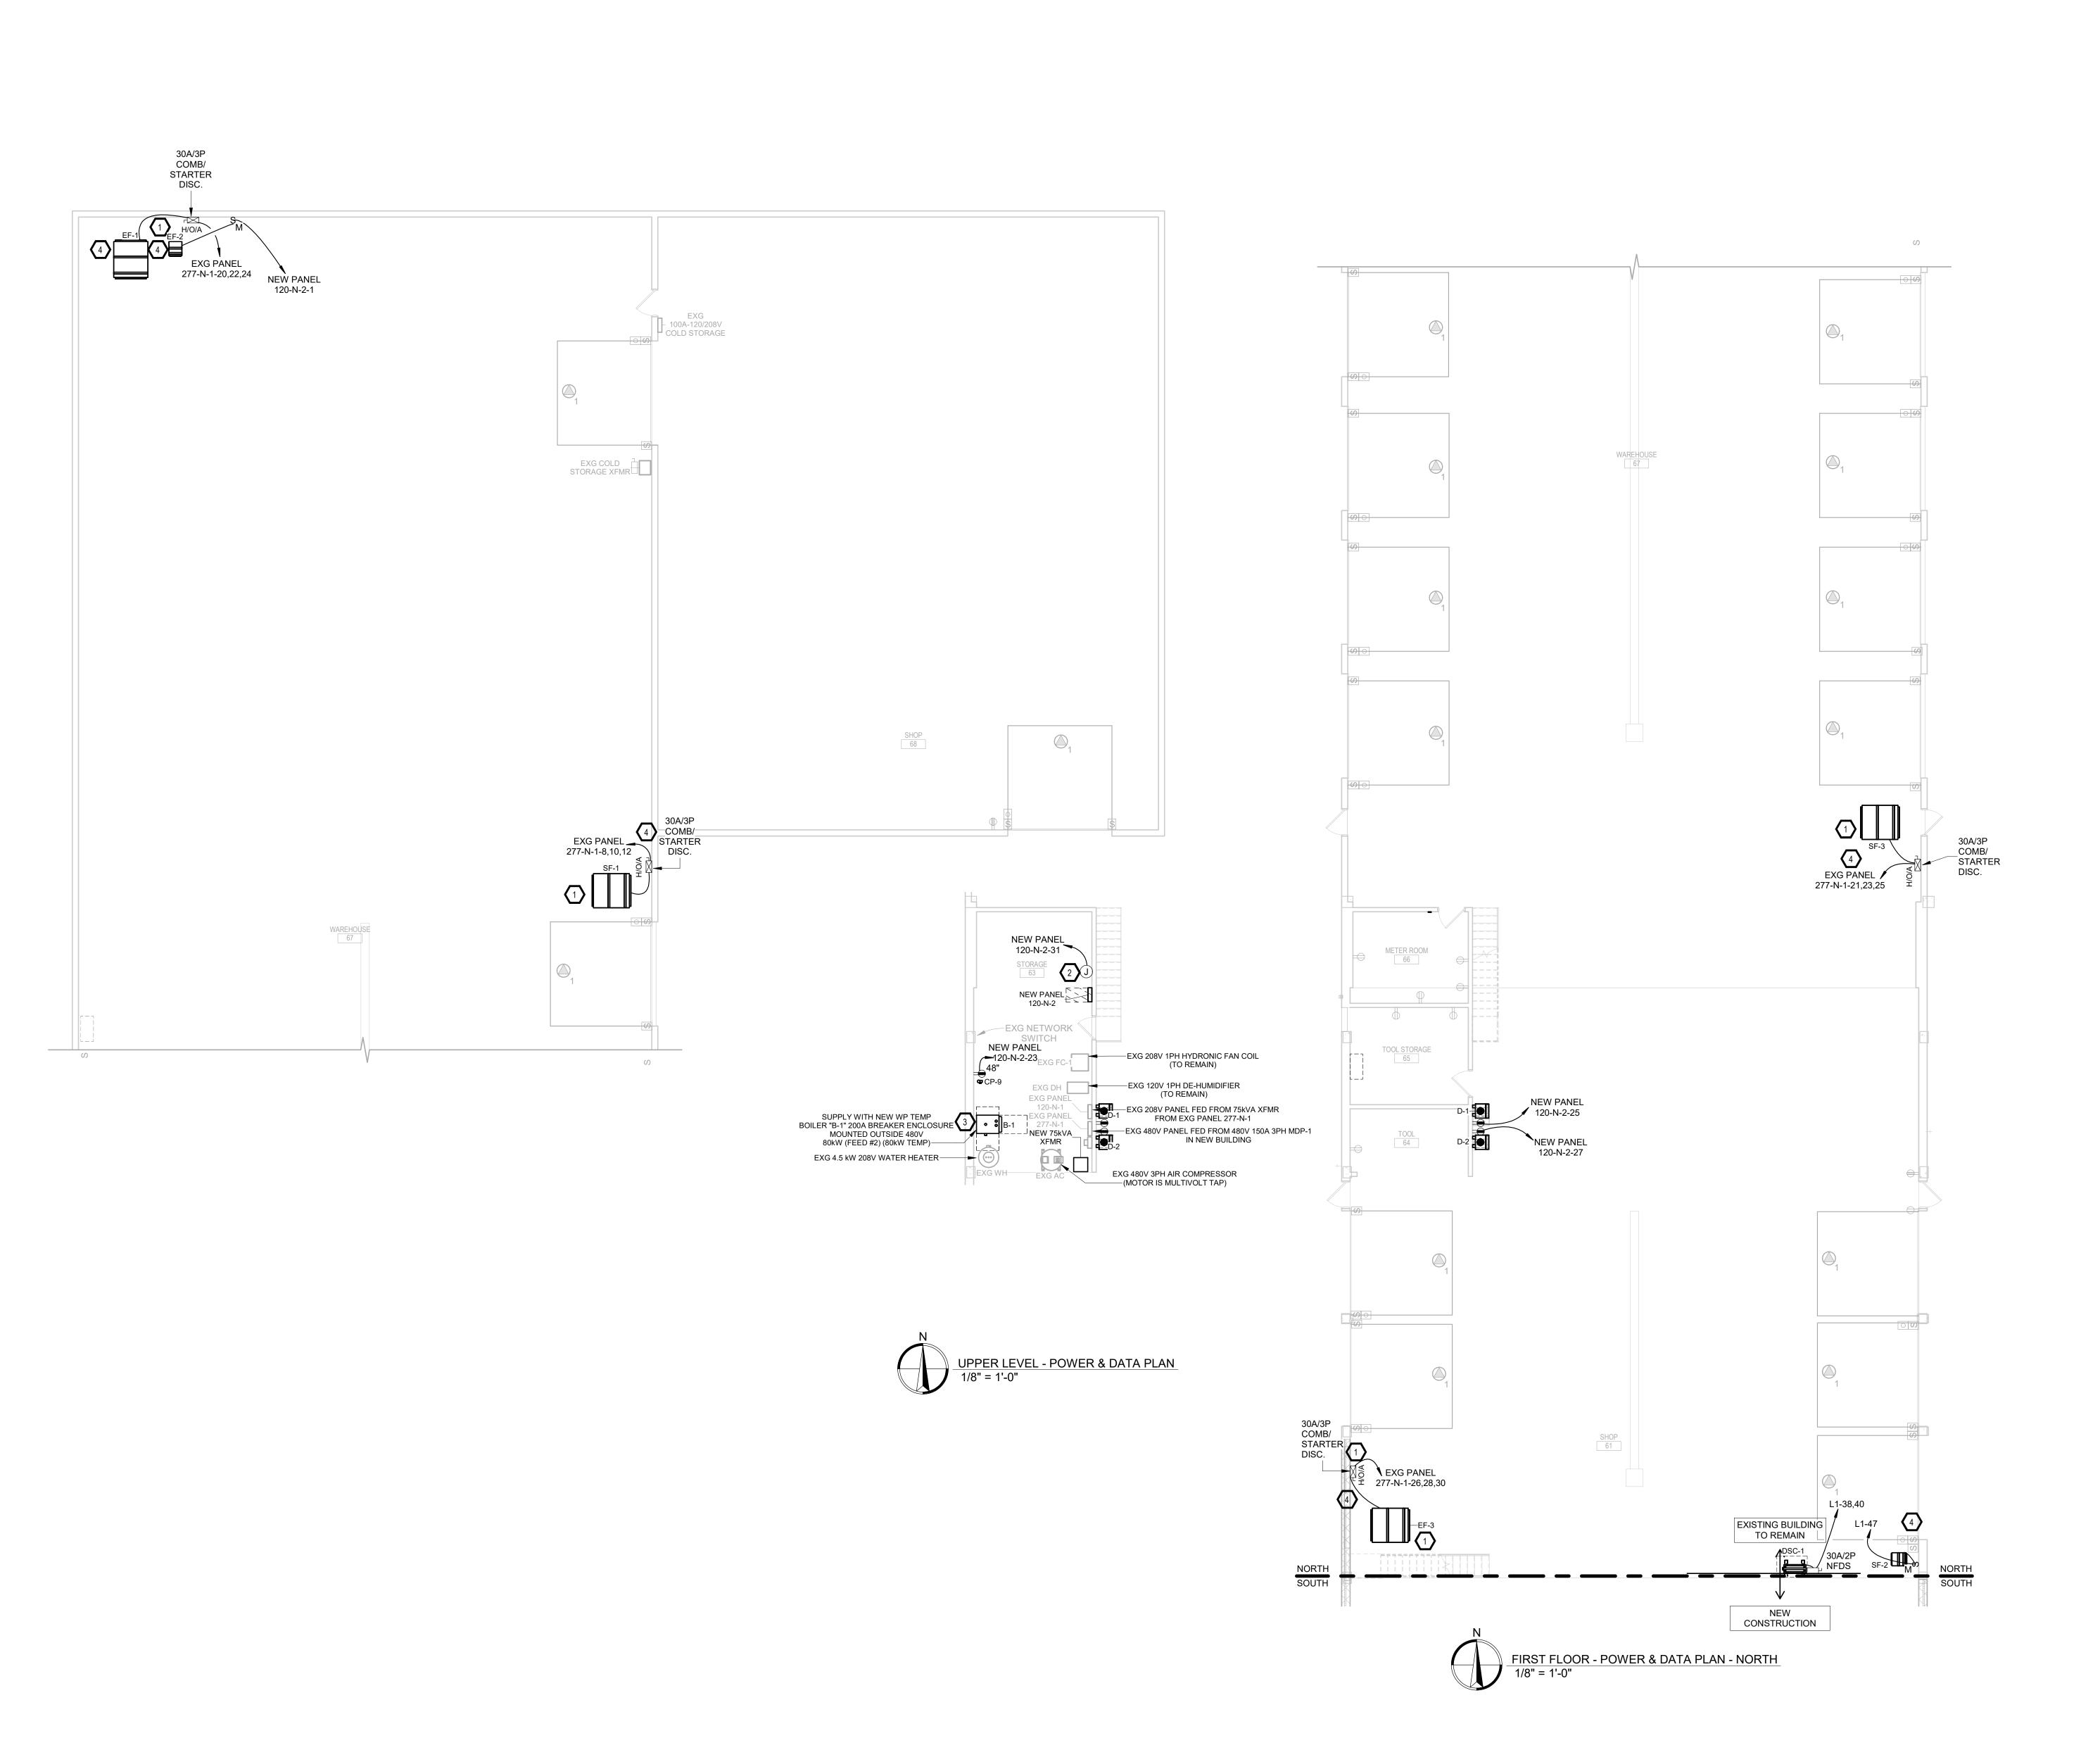
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KEYNOTES

- PROVIDE AND INSTALL COMBINATION STARTER DISCONNECT(S) FOR EXHAUST FANS AND SUPPLY FANS. PROVIDE SIGNAL BACK TO BAS FOR TC TO CONTROL. NO2CO SYSTEM AND SENSORS PROVIDED AND INSTALLED BY
- 2. COORDINATE ADDITIONAL REQUIREMENTS WITH TC.
- 3. DISCONNECT NEW BOILER WHEN RELOCATED TO NEW OFFICE AREA.
- PROVIDE POWER PROVISIONS FROM EXHAUST AND SUPPLY FAN CIRCUIT TO VC PROVIDED LINE VOLTAGE MOTORIZED DAMPER. COORDINATE WITH VC ON LOCATIONS.

SPECIAL OUTLETS

1. EXG OVERHEAD DOOR OPENERS - NO WORK.

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REVISION SCHEDULE:
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PROJECT:
NORTHERN ELECTRIC
COOPERATIVE
ABERDEEN, SOUTH DAKOTA

SHEET TITLE:


<u>KEYPLAN</u>

SOUTH

SHEET TITLE: POWER & DATA PLAN - NORTH

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NORTH

L2-36 L2-38 L2-44 L2-46

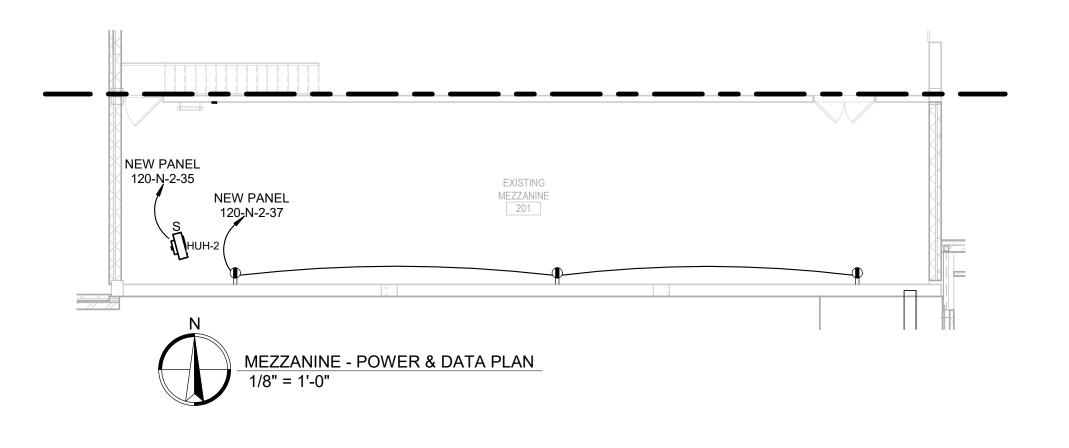WALL


4kW CUH BERKO AWH SERIES

208V 25A/2P W/INTEGRAL TAMPERPROOF SET @ 65


NEW PANEL 120-N-2-33

208V HEAT TRACE SEE EM103

FIRST FLOOR - POWER & DATA PLAN SOUTH
1/8" = 1'-0"

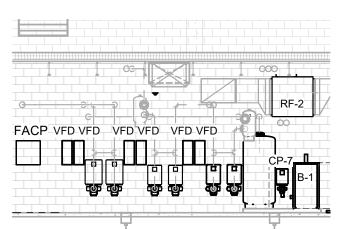

BOILER-1 AND RETURN FAN-1 SCALE: 1/8" = 1'-0"

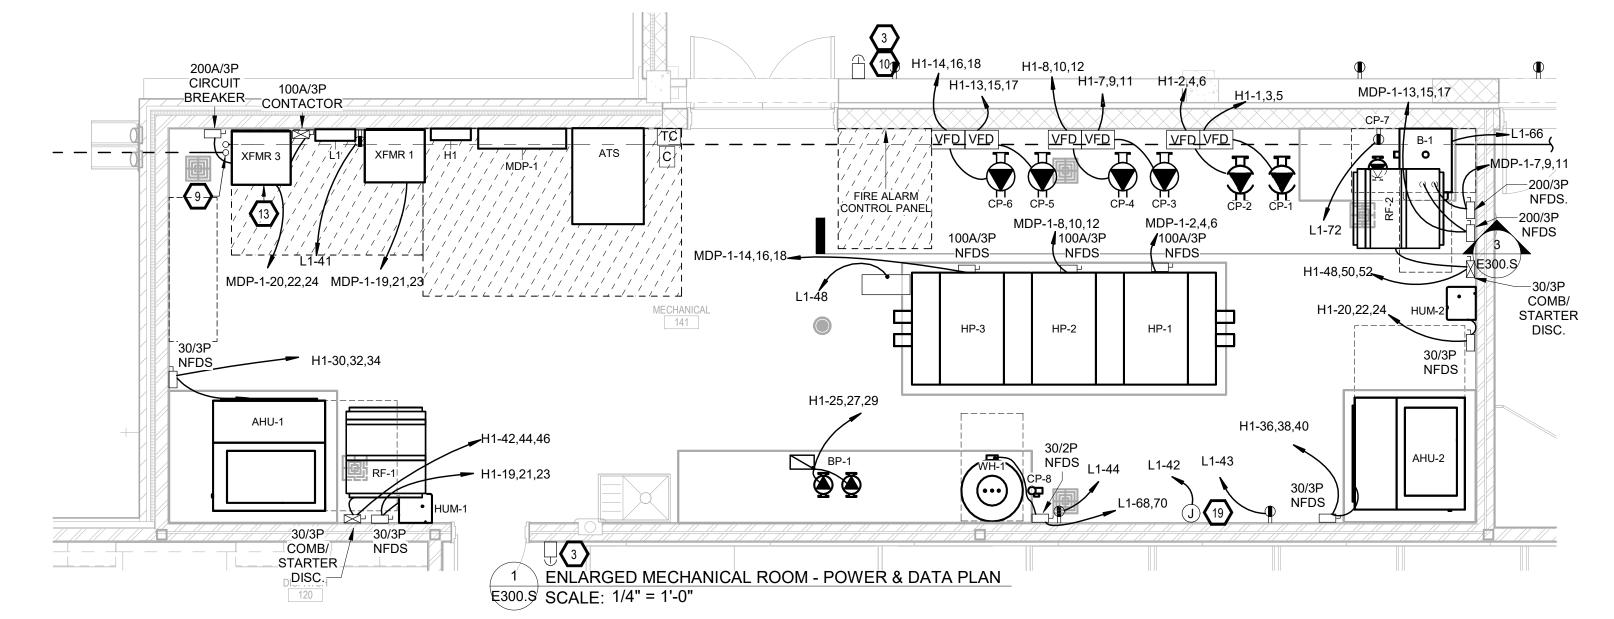

NORTH

L1-59,61,63,65

L1-36 🖡

208V HEAT TRACE SEE EM103

L1-45

NEW PANEL

SEE 'ENLARGED MECHANICAL ROOM -

GENERATOR

-MONITORING PANEL-

SEE ENLARGED SERVER ROOM POWER & DATA PLAN'

FOR CONTINUATION


208V HEAT TRACE SEE EM103

POWER & DATA PLAN' FOR CONTINUATION

120-N-2-29 🔪

EXISTING BUILDING <u>ΓΟ REMAIN</u> _


CONSTRUCTION

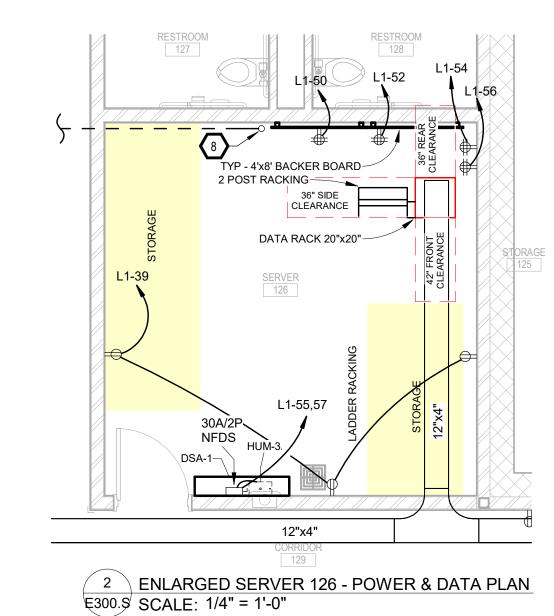

	ELEC	CTRIC H	EATER	SC	HED	ULE	EH
EQUIP. NO.	MANUFACTURERS & MODEL	LOCATION	VOLTS/PHASE	AMPS	WATTS	BTU/HR	NOTES
CUH-1	BERKO FRC4020F	VESTIBULE 100	208	19.2	4000	10,236	CABINET UNIT HEATER WITH TAMPER PROOF THERMOSTAT AND DOUBLE POLE SINGLE THROW SWITCH
CUH-2	BERKO FRC4020F	VESTIBULE 119	208	19.2	4000	10,236	CABINET UNIT HEATER WITH TAMPER PROOF THERMOSTAT AND DOUBLE POLE SINGLE THROW SWITCH
CUH-3	BERKO FRC4020F	VESTIBULE 135	208	19.2	4000	10,236	CABINET UNIT HEATER WITH TAMPER PROOF THERMOSTAT AND DOUBLE POLE SINGLE THROW SWITCH
EH-1	BERKO RCC 10512C	RESTROOM 101A	120	8.8	1050W	3583	COVE HEAT WITH M602W LINE VOLTAGE THERMOSTAT

DATA KEYNOTES

- 1. TYPICAL PROVIDE AND INSTALL (1) 25' HDMI CABLE & (1) CAT6A CABLE
- ROUTED TO WORKSTATION.
- 2. TYPICAL PROVIDE AND INSTALL (1) 50' HDMI CABLE & (1) CAT6A CABLE ROUTED TO WORKSTATION.
- 3. BOARD ROOM & TRAINING ROOM TV LOCATION, PROVIDE AND INSTALL (1) 1-1/4" CONDUIT ROUTED IN 4 11/16" JUNCTION BOX BACK TO AV 136.2. PROVIDE (1) HDMI, (2) CAT 6A AND (1) USB CABLE ROUTED IN CONDUIT. COORDINATE WITH A/V INSTALLER.
- 4. MEETING ROOM WALL 4-11/16" JUNCTION BOX COORDINATE EXACT LOCATION WITH A/V INSTALLER.

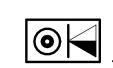

-208V HEAT TRACE SEE EM103

—RANGE HOOD @ 5'

CUH-3

MDP-1-25,27,29

OPEN OFFICE

POWER FOR ILLUMINATED SIGNAGE
SEE ARCHITECTURAL

208V HEAT TRACE SEE EM103

208V HEAT TRACE SEE EM103

-208V HEAT TRACE SEE EM103

DATA KEYNOTES

- 1. PROVIDE AND INSTALL 1-1/4" CONDUIT TO FLOOR T&B 665 BOX WITH (2) CAT6A, HDMI CABLE, (1) USB, MICROPHONE AND AUDIO INPUT CABLE ROUTED TO AV136A IN BOARD ROOM & TRAINING ROOM IN 4-11/16" JUNCTION BOX. COORDINATE WITH A/V INSTALLER.
- 2. PROVIDE AND INSTALL 1-1/4" CONDUIT TO T&B 665 FLOOR BOX WITH (2) CAT6A AND (1) HDMI CABLE ROUTED IN 1" CONDUIT BACK BEHIND TV. COORDINATE WITH A/V INSTALLER.

SPECIAL NOTES:

A. EC TO PROVIDE AND INSTALL ALL ROUGH-INS AND TERMINATIONS OF ALL CAT6A CABLING. ALL CAT6A CABLING SHALL BE CLEARLY LABELED AT BOTH ENDS OF CABLE IN A PRINTED LABEL TYPE.

GENERAL NOTES:

A. ALL WORK SHALL BE PERFORMED IN A CLEAN AND WORKMANLIKE

B. THE ELECTRICAL CONTRACTOR SHALL BE RESPONSIBLE FOR PATCHING ANY OPENINGS LEFT IN FLOORS, WALLS, AND CEILINGS THAT WERE CAUSED BY HIS/HER ACTIONS. PATCHING SHALL MATCH EXISTING SURFACE IN COLOR, TEXTURE AND QUALITY SO THAT PATCH IS INDISTINGUISHABLE FROM

C. ALL PENETRATIONS THROUGH DRAFT STOPS AND OTHER FIRE-RATED PARTITIONS SHALL BE FIRE STOPPED AS PER SPECIFICATIONS AND LOCAL

D. ALL ELECTRICAL WORK SHALL BE INSTALLED IN STRICT ACCORDANCE WITH ALL APPLICABLE LOCAL, STATE, NATIONAL ELECTRIC CODE, AND THE AUTHORITY HAVING JURISDICTION.

EXACT LOCATION SHALL AVOID INTERFERENCE WITH ELECTRICAL EQUIPMENT & REQUIRED ELECTRICAL CLEARANCES.

KEYNOTES

- 2. TYPICAL TV DATA INSTALL TWO GANG BOX OPENING AND PROVIDE (2) CAT 6 CABLES IN 1" CONDUIT ROUTED TO CABLE TRAY IN CORRIDOR. PULL ' CABLES TO SERVER ROOM 120 AS NOTED ON PLAN. LEAVE 15' SERVICE
- 3. PROVIDE AND INSTALL STANDARD MUSHROOM BOILER SHUTDOWN
- 4. PROVIDE AND INSTALL PROVISIONS FOR 120V HAND DRYER(S) PROVIDED BY GC. REFER TO A402 FOR ELEVATIONS AND ROUGH-IN HEIGHT. COORDINATE
- 5. PROVIDE AND INSTALL 250V, 50A 4 WIRE FOR RANGE NEMA 1450R
- 6. POWER, LIGHTING & SPECIAL SYSTEMS PROVISIONS TO BE ROUTED ABOVE

- ROUTED TO THE WEST PAST BUILDING CONCRETE. (1) ROUTED TO EAST PAST BUILDING CONCRETE. COORDINATE EXACT LOCATION WITH OWNER.
- INSTALL IN CLOSET AV 136A. BY DEDUCT ALTERNATE OMIT ELECTRICAL CONNECTION, CONDUIT, AND CONDUCTORS TO ELECTRIC OPERABLE WALL
- 12. PROVIDE AND INSTALL DURESS BUTTON EQUAL TO UBIQUITI # "UA-BUTTON".
- 13. PROVIDE AND INSTALL NEW TRANSFORMER CONTROLLED BY 100A COMBINATION MOTOR STARTER WITH HAND/OFF/AUTO TO OPERATE NEW
- 14. TYPICAL PROVIDE AND INSTALL T&B 664 WITH BLACK ALUMINUM COVER. COLOR CONFIRMED WITH ARCHITECT. 1" C. MINIMUM FOR DATA UNLESS NOTED OTHERWISE, 3/4" C. MINIMUM FOR POWER UNLESS NOTED
- OTHERWISE. COORDINATE LOCATION(S) WITH OWNER.

OTHERWISE. COORDINATE LOCATION(S) WITH OWNER.

- 17. BY DEDUCT ALTERNATE OMIT ELECTRICAL CONNECTION, CONDUIT, AND CONDUCTORS TO GROUND MOUNTED SIGNAGE.
- 18. PROVIDE ONE DATA DROP, 6A CABLE, AT EACH COMMUNICATIONS OUTLET SHOWN IN THE POWERED OFFICE FURNITURE LOCATED IN LINE/CREW ROOM 121 FOR A TOTAL OF TWENTY CAT 6A CABLES. COORDINATE
- 19. COORDINATE ADDITIONAL REQUIREMENTS WITH TC.
- SUPPLY MOUNTING/PLACEMENT FOR POWERED SHUTTERS. COORDINATE CONTROLS WITH SUPPLIER.
- 21. PROVIDE POWER PROVISIONS FROM EXHAUST FAN CIRCUIT TO VC

ORIGINAL SURFACE.

E. THE ELECTRICAL DRAWINGS SHOW GENERAL ARRANGEMENT ONLY.

TYPICAL WAP LOCATION - INSTALL (1) CAT6A CABLE CENTRALLY TO OWNER PROVIDED WIRELESS ACCESS POINT. PULL CABLES TO SERVER 120 RM. LEAVE 15' SERVICE LOOP.


- LOOP. VERIFY EXACT HEIGHTS AND LOCATIONS WITH OWNER.
- SWITCH. SWITCH MUST BE MOUNTED AND LABELED AT 60" AFF.
- 8' AFF IN CHASE WALL. EC TO COORDINATE WITH VC & PC FOR LOCATIONS.
- 7. PROVIDE AND INSTALL MICROWAVE RECEPTACLES AND CIRCUITS SEE ARCHITECTURAL A400 FOR ELEVATIONS.
- 8. PROVIDE AND INSTALL (1) 2" CONDUIT FROM SERVER 126 STUBBED OUTSIDE WEST SIDE OF BUILDING PAST NEW SIDEWALK PLUGGED & CAPPED FOR FUTURE. COORDINATE EXACT PLACEMENT WITH OWNER.
- 9. PROVIDE AND INSTALL (2) 2" SPARE CONDUITS AS NOTED ON SITE PLAN. (1)
- 10. TYPICAL FIRE WALL INSTALL 3M FIRE BARRIER INSERT "EBI-4" FOR 4X4 JUNCTION BOX AND "EBI-5" FOR 4 11/16 JUNCTION BOX OR APPROVED

11. PROVIDE AND INSTALL DISCONNECT FOR OPERABLE WALL WITHIN 5'.

- COORDINATE LOCATION WITH OWNER. PROVIDE CABLING TO SERVER 126.
- PANEL E AND PANEL W. SEE E600 ELECTRICAL DETAILS.
- OTHERWISE. COORDINATE LOCATION(S) WITH OWNER. 15. TYPICAL - PROVIDE AND INSTALL T&B 664 WITH BLACK ALUMINUM COVER. COLOR CONFIRMED WITH ARCHITECT. 1" C. MINIMUM FOR DATA UNLESS

NOTED OTHERWISE, 3/4" C. MINIMUM FOR POWER UNLESS NOTED

- NOTED OTHERWISE, 3/4" C. MINIMUM FOR POWER UNLESS NOTED 16. TYPICAL - PROVIDE AND INSTALL T&B 664 WITH BLACK ALUMINUM COVER. COLOR CONFIRMED WITH ARCHITECT. 1" C. MINIMUM FOR DATA UNLESS
- ADDITIONAL INFORMATION WITH OWNERS OFFICE FURNITURE SUPPLIER.
- 20. COORDINATE WITH ARCHITECT AND GC FOR JUNCTION BOX POWER
- PROVIDED MOTORIZED DAMPER. COORDINATE WITH VC ON LOCATIONS.

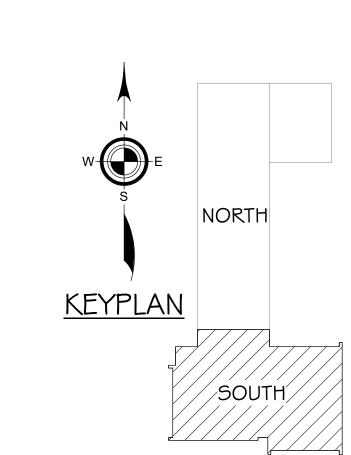

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SE PROJECT NO: 240700836

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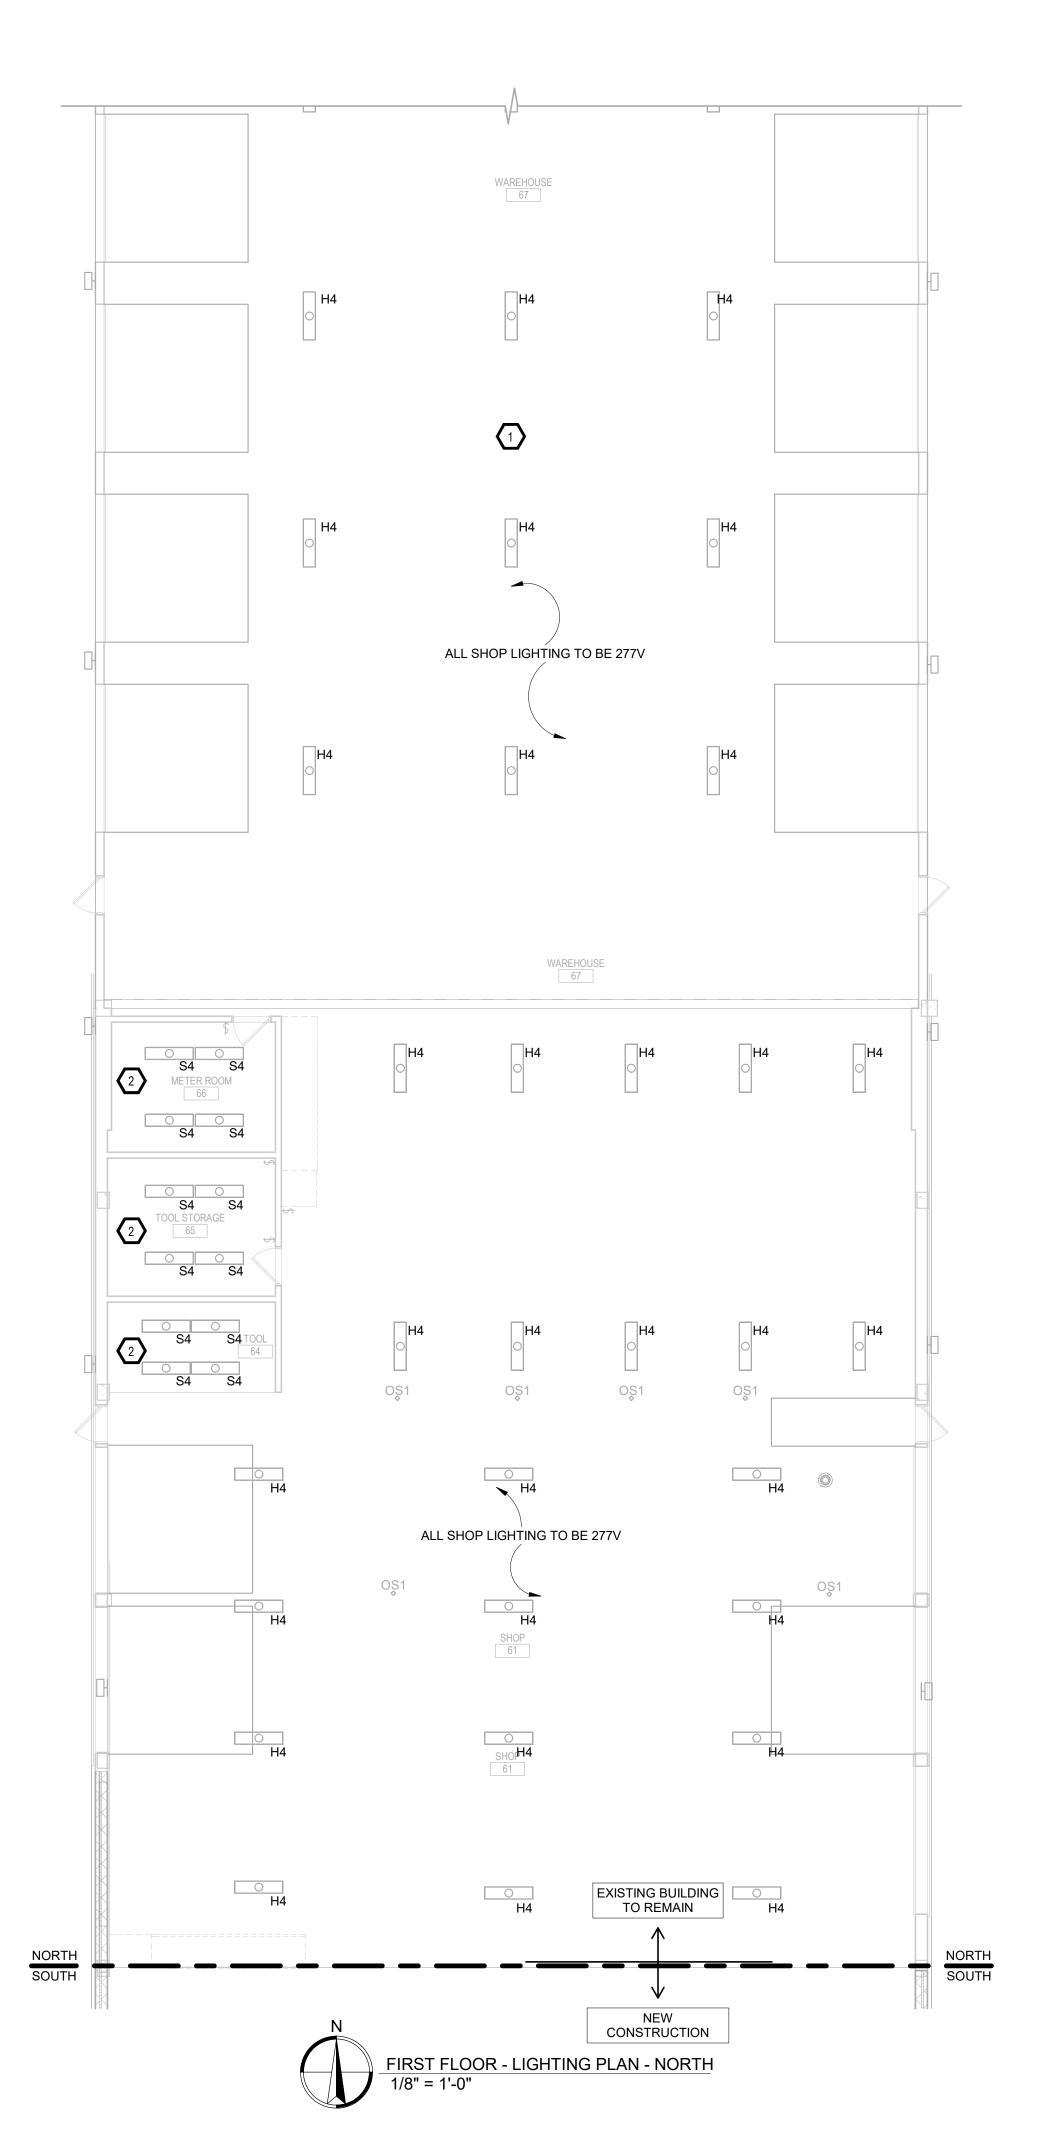
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PROJECT: NORTHERN ELECTRIC COOPERATIVE ABERDEEN, SOUTH DAKOTA

SHEET TITLE POWER & DATA PLAN - SOUTH

E300.S





A. ALL WORK SHALL BE PERFORMED IN A CLEAN AND WORKMANLIKE

B. THE ELECTRICAL CONTRACTOR SHALL BE RESPONSIBLE FOR PATCHING ANY OPENINGS LEFT IN FLOORS, WALLS, AND CEILINGS THAT WERE CAUSED BY HIS/HER ACTIONS. PATCHING SHALL MATCH EXISTING SURFACE IN COLOR, TEXTURE AND QUALITY SO THAT PATCH IS INDISTINGUISHABLE FROM ORIGINAL SURFACE.

C. ALL PENETRATIONS THROUGH DRAFT STOPS AND OTHER FIRE-RATED PARTITIONS SHALL BE FIRE STOPPED AS PER SPECIFICATIONS AND LOCAL

D. ALL ELECTRICAL WORK SHALL BE INSTALLED IN STRICT ACCORDANCE WITH ALL APPLICABLE LOCAL, STATE, NATIONAL ELECTRIC CODE, AND THE AUTHORITY HAVING JURISDICTION.

E. THE ELECTRICAL DRAWINGS SHOW GENERAL ARRANGEMENT ONLY. EXACT LOCATION SHALL AVOID INTERFERENCE WITH ELECTRICAL EQUIPMENT & REQUIRED ELECTRICAL CLEARANCES.

Phone: 605-334-9999

1. BY ADD ALTERNATE: EC TO PROVIDE & INSTALL NEW SHOP LED FIXTURES TYPE "H4". RE-WORK EXG SHOP LIGHTING CIRCUITRY WIRING TO 277V.

2. BY ADD ALTERNATE: EC TO PROVIDE & INSTALL NEW LED FIXTURES TYPE "S4" IN ROOMS AS NOTED. RE-WORK EXG SHOP LIGHTING CIRCUITRY WIRING TO 277V.

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PROJECT: NORTHERN ELECTRIC COOPERATIVE ABERDEEN, SOUTH DAKOTA


SHEET TITLE:

<u>KEYPLAN</u>

SOUTH

LIGHTING PLAN - NORTH

E400.N

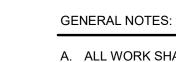

A. ALL WORK SHALL BE PERFORMED IN A CLEAN AND WORKMANLIKE

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1. TYPICAL - INSTALL OFFICES WITH 0-10V DIMMING PROVISIONS. PROVIDE AND INSTALL 0-10V WIRING FROM SWITCH CONNECTED TO LED DRIVER & TO LIGHT FIXTURES.

2. BY DEDUCT ALTERNATE - INSTALL TYPE "A4" FIXTURES IN PLACE OF "L6" FIXTURES.

3. BY DEDUCT ALTERNATE - INSTALL TYPE "A2" FIXTURES IN PLACE OF "L4" FIXTURES.

4. TYPICAL - FIRE WALL INSTALL 3M FIRE BARRIER INSERT "EBI-4" FOR 4X4 JUNCTION BOX AND "EBI-5" FOR 4 11/16 JUNCTION BOX OR APPROVED


5. TYPICAL - PROVIDE AND INSTALL SURFACE MOUNTED CONDUIT FOR LIGHTING AND SWITCHING DEVICES.


PROVIDE AND INSTALL HIGH EFFICIENCY OUTDOOR LINEAR WALL WASH FIXTURE "W4" ALONG THE SOUTHERN PERIMETER.

7. PROVIDE AND INSTALL DIMMING SWITCHES FOR EXTERIOR LIGHTING IN MECH 141 DOWNSTREAM OF TIME CLOCK.

NOT USED.

9. SEE ARCHITECTURAL ELEVATION FOR CONFIGURATION OF PENDANT FIXTURES. COORDINATE CABLE LENGTHS, DIFFUSER FINISH & FINAL PLACEMENT WITH ARCHITECT.

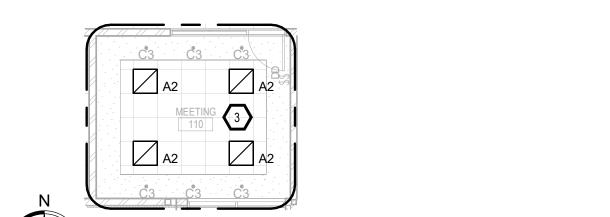

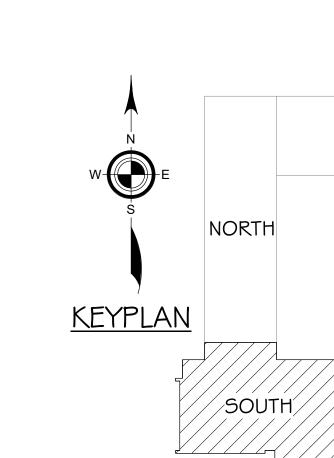

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BY DEDUCT ALTERNATE - BOARD & TRAINING ROOM - LIGHTING PLAN

1/8" = 1'-0"

SE PROJECT NO: 240700836

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PROJECT: NORTHERN ELECTRIC COOPERATIVE ABERDEEN, SOUTH DAKOTA

SHEET TITLE: LIGHTING PLAN - SOUTH

E400.S

BY DEDUCT ALTERNATE - MEETING ROOM - LIGHTING PLAN
1/8" = 1'-0"

CONNECT TO TIME CLOCK

TO REMAIN'

 $\frac{\text{FIRST FLOOR - LIGHTING - SOUTH}}{1/8" = 1'-0"}$

CONNECT CIRCUITRY TO MEZZ LIGHTING

LOBBY 101 - WEST WALL

SKY LIGHTS

SKY LIGHTS

H1-51

// H1-59

NOT TO SCALE


SHOP MEZZANINE - LIGHTING PLAN

1/8" = 1'-0"

NEW
CONSTRUCTION

S4
EXISTING BUILDING
TO REMAIN

67' - 3"

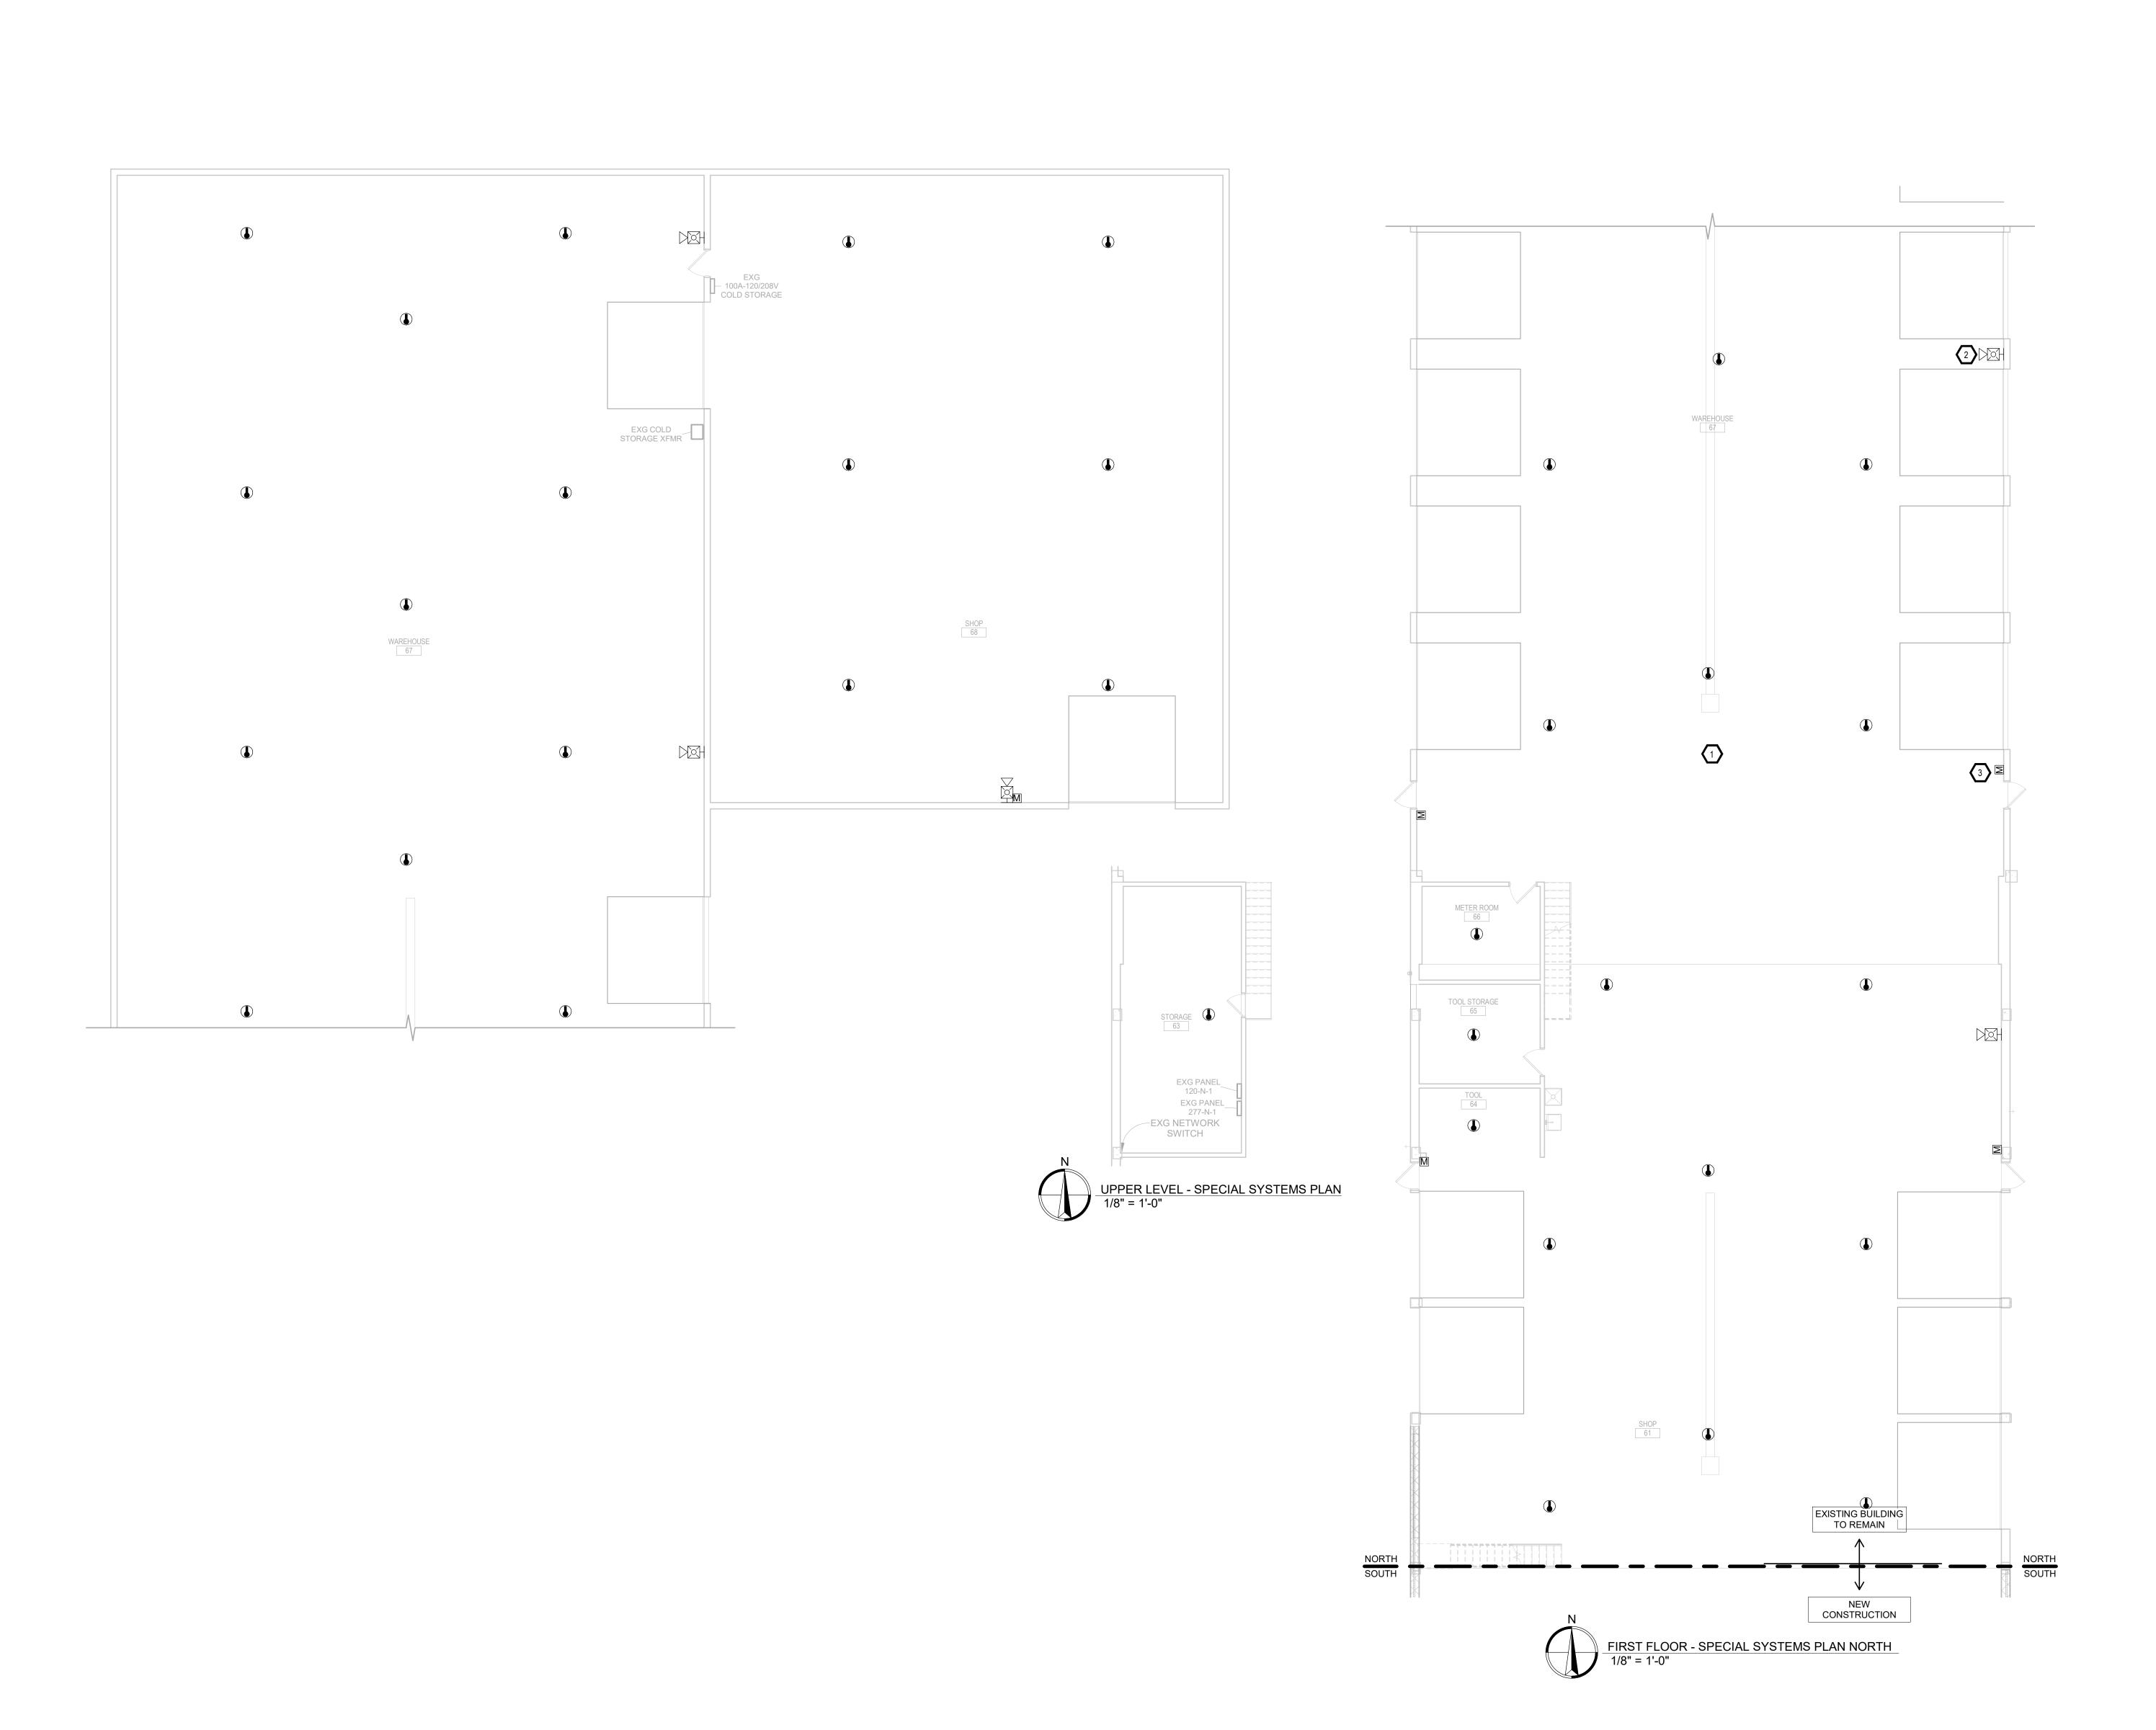

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D. ALL ELECTRICAL WORK SHALL BE INSTALLED IN STRICT ACCORDANCE WITH ALL APPLICABLE LOCAL, STATE, NATIONAL ELECTRIC CODE, AND THE AUTHORITY HAVING JURISDICTION.

E. THE ELECTRICAL DRAWINGS SHOW GENERAL ARRANGEMENT ONLY.
EXACT LOCATION SHALL AVOID INTERFERENCE WITH ELECTRICAL EQUIPMENT & REQUIRED ELECTRICAL CLEARANCES.

GENERAL NOTES:

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- 1. TYPICAL PROVIDE AND INSTALL HEAT DETECTORS THOUGHT EXG SHOP.
- TYPICAL PROVIDE AND INSTALL HORN/STROBE THOUGHT EXG SHOP AS REQUIRE.
- TYPICAL PROVIDE AND INSTALL MANUAL PULL STATIONS AT EXIT DOORS AS REQUIRED.

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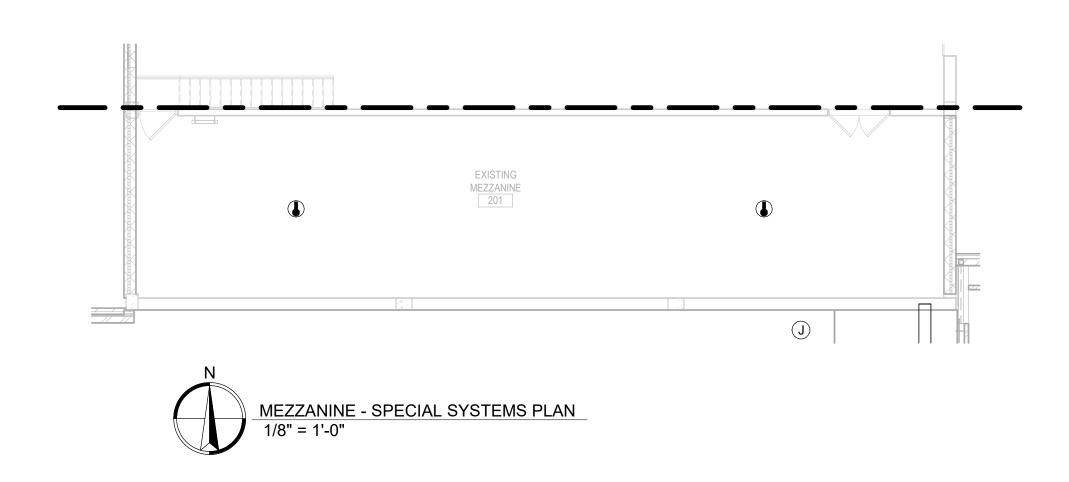
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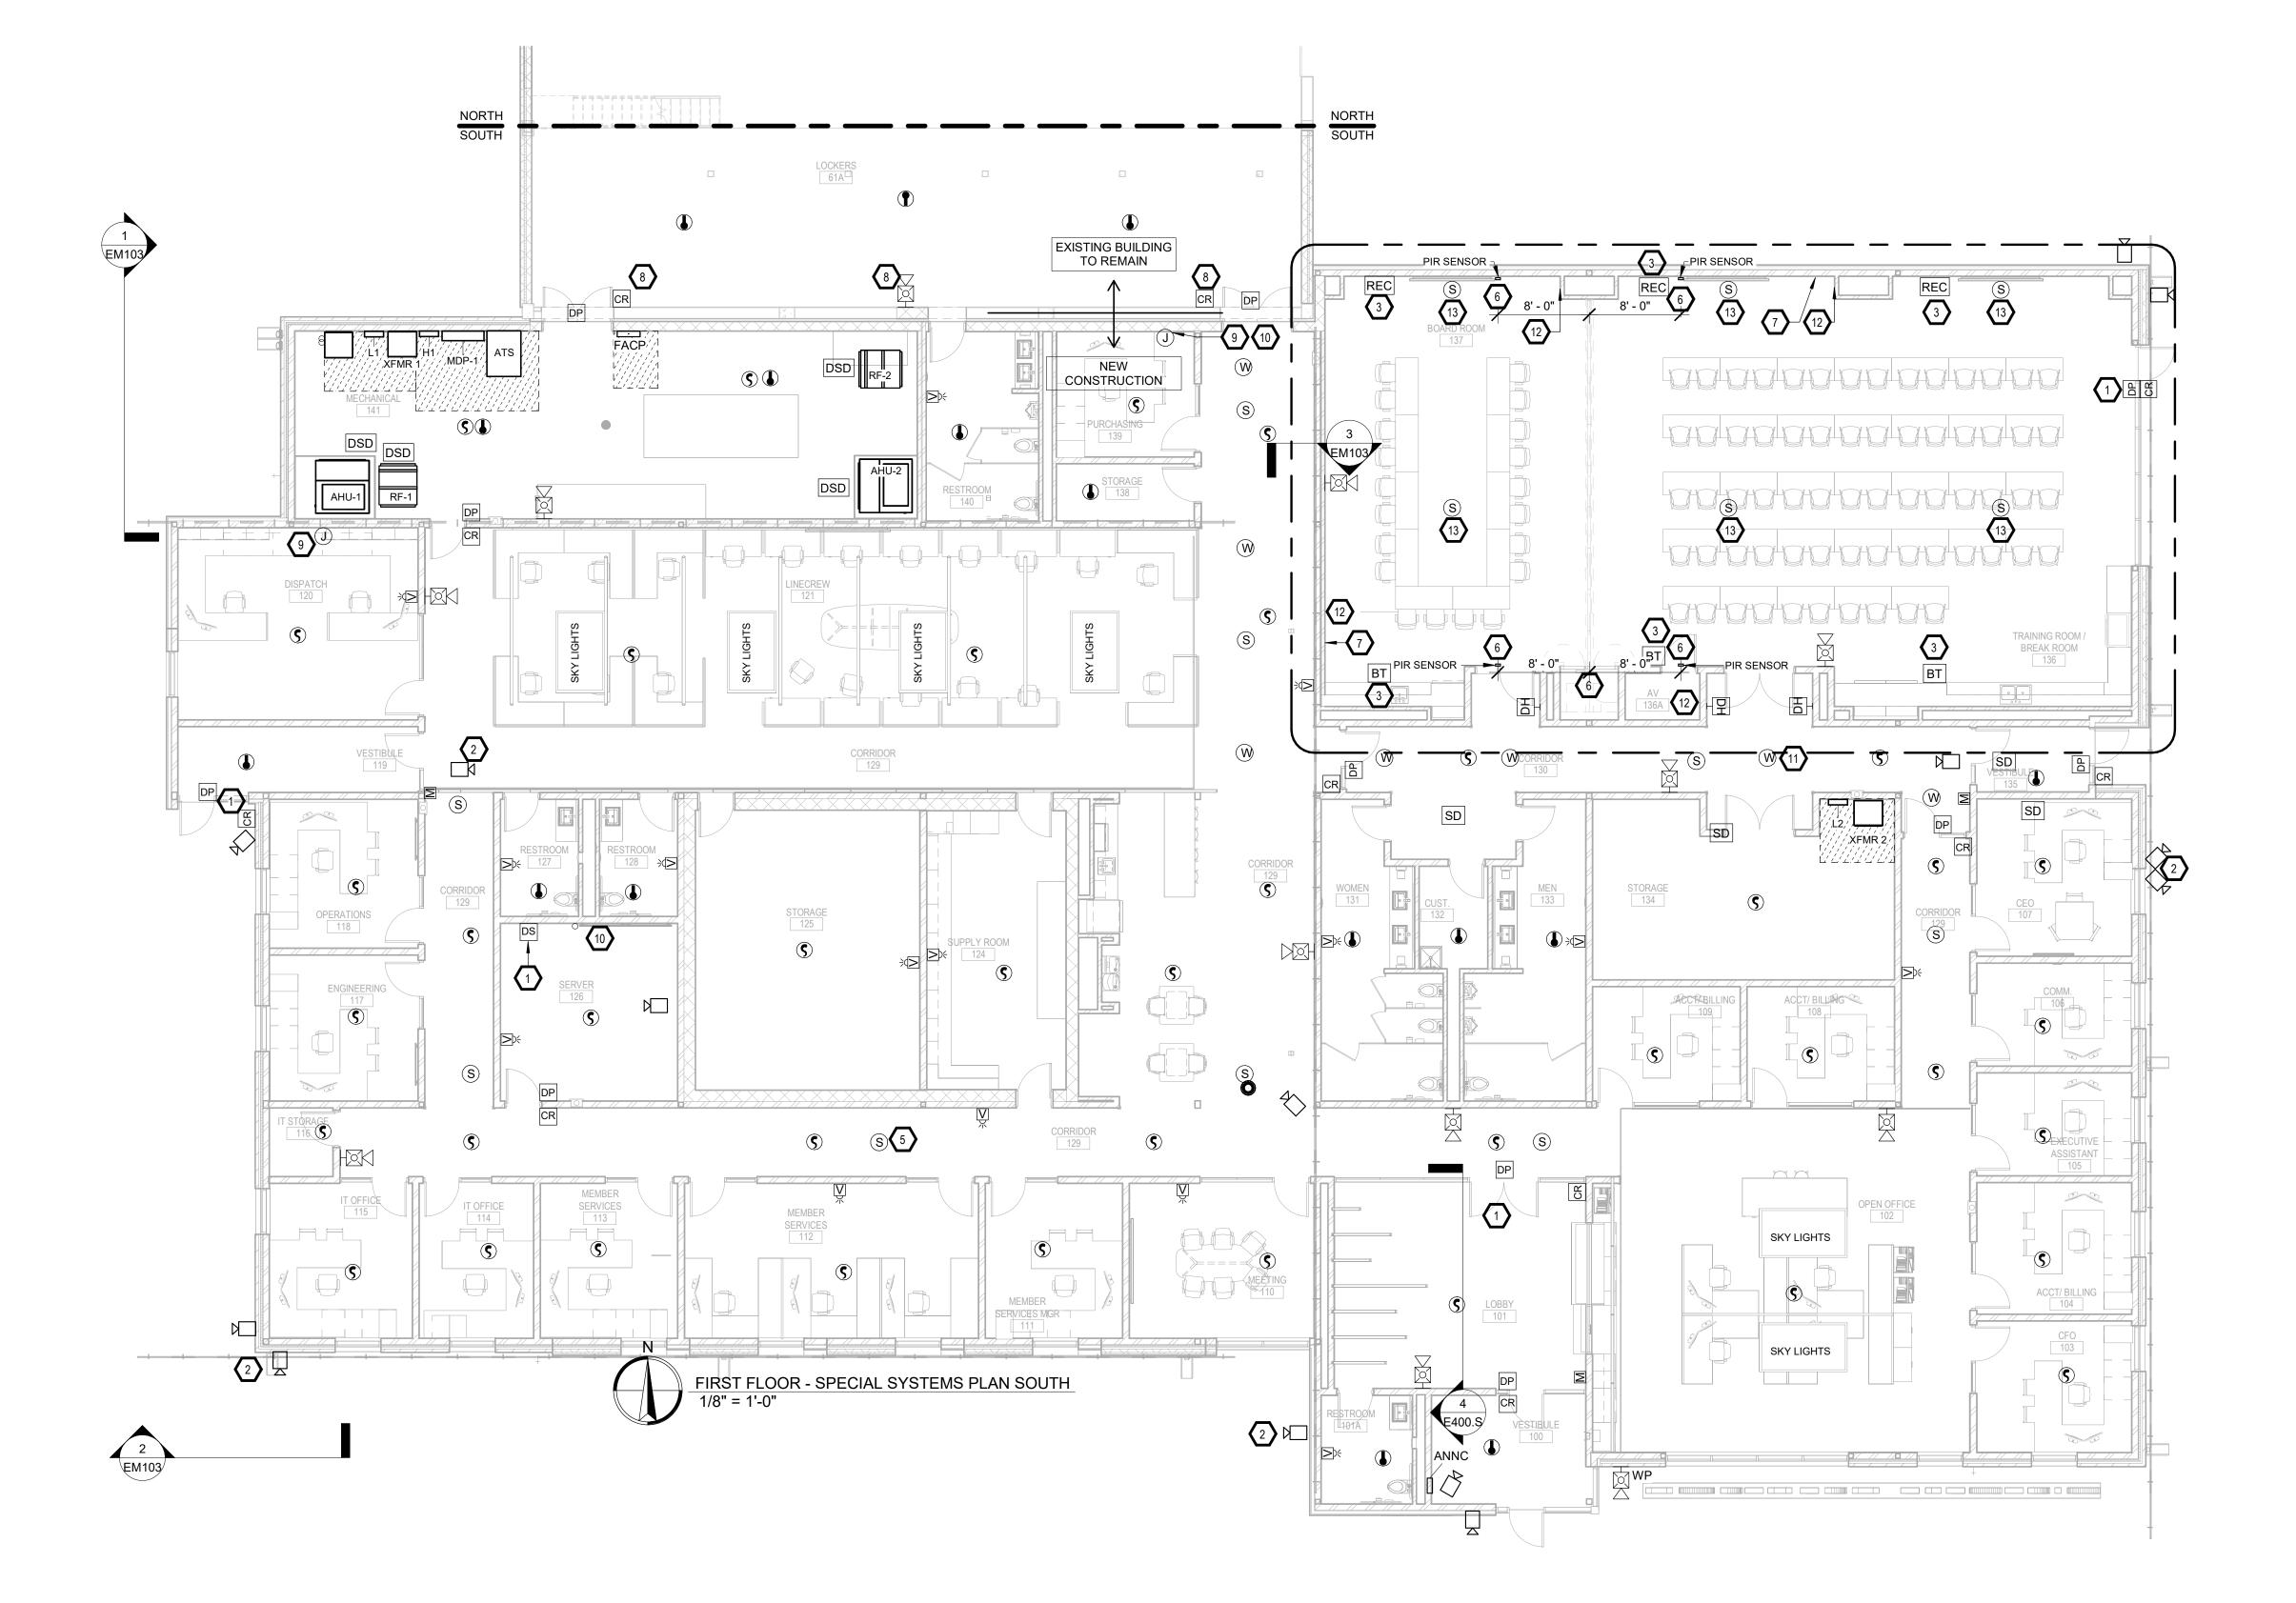
PROJECT: NORTHERN ELECTRIC COOPERATIVE ABERDEEN, SOUTH DAKOTA

SHEET TITLE: SPECIAL SYSTEMS PLAN -NORTH

E500.N

<u>KEYPLAN</u> SOUTH





SPECIAL NOTES:

- A. ALL SECURITY SYSTEMS TO BE ROUGH-IN ONLY WITH 3/4" CONDUIT UNLESS OTHERWISE APPROVED TO AN ACCESSIBLE CEILING LOCATION. CAMERAS CARD READERS, MOTION DETECTORS, SECURITY DEVICES, WIRING & TERMINATIONS BY OTHERS.
- BOARDROOM 137 AND TRAINING/BREAKROOM 136. SYSTEMS OPERATION SHALL CONSIST OF BOARDROOM ONLY, TRAINING/BREAKROOM ONLY AND AT FRONT OF EACH ROOM. PROVIDE RACK MOUNTED UNIFI POWERAMPS UPL-AMP-B AS REQUIRED AND TWO ALLEN & HEALTH 16X16 AUDIO MATRIX MIXERS AH-AHM-16. PROVIDE THREE SPEAKERS, DESNO DX-S8 LOCATED AT THE FRONT(NORTH) OF ROOMS AND THREE SPEAKERS, DESNO DX-S5 LOCATED AT THE MID POINT OF ROOMS. PROVIDE AUDIO INPUTS LOCATED IN THE PODIUM FLOOR BOX AND AT FRONT DISPLAY IN EACH ROOM. PROVIDE ONE VOLUME CONTROL LOCATED AT THE FRONT OF EACH ROOM. PROVIDE THREE HANDHELD WIRELESS MICROPHONES, SHURE MXW2/SM58=Z10 AND THREE DESK MOUNTED MICROPHONES, NECESSARY ITEMS FOR A COMPLETE AND FUNCTIONING SYSTEM NOT LIMITED TO MOUNTING RACK, CABLING, CONNECTORS, FACEPLATES, ADDITIONAL REQUIREMENTS.

GENERAL NOTES:

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B. THE ELECTRICAL CONTRACTOR SHALL BE RESPONSIBLE FOR PATCHING ANY OPENINGS LEFT IN FLOORS, WALLS, AND CEILINGS THAT WERE CAUSED BY HIS/HER ACTIONS. PATCHING SHALL MATCH EXISTING SURFACE IN COLOR, TEXTURE AND QUALITY SO THAT PATCH IS INDISTINGUISHABLE FROM ORIGINAL SURFACE.

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E. THE ELECTRICAL DRAWINGS SHOW GENERAL ARRANGEMENT ONLY. EXACT LOCATION SHALL AVOID INTERFERENCE WITH ELECTRICAL EQUIPMENT & REQUIRED ELECTRICAL CLEARANCES.

KEYNOTES


1. TYPICAL - PROVIDE AND INSTALL ROUGH-INS FOR NEW OWNER PROVIDED DOOR ACCESS CONTROLS. PROVIDE AND INSTALL (1) CAT6A & (1) 18-4 AWG CONDUCTOR TO EACH FOR OWNER PROVIDED DOOR ACCESS CONTROL. ROUTE ALL DOOR ACCESS CONTROL(S) CABLING BACK TO SERVER 126. CONNECT FACP TO OWNER PROVIDED DOOR ACCESS CONTROL PANEL(S). COORDINATE WITH OWNER ON CARD READER PLACEMENT.

- 2. TYPICAL SECURITY CAMERA PROVIDE AND INSTALL (1) CAT6A ROUTED TO SERVER 126 FOR OWNER PROVIDED SECURITY CAMERA'S.
- 3. INSTALL BEAM TYPE SMOKE SENSOR TRANSMITTER & RECEIVER CENTERED IN UPPER SOFFIT.
- 4. BY DEDUCT ALTERNATE INSTALL SMOKE DETECTORS AS ILLUSTRATED IN ACT CEILING. DEDUCT (6) SMOKE DETECTORS.
- 5. TYPICAL CEILING SPEAKER PROVIDE AND INSTALL CABLING FOR INTERCOM SYSTEM ROUTED TO SERVER 126 FOR OWNER PROVIDED SPEAKERS AND INTERCOM SYSTEM.
- SENSORS FOR OPERABLE WALL. COORDINATE WITH GC FOR EXACT PIR SENSOR LOCATIONS AND HEIGHTS TO NOT CONFLICT WITH PROPOSED TV. TYPICAL PLACEMENT OF PIR SENSOR(S) IS MOUNTED 8' FROM CENTER LINE OF OPERABLE WALL MOUNTED FROM 7'-6" AFF TO 10' AFF.
- BE INSTALLED 8' MIN. FROM CLOSEST PIR SENSOR. COORDINATE WITH OWNER AND GC FOR EXACT LOCATIONS AND PLACEMENT.
- 8. TYPICAL FIRE WALL INSTALL 3M FIRE BARRIER INSERT "EBI-4" FOR 4X4 JUNCTION BOX AND "EBI-5" FOR 4 11/16 JUNCTION BOX OR APPROVED
- 9. PROVIDE AND INSTALL RACEWAY FOR OWNER PROVIDED ANTENNA CABLING 3 RUNS OF LMR - 400 50 OHM COAX CABLE. PROVIDE 2" CONDUIT ROUTED FROM 8X8X4 RECESSED JUNCTION BOX IN PURCHASING 129 TO CABLE TRAY. PROVIDE 2" CONDUIT FROM CABLE TRAY TO STORAGE 63 IN SHOP. MAINTAIN FIRE WALL RATING WITH SLEEVE. COORDINATE WITH OWNER ON ROUTING AND PLACEMENT.
- 10. PROVIDE AND INSTALL RACEWAY FOR OWNER PROVIDED 4 PAIR FIBER CABLING. PROVIDE 1 1/4" CONDUIT ROUTED FROM 8X8X4 RECESSED JUNCTION BOX IN SERVER 126 TO CABLE TRAY. PROVIDE 1 1/4" CONDUIT FROM CABLE TRAY TO STORAGE 63 IN SHOP. MAINTAIN FIRE WALL RATING WITH SLEEVE. COORDINATE WITH OWNER ON ROUTING AND PLACEMENT
- 11. PROVIDE AND INSTALL, WHITE NOISE PLENUM MOUNT SPEAKER.
- 12. PROVIDE AND INSTALL RACEWAY FOR HEADEND CONTROLLER(S) IN AV 136A WITH VOLUME CONTROL INSTALLED IN FOR BOARD ROOM 137 & BREAK ROOM 136. COORDINATE WITH OWNER ON AUDIO CONTROL
- 13. TYPICAL SPEAKER PROVIDE AND INSTALL RACEWAY FROM SPEAKER BACK TO AV 136A FOR SPEAKER CABLING.

W-

<u>KEYPLAN</u>

/SOUTH/

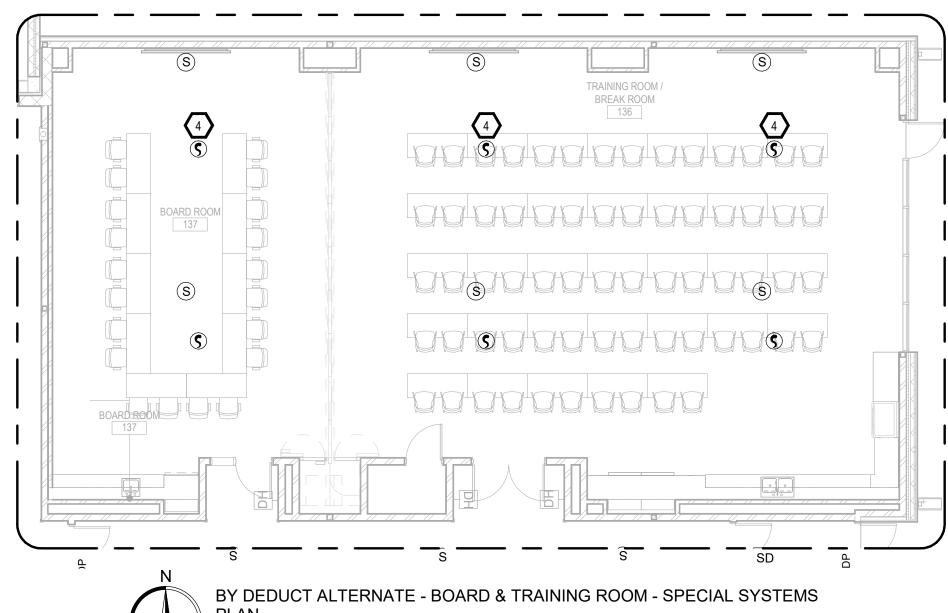


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5/15/2025 100% CONSTRUCTION DOCUMENTS REVISION SCHEDULE: REV. # REV. DSC. REV. DATE

PROJECT: NORTHERN ELECTRIC COOPERATIVE ABERDEEN, SOUTH DAKOTA

SHEET TITLE: SPECIAL SYSTEMS PLAN -

E500.S

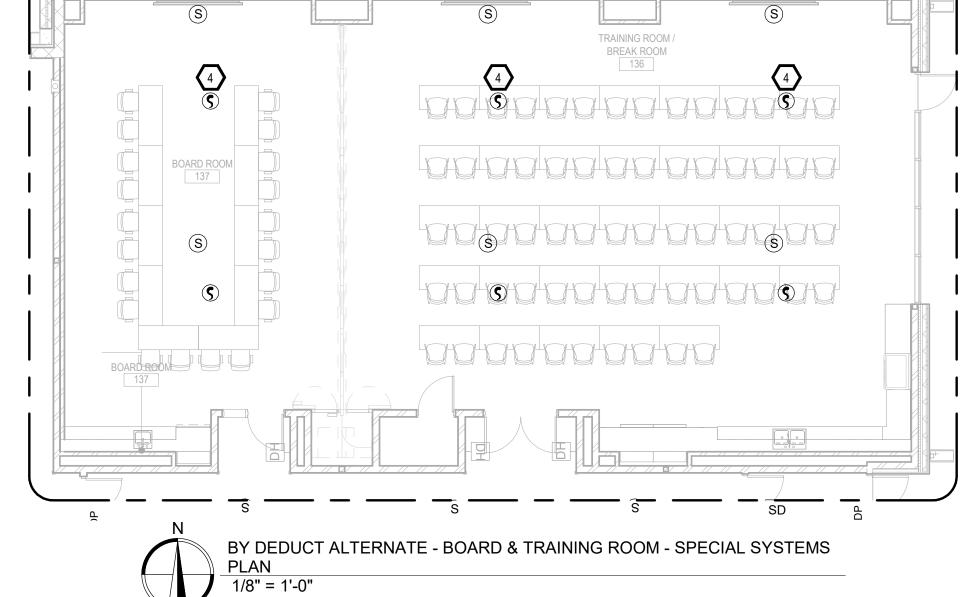

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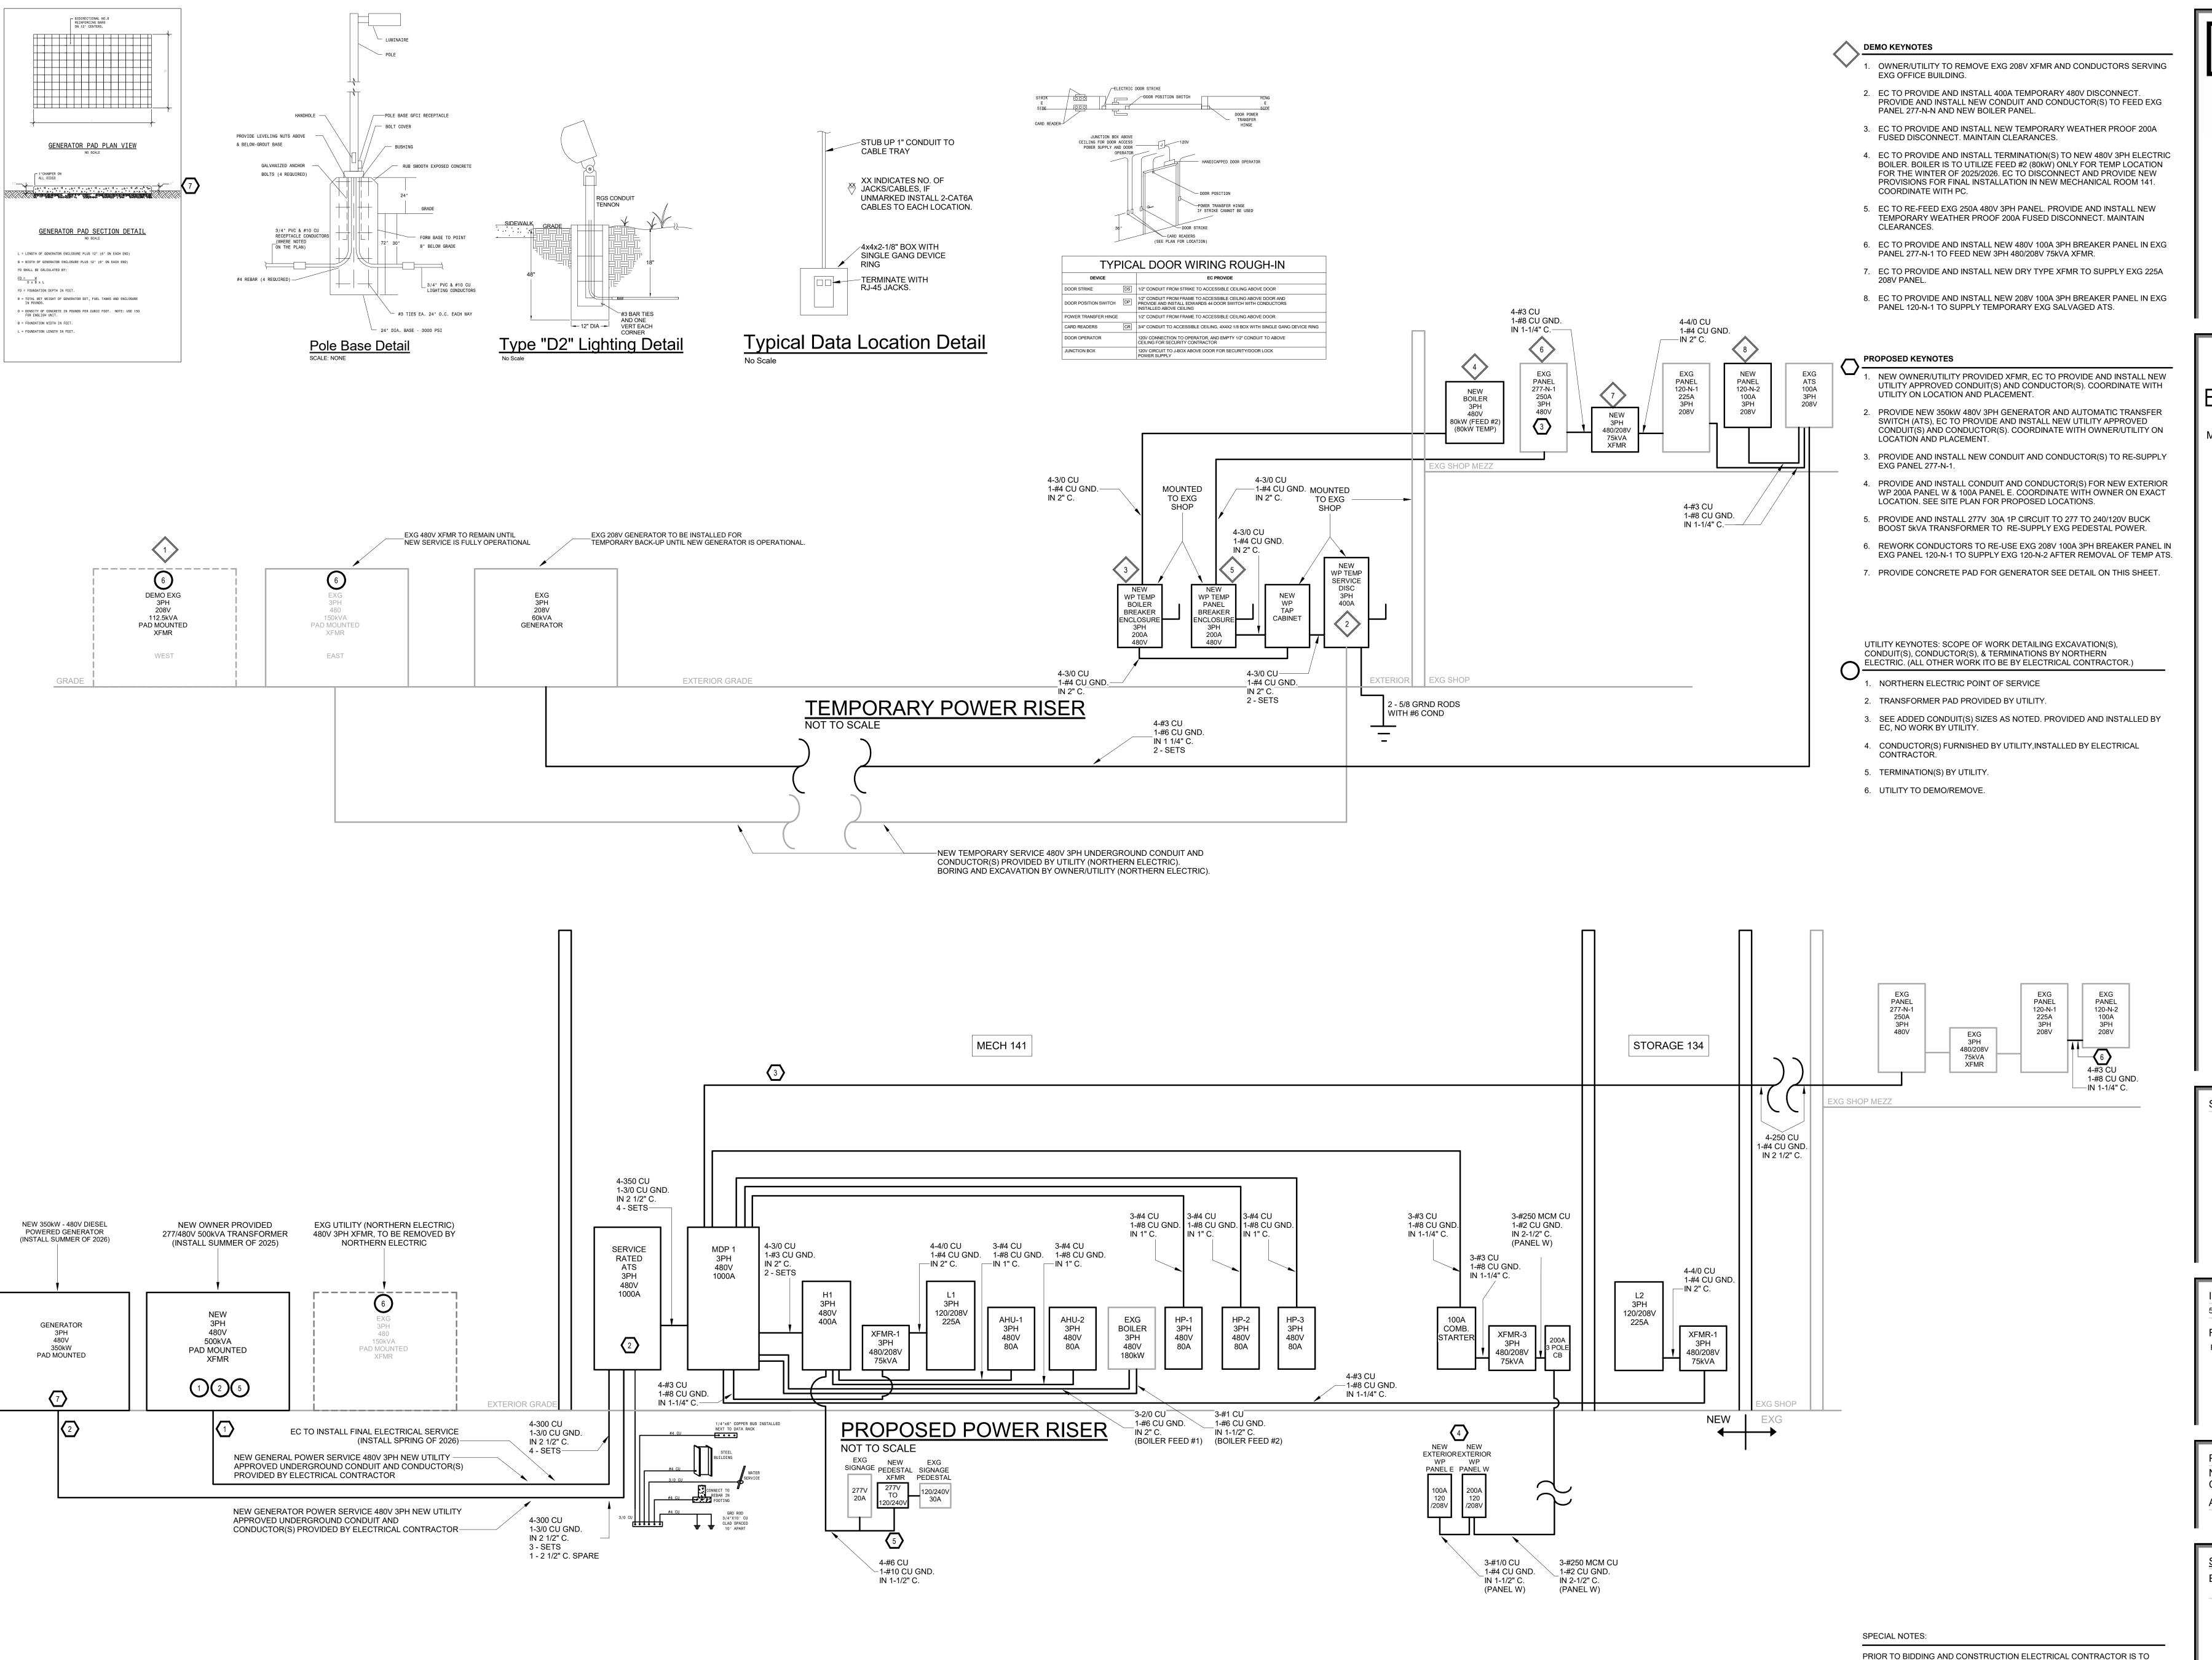
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B. SOUND REINFORCEMENT - PROVIDE SOUND REINFORCEMENT SYSTEMS IN

BOTH COMBINED. SELECTION SHALL BE VIA WALL MOUNTED LCD SCREEN

SHURE MZW8X-Z10 WITH GOOSENECK BASES, THREE SHURE X415RLPDF/N 15" GOOSE NECK AND ONE 4 CHANNEL CHARGING STATION. PROVIDE ALL ETC. CONTACT ALEX BARTLET WITH PAUER SOUND AT 605-228-8342 FOR

> 6. PROVIDE AND INSTALL WIRING AND ELECTRICAL CONNECTIONS TO PIR 7. PROVIDE AND INSTALL WIRING AND ELECTRICAL CONNECTIONS TO KEY SWITCH/DISPLAY FOR OPERABLE WALL UNIT. KEY SWITCH/DISPLAY UNIT TO



CO

Arch



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ISSUE:
5/15/2025 100% CONSTRUCTION DOCUMENTS

REVISION SCHEDULE:
REV. # REV. DSC. REV. DATE

PROJECT:
NORTHERN ELECTRIC
COOPERATIVE
ABERDEEN, SOUTH DAKOTA

SHEET TITLE:
ELECTRICAL DETAILS

F600

COORDINATE REQUIREMENTS WITH UTILITY COMPANY (NORTHERN ELECTRIC)

(605) 225-0310 (OFFICE) rulmer@northernelectric.coop

NORTHERN ELECTRIC CONTACT - RUSS ULMER

		LIGHT	ΓΙΝ	G F	IXT		SCH	HEDU	JLE	_		
ТҮРЕ	MANUFACTURERS	CAT. NO.	TYPE	WATTS (W)	LUMENS	COLOR TEMP. (K)	COLOR SELECT.	LUMEN SELECT.	DIMMING	RGB CAPABLE	MIN. CRI	REMARKS
A2	COOPER, LITHONIA LIGHTING, RAB OR EQUAL	LITHONIA STAKS 2X4 ALO3 SWW7 UVOLT	LED	33	4563	4000	YES	YES	0-10V	NO	90	2X2 TROFFER DROP IN PANEL
A4	COOPER, LITHONIA LIGHTING, RAB OR EQUAL	LITHONIA STAKS 2X4 ALO6 SWW7 UVOLT	LED	38	5517	4000	YES	YES	0-10V	NO	90	2X4 TROFFER DROP IN PANEL
C3	COOPER, LITHONIA LIGHTING, RAB, MOLTO LUCE OR EQUAL	COOPER ML3LSFSE010RMW	LED	12	800	4000	YES	YES	0-10V	NO	90	3" ROUND CANLESS LED DOWNLIGHTING
C4	COOPER, LITHONIA LIGHTING, RAB, MOLTO LUCE OR EQUAL	LITHONIA LDN4 ALO3 LO4 WR LSS MVOLT 90CRI	LED	19	2000	4000	YES	YES	0-10V	NO	90	3" ROUND CANLESS LED DOWNLIGHTING
C6	COOPER, LITHONIA LIGHTING, RAB OR EQUAL	LITHONIA LDN6 AL02 SWW1 LO6 WR LSS MVOLT	LED	12	1000	4000	YES	YES	0-10V	NO	90	6" ROUND CAN DOWNLIGHT
C6A	COOPER, LITHONIA LIGHTING, RAB OR EQUAL	LITHONIA LDN6 ALO2 SWW1 LO6 WR LSS MVOLT	LED	19	1500	4000	YES	YES	0-10V	NO	90	6" ROUND CAN DOWNLIGHT
D2	COOPER, LITHONIA LIGHTING, OR APPROVED EQUAL	LITHONIA DSXF2 LED P1 70CRI MSP MVOLT IS PE UBV DBLXD	LED	64	8138	4000	NO	NO	0-10V	NO	90	OUTDOOR LED FLOODLIGHT WITH TOP MOUNTED UBV VISOR
E	DUAL-LITE, SURE-LITES, MULE LIGHTING, LIGHTALARMS, OR EQUAL	LITHONIA ELM4L LTP SDRT	LED	-	-	-	-	-	-	NO	-	WHITE EMERGENCY LIGHT WITH SELF DIAGNOSTICS
F1	LITHONIA OR APPROVED EQUAL	LITHONIA RSX2 LED P4 40K R4 MVOLT RPA DBLXD	LED	187	24000	4000	NO	NO	NO	NO	70	LED AREA LIGHT. 25' ROUND TAPER ALUMINUM POLE
H4	COOPER, LITHONIA LIGHTING, RAB OR EQUAL	LITHONIA CPHB 24000LM SEF WD MVOLT 40K 80CRI	LED	174	24000	4000	YES	YES	NO	NO	90	LED HIGH BAY
J5	AYO FURO 3	FURO 3 F3 MI CR 5' 840 L SB 1D CR (116.5° CORNER)	LED	28	3600	4000	NO	NO	0-10V	NO	90	MUD IN SEAMLESS LIGHTING, FIELD VERIFY DIMENSIONS
J7.6	AYO FURO 3	FURO 3 F3 MI CR 7' 6" 840 L SB 1D CR (116.5° CORNER)	LED	42	5500	4000	NO	NO	0-10V	NO	90	MUD IN SEAMLESS LIGHTING, FIELD VERIFY DIMENSIONS
J8.6	AYO FURO 3	FURO 3 F3 MI CR 8' 6" 840 L SB 1D CR (116.5° CORNER)	LED	47	6300	4000	NO	NO	0-10V	NO	90	MUD IN SEAMLESS LIGHTING, FIELD VERIFY DIMENSIONS
J9.6	AYO FURO 3	FURO 3 F3 MI CR 9' 6" 840 L SB 1D CR (116.5° CORNER)	LED	53	7000	4000	NO	NO	0-10V	NO	90	MUD IN SEAMLESS LIGHTING, FIELD VERIFY DIMENSIONS
J12.6	AYO FURO 3	FURO 3 F3 MI CR 12' 6" 840 L SB 1D CR (116.5° CORNER)	LED	70	9200	4000	NO	NO	0-10V	NO	90	MUD IN SEAMLESS LIGHTING, FIELD VERIFY DIMENSIONS
J13	AYO FURO 3	FURO 3 F3 MI CR 13' 840 L SB 1D CR (116.5° CORNER)	LED	72	9500	4000	NO	NO	0-10V	NO	90	MUD IN SEAMLESS LIGHTING, FIELD VERIFY DIMENSIONS
J14	AYO FURO 3	FURO 3 F3 MI CR 14' 840 L SB 1D CR (116.5° CORNER)	LED	77	10200	4000	NO	NO	0-10V	NO	90	MUD IN SEAMLESS LIGHTING, FIELD VERIFY DIMENSIONS
J23.6	AYO FURO 3 OR APPROVED EQUAL	FURO 3 F3 MI CR 23' 6" 840 L L 1D	LED	130	16900	4000	NO	NO	0-10V	NO	90	MUD IN SEAMLESS LIGHTING
J67.3	AYO FURO 3	FURO 3 F3 MI CR 67' 6" 840 L W 1D	LED	371	250000	4000	NO	NO	0-10V	NO	90	MUD IN SEAMLESS LIGHTING
K1	EUREKA OR APPROVED EQUAL	102U2 QTY 7, 102U4 QTY 5 LED** 35 90 277 DV FLC BLKE ** **	LED	15	1800	3500	NO	NO	0-10V	NO	90	VELIA DROPLET, EXTERIOR & INTERIOR SELECTED BY ARCHITECT
L4	JESCO OR APPROVED EQUAL	JESCO LINSL-D-48-30W-DSW1-0P-BK	LED	30	3900	4000	YES	NO	0-10V	NO	90	4' LINEAR LIGHT FIXTURE
L6	JESCO OR APPROVED EQUAL	JESCO LINSL-D-72-45W-DSW1-OP-BK	LED	4	5850	4000	YES	NO	0-10V	NO	90	6' LINEAR LIGHT FIXTURE
M1	COOPER, LITHONIA LIGHTING, RAB OR EQUAL	LITHONIA WPX3 LED 40L MVOLT DBLXD	LED	69	9200	4000	NO	NO	0-10V	NO	90	WALL PACK
P1	IMPACT LTG, OCL OR APPROVE EAQUAL	IMPACT LTG P3508 40 LO ANB BKPC 3FT	LED	20	2165	4000	NO	NO	0-10V	NO	90	8" PENDANT FIXTURE
S4	COOPER, LITHONIA LIGHTING, RAB OR EQUAL	LITHONIA CSS L38 AL03 MVOLT SWW3 80CRI	LED	35	5076	4000	YES	YES	0-10V	NO	80	CHAIN HUNG LED STRIP FIXTURE
V14	FOCAL POINT, LUMENWERX OR APPROVED EQUAL	LUMENWERX VIA2ACOP DI HLO SH WIO2 SW 90 750 750 40 14 8 UNV D1 2	LED	12W PER FT	750D 500I PER FT	4000	NO	NO	0-10V	NO	90	ACOUSTICAL LINEAR FIXTURE, DIRECT/INDIRECT, 2 CIRCUIT
V22	FOCAL POINT, LUMENWERX OR APPROVED EQUAL	LUMENWERX VIA2ACOP DI HLO SH WIO2 SW 90 750 750 40 22 8 UNV D1 2	LED	12W PER FT	750D 500I PER FT	4000	NO	NO	0-10V	NO	90	ACOUSTICAL LINEAR FIXTURE, DIRECT/INDIRECT, 2 CIRCUIT
W4	SOLID STATE LUMINARES OR APPROVED EQUAL	LZWET 48 UNV 840 44L ** LD	LED	44	4400	4000	NO	NO	4000	4000	4000	HIGH EFFICIENCY LINEAR OUTDOOR FIXTURE, OPTICS SELECTED BY MANUFACTURE
Х	DUAL-LITE, SURE-LITES, MULE LIGHTING, LITHONIA, LIGHTALARMS	MULE SQCR LED U R WW SD	LED	5	-	-	-	-	-	-	-	WALL MOUNT EXIT SIGN WITH SELF DIAGONSTICS

	OCCUPANC	Y SENSOR	SWITCH SCHEDULE
ТҮРЕ	MANUFACTURERS	CAT. NO.	REMARKS
s ⁰	WATT STOPPER OR EQUAL	DSW-302	DUAL TECHNOLOGY PIR/ULTRASONIC WALL SWITCH SENSOR OCCUPANCY SENSOR. SET FOR AUTOMATIC 'ON' OPERATION.
0S1	WATT STOPPER OR EQUAL	DT-355	LINE VOLTAGE, DUAL TECHNOLOGY CEILING SENSOR, 18' RADIUS

	Location: STORAGE 63 Mounting: Surface			Vol Phase Wire	es: 3		77 V	Vye A.I.C. Rating: Mains Type: MLO Rating: 250 A					
СКТ	LOAD	CKT BRK	POLES	A	В		С	POLES	CKT BRK	LOAD	СКТ		
1	EXG TRANSFORMER ROOM	50 A	2	0				3	150 A	NEW 75kVA XFMR (PANEL 120-N-1)	2		
3											4		
5	EXG SPARE	20 A	1			0					6		
7	EXG LOCKER RM LIGHTS	20 A	1	0				3	20 A	NEW SF-1	8		
9	EXG SPARE	20 A	1								10		
11	EXG BATHROOM LIGHTS	20 A	1			0					12		
13	EXG SPARE	20 A	1	0				3	20 A	EXG METER	14		
15	EXG BREAKROOM LIGHTS	20 A	1								16		
17	EXG SPARE	20 A	1			0					18		
19	EXG SHOP LIGHTS	20 A	1	0				3	20 A	NEW EF-1	20		
21	NEW SF-3	20 A	3								22		
23						0					24		
25				0				3	20 A	NEW EF-3	26		
27											28		
29											30		

SPECIAL NOTES

REFER TO THE FRONT END BIDDING DOCUMENTS FOR DESCRIPTION OF ALTERNATES.

	Location: STORAGE 6 Mounting: Surface	3		Phas		3	208 \	Nye		A.I.C. Rating: Mains Type: MCB Rating: 200 A	
СКТ	LOAD	CKT BRK	POLES	A	В		С	POLES	CKT BRK	LOAD	СКТ
1	EXG SHOP LIGHTS	20 A	1	0				1	20 A	EXG PANEL OUTLET	2
3	EXG SHOP LIGHTS	20 A	1					1	20 A	EXG PANEL OUTLET	4
5	EXG METER SOCKETS	20 A	3			0		1	20 A	EXG TOOL, MAINT RM OUTLETS	6
7				0				1	20 A	EXG MECHANICAL RM OUTLETS	8
9					l			1	20 A	EXG MAINT RM OUTLETS	10
11	EXG SHOP OUTLETS	20 A	1			0		1	20 A	SPARE	12
13	EXG SHOP OUTLETS	20 A	1	0				2	50 A	EXG PRESSURE WASHER (GFCI)	14
15	EXG SHOP OUTLETS	20 A	1								16
17	EXG SHOP OUTLETS	20 A	1			0		2	30 A	EXG WATER HEATER	18
19	EXG SHOP OUTLETS	20 A	1	0							20
21	EXG SHOP OUTLETS	20 A	1					3	20 A	EXG LIFT CHARGER	22
23	EXG MECH RM LIGHTS	20 A	1			0					24
25	EXG METER RM OUTLETS	20 A	1	0							26
27	EXG CHECK OUT DESK OUTLETS	20 A	1					1	20 A	EXG EAST WALL SHOP OUTLETS	28
29	EXG TOOL RM OUTLETS	20 A	1			0		1	20 A	SPARE	30
31	EXG GEO CONTROLS	20 A	1	0				1	20 A	EXG EAST WALL SHOP OUTLETS	32
33	EXG GEO PUMPS	20 A	2					2	20 A	EXG LOAD CONTROL	34
35						0					36
37	EXG METER SOCKETS	20 A	2	3				3	100 A	PANEL 120-N-2	38
39					I						40
41	SPARE	20 A	1								42
Notes	I	207	'								72

	Location: MECHANICAL Mounting: Surface	141		Pł	nas	lts: es: es:		208 \	Nye		A.I.C. Rating: 10,000 Mains Type: MCB Rating: 200 A	
скт	LOAD	CKT BRK	POLES	4	4	В		С	POLES	CKT BRK	LOAD	СКТ
1	Receptacle Room 142, 129	20 A	1		1				1	20 A	Receptacle SUPPLY ROOM 124	2
3	*HEAT TRACE	30 A	2						1	20 A	Receptacle SUPPLY ROOM 124	4
5							0.		1	20 A	Receptacle SUPPLY ROOM 124	6
7	*HEAT TRACE	30 A	2		0				1	20 A	RESTROOM 127 HAND DRYER	8
9									1	20 A	Power TRAINING ROOM / BREAK ROOM	10
11	*HEAT TRACE	30 A	2				0.		1	20 A	Receptacle Space 139	12
13					7				1	20 A	Receptacle Space 139	14
15	*HEAT TRACE	30 A	2						1	20 A	Receptacles DISPATCH EAST	16
17							0.		1	20 A	Receptacles DISPATCH WEST	18
19	Receptacle STORAGE 125	20 A	1		9				1	20 A	Receptacle RESTROOM 138	20
21	RESTROOM 101A (EH-1)	20 A	1						1	20 A	Receptacle Room 110, 111	22
23	Receptacle VESTIBULE 100	20 A	1				1.		1	20 A	Receptacle MEMBER SERVICES 112	24
25	CUH-1	20 A	2	·	1				1	20 A	Receptacle MEMBER SERVICES 113	26
27									1	20 A	Receptacle Room 114, 115	28
29	CUH-2	20 A	2				3.		1	20 A	Receptacle STOR 116	30
31					1				1	20 A	Receptacle DISPATCH STORAGE 122	32
33	Receptacle LOBBY 101	20 A	1						1	20 A	Receptacle CORRIDOR 130	34
35	RESTROOM 101A HAND DRYER	20 A	1				0.		1	20 A	Receptacle Room 414, 594	36
	RESTROOM 140 HAND DRYER	20 A	1		0				2	30 A	DSC-1	38
39	Receptacle SERVER 126	20 A	1		····							40
41	Receptacle MECHANICAL 141	20 A	1				1		1	20 A	Power MECHANICAL 141	42
43	Receptacle MECHANICAL 141	20 A	1		1		1.		1	20 A	CP-8	44
45	Receptacle WEST EXTERIOR	20 A	1		1				1	20 A	EF-4	46
47	SF-2	20 A	1								HEAT PUMP CONTROLS	48
49		20 A	1		1		U.		1			50
-	Other		1		1					20 A	Receptacle SERVER 126	
51	Receptacle Room 128, 15	20 A	1						1	20 A	Receptacle SERVER 126	52
	RESTROOM 128 HAND DRYER	20 A	1		4		0.		1	20 A	Receptacle SERVER 126	54
	HUM-3	20 A	2	•••	1				1	20 A	Receptacle SERVER 126	56
57									1	20 A	LINECREW 121 SOUTH FLOOR BOXES	58
59	LINECREW 121 NORTH FLOOR BOXES	20 A	1				0.		1	20 A	LINECREW 121 SOUTH FLOOR BOXES	60
61	LINECREW 121 NORTH FLOOR BOXES	20 A	1		0				1	20 A	LINECREW 121 SOUTH FLOOR BOXES	62
	LINECREW 121 NORTH FLOOR BOXES	20 A	1						1	20 A	LINECREW 121 SOUTH FLOOR BOXES	64
	LINECREW 121 NORTH FLOOR BOXES	20 A	1				0.		1	20 A	Other MECHANICAL 141	66
	SPARE	25 A	2		0				2	30 A	WH-1	68
69												70
	GENERATOR BATTERY CHARGER	20 A	1				0.		1	20 A	CP-7	72
	GENERATOR BLOCK HEATER	20 A	1		0				1	20 A	SPARE	74
	SPARE	20 A	1						1	20 A	SPARE	76
	SPARE	20 A	1				0.		1	20 A	SPARE	78
79	SPARE	20 A	1		0				1	20 A	SPARE	80
81	SPARE	20 A	1						1	20 A	SPARE	82
83	SPARE	20 A	1				0.		1	20 A	SPARE	84

	Location: STORAGE 134 Mounting: Surface			Pł	Volt nase Wire	s: :		08 V	Vye		A.I.C. Rating: 10,000 Mains Type: MCB Rating: 200 A	
СКТ	LOAD	CKT BRK	POLES	A	4	В		3	POLES	CKT BRK	LOAD	CK
1	RANGE TRAINING ROOM / BREAK ROO	20 A	2		1				1	20 A	*Fridge TRAINING ROOM / BREAK ROOM	2
3									1	20 A	*Fridge TRAINING ROOM / BREAK ROOM	4
5	Power TRAINING ROOM / BREAK ROOM	20 A	1				0		1	20 A	Receptacle TRAINING ROOM / BREAK	6
7	Receptacle TRAINING ROOM / BREAK	20 A	1		1				1	20 A	Receptacle TRAINING ROOM / BREAK	8
9	Receptacle TRAINING ROOM / BREAK	20 A	1						1	20 A	Receptacle TRAINING ROOM / BREAK	10
11	Receptacle TRAINING ROOM / BREAK	20 A	1				1		1	20 A	OPEN OFFICE 102 FLOOR BOX	12
13	Receptacle TRAINING ROOM / BREAK	20 A	1		0				1	20 A	OPEN OFFICE 102 FLOOR BOX	14
15	Receptacle TRAINING ROOM / BREAK	20 A	1						1	20 A	OPEN OFFICE 102 FLOOR BOX	16
17	Receptacle TRAINING ROOM / BREAK	20 A	1				1	Ī	1	20 A	OPEN OFFICE 102 FLOOR BOX	18
19	Receptacle TRAINING ROOM / BREAK	20 A	1		1				1	20 A	Receptacle	20
21	Receptacle TRAINING ROOM / BREAK	20 A	1						1	20 A	Receptacle	22
23	* Fridge TRAINING ROOM / BREAK ROO	20 A	1				1		1	20 A	Power Space 143	24
25	* Fridge TRAINING ROOM / BREAK ROO	20 A	 1		0		-		1	20 A	OPEN OFFICE 102 FLOOR BOX	26
27	Receptacle TRAINING ROOM / BREAK	20 A	<u>·</u> 1		•				1	20 A	WOMENS 131 HAND DRYER	28
29	Receptacle TRAINING ROOM / BREAK	20 A	1				1		1	20 A	Receptacle Space 143	30
31	Receptacle TRAINING ROOM / BREAK	20 A	1		1	+	1		1	20 A	Receptacle Space 143	3:
33	Receptacle TRAINING ROOM / BREAK	20 A	1		1				1	20 A	Receptacle BOARD ROOM 137	34
35	Receptacle WOMEN 131	20 A	1			•••	3		1	20 A	Receptacle BOARD ROOM 137	36
37	·	20 A 20 A	1		1		3		1	20 A	·	38
	Receptacle CUST. 132		-		1			-	-		Receptacle BOARD ROOM 137	-
39	Receptacle MEN 133	20 A	1						1	20 A	Receptacle BOARD ROOM 137	40
41	Receptacle STORAGE 134	20 A	1				1		1	20 A	Receptacle BOARD ROOM 137	42
43	Receptacle OPEN OFFICE 102	20 A	1		1				1	20 A	Receptacle BOARD ROOM 137	44
45	Receptacle OPEN OFFICE 102	20 A	1						1	20 A	* Receptacle BOARD ROOM 137	40
47	Receptacle Room 104, 105	20 A	1				1		2	25 A	UH-3	48
49	Receptacle Room 106, 107	20 A	1		0							50
51	Receptacle CFO 103	20 A	1						1	20 A	LIGHT POLE RECEPTACLE NORTH WEST	52
53	Receptacle ACCT/ BILLING 109	20 A	1				1		1	20 A	LIGHT POLE RECEPTACLE WEST	54
55	MENS 133 HAND DRYER	20 A	1		0				1	20 A	LIGHT POLE RECEPTACLE SOUTH WEST	56
57	*Receptacle WORK AREA 123 (VENDING)	20 A	1						1	20 A	LIGHT POLE RECEPTACLE SOUTH	58
59	*Receptacle WORK AREA 123	20 A	1				1		1	20 A	SPARE	6
61	*Refrigeratoror Receptacle WORK AREA 123	20 A	1		0				1	20 A	SPARE	6
63	*Receptacle WORK AREA 123(VENDING)	20 A	1						1	20 A	SPARE	64
65	Receptacle WORK AREA 123	20 A	1				1		1	20 A	SPARE	6
67	Receptacle WORK AREA 123	20 A	1		0				1	20 A	SPARE	6
69	SPARE	20 A	1						1	20 A	SPARE	7
71	SPARE	20 A	1				0		1	20 A	SPARE	7:
73	SPARE	20 A	1		0				1	20 A	SPARE	74
75	SPARE	20 A	1						1	20 A	SPARE	76
77	SPARE	20 A	 1			-	0		1	20 A	SPARE	78
79	SPARE	20 A	1		0		J	Ë	1	20 A	SPARE	80
81	SPARE	20 A	1						1	20 A	SPARE	8:
83	SPARE	20 A	1				0		1	20 A	SPARE	8
os		207					0	1	<u>'</u>	207	O. 7 11 (L	

	Location: MECHAN Mounting: Surface	IICAL 141		Pha	se	s: 4 s: 3 s: 4	3	/277 V	Vye	A.I.C. Rating: 35,000 Mains Type: MLO Rating: 1000 A			
СКТ	LOAD	CKT BRK	POLES	A		В		С	POLES	CKT BRK	LOAD	скт	
1	PANEL H1	400 A	3	0					3	80 A	HP-1	2	
3												4	
5							8	3				6	
7	BOILER-1 (FEED #1)	150 A	3	0					3	80 A	HP-2	8	
9												10	
11							C)				12	
13	BOILER FEED #2	125 A	3	0					3	80 A	HP-3	14	
15												16	
17							C)				18	
19	XFMR 1	100 A	3	7					3	100 A	XFMR 3	20	
21												22	
23							7	7				24	
25	XFMR 2	100 A	3	0					3	200 A	EXG PANEL 277-N-1	26	
27												28	
29							7	7				30	
31	SPARE	225 A	3	0					3	100 A	SPARE	32	
33												34	
35							C)				36	
37	SPACE FOR FUTURE 225A		3	0					3	100 A	SPARE	38	
39												40	
41												42	
43	SPARE	225 A	3		-				3		SPACE 100A	44	
45						-	-					46	
47							C)				48	
49					1							50	
51												52	
53												54	
55												56	
57												58	
59												60	

	Location: MECHANICAL 1 Mounting: Surface	41		Ph	าลร	lts: 48 es: 3 es: 4	30/277	Wye			
СКТ	LOAD	CKT BRK	POLES	_	4	В	С	POLES	CKT BRK	LOAD	СКТ
1	CP-1	20 A	3		0			3	20 A	CP-2	2
3											4
5							0				6
7	CP-3	20 A	3		0			3	20 A	CP-4	8
9											10
11							0				12
13	CP-5	25 A	3		0			3	25 A	CP-6	14
15											16
17							0				18
19	HUM-1	20 A	3		3			3	30 A	HUM-2	20
21											22
23							3				24
25	BP-1	30 A	3		0			2	20 A	LS-1	26
27											28
29							0	. 3	20 A	AHU-1	30
31	Lighting - BOARD ROOM 137	20 A	1		0						32
33	Lighting - CORRIDOR 130	20 A	1								34
35	Lighting - CEO, COMM,ASSIST, ACT BILL	20 A	1				6	. 3	20 A	AHU-2	36
37	Lighting - OPEN OFFICE 102	20 A	1		0						38
39	Lighting - OPERATIONS 118,	20 A	1								40
41	Lighting - CORRIDIR 121 & WORK AREA	20 A	1				9	. 3	20 A	RF-1	42
43	Lighting - Dwelling Unit CORRIDOR-1 129-1	20 A	1		0						44
45	Lighting - DISPATCH 120, LINEMAN 121	20 A	1								46
47	NEC SIGNAGE POWER	20 A	1				0	. 3	20 A	RF=2	48
49	Lighting - MECH 141 MEZZ LIGHTING	20 A	1		0						50
51	Lighting - LOBBY 101	20 A	1								52
53	Lighting - EAST EXTERIOR LIGHTING	20 A	1				4	. 1	20 A	SPARE	54
55	Lighting - TRAINING ROOM / BREAK ROO	20 A	1		0			1	20 A	SPARE	56
57	Lighting - WEST EXTERIOR LIGHTING	20 A	1					1	20 A	SPARE	58
59	Lighting - VESTIBULE 100	20 A	1				0	. 1	20 A	SPARE	60
61	SOUTH WEST EXTERIOR LINEAR	20 A	1		0			1	20 A	SPARE	62
63	SOUTH EAST EXTERIOR LINEAR	20 A	1					1	20 A	SPARE	64
65	FLAG POLE LIGHTING	20 A	1				0	. 1	20 A	SPARE	66
67	SPARE	20 A	1		0			1	20 A	SPARE	68
69	SPARE	20 A	1					1	20 A	SPARE	70
71	SPARE	20 A	1				0	. 1	20 A	SPARE	72
73											74
75											76
77											78
79											80
81											82
83											84

	Location: STORAGE 6 Mounting: Surface	3	Volts: 120/208 Wye Phases: 3 Wires: 4							A.I.C. Rating: 10,000 Mains Type: MLO Rating: 100 A		
СКТ	LOAD	CKT BRK	POLES		4	В		С	POLES	CKT BRK	LOAD	скт
1	Power	20 A	1		0				1	20 A	SPARE	2
3	SPARE	20 A	1						1	20 A	SPARE	4
5	SPARE	20 A	1				_)	1	20 A	SPARE	6
7	SPARE	20 A	1		0				1	20 A	SPARE	8
9	SPARE	20 A	1						1	20 A	SPARE	10
11	SPARE	20 A	1				C)	1	20 A	SPARE	12
13	SPARE	20 A	1		0				1	20 A	SPARE	14
15	SPARE	20 A	1						1	20 A	SPARE	16
17	SPARE	20 A	1				C)	1	20 A	SPARE	18
19	SPARE	20 A	1		0				1	20 A	SPARE	20
21	SPARE	20 A	1						1	20 A	SPARE	22
23	Receptacle	20 A	1				1	1				24
25	Receptacle	20 A	1									26
27	Receptacle	20 A	1									28
29	HVAC	20 A	1				1	1				30
31	Power	20 A	1									32
33	Receptacle	20 A	1									34
35	HVAC	20 A	1				1	1				36
37	Receptacle	20 A	1									38
39												40
41												42



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SHEET TITLE: ELECTRICAL SCHEDULES