LINCOLN ELEMENTARY RESTROOM Aberdeen School District 6-1 ABERDEEN, SOUTH DAKOTA RENOVATIONS







OWNER: ABERDEEN SCHOOL DISTRICT 6-1

801 RAILROAD AVENUE SE

Aberdeen, SD 57401

Phone: 605-225-4344



1224 S. 3rd Street Aberdeen, SD 57401 Phone: 605-725-7100 DRAWING SHEET INDEX:

CODE

G100 **GENERAL NOTES, CODE & ORIENTATION PLAN**

G102 CODE STANDARDS AND SYMBOLS LEGEND

ARCHITECTURAL

A100	DEMOLITION PLANS & ENLARGED FLOOR PLANS
A101	INTERIOR ELEVATIONS, ROOM FINISH SCHEDULE, FINISH
	LEGEND, MISC. DETAILS
A102	REFLECTED CEILING PLANS

MECHANICAL

MOTOR SCHEDULE, LEGEND & SHEET INDEX
PLUMBING & HYDRONICS DEMOLITION PLAN
PROPOSED PLUMBING & HYDRONICS PLAN
PLUMBING FIXTURE SCHEDULE
HVAC & FIRE PROTECTION PLAN

ELECTRICAL

ELECTRICAL PLAN E200

GENERAL NOTES

- SEE MECHANICAL, AND ELECTRICAL FOR ADDITIONAL INFORMATION AND COORDINATION.
- REFER TO SHEET <u>G101</u> FOR ALL ADA CODE STANDARDS. • SQUARE FOOTAGES LISTED ARE FOR CODE REVIEW PURPOSES ONLY AND SHOULD NOT BE
- USED FOR ANY OTHER PURPOSES.
- COORDINATE WORK DONE BY OTHERS AS INDICATED ON THE DRAWINGS. • CONTRACTOR TO VERIFY ALL EXISTING CONDITIONS, ELEVATIONS AND DIMENSIONS.
- ALL WORK SHALL BE IN ACCORDANCE WITH OSHA CODES AND STANDARDS. NOTHING INDICATED ON THESE DRAWINGS SHALL RELIEVE THE CONTRACTOR FROM COMPLYING WITH
- ANY APPROPORIATE SAFETY REGULATIONS. • THE CONTRACTOR SHALL CONSTRUCT ALL ITEMS WITHIN THIS CONTRACT IN ACCORDANCE WITH THE STATE AND LOCAL REGULATIONS AND CODES.
- REVIEW ALL INTERIOR ELEVATION SHEETS FOR ACCESSORY AND EQUIPMENT INFORMATION. COORDINATE WITH CODE STANDARD SHEET <u>G101</u>.
- COORDINATE ALL CHASE SIZES AND LOCATIONS W/ MECHANICAL. PROVIDE CHASES AT ALL EXPOSED MACHANICAL & ELECTRICAL WITH ADJACENT WALL MATERIAL AS REQUIRED.

DEMOLITION NOTES

- SEE MECHANICAL, AND ELECTRICAL DRAWINGS FOR ADDITIONAL INFORMATION RELEVANT TO DEMOLITION & PATCHING.
- PATCH REMAINING EXISTING CONSTRUCTION, AFFECTED BY DEMOLITION, TO MATCH EXISTING U.O.N.
- COORDINATE WITH OWNER ANY DEMO ITEMS TO BE SALVAGED FOR THE OWNERS REUSE.

FINISHES NOTES

- SEE DRAWING SHEET A1-3 FOR ROOM FINISH SCHEDULE.
- INTERIOR WALL FINISHES ARE FULL HEIGHT, U.N.O.
- PREP ALL EXISTING WALLS AS REQUIRED FOR PROPER ADHESION OF NEW WALL TILE. • PREP ALL EXISTING WALLS AS REQUIRED FOR NEW PAINTING.


ARCHITECTURAL GENERAL NOTES

CEILING NOTES

- ALL ITEMS INSTALLED IN CEILINGS, INCLUDING SPRINKLER HEADS, ARE TO BE CENTERED OR SYMMETRICALLY ARRANGED ON OR ABOUT CENTERLINES OF ROOMS AND CENTERED IN CEILING TILES.
- WALL MOUNTED EXIT SIGNS AND FIXTURES ARE TO BE CENTERED OVER DOOR OR DOOR OPENING WHERE APPLICABLE.
- REFER TO SPECIFICATIONS FOR CEILING AND FIXTURE SUSPENSION REQUIREMENTS.
- PROVIDE ACCESS DOORS AT ALL MECHANICAL UNIT LOCATIONS ABOVE SOFFIT. COORD. NUMBER REQUIRED AND LOCATIONS WITH MECHANICAL SHEETS.
- CENTER CEILING GRID IN AREAS SUCH THAT THERE WILL BE NO CEILING TILE LESS THAN 6" IN THE SMALLEST DIMENSION, U.N.O.
- THE REFLECTED CEILING PLANS ARE INTENDED TO AID IN COORDINATION ONLY AND ARE NOT INTENDED TO BE COMPREHENSIVE. SEE MECHANICAL AND ELECTRICAL DRAWINGS FOR ADDITIONAL INFORMATION. WHERE CONFLICTS OCCUR, NOTIFY ARCHITECT.
- COORDINATE WITH MEP FOR LOCATION OF CEILING ACCESS PANELS. • CENTER LIGHT FIXTURES BETWEEN WALLS AND/OR CEILING BULKHEADS UNLESS DIMENSIONED OTHERWISE.
- ALIGN GYPSUM BOARD CEILINGS AND SOFFITS WITH ADJACENT PARTITIONS, U.N.O. • IN ALL EXPOSED TO STRUCTURE ROOMS, CENTER LIGHT FIXTURE WITHIN ROOM


DOORS, HARDWARE & WINDOWS NOTES

- ALL HM FRAMES IN STUD PARTITIONS SHALL BE WRAPPED AROUND BOTH SIDES OF
- PARTITION (U.O.N.) SEE PLAN FOR WALL THICKNESS.
- ALL EXTERIOR FRAMES & DOORS ARE TO BE THERMALLY BROKEN.
- CAULK ENTIRE PERIMETER OF H.M. FRAMES (BOTH SIDES).
- PAINT FRAMES TO MATCH WALL. SPLIT PAINT COLOR AT DOOR GASKET AS REQUIRED. • PROVIDE ROOM SIGNAGE AT ALL DOORS. WHERE MOUNTED TO GLAZING, PROVIDE A BLANK BACK PLATE ON OPPOSIZE SIDE OF GLAZING. SEE CODE STANDARDS FOR MOUNTING HEIGHTS AND LOCATIONS. SEE SPECIFICATIONS FOR SPECIAL SIGNAGE REQ.
- REFER TO WALL TYPES FOR WALL CONSTRUCTION ELEMENTS FOR ALL DOOR AND WINDOW DETAILS. COORDINATE ALL STRUCTURAL REQ. WITH STRUCTURAL DRAWINGS.
- WALL MOUNTED EXIT SIGNS AND FIXTURES ARE TO BE CENTERED OVER DOOR OR DOOR OPENING WHERE APPLICABLE.

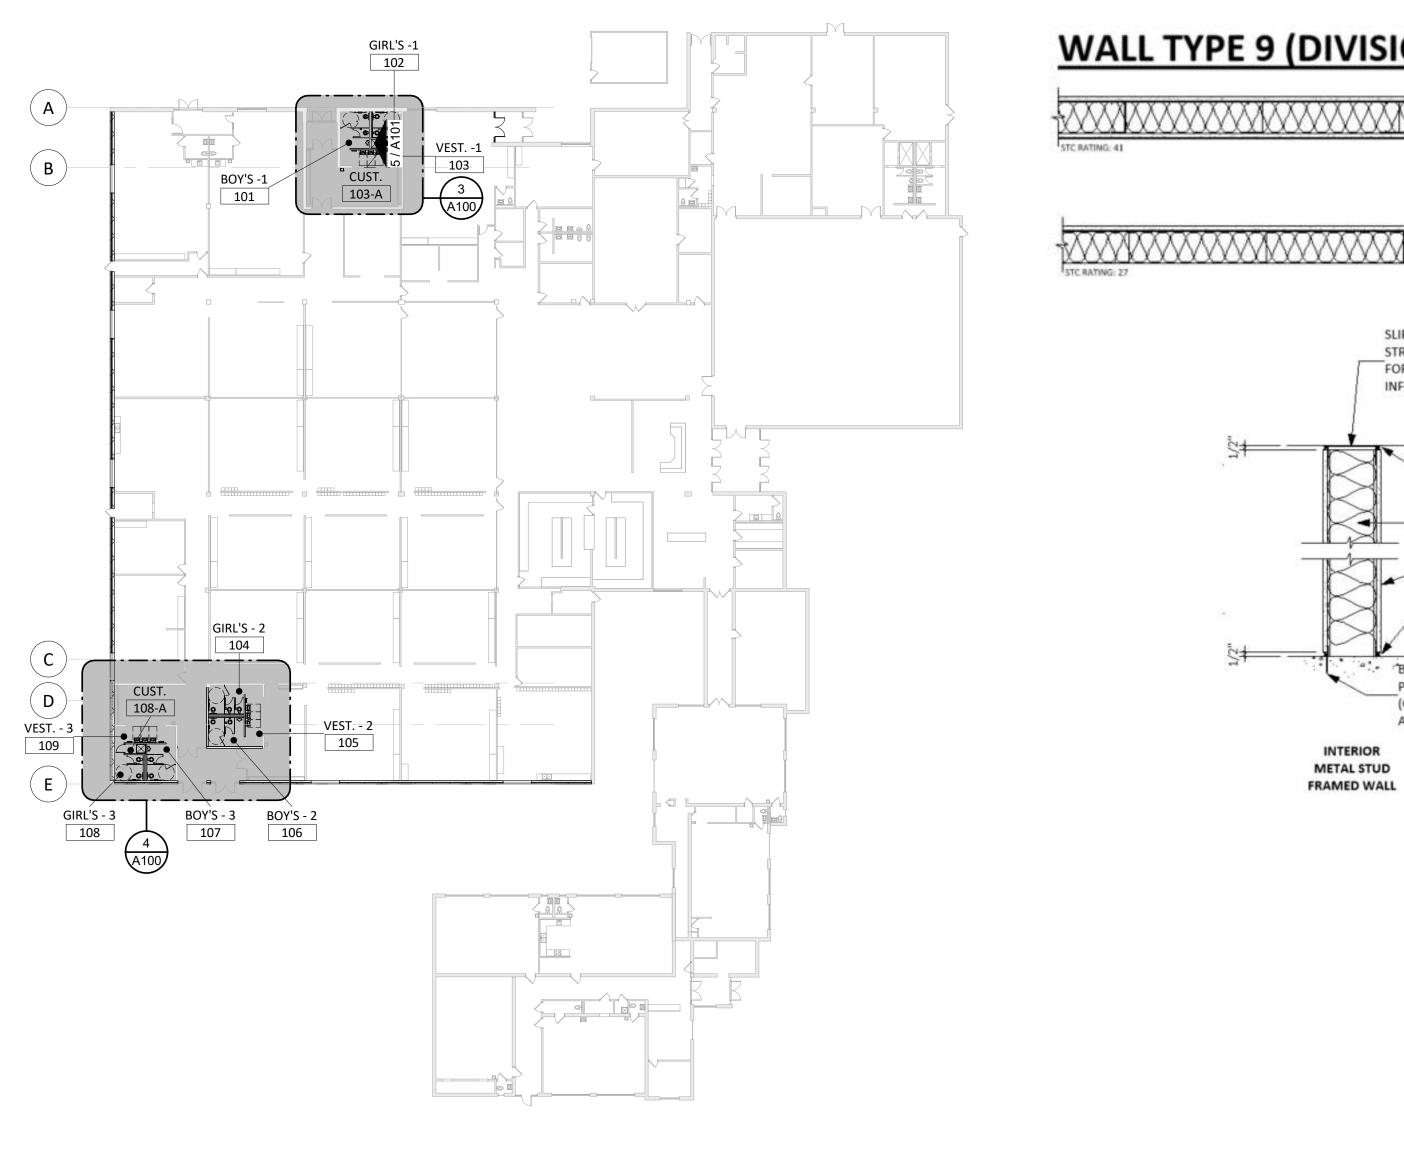





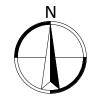

FLOOR NOTES

• SEE MECHANICAL FOR ALL FLOOR DRAIN SIZES AND LOCATIONS U.N.O. SET FLOOR DRAINS MINIMUM 3/4" BELOW FINISHED FLOOR. PROVIDE EVEN SLOPE FROM WALL TO DRAIN W/ A MAXIMUM SLOPE OF ¼" PER FOOT.


WALL NOTES

- ALL WALLS TO BE TYPE 9A AND TYPE 9D U.O.N. AND EXTEND TO DECK UNLESS OTHERWISE NOTED ON WALL TYPES.
- ALL DIMENSIONS ARE FROM FACE GWB TO FACE OF GWB U.N.O.
- COORDINATE ALL CHASE SIZES AND LOCATIONS W/ MECHANICAL. PROVIDE CHASES AT ALL EXPOSED MACHANICAL & ELECTRICAL WITH ADJACENT WALL MATERIAL AS REQUIRED.
- INCREASE WALL THICKNESS OF METAL STUD AND CONCRETE BLOCK WALLS AS REQUIRED TO ACCOMMODATE MECHANICAL AND ELECTRICAL DEVICES- VERIFY WITH ARCHITECT PRIOR TO WORK.
- PROVIDE WATER-RESISTANT GYPSUM BOARD PANELS AT ALL BATHROOM AND SHOWER ROOM WALLS AND CEILINGS WHERE EXPOSED TO MOISTURE.
- RESTROOM WALLS ARE SOUND INSULATED AND EXTEND TO THE DECK.
- VERIFY DRYWALL CONTROL JOINT LOCATIONS w/ARCHITECT ON SITE PRIOR TO INSTALLATION. THIS INCLUDES, BUT IS NOT LIMITED TO, CONTROL JOINTS AT 30'-0" O.C. MAX. IN LONG WALL EXPANSES. CONTROL JOINTS AT DOOR JAMBS EXTENDING FROM DOOR HEAD TO CEILING. CONSIDERATION SHALL ALSO BE GIVEN TO LOCATING CONTROL JOINTS FROM FLOOR TO CEILING AT EITHER EDGE OF LARGE WINDOW OPENINGS.
- THE AIR & MOISTURE WEATHER BARRIER IS TO BE CONTINUOUS FROM THE BASE OF THE WALLS UP TO & TYING INTO THE ROOF BARRIER SYSTEM.

FIXTURES NOTES

- CAULK PERIMETER OF ALL TUB/SHOWER UNITS, TOILETS, URINALS, SINKS & COUNTERTOPS AS REQUIRED.
- REVIEW ALL INTERIOR ELEVATION SHEETS FOR ACCESSORY AND EQUIPMENT INFORMATION. • PROVIDE 2x FIRE TREATED BLOCKING AT ALL GRAB BAR. SEE CODE SHEETS FOR ADDITIONAL
- BLOCKING INFORMATION.

WALL TYPE 9 (DIVISION 9 - INTERIORS)

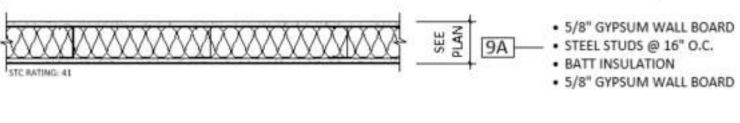





- STEEL STUDS @ 16" O.C. BATT INSULATION
- SLIP TRACK AT BOTTOM OF STRUCTURE (SEE STRUCT. FOR ADDITIONAL INFORMATION) -B.O. STRUCTURE \$† _ _ ACOUSTICAL SEALANT (TYP. BOTH SIDES) SOUND ATTENUATION BATT INSULATION VERIFY WALL ASSEMBLY w/ WALL TYPES ACOUSTICAL SEALANT (TYP. BOTH SIDES) šŧ—− "BOND BREAK IN CAST-IN-PLACE CONCRETE (COORDINATE WITH ARCHITECT) INTERIOR


METAL STUD FRAMED WALL


		2018	INTER	NATIO	NAL B	UILDI	NG CO	DE			-
BUILDING	OCCUP.	TYPE OF	NO. OF		PERIMETER			ACTUAL	соммт.		
AREA	E TYPE E	CONSTR. 5-A	STORIES	Y	W/20' YD.	BUILDING	AREA/FLK.	AKEA/FLK.			
										Arch	OP
			PRO	JECT IN	IFORMA	TION					
PROJECT NA	ME:			ROOM RENOVA	TIONS						
ADDRESS:		1414 S 10TH S	TREET								. Main St. 102 een, SD 57401
OWNER: LEGAL DESC		Aberdeen Scho	ool District 6-1								605-725-4852
LEGAL DESC	RIFTION.										nsas City St. 7 City, SD 57701
ZONING:		R-2									605-716-3652
SETBACK RE		: FRONT:		SID)E.		REAR:				. 8th St. 221 alls, SD 57103
PARKING SET											605-334-9999
PROPERTY A										со-с	pparch.com
EXISTING BUI BUILDING HE											
PARKING REC											
PARKING PRO	OVIDED:										
FIRST FLOOR	R ELEVATION:										
<u>A</u>			<u> </u>	ABBREV	VIATIONS		<u>p</u>				
A/C AIR COI AB ANCHO			FFE FF	FINISHED FLOOR FINISHED FLOOR		I		ER SQAURE FOO	Г		
ADJ ADJUST		R	FRP	FLOOR FIBERGLASS REIN	FORCED PANEL		PTB PAVER TILE PWD PLYWOO				
	FINISH FLOOR	т		FOOT FOOTING FABRIC WALL C	OVERING		<u>D</u> QB QUARRY TI				
ALOW ALOW ALT ALTERN ANC ANCH	NATE		<u> </u>				QUARRY TI			1	
	TICAL PANEL CE	EILING	GALV	GALVANIZED GRAB BAR			<mark>r</mark> RB RESILIENT E	BASE		CO-OP PROJEC	CT NO: 2259
	M OF CURB		GLAZ	GENERAL CONTRA		I	RD ROOF DRAI				
BD BOARD BLDG BUILI BLKG BLOC	DING		GWB GWT	GYPSUM WALL GLAZED WALL ⁻ GLAZED WALL TIL	TILE	I	RM ROOM RO ROUGH OP RST RESILIENT S	ENING STAIR TREAD		THIT	ERED ARC.
BING BUULING B.O. BOTTOI	OSE		<u>H</u>	GLAZED WALL III		I	RT RUBBER TIL RVB RUBBER VE	E		HILLING CONTRACT	REG. NO.
	OM OF WALL		HB	HOSE BIB HANDICAPPED			5				-9649
BRL BRICK L BURN BURN	LEDGE NISHED BLOCK		HM	HORIZONTAL LOU HOLLOW METAL				COATING (COLOI	R #)		HURLBERT
<u>C</u>			HT	HIGH PERFORMA HEIGHT			SCONC SEALED	OCONCRETE		511111	HURLBERT
	R GUARD OL JOINT		HVAC	HEATING, VENT	TING & AIR COND	5	SIM SIMILAR SQ SQUARE SS STAINLESS	CTEFI			MUMMIN .
	CRETE MASONR	RY UNIT	<u>I</u> ID INSL	INSIDE DIAMETER	3	:	STAINLESS STD STANDARD STL STEEL	SIEEL			
	MPARTMENT			INTERIOR				'L FLOORING CAL		ISSUE: 11-23-2022 CONST	
	TINUOUS OR CC	ONTINUE		JOIST BEARING EI	LEVATION	:	Ľ			REVISION SCH	
CONTR CO CPT CARPET	г		JST . DI TI	JOIST PINT		-	TB TACKBOAR			REV. # REV	V. DSC. REV. DATE
CT CERAM	SHEET VINYL BAS IIC TILE IIC TILE BASE	SE	<u>L</u> LAM	LAMINATE		-	TBD TO BE DETE TC TOP OF CU TERR TERRAZZ	RB			
<u>D</u>	IIC TILL BASE			LAVATORY		-	F.O. TOP OF F.O. TOP OF CO				
DBL DOUBLI DIA DIAMET			<u>M</u> MAX	MAXIMUM		-	TOF TOP OF FO	DTING			
	ENSION MOLITION			MARKER BOARD MECHANICAL			TOO TOP OF C				
	NG FOUNTAIN		MTL MIN	METAL MINIMUM		-	TOS TOP OF STE	VALL		PROJECT:	/IENTARY RESTROON
DR DOOR DS DOWNS DW DISH W			MO MST MTB	MASONRY OPENI MOSAIC TILE MOSAIC TILE B/		-	TPD TOILET PAP TS TALL STOR/ TV TELEVISION			RENOVATION	
DWG DRAV			<u>N</u>	WOSAIC HELD			TYP TYPICAL				
<u>E</u> EA EACH			NIC NO	NOT IN CONTRAC NUMBER	CT		<u>u</u> JNO UNLESS I	NOTED OTHERW	ISE		
EJ EXPANSIC	TNIOL NC	I FINISH SYSTEM	NOM NTS	NOMINAL NOT TO SCALE		-				SHEET TITLE:	
ELEV ELEV ELEC ELECT EO FOLIAL	TRIC		<u>o</u> oc	ON CENTER		,	VCT VINYL CON VEND VENDING VERT VERTICAI	MACHINE		GENERAL NOT	
	UIPMENT ED STRUCTURE		OD	ON CENTER OUTSIDE DIAMET OVERHEAD	ER	,	VTR VENT THRU			ORIENTATION	r lan
EW EACH W		OOLER	<u>P</u>	N				ALL COVERING			
EXPO EXPO EXIST EXIST	SED		PT	PAINT PLATE			<u>и</u> w/ with				100
EXT EXTERIO <u>E</u>			PLAS	PLASTER PLASTIC LAMIN	IATE	,	W/O WITHOU WB WOOD BAS	E			100
FD FLOOR		S				,	WC WATER CLO				
FE FIRE EX	NDATION (TINGUISHER (TINGUISHER CA					,	WH WATER HEA WOM WALK OF				
FEC FIRE EX	TINGUISHER CA	ARINEI					NT WEIGHT]	


<u>A</u>	E
A/C AIR CONDITION AB ANCHOR BOLT	F
ACPL ACOUSTICAL PLASTER	F
ADJ ADJUSTABLE	F
AFF ABOVE FINISH FLOOR	F
AHU AIR HANDELING UNIT ALUM ALUMINUM	F
ALT ALTERNATE	
ANC ANCHOR	<u>c</u>
APC ACOUSTICAL PANEL CEILING	Ģ
	0
<u>B</u> BC BOTTOM OF CURB	((
BD BOARD	Ģ
BLDG BUILDING	Ģ
BLKG BLOCKING	G
BN BULLNOSE B.O. BOTTOM OF	
BOW BOTTOM OF WALL	<u>₽</u> ⊦
BRG BEARING	ŀ
BRL BRICK LEDGE	F
BURN BURNISHED BLOCK	F
<u>C</u>	ł
<u>C</u> CG CORNER GUARD	r F
CJ CONTROL JOINT	-
CLG CEILING	1
CMU CONCRETE MASONRY UNIT	l
COL COLUMN COMP COMPARTMENT	l I
CONC CONCRETE	•
CONSTRCONSTRUCTION	Ţ
CONT CONTINUOUS OR CONTINUE	J
CONTR CONTRACTOR	J
CPT CARPET CSV COVE SHEET VINYL BASE	J
CT CERAMIC TILE	Ŀ
CTB CERAMIC TILE BASE	L
_	L
<u>D</u> DBL DOUBLE	<u>N</u>
DIA DIAMETER	<u>1</u> N
DIM DIMENSION	Ν
DEMO DEMOLITION	Ν
DET DETAIL	N
DF DRINKING FOUNTAIN DR DOOR	A A
DS DOWNSPOUT	N
DW DISH WASHER	Ν
DWG DRAWING	
-	<u>1</u> 1
<u>E</u> EA EACH	r N
EIFS EXTERIOR INSULATION FINISH SYSTEM	N
EJ EXPANSION JOINT	Ν
ELEV ELEVATION	
ELEC ELECTRIC EQ EQUAL	<u>c</u>
EQUIP EQUIPMENT	C
ES EXPOSED STRUCTURE	Ċ
EW EACH WAY	
EWC ELECTRIC WATER COOLER	<u> </u>
EXPO EXPOSED EXIST EXISTING	P
EXIST EXISTING EXT EXTERIOR	P
<u>E</u>	P
FBO FURNISHED BY OTHERS	
FD FLOOR DRAIN	
FDN FOUNDATION	

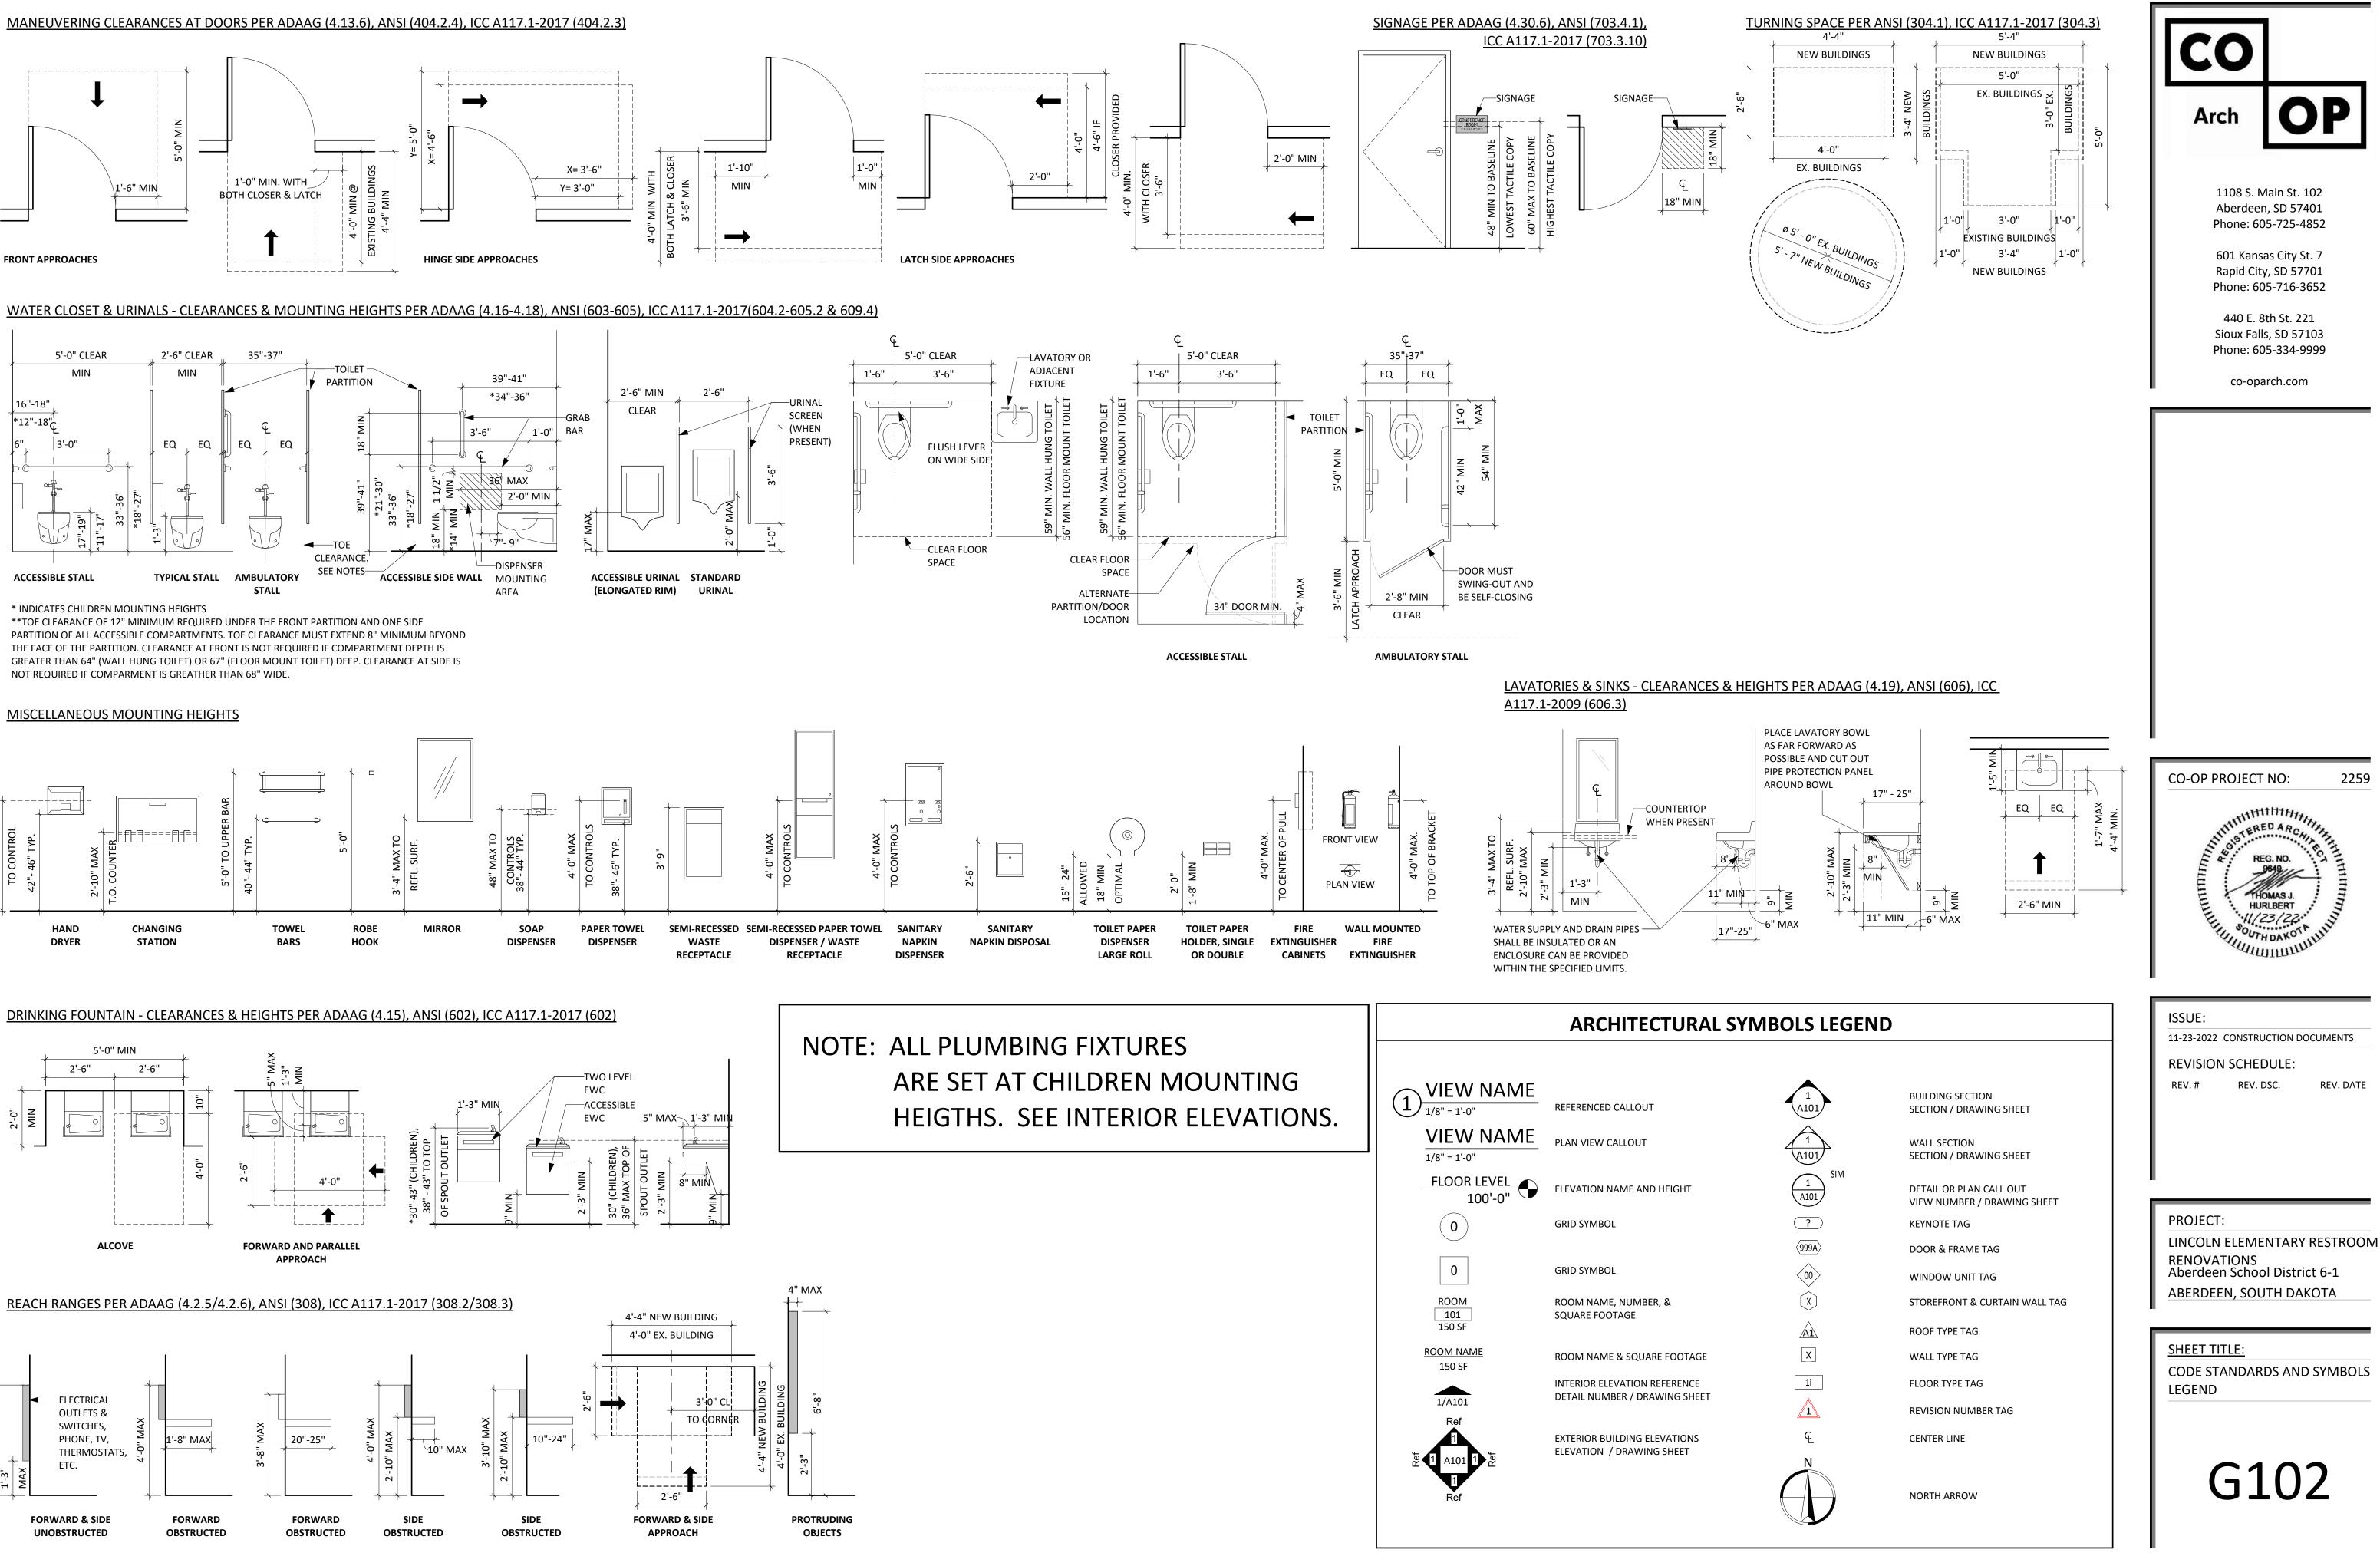


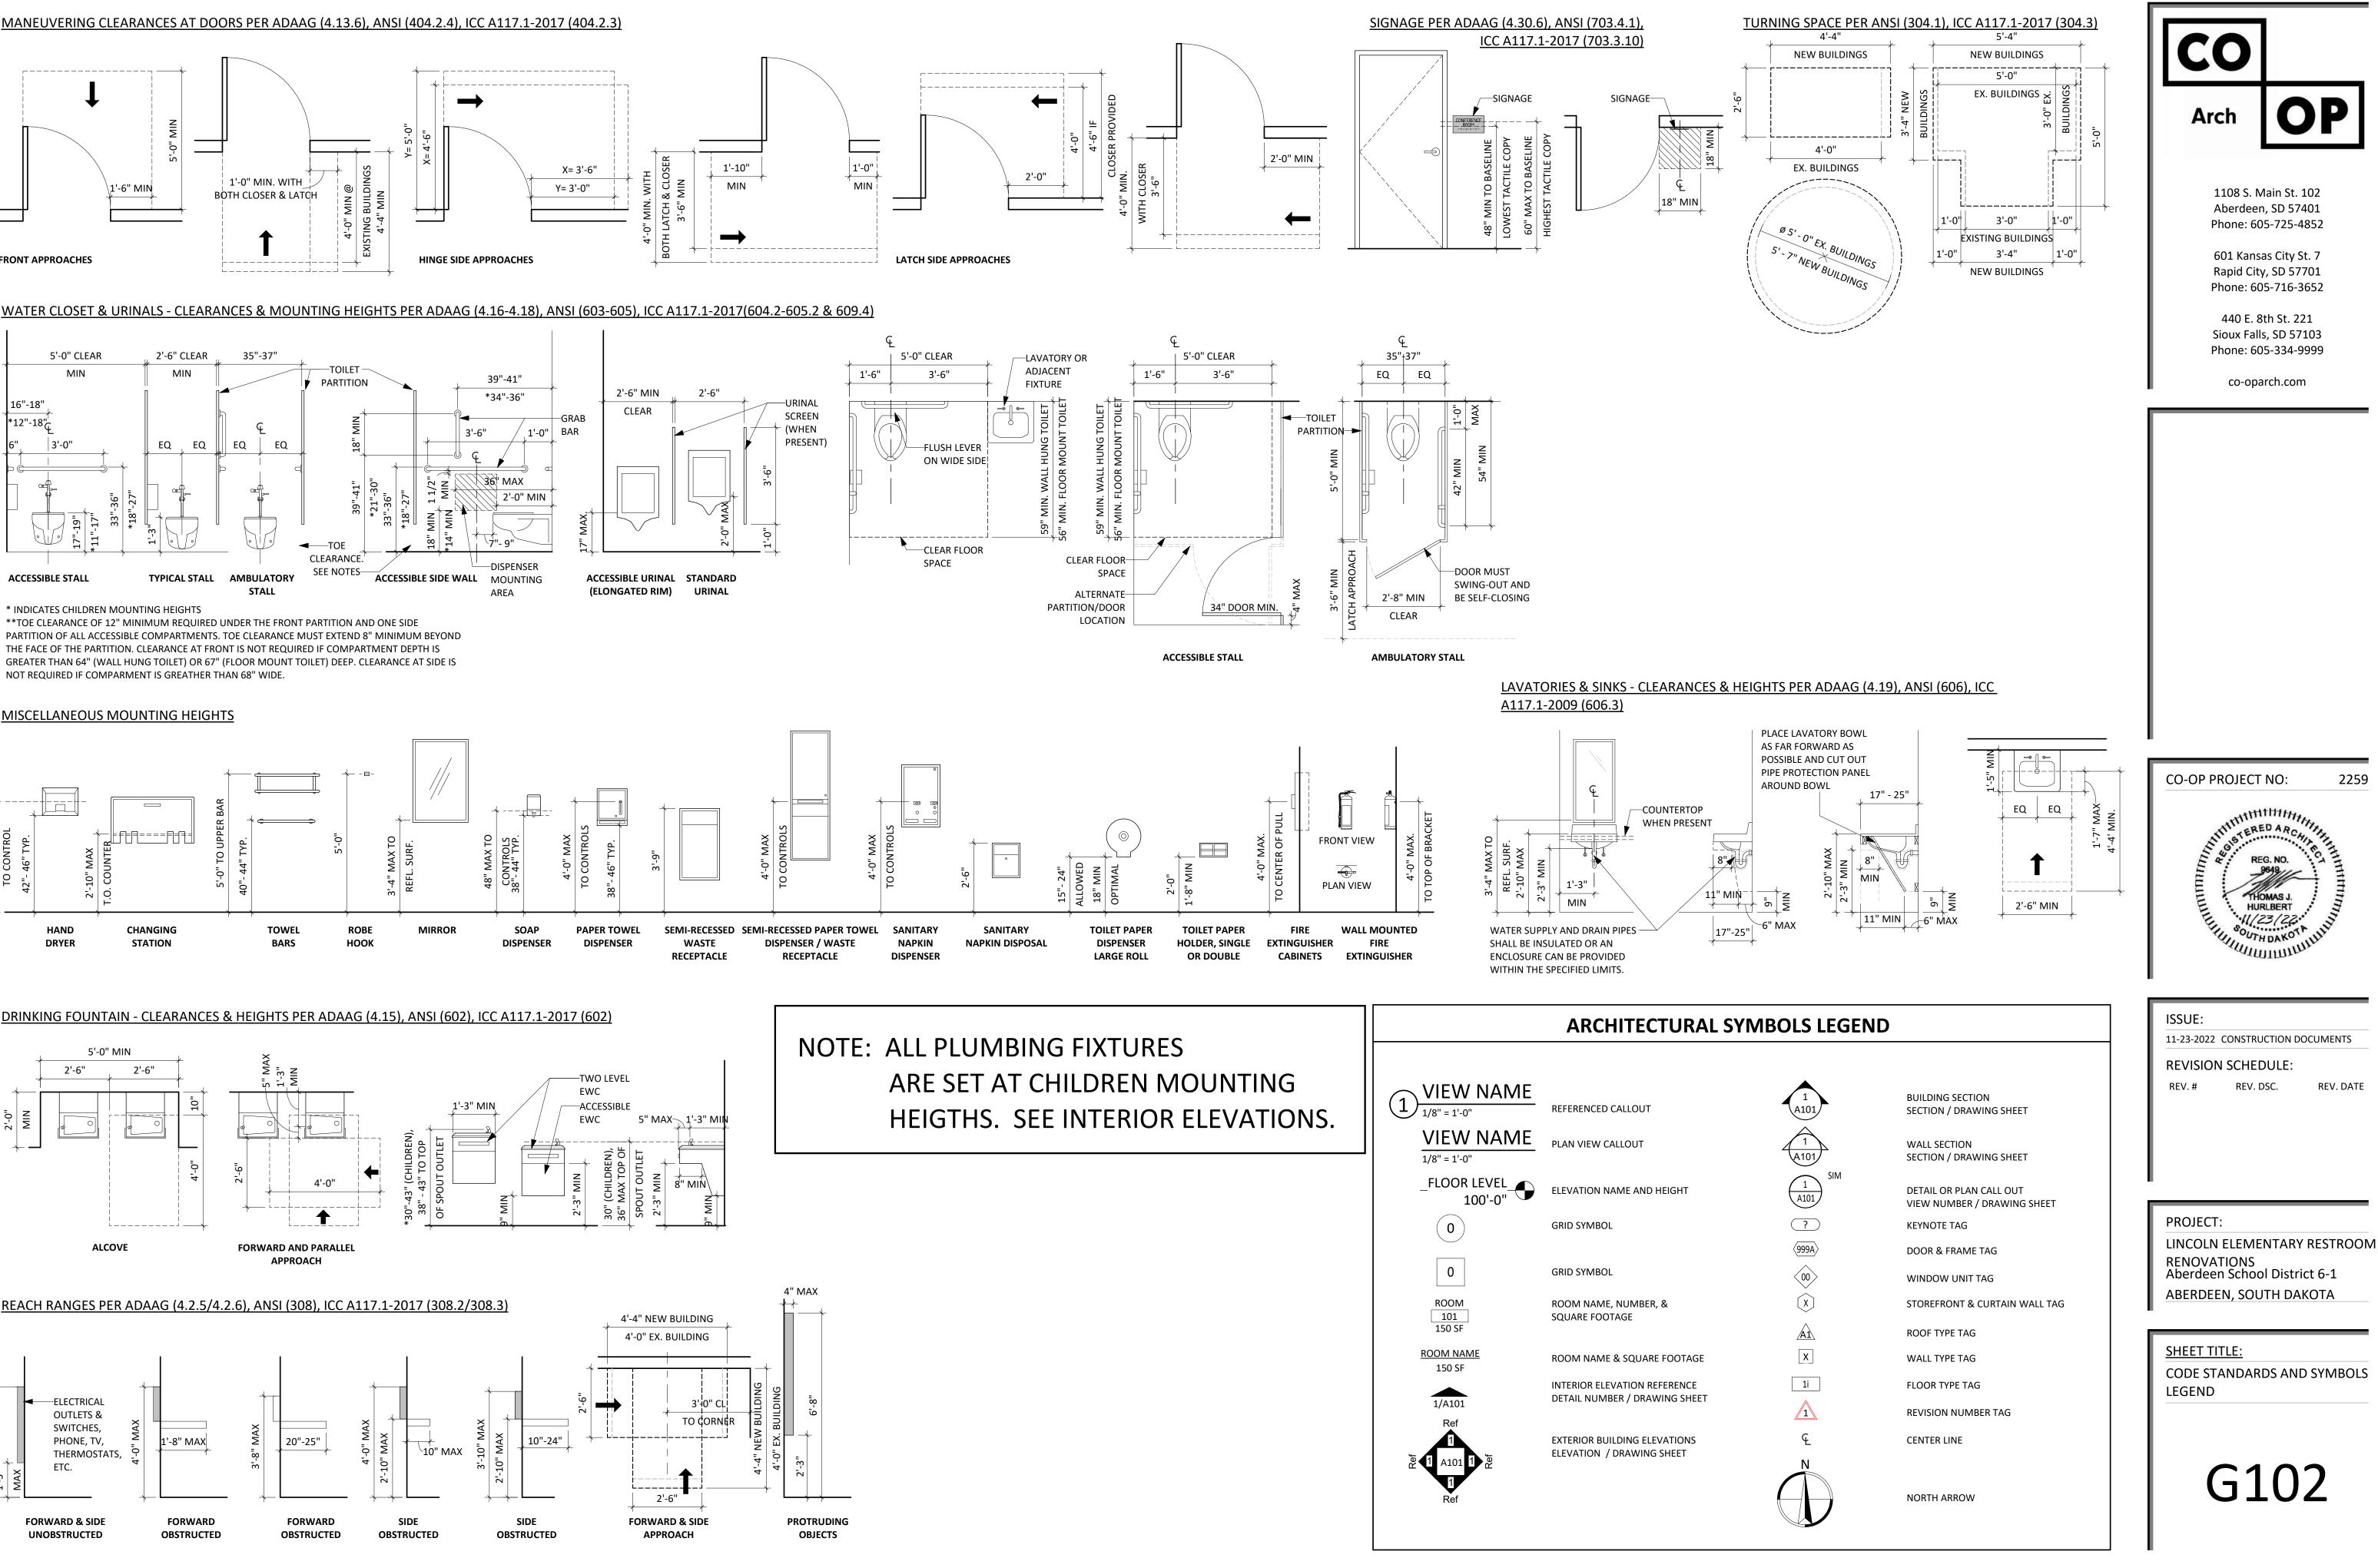

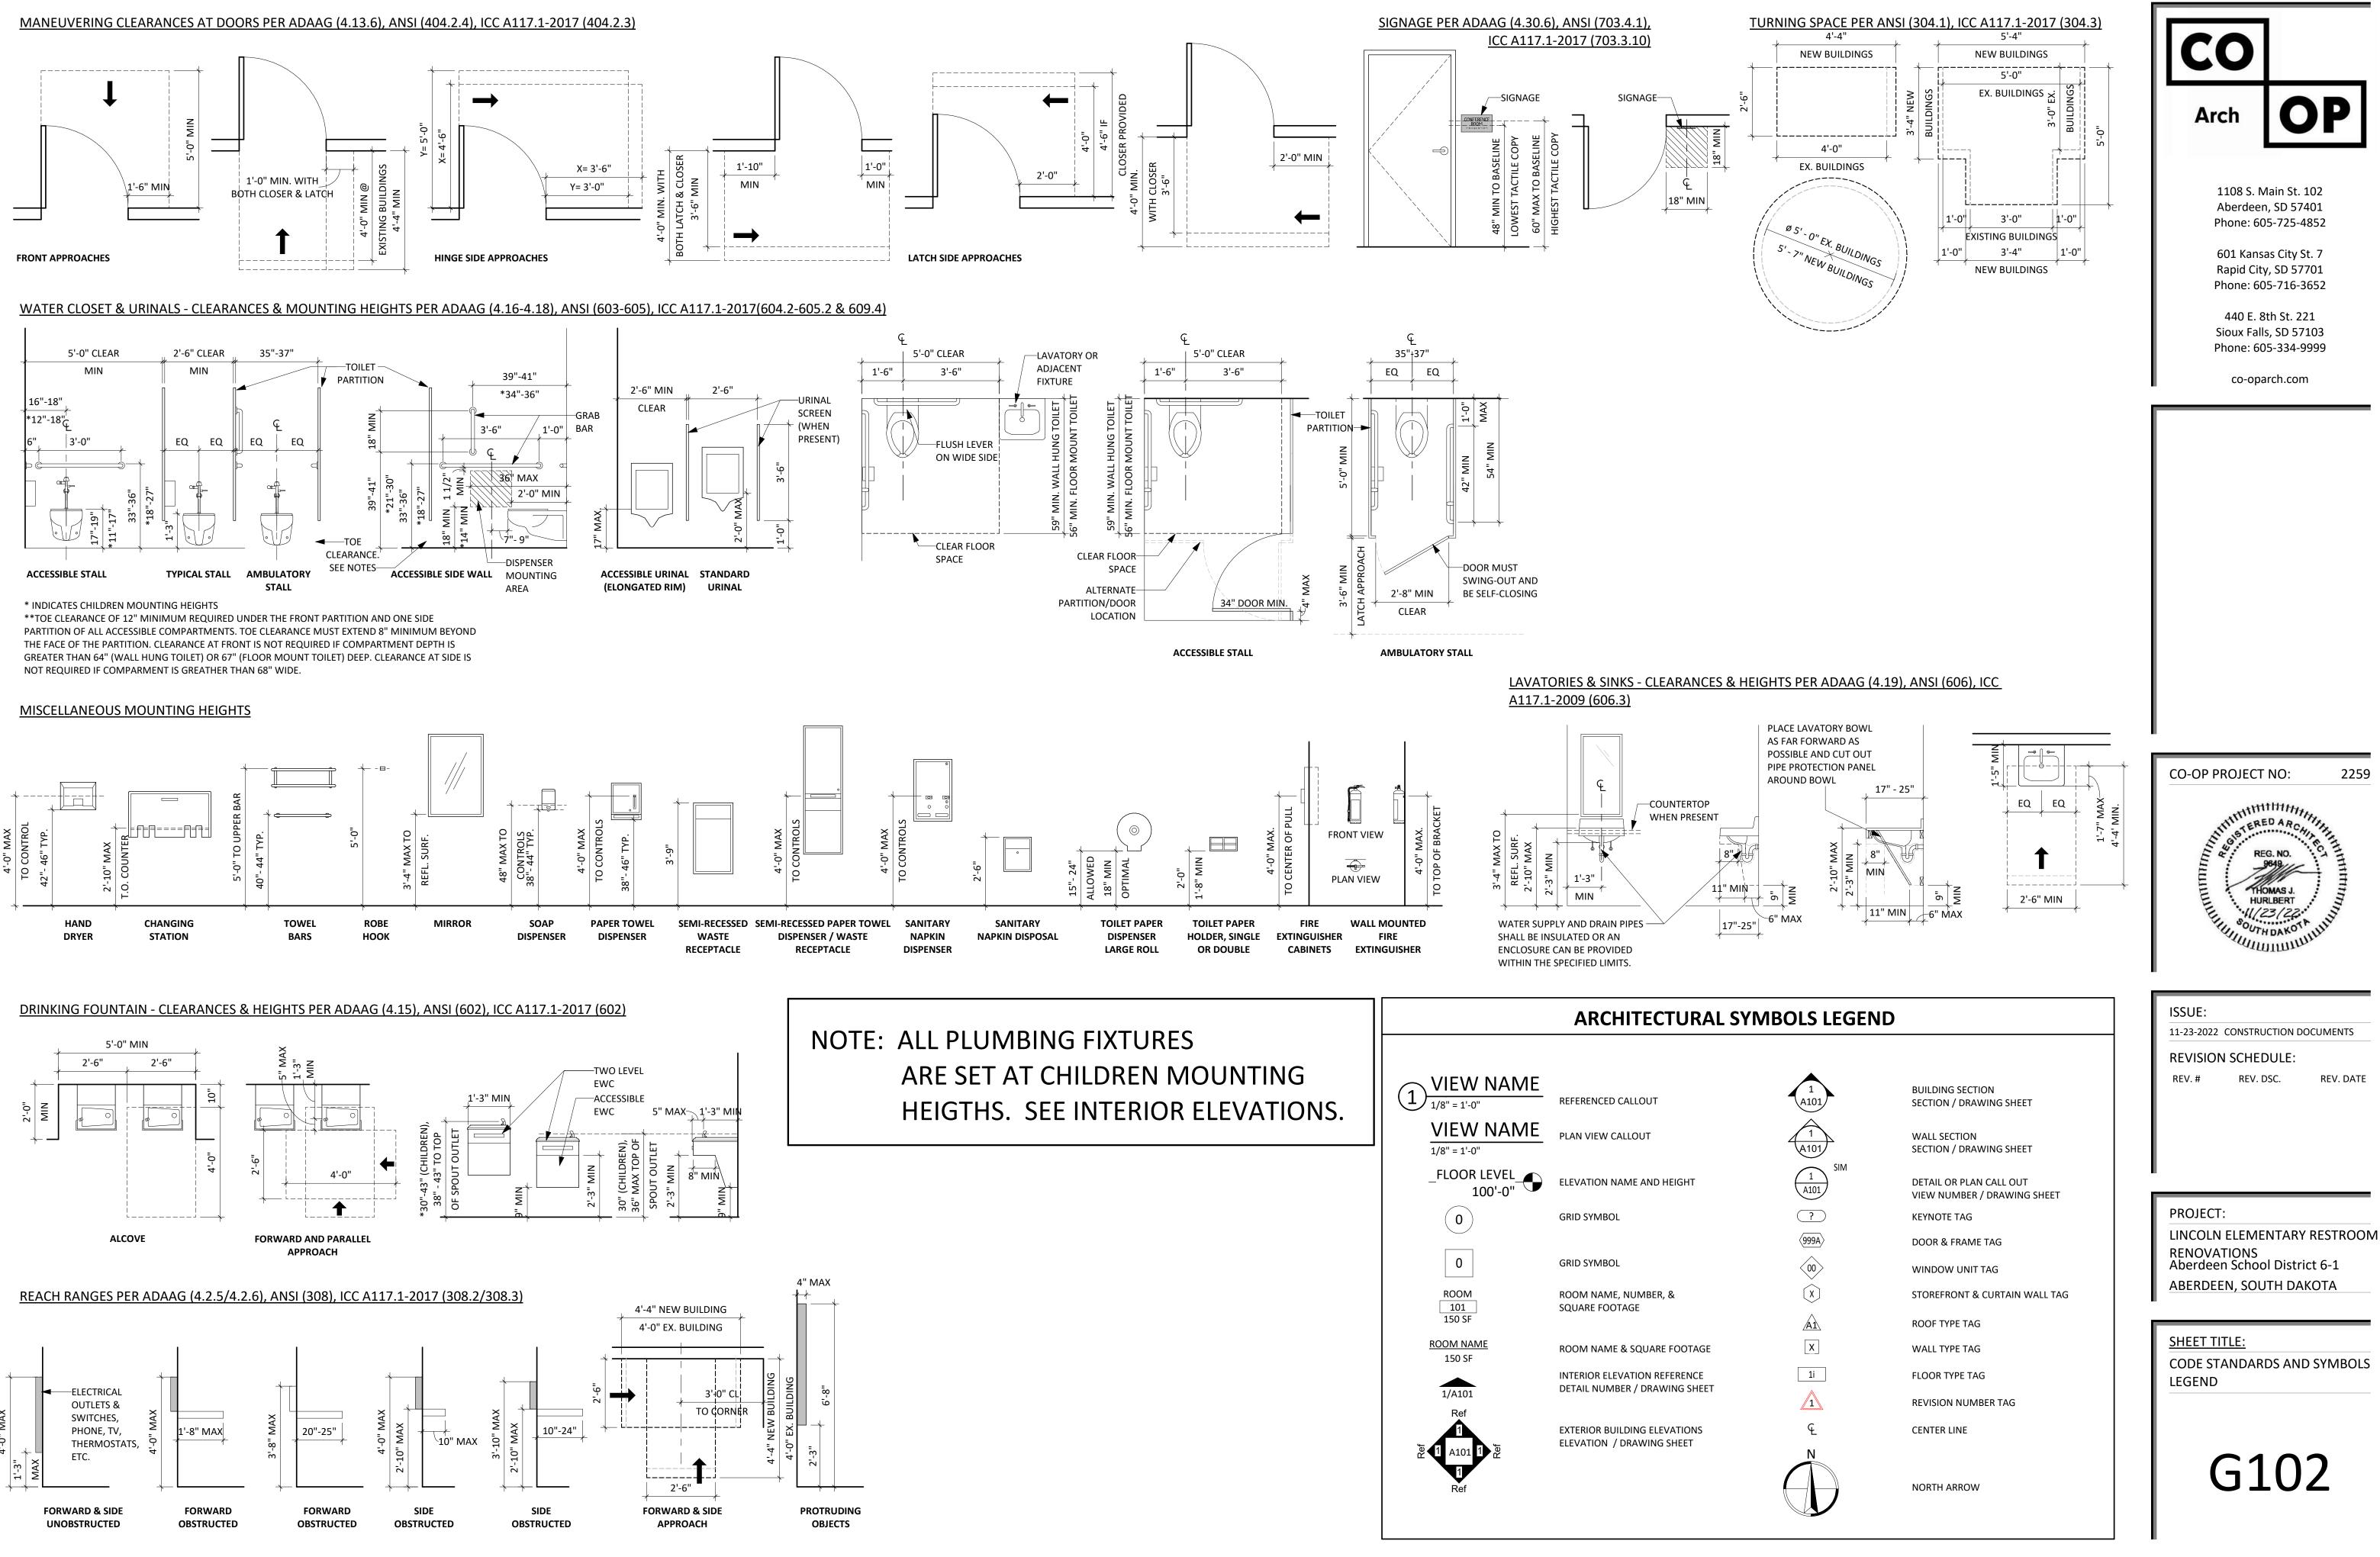

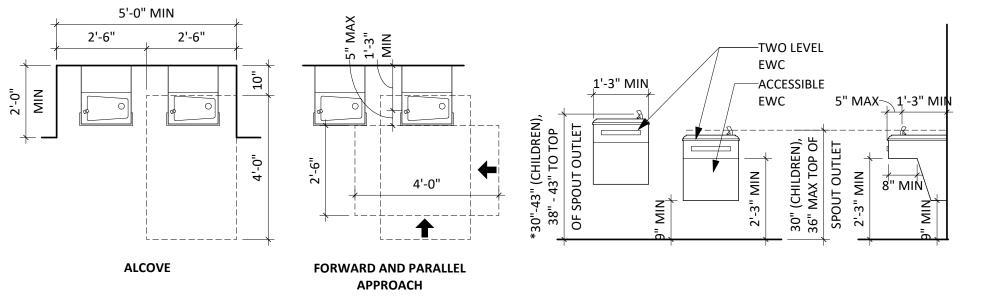


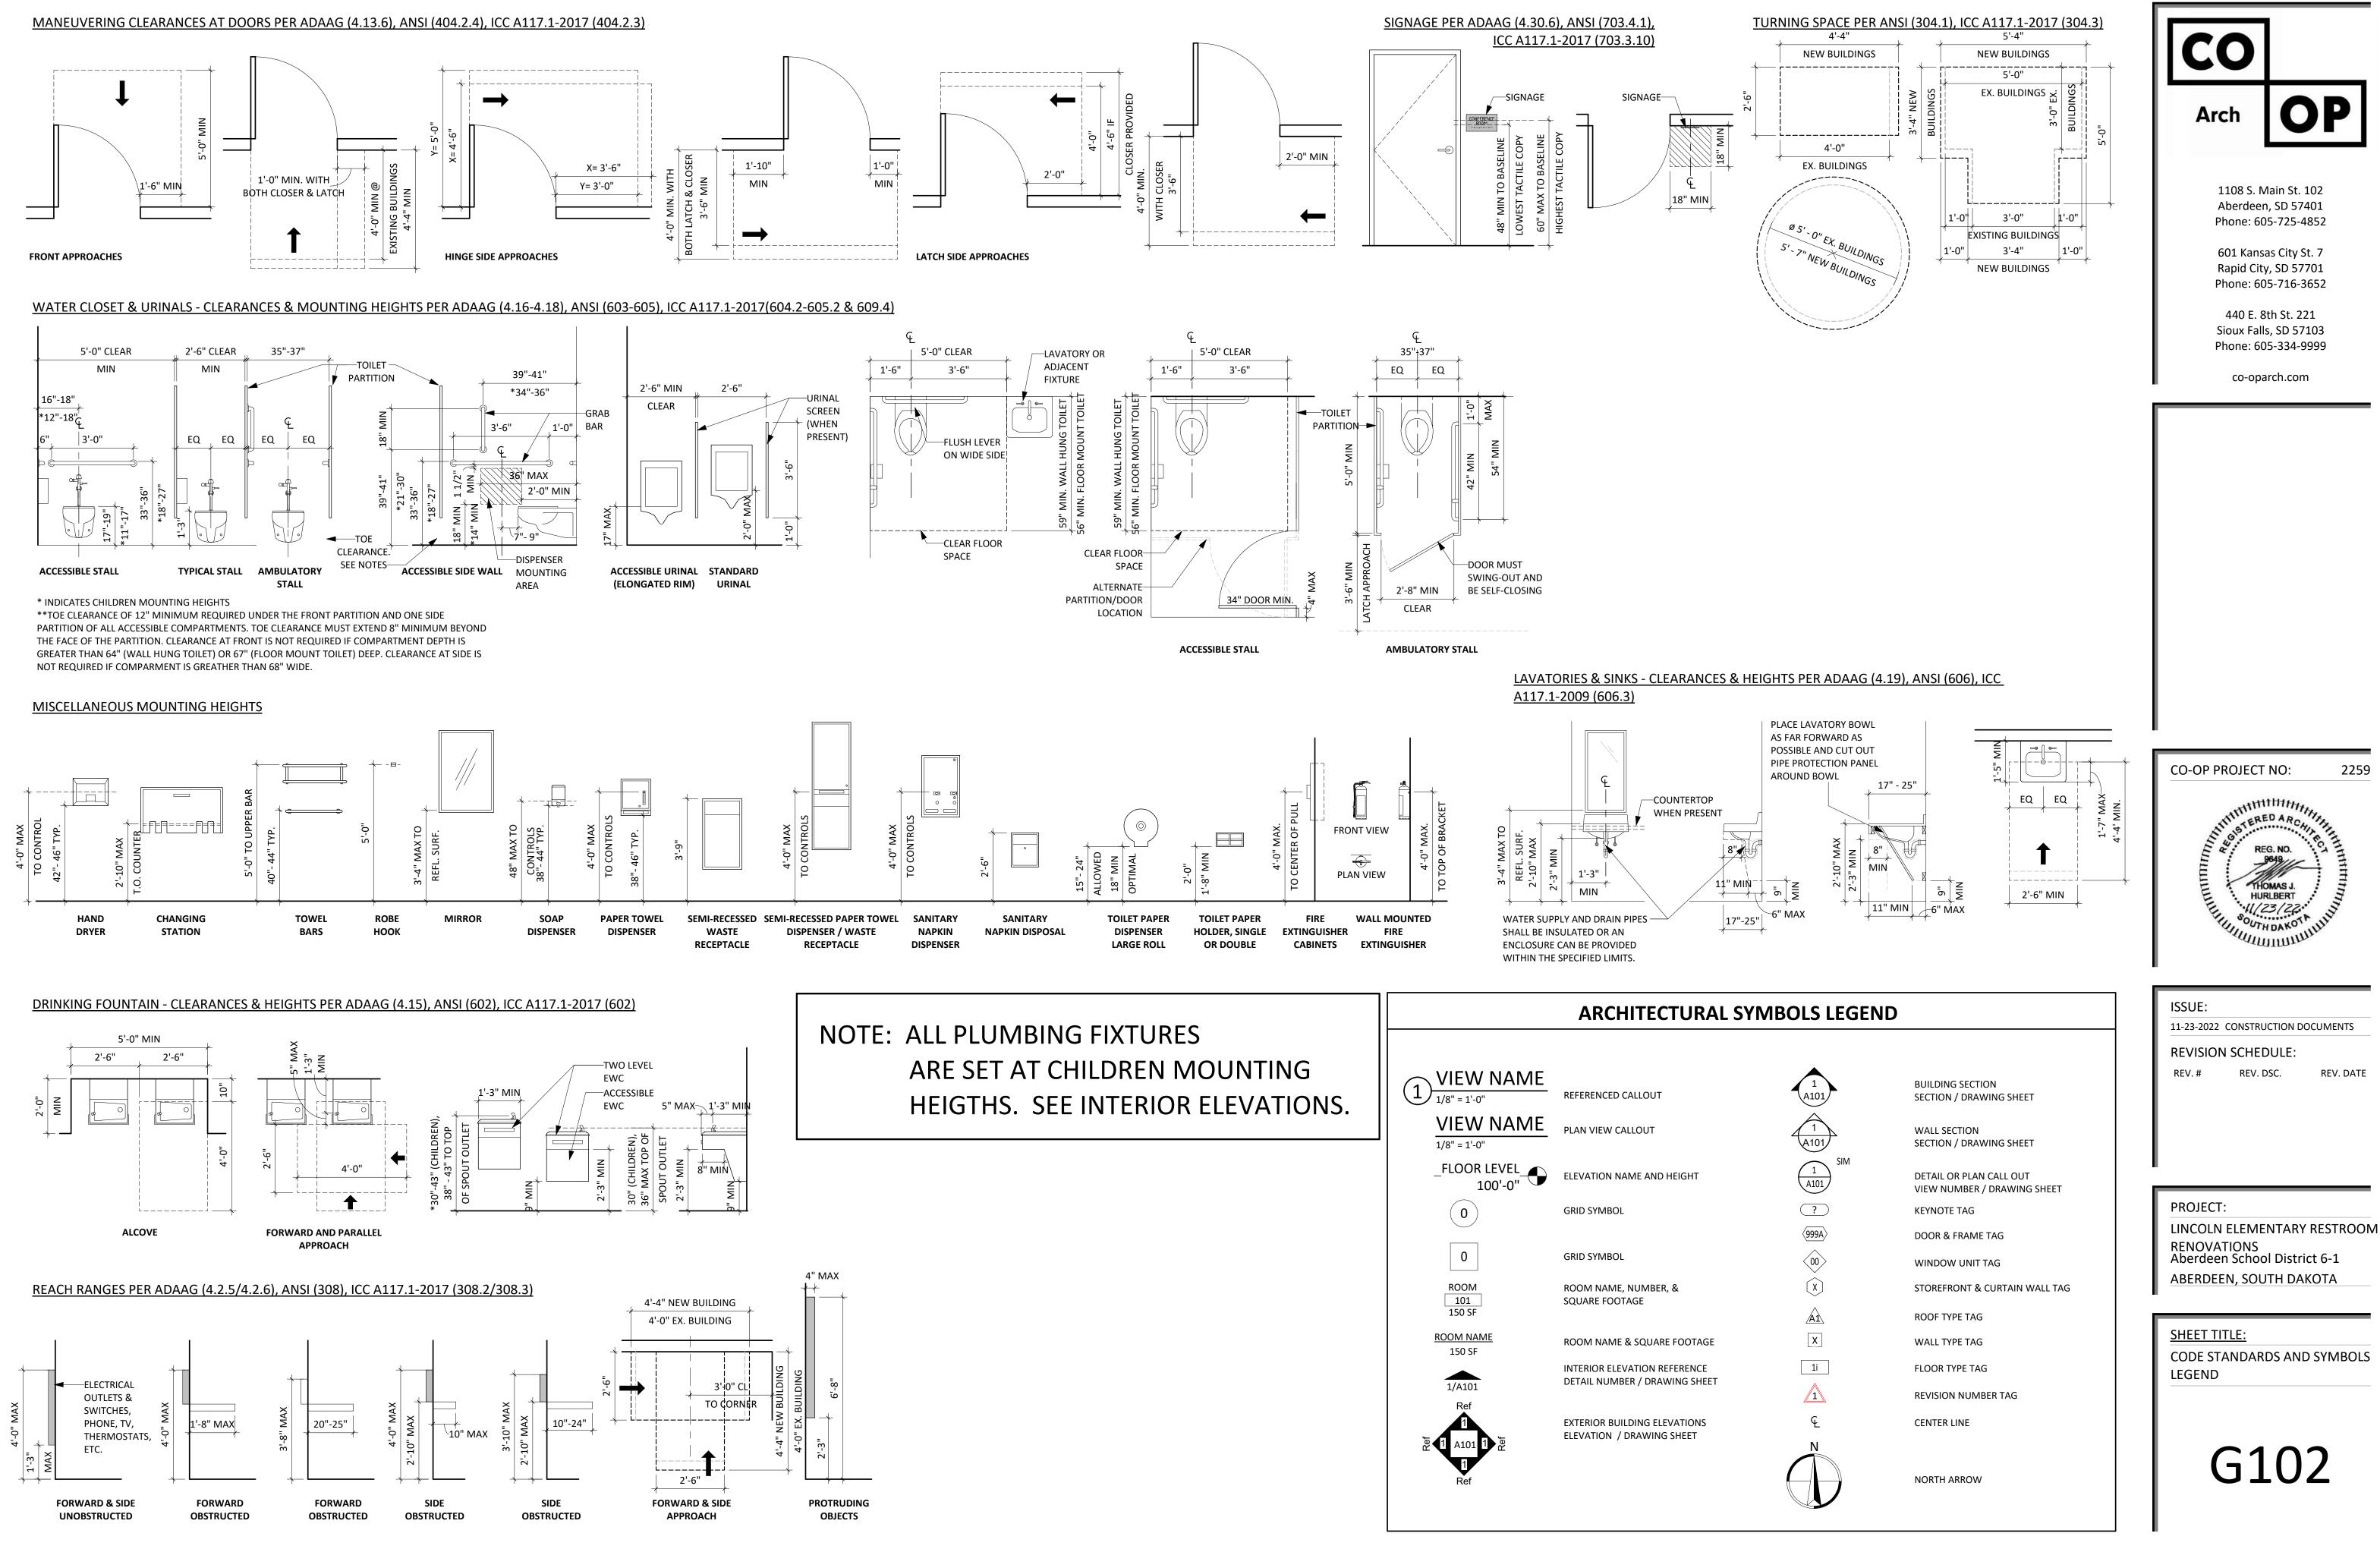

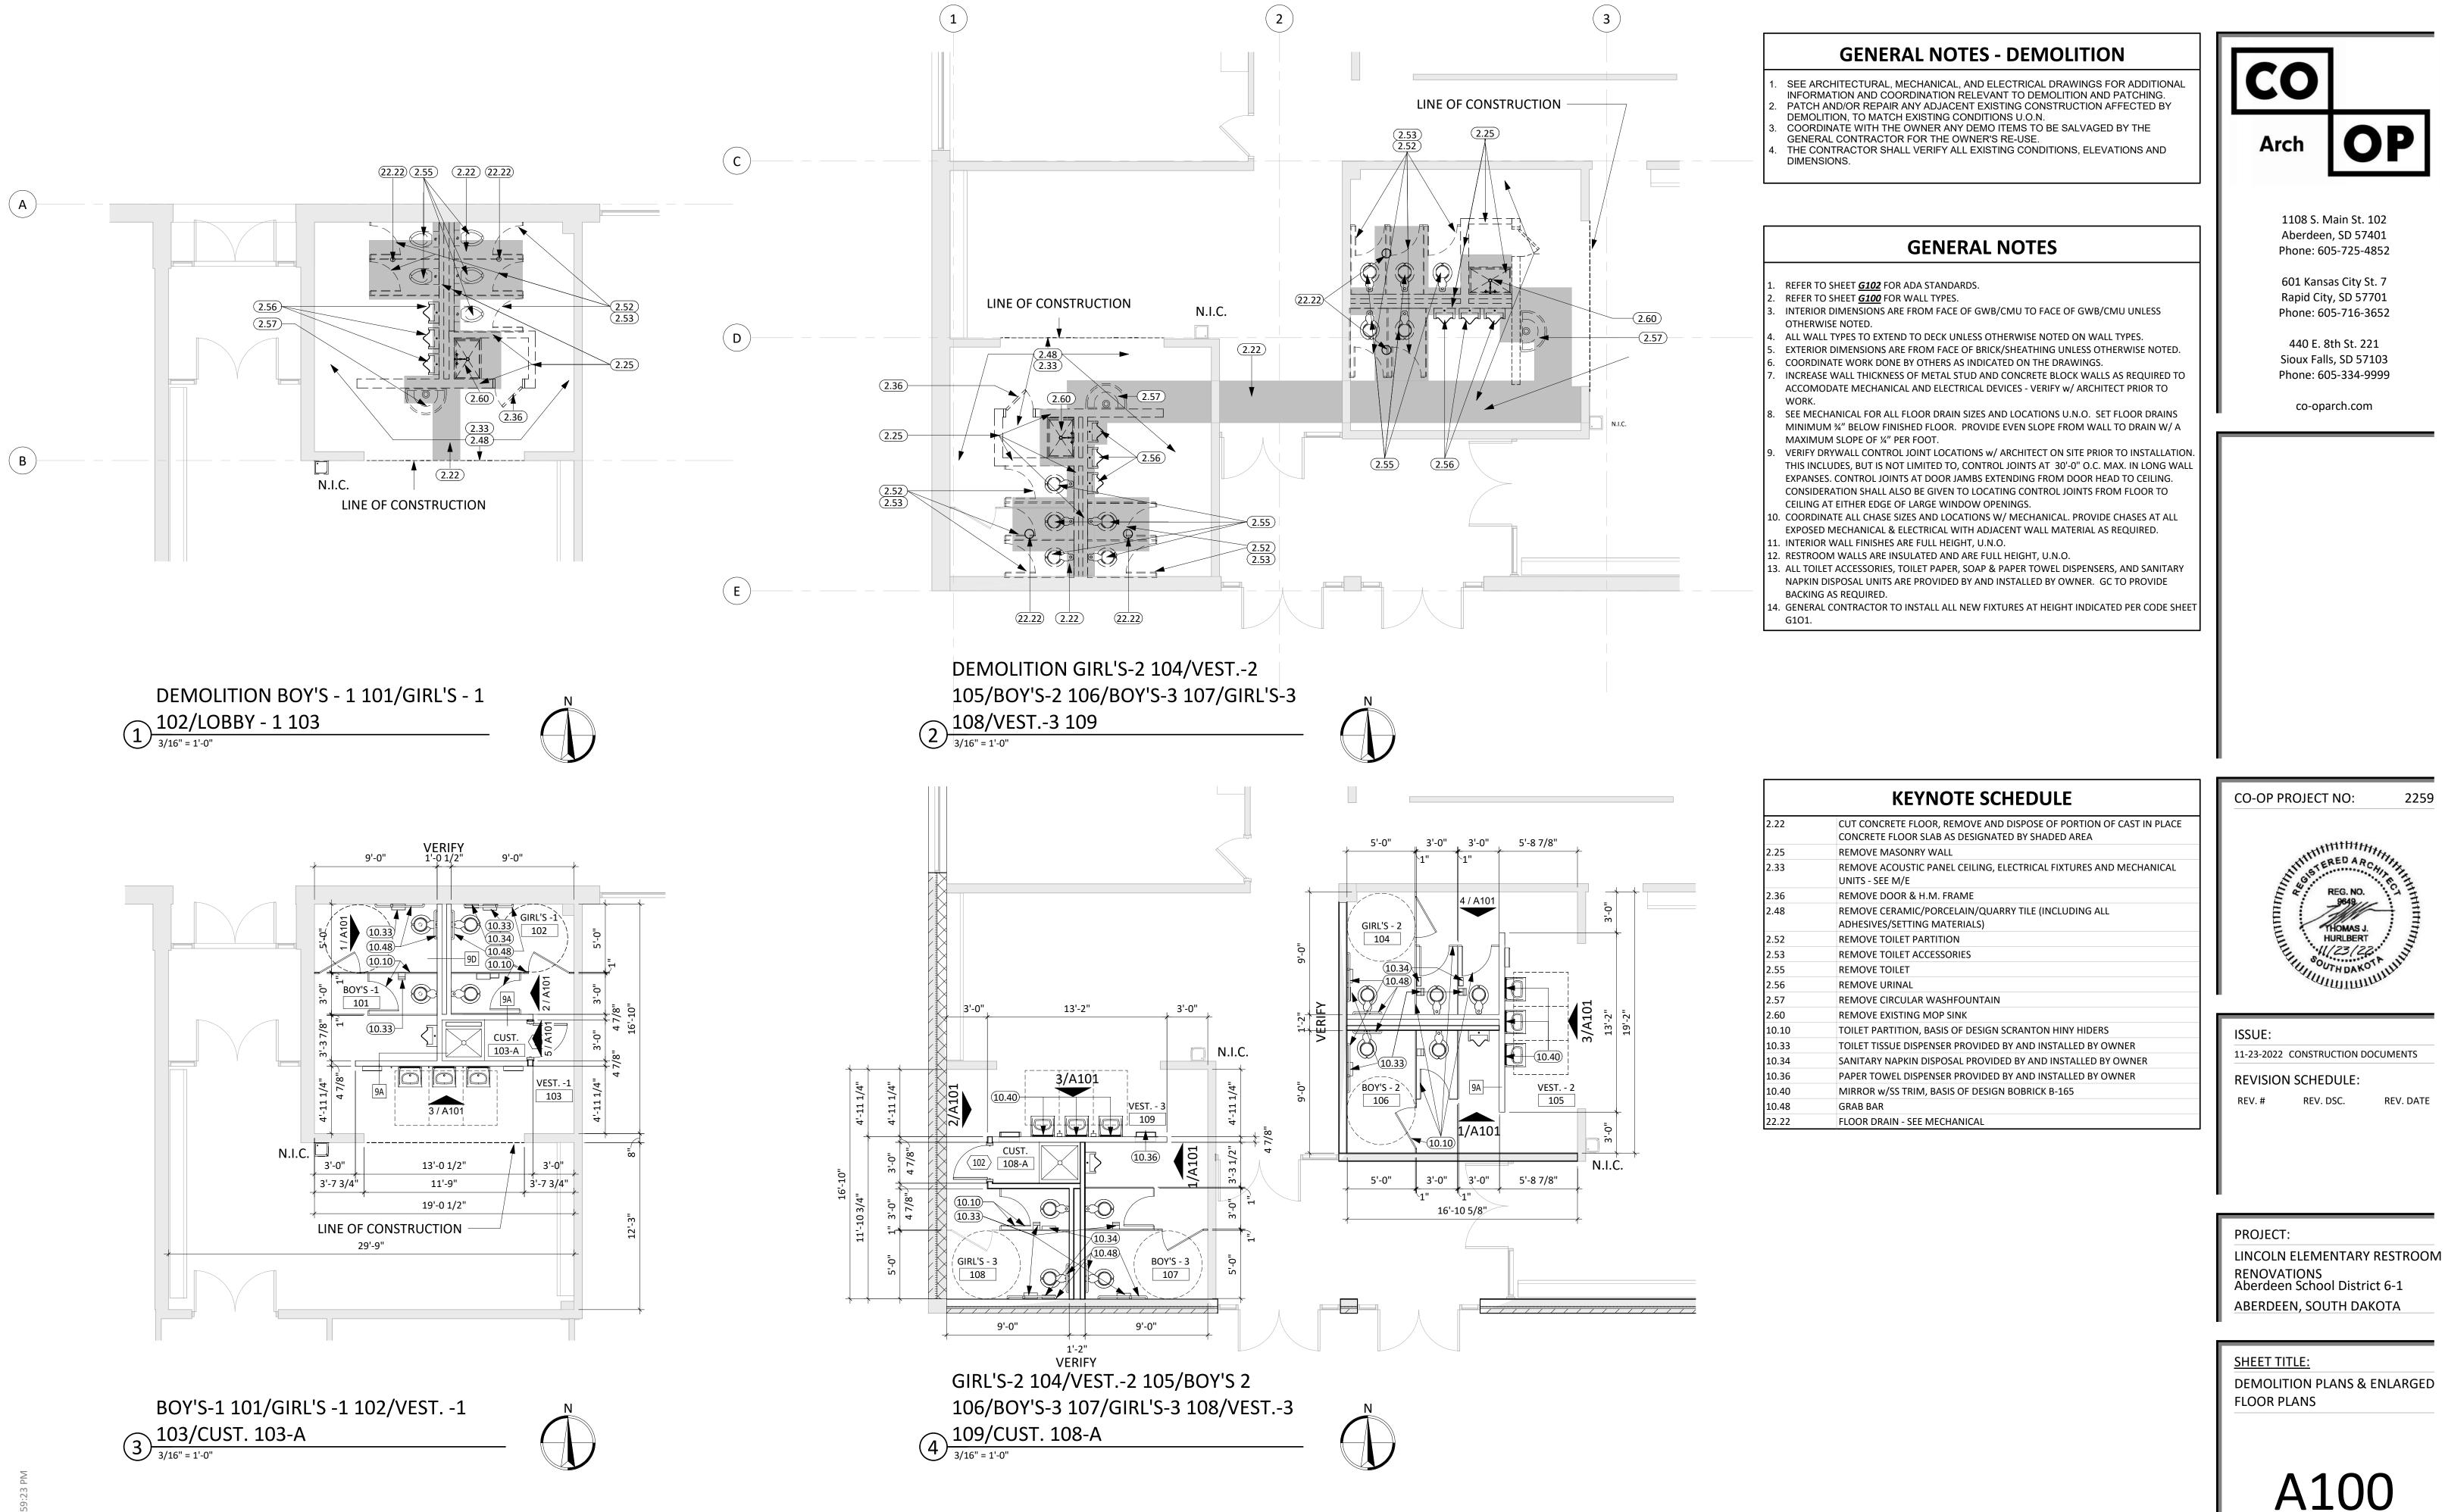

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SCHULUTER DILES WALL TRANSITION-TYP.

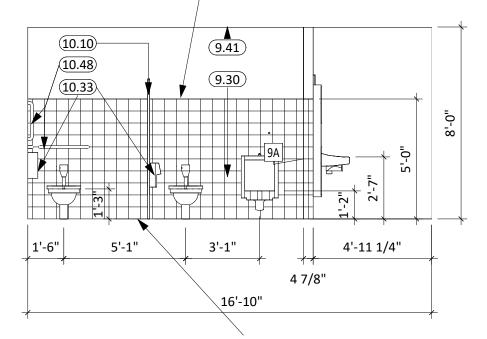

SCHULUTER DILES WALL TO FLOOR TRANSITION-TYP.

9.30 (10.50) (22.18) 3'-0" 1'-6" 3" 4 7/8" 4'-11 1/4" 5'-1" 1'-6" 4 7/8" 16'-10"

9.41

- 9D -

10.48

BOY'S-1 101 EAST/BOY'S -2 106 1 SOUTH/BOY'S-3 107


GIRL'S-1 102/VEST.-1 103 WEST GIRL'S-3 108 EAST/CUST. 103-A/CUST. 2 108-A 1/4" = 1'-0"


DOOR & FRAME SCHEDULE								
			DOOR			FR	AME	
NO	W	Н	Т	TYPE	MAT'L.	TYPE	MAT'L.	ADDITIONAL NOTES
101	2'-6"	7'-0"	1 3/4"	А	WD	1	HM	PAINT ALL HOLLOW METAL FRAMES
102	2'-6"	7'-0"	1 3/4"	Α	WD	1	HM	PAINT ALL HOLLOW METAL FRAMES


	ROOM FINISH SCHEDULE							
RM#	NAME	FLR FIN.	BASE FIN.	WALL FIN.	CLG FIN.	CLG HT.	NOTES	
101	BOY'S -1	PT-1	CT-1	CT-1/P-1	GWB P-3	8'-0"	5'-0" HIGH WAINSCOT OF CT, PAINT ABOVE	
102	GIRL'S -1	PT-1	CT-1	CT-1/P-1	GWB P-3	8'-0"	5'-0" HIGH WAINSCOT OF CT, PAINT ABOVE	
103	VEST1	PT-1	CT-1	CT-1/P-1	GWB P-3	8'-0"	5'-0" HIGH WAINSCOT OF PT AT WET WALL, PAINT ABOVE	
103-A	CUST.	PT-1	CT-1	FRP/P1	GWB P-3	8'-0"	5'-0" HIGH WAINSCOT OF FRP BOARD AT WALL SIDES OF MOP SINK PAINT ABOVE	
104	GIRL'S - 2	PT-1	CT-1	CT-1/P-1	GWB P-3	8'-0"	5'-0" HIGH WAINSCOT OF CT, PAINT ABOVE	
105	VEST 2	PT-1	CT-1	CT-1/P-1	GWB P-3	8'-0"	5'-0" HIGH WAINSCOT OF PT AT WET WALL, PAINT ABOVE	
106	BOY'S - 2	PT-1	CT-1	CT-1/P-1	GWB P-3	8'-0"	5'-0" HIGH WAINSCOT OF CT, PAINT ABOVE	
107	BOY'S - 3	PT-1	CT-1	CT-1/P-1	GWB P-3	8'-0"	5'-0" HIGH WAINSCOT OF CT, PAINT ABOVE	
108	GIRL'S - 3	PT-1	CT-1	CT-1/P-1	GWB P-3	8'-0"	5'-0" HIGH WAINSCOT OF CT, PAINT ABOVE	
108-A	CUST.	PT-1	CT-1	FRP/P1	GWB P-3	8'-0"	5'-0" HIGH WAINSCOT OF FRP BOARD AT WALL SIDES OF MOP SINK PAINT ABOVE	
109	VEST 3	PT-1	CT-1	CT-1/P-1	GWB P-3	8'-0"	5'-0" HIGH WAINSCOT OF CT, PAINT ABOVE	

NOTE: NO CT ON EXISTING CMU WALLS/PAINT EXISTING CMU


					FINISH LEGE	ND		
ΤΥΡΕ	MARK	MANUFACTURER	STYLE	COLOR	STYLE/COLOR NO.	SIZE	INSTALL	NOTES
LOORING & T	TILING							
CERAMIC &	PT-1	AMERICAN OLEAN	UNGLAZED MOSAICS	SALT & PEPPER	OA12	2" X 2"	STACKED BOND	FLOOR TILE USE 2/ GRT-1
PAINT & WALL	COVERIN	GS						
	P-1	SHERWIN WILLIAMS	PERMACRYL INTERIOR	NAVAJO WHITE	SW 6126			SEMI GLOSS
PAINT	P-2	SHERWIN WILLIAMS	PROMAR 200 INTER	BLACK FOX	SW 7020			HOLLOW METAL DOOR FRAMES - SEMI GLOSS
	P-3	SHERWIN WILLIAMS	ELEVATE INTER	EXTRA WHITE	SW 7006			RESTROOM CEILING PAINT
VALL BASE, TI	RANSITION	IS & MISC. TRIMS						
	CT-1	DAHLTILE	MATTE WALL GLAZED	ARTIC WHITE	0790	6" X 6"	STACKED BOND	
SCHLUTER		SCHLUTER		SATIN ANODIZED	AE			
AISCELLANEO	US							
PARTITIONS	TP	SCRANTON	HINY HIDERS	TBD				FLOOR MOUNTED, OVERHEAD BRACED

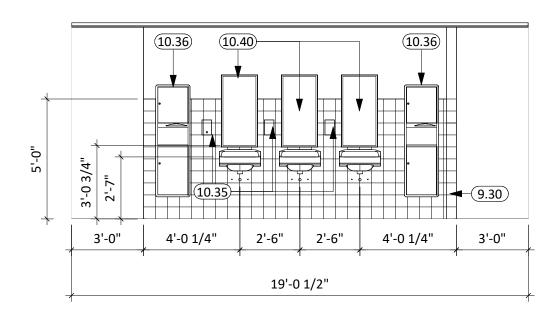


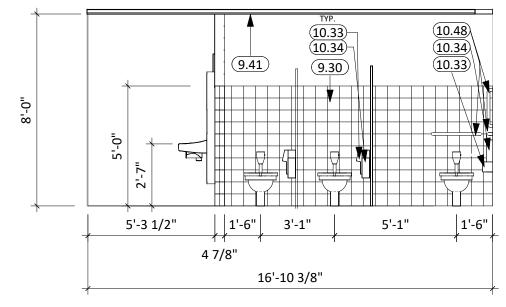

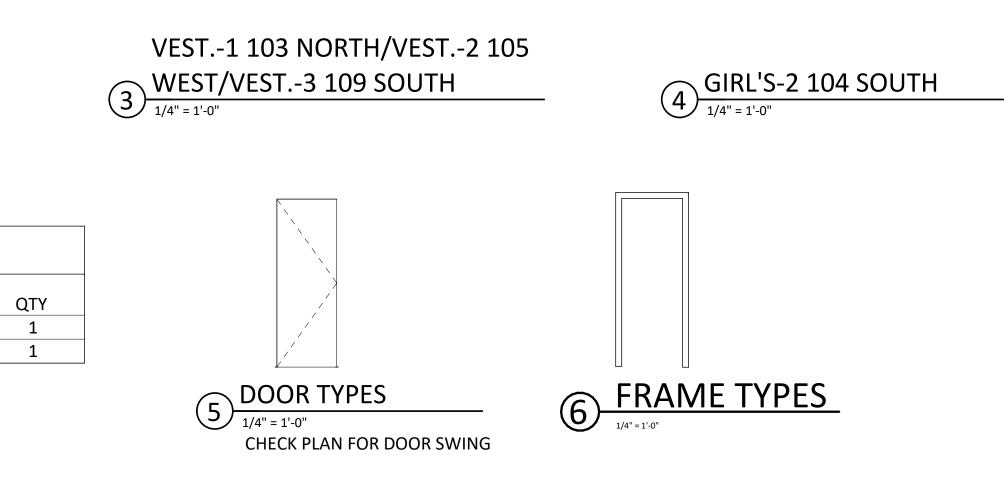


	KEYN
6.01	2x WOOD STUD FRAMING @ 16" O.C. (
7.20	BATT INSULATION
8.01	DOOR (SEE SCHED.)
8.02	FRAME (SEE SCHED.)
9.01	GYPSUM SHAFT WALL
9.06	1/2" RESILIENT SOUND CHANNEL
9.30	CERAMIC TILE
9.41	ACOUSTICAL TILE CEILINGS SYSTEM (CC
10.10	TOILET PARTITION, BASIS OF DESIGN SC
10.33	TOILET TISSUE DISPENSER PROVIDED B
10.34	SANITARY NAPKIN DISPOSAL PROVIDED
10.35	SOAP DISPENSER PROVIDED BY AND IN
10.36	PAPER TOWEL DISPENSER PROVIDED B
10.40	MIRROR w/SS TRIM, BASIS OF DESIGN
10.48	GRAB BAR
10.50	MOP & BROOM HOLDER
22.18	MOP SINK - SEE M/E

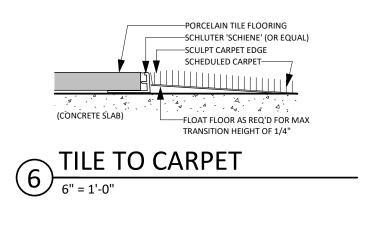

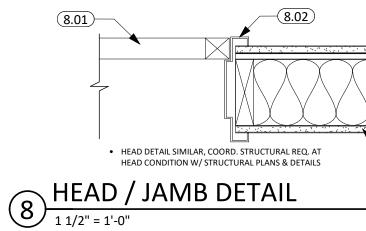

	COArchOP1108 S. Main St. 102Aberdeen, SD 57401Phone: 605-725-4852601 Kansas City St. 7Rapid City, SD 57701
	co-oparch.com
NOTE SCHEDULE (SEE PLAN) COORD. w/ MECH. & ELEC. FOR FIXTURE REQ./LOCATIONS) SCRANTON HINY HIDERS BY AND INSTALLED BY OWNER	CO-OP PROJECT NO: 2259
ED BY AND INSTALLED BY OWNER NSTALLED BY OWNER BY AND INSTALLED BY OWNER I BOBRICK B-165	ISSUE: 11-23-2022 CONSTRUCTION DOCUMENTS REVISION SCHEDULE: REV. # REV. DSC. REV. DATE
WALL TILE OR TILE BASE SCHLUTER 'DILEX-AHK' (OR EQUAL) PORCELAIN TILE FLOORING (CONCRETE SLAB) TILE FLOOR TO WALL 6" = 1'-0"	PROJECT: LINCOLN ELEMENTARY RESTROOM RENOVATIONS Aberdeen School District 6-1 ABERDEEN, SOUTH DAKOTA
9.01 9.06 6.01 7.20 9.01	SHEET TITLE: INTERIOR ELEVATIONS, ROOM FINISH SCHEDULE, FINISH LEGEND, MISC. DETAILS A101

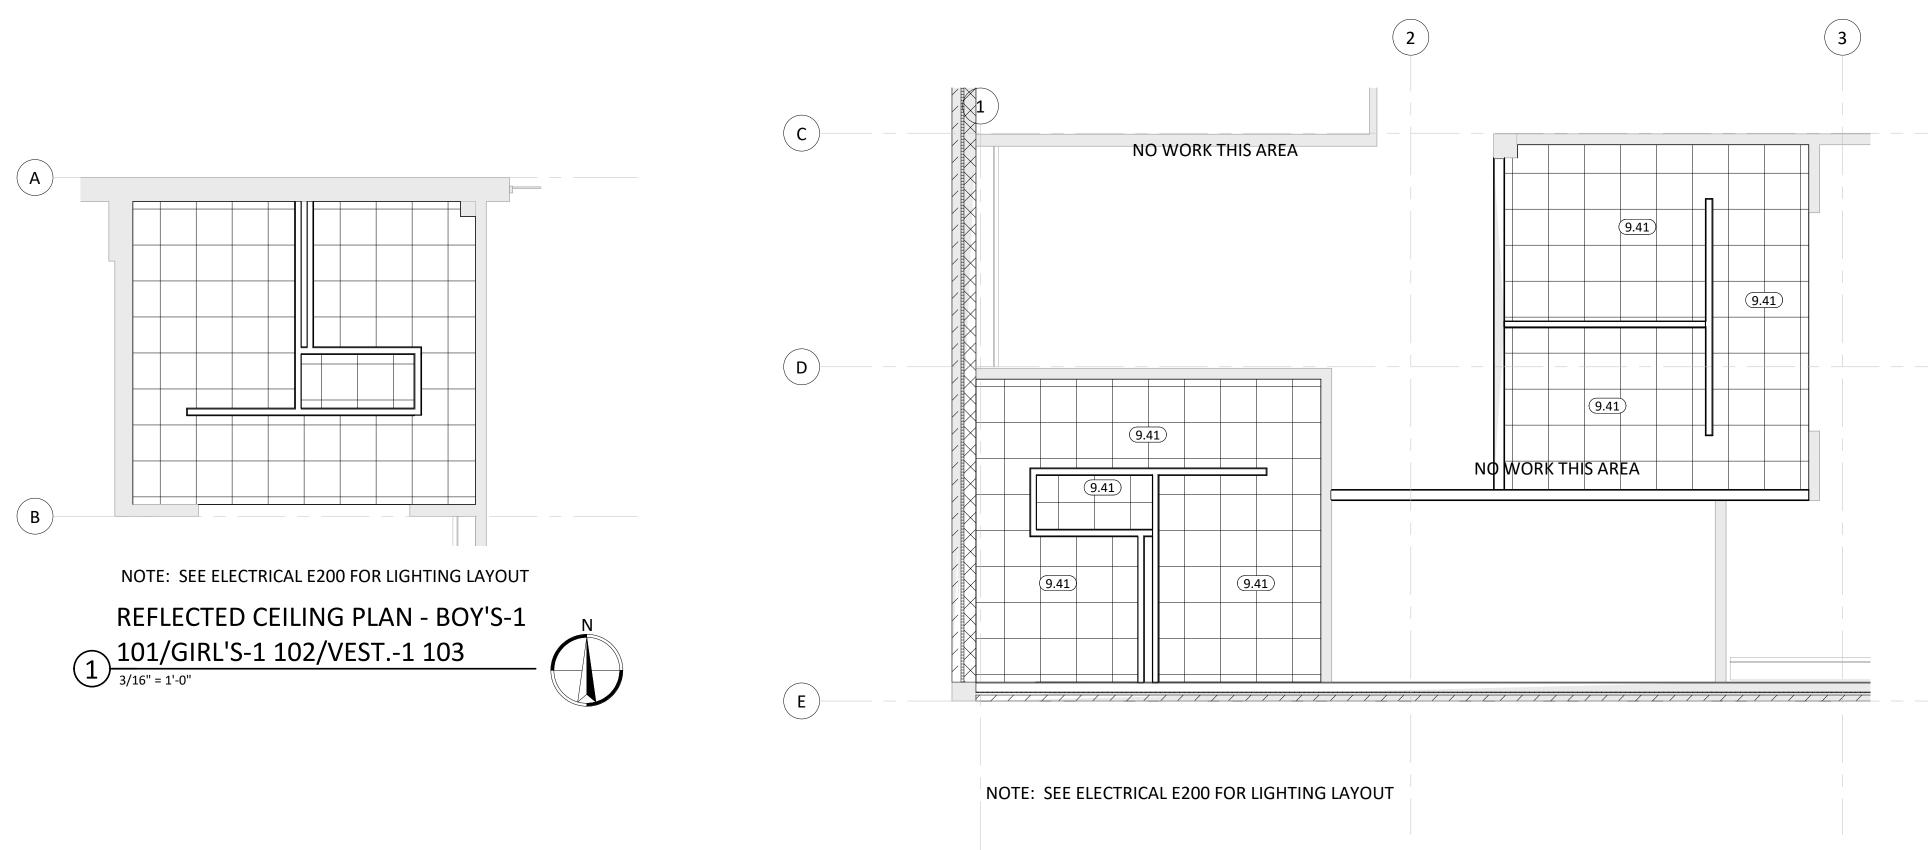








1.	ALL DIMENS
2.	REFER TO SE
3.	PROVIDE AC
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6.	PROVIDE W
	WALLS EXPO
7.	VERIFY FINA
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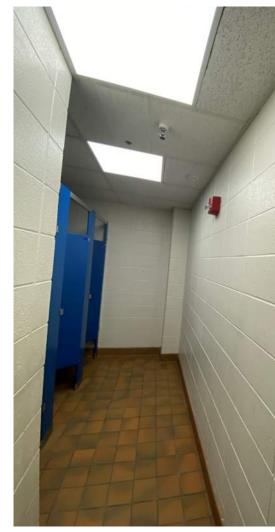
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REFLECTED CEILING PLAN - GIRL'S-2 1104/VEST.-2 105/BOY'S-2 106/BOBOY'S-3 107/GIRL'S-3 2 108VVEST-3 109 3/16" = 1'-0"







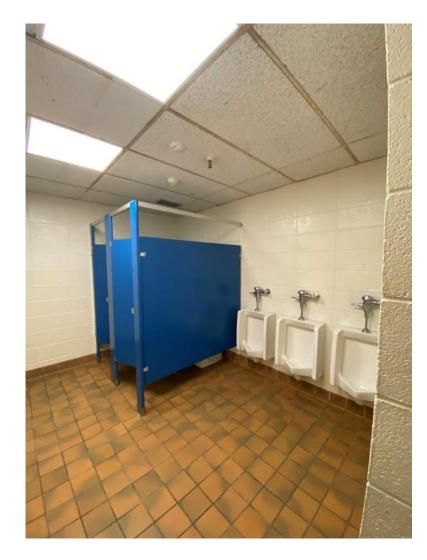

GENERAL NOTES

ISIONS ARE FROM FACE OF FINISH MATERIAL UNLESS OTHERWISE NOTED. SPECIFICATIONS FOR CEILING AND FIXTURE SUSPENSION REQUIREMENTS. ACCESS DOORS AT MECHANICAL UNIT LOCATIONS ABOVE CEILING. COORDINATE REQUIRED AND LOCATIONS WITH MECHANICAL SHEET GHT FIXTURES BETWEEN WALLS AND/OR CEILING BULKHEADS UNLESS OTHERWISE NED.


CTED CEILING PLANS ARE INTENDED TO AID IN COORDINATION ONLY AND ARE NOT TO BE COMPREHENSIVE. SEE MECHANICAL AND ELECTRICAL DRAWINGS FOR L INFORMATION. NOTIFY ARCHITECT WHERE CONFLICTS OCCUR.

VATER-RESISTANT GYPSUM BOARD PANELS AT ALL BATHROOM WALLS AND ANY POSED TO MOISTURE.

AL LOCATION OF ROOF HATCH WITH EXISTING CONDITIONS AND M/E CONTRACTOR DRAWINGS.


KEYNOTE SCHEDULE

ACOUSTICAL TILE CEILINGS SYSTEM (COORD. w/ MECH. & ELEC. FOR FIXTURE **REQ./LOCATIONS)**

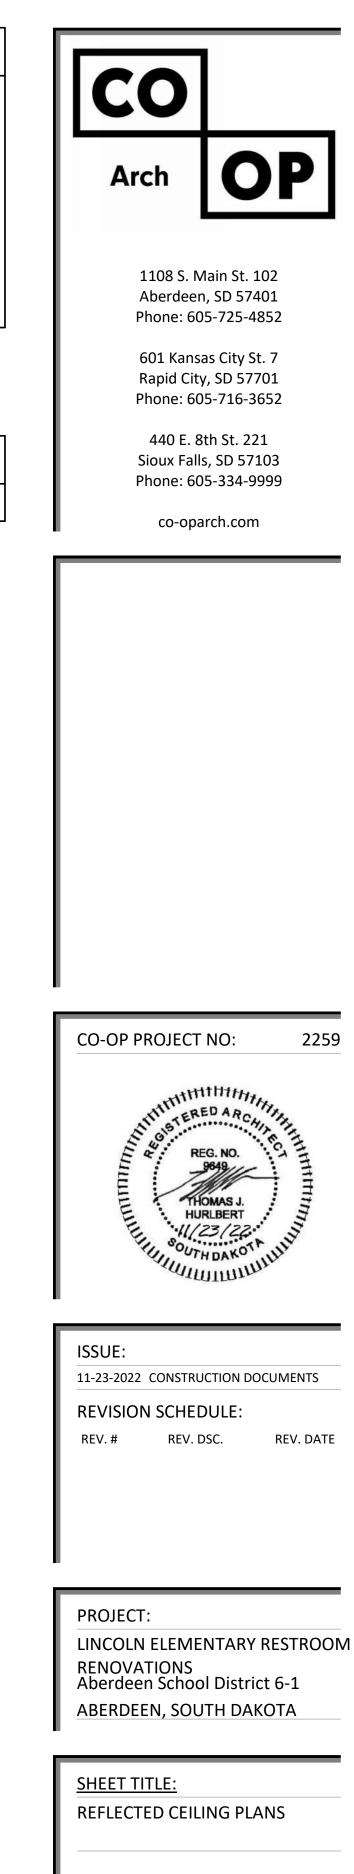

A102



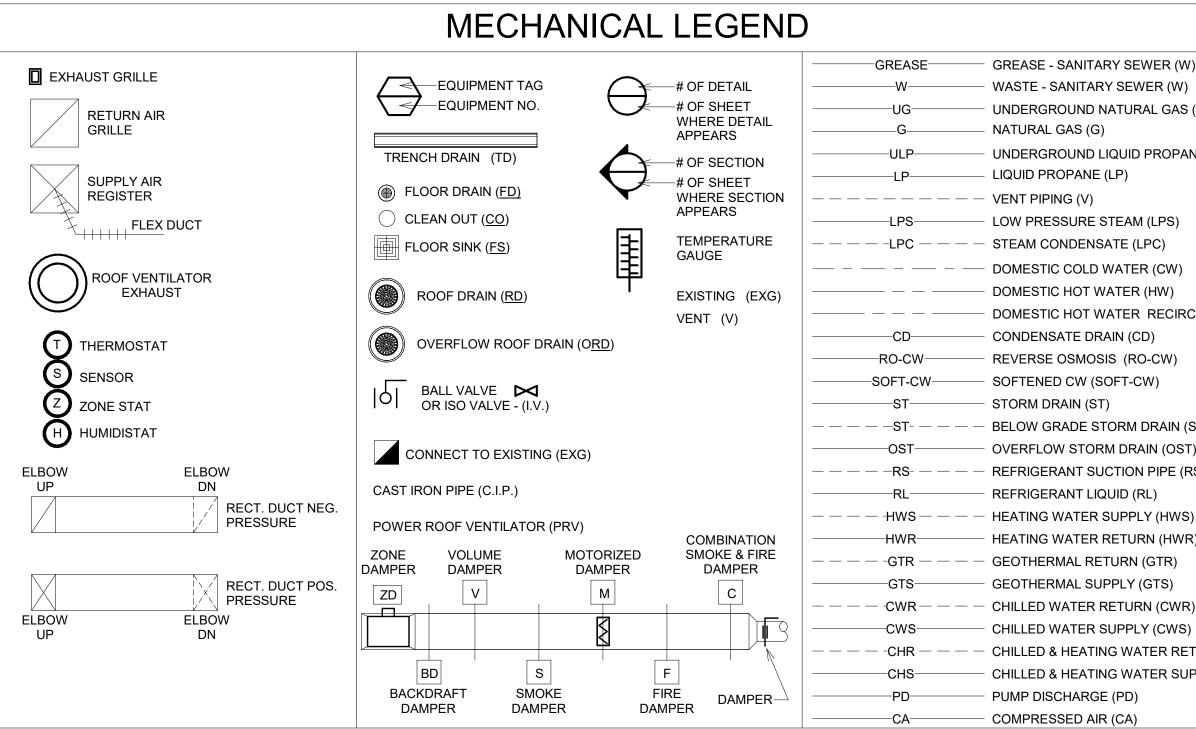

		EL	ECTRICAL LEGEND		
SYMBOL	DESCRIPTION	SYMBOL	DESCRIPTION	SYMBOL	
\$	SINGLE POLE SWITCH	##	LIGHTING FIXTURE E = EMERGENCY BALLAST	•	SMOKE DETECT
\$3 \$4	THREE WAY SWITCH FOUR WAY SWITCH		NL = NIGHT LIGHT ## = FIXTURE ID TAG a,b = CNTRL/RELAY ID TAG	M	MANUAL PULL S
^{\$} LV	LOW VOLTAGE PUSH BUTTON SWITCH		UNDER CABINET FIXTURE	XX DOH	HORN/STROBE
^{\$} D ^{\$} т	DIMMER SWITCH	.ф.	WALL MOUNTED FIXTURE	XX 🖂	STROBE ONLY X
т \$о	OCCUPANCY SENSOR	\bigcirc	RECESSED FIXTURE	ANNC	FIRE ALARM CON
^{\$} Р	PILOT LIGHT SWITCH		PHOTO CONTROL	TS	TAMPER SWITCH
^{\$} к	KEYED SWITCH		SECURITY CAMERA	FS	FLOW SWITCH
^{\$} F OS1	VARIABLE SPEED FAN SWITCH OCCUPANCY SENSOR - CEILING MOUNTED	S	WALL SPEAKER	BT	BEAM TRANSMIT
	POWER PACK FOR LOW VOLTAGE OCCUPANCY SENSOR	8	EXIT FIXTURE EMERGENCY WALL PACK	REC	BEAM RECEIVER
P	DUPLEX RECEPTACLE	C –	CLOCK	MD	MOTORIZED DAM
•	GROUND FAULT CIRCUIT INTERRUPTER DUPLEX RECEPTACLE	Ν	NURSE CALL PULL STATION	DSD	DUCT SMOKE DE
⊕D1	DROP CORD RECEPTACLE (SEE DETAILS)		NURSE CALL DUTY STATION	DS	DOOR STRIKE
₽ ⊕	250V 4-WIRE RECEPTACLE DOUBLE DUPLEX RECEPTACLE		NURSE CALL CORRIDOR LIGHT	CR	CARD READER/k
•	TOP SWITCHED DUPLEX RECEPTACLE		THERMOSTAT		DISCONNECT (F
٢	SPECIAL OUTLET	S	INTERCOM SPEAKER		COMBINATION S
×x ▼	DATA/PHONE OUTLET XX INDICATES NO. OF JACKS	H	INTERCOM CALL STATION	R 4	RELAY CONNECT TO EX
54" ▽	WALL PHONE OUTLET	L	JUNCTION BOX	VFD	VARIABLE FREQ
	CEILING DATA/PHONE OUTLET	TC	TIME CLOCK VOLUME CONTROL	WG	WIRE GUARD
Ø◀	FLOOR BOX WITH POWER AND DATA	T	TRANSFORMER	WP AC	WEATHER PROO ABOVE COUNTEI
	FLOOR BOX WITH POWER ONLY		CABLE TV - ONE CAT6 & ONE COAX CABLE	UC	UNDER COUNTE
^{\$} м	MANUAL MOTOR STARTER	DH	DOOR HOLDER	UPS EXG	UNINTERRUPTIB
()	MOTOR CONNECTION			EAG	

GREASE - SANITARY SEWER (W) WASTE - SANITARY SEWER (W) UNDERGROUND NATURAL GAS (UG) NATURAL GAS (G) UNDERGROUND LIQUID PROPANE (ULP) LIQUID PROPANE (LP) LOW PRESSURE STEAM (LPS) --- STEAM CONDENSATE (LPC) DOMESTIC COLD WATER (CW) DOMESTIC HOT WATER (HW) DOMESTIC HOT WATER RECIRC (DHWR) CONDENSATE DRAIN (CD) REVERSE OSMOSIS (RO-CW) - SOFTENED CW (SOFT-CW) STORM DRAIN (ST) BELOW GRADE STORM DRAIN (ST) OVERFLOW STORM DRAIN (OST) REFRIGERANT SUCTION PIPE (RS) REFRIGERANT LIQUID (RL) HEATING WATER SUPPLY (HWS) HEATING WATER RETURN (HWR) ———— GEOTHERMAL RETURN (GTR)

GEOTHERMAL SUPPLY (GTS) CHILLED WATER RETURN (CWR)

- CHILLED & HEATING WATER RETURN (CHR)
- CHILLED & HEATING WATER SUPPLY (CHS) PUMP DISCHARGE (PD)
- COMPRESSED AIR (CA)
 - DESCRIPTION
 - TOR
 - OR (FT = FIXED TEMPERATURE)
 - STATION

 - XX CANDELA RATING
 - XX CANDELA RATING
 - ONTROL PANEL
 - NNUNCIATOR PANEL
 - СН
 - **1ITTER**

 - AMPER
 - DETECTOR

 - R/KEYPAD
 - (F = FUSED)
 - I STARTER
 - EXISTING
 - EQUENCY DRIVE
 - OF

 - ER
 - IBLE POWER SUPPLY

LINCOLN ELEMENTARY **RESTROOM RENOVATIONS ABERDEEN SCHOOL DISTRICT ABERDEEN, SOUTH DAKOTA**

SPECIAL NOTES:

- 1. HVAC CONTRACTOR TO INCLUDE ALL TEMPERATURE CONTROL WORK NEEDED AND WORK TO BE DONE BY: JOHNSON CONTROLS, CONTACT GREG HINTGEN @ PHONE 605-362-5315.
- 2. IN AREAS WHERE EXISTING CEILINGS ARE TO REMAIN, EACH TRADE SHALL BE RESPONSIBLE FOR ANY DAMAGE OR REPAIR NEEDED TO EXISTING CEILINGS AS A RESULT OF THEIR WORK.
- 3. PC, VC, EC, OR TC TO BE RESPONSIBLE FOR CUTTING AND PATCHING AS NECESSARY TO ALLOW FOR COMPLETION OF THEIR WORK.
- 4. GLYCOL SOLUTION:

a. THE EXISTING GLYCOL SOLUTION IS 30% ETHYLENE GLYCOL USING DOWTHERM SR-1. ANY NEW GLYCOL NEEDED FOR THE PROJECT SHALL BE DOWTHERM SR-1.

b. THE PLUMBING/HYDRONICS CONTRACTOR SHALL PROVIDE INDEPENDENT ANALYSIS OF EXISTING HYDRONICS SOLUTION PRIOR TO PROPOSED WORK TO DETERMINE EXACT GLYCOL AND COMPOSITION, ETC. · SUBMIT ANALYSIS/RECOMMENDATIONS TO SICHMELLER ENGINEERING &

OWNER. · THIS CONTRACTOR SHALL BE RESPONSIBLE FOR PUMPING IN ANY ADJUSTMENTS PROVIDED BY THE OWNER PRIOR TO BEGINNING ANY WORK ON

THE SYSTEM. c. THE PLUMBING/HYDRONICS CONTRACTOR SHALL BE RESPONSIBLE FOR

DRAINING AND STORING THE CURRENT GLYCOL SOLUTION AND BE RESPONSIBLE FOR CLEANING AND FLUSHING THE NEW SYSTEM PIPING. UPON COMPLETION OF THE SYSTEM FLUSHING, THE HEATING/CHILLED SYSTEM GLYCOL SOLUTION SHALL BE PUMPED BACK IN.


d. AFTER PROPOSED WORK IS COMPLETE THE PLUMBING/HYDRONICS CONTRACTOR TO PROVIDE A COMPLETE INDEPENDENT ANALYSIS TO CONFIRM 30% PROPYLENE GLYCOL % AND TREATMENT.

· SUBMIT ANALYSIS/RECOMMENDATIONS TO SICHMELLER ENGINEERING & OWNER.


· PROVIDE RECOMMENDED ADJUSTMENTS AND RETEST AS NECESSARY UNTIL **RESULTS ARE SATISFACTORY**


ME Sheet Number EM100 M200 M300 IF M400 M500 E200

CHANICAL & ELECTRICAL SHEET INDEX
Sheet Name
EGENDS & SHEET INDEX
LUMBING & HYDRONICS DEMOLITION PLAN
PROPOSED PLUMBING & HYDRONICS PLAN
LUMBING FIXTURE SCHEDULE
IVAC & FIRE PROTECTION PLAN
LECTRICAL PLAN

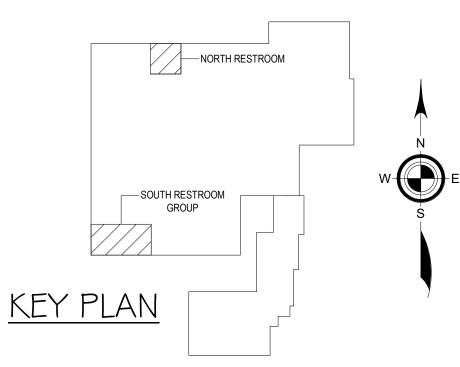


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Aberdeen Phone: 60 601 Kansa Rapid City Phone: 60 440 E. 8 Sioux Falls Phone: 60	1108 S. Main St. 102 Aberdeen, SD 57401 Phone: 605-725-4852 601 Kansas City St. 7 Rapid City, SD 57701 Phone: 605-716-3652 440 E. 8th St 221 Sioux Falls, SD 57103 Phone: 605-334-9999 co-oparch.com					
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<u>SHEET TITLE:</u> LEGENDS & SH	eet index					

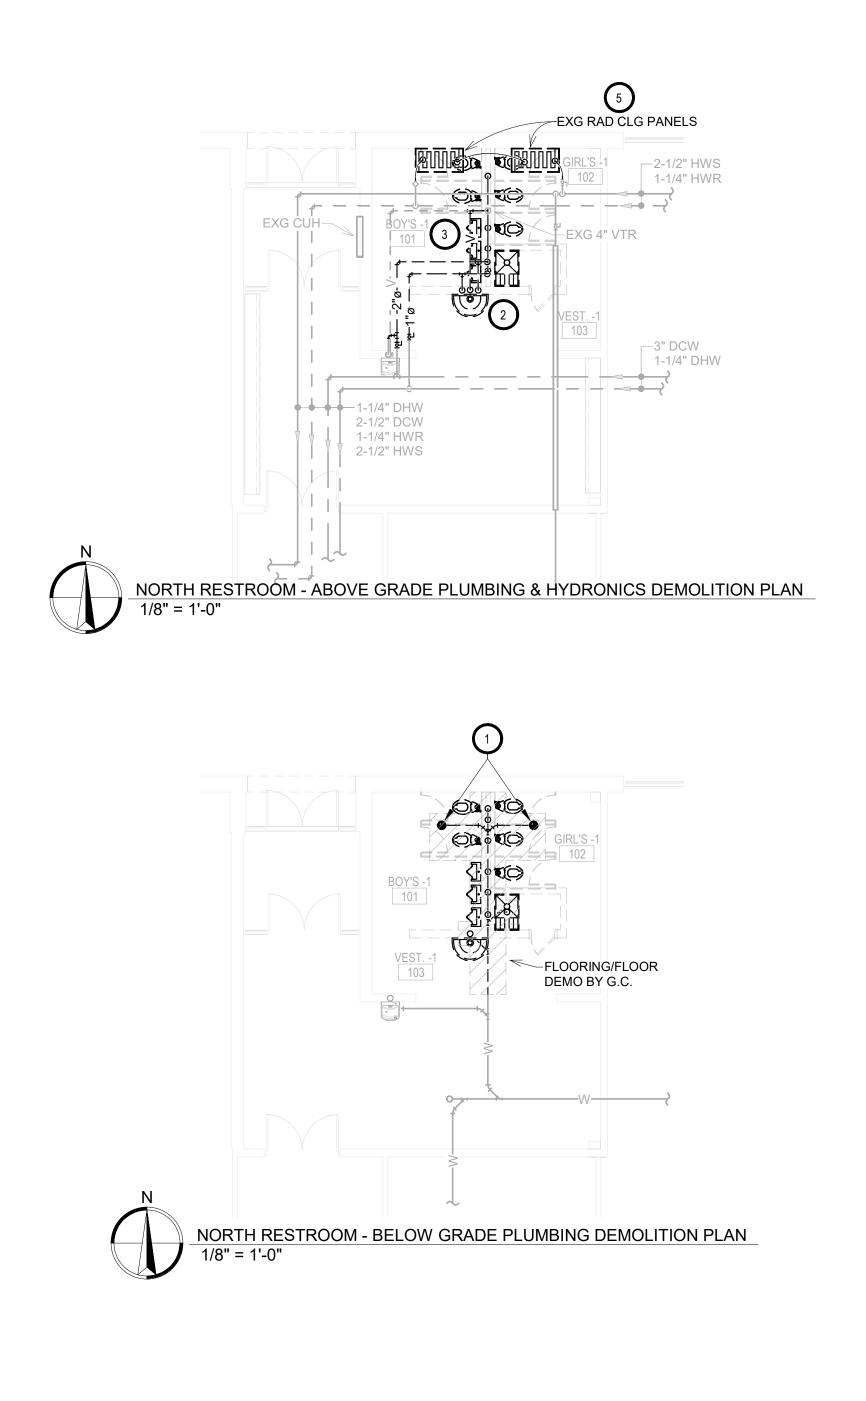


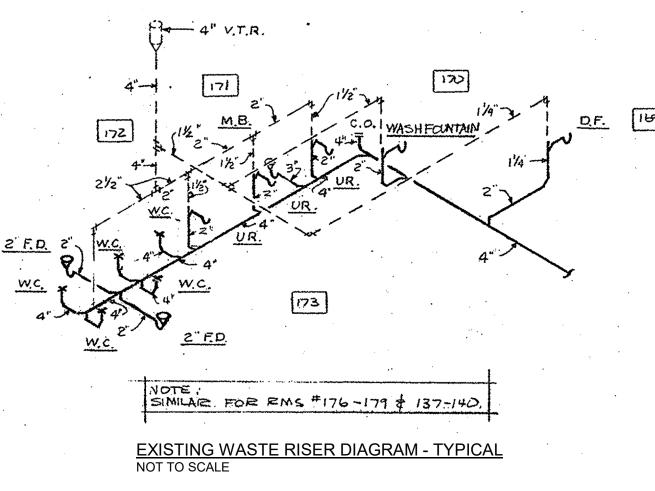

NOTE: EXISTING PLANS SHOWN ARE FOR REFERENCE ONLY SEE PLAN VIEW FOR DEMOLITION WORK.

● ● ● 1" DHW 2-1/2" DCW 2" HWR 2" HWS <u>GIRL'S - 2</u> 104 \mathbb{X} (3) 1/2" HWS —3/4" DHW E BOY'S 1" DCW 106 2" HWR 1-1/2" HWS – 1"ø — _ _ _ யிட்டு —___2 1/2"ø -O H _ _ _ _ _ _ EXG CUH-3 EXG CUH -EXG RAD CLG PANELS (5)HRESTROOM GROUP - ABOVE GRADE PLUMBING & HYDRONICS DEMOLITION PLAN SOUTH 1/8" = 1'-0"

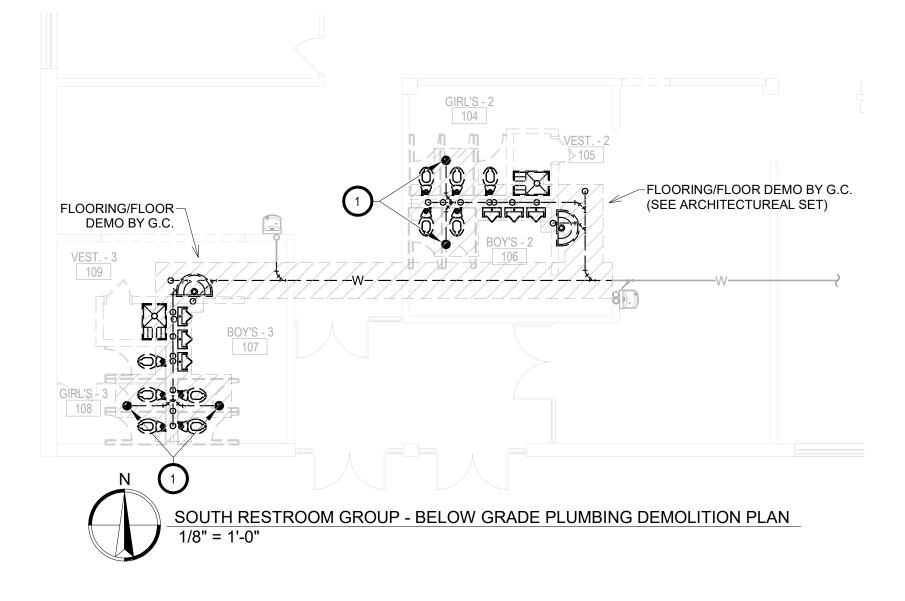

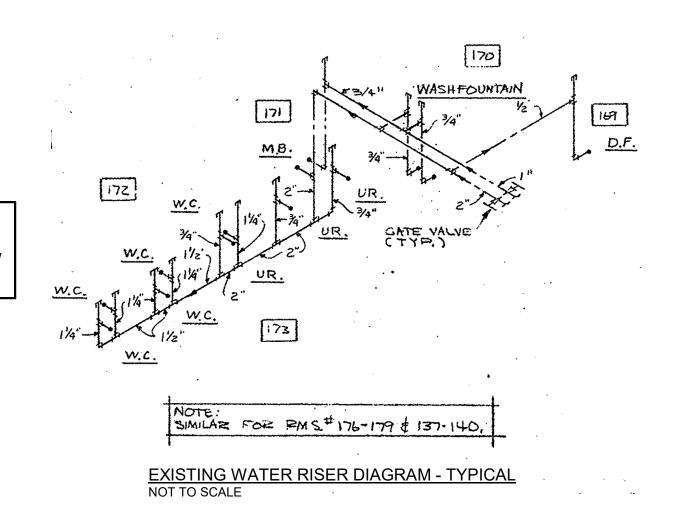

MECHANICAL GENERAL NOTES:

- NECESSARY DEMOLITION. COMPLETION OF THE NEW WORK. CONDITION, WHICH EXISTED PRIOR TO THE INTERRUPTION.
- JURISDICTION.



- ACCOMODATE REMODEL. SEE PROPOSED.
- FIXTURES. SEE PROPOSED.

- BE REINSTALLED. SEE PROPOSED.

SPECIAL NOTES

- DEMOLITION BY OTHERS.
- EXISTING CONDITIONS.

A. CONTRACTOR SHALL VISIT THE SITE AND VERIFY ALL EXISTING CONDITIONS AND DIMENSIONS. NOTIFY THE ENGINEER IMMEDIATELY OF ANY DISCREPANCIES, INCLUDING ANY

B. REMOVE MECHANICAL EQUIPMENT IN THE AREAS SHOWN ON THE PLAN, DISCONNECT SERVICES AND REMOVE TO A POINT OUT OF THE WAY OF THE GENERAL DEMOLITION. MARK ON THE PLAN TO CLEARLY SHOW WHERE THESE SERVICES ARE STOPPED. DEMOLITION WORK SHALL BE COORDINATED WITH THE OWNER. SHOULD QUESTIONS ARISE REGARDING THE REMOVAL OF EQUIPMENT, CONFER WITH THE OWNER BEFORE SUCH EQUIPMENT IS DEMOLISHED. MATERIALS REMOVED BY DEMOLITION SHALL REMAIN THE PROPERTY OF THE OWNER UNLESS OTHERWISE SPECIFICALLY NOTED. MATERIAL THE OWNER DOES NOT WISH TO RETAIN SHALL BE REMOVED AND DISPOSED OF PROPERLY BY THE CONTRACTOR. C. EQUIPMENT SHOWN ON DRAWINGS AS EXISTING IS BASED ON EXISTING PLANS AND LIMITED FIELD INVESTIGATION. THE FIELD SURVEY WAS CONDUCTED TO VERIFY, AS MUCH AS POSSIBLE, THE ACCURACY OF THE LOCATIONS SHOWN. THE CONTRACTOR SHALL VERIFY THE ACCURACY OF THE "EXISTING CONDITIONS" AS SHOWN ON THE DRAWINGS AS THE DEMOLITION WORK PROGRESSES. PERFORM MODIFICATIONS AND ADDITIONS AS NECESSARY TO CORRECT FOR THESE HIDDEN CONDITIONS AND ALLOW FOR THE

D. THE EXISTING BUILDING WILL BE IN USE DURING THIS CONSTRUCTION. SCHEDULE AND CARRY OUT THE WORK IN SUCH A MANNER AS TO CAUSE THE OWNER A MINIMUM OF INCONVENIENCE DUE TO SERVICE INTERRUPTIONS. TEMPORARY SERVICES SHALL BE INSTALLED IF ONE PHASE OF CONSTRUCTION DISRUPTS SERVICE TO ANOTHER AREA OF THE BUILDING OR IF EQUIPMENT HAS TO BE RELOCATED TO ALLOW CONSTRUCTION TO PROGRESS. SERVICE INTERRUPTIONS SHALL BE CONFINED TO THE SMALLEST AREA POSSIBLE AT ANY ONE TIME AND INTERRUPTIONS SHALL BE SCHEDULED WITH THE OWNER'S

SITE REPRESENTATIVE. AFTER SERVICE HAS BEEN RESTORED FOLLOWING AN INTERRUPTION, INSPECT AREAS AFFECTED BY THE INTERRUPTION AND BE RESPONSIBLE FOR RETURNING AUTOMATICALLY CONTROLLED EQUIPMENT TO THE SAME OPERATING

PROVIDE PENETRATIONS TO THE BUILDING STRUCTURE AS REQUIRED FOR INSTALLATION. WHERE EXISTING OR TEMPORARY SYSTEMS ARE BEING DEMOLISHED, WHICH LEAVE OPENINGS IN THE EXISTING BUILDING STRUCTURE, THE BUILDING STRUCTURE SHALL BE PATCHED TO MATCH THE EXISTING CONSTRUCTION AND MAINTAIN THE EXISTING BUILDING FIRE RATINGS. ALL PENETRATIONS THROUGH DRAFT STOPS AND OTHER FIRE-RATED PARTITIONS SHALL BE FIRE STOPPED AS PER SPECIFICATIONS AND LOCAL CODES. ALL MECHANICAL WORK SHALL BE INSTALLED IN STRICT ACCORDANCE WITH ALL APPLICABLE LOCAL, STATE, NATIONAL PLUMBING REGULATIONS, AND THE AUTHORITY HAVING

G. THE MECHANICAL CONTRACTOR IS RESPONSIBLE FOR THE TESTING & CLEANING OF EACH RESPECTIVE SYSTEM IN ACCORDANCE WITH APPLICABLE STATE & LOCAL CODES. TESTS SHALL BE PERFORMED IN THE PRESENCE OF THE AUTHORITY HAVING JURISDICTION. WRITTEN NOTIFICATION OF TEST, DATE, AND RESULTS SHALL BE FURNISHED TO THE ENGINEER BEFORE CONCEALING OR COVERING THE INSTALLATION. TESTS SHALL BE REPEATED UNTIL EACH SYSTEM IS PROVEN ACCEPTABLE.

1. TYPICAL - PC TO REMOVE & REPLACE EXISTING FLOOR DRAINS & CLEANOUTS TO

2. TYPICAL - PC TO DISCONNECT & REMOVE EXISTING PLUMBING FIXTURES & ASSOCIATED CARRIERS. REMOVE EXISTING DOMESTIC WATER PIPING, VENTING, & SANITARY SERVING

3. CHASE WALL ON BOYS RESTROOM SIDE OF CHASE TO BE DEMOLISHED & REPLACED TO ALLOW ACCESS TO CHASE. COORDINATED WITH OTHER TRADES.

4. PC TO DISCONNECT & REMOVE EXISTING PLUMBING FIXTURES. REMOVE EXISTING DOMESTIC WATER PIPING & VENTING AS NECESSARY & PROVIDE & INSTALL VALVE & CAP NEAR MAINS. REMOVE EXISTING SANITARY BELOW FLOOR SHOWN DARK & DASHED. PROVIDE & INSTALL TEMPORARY INSULATED WATERTIGHT CAP ON EXISTING VENT THRU ROOF.

5. PC TO DISCONNECT & REMOVE EXISTING CEILING RADIANT HEAT. EXISTING RADIANT HEAT TO

A. ALL MECHANICAL SYSTEMS, EXCLUDING DROPS, TO BE INSTALLED AS HIGH AS POSSIBLE TO PROVIDE MAXIMUM CLEARANCES FOR OWNER.


B. ALL FLOOR CLEANOUTS TO BE LOCATED IN INCONSPICUOUS LOCATIONS. CLEANOUTS LOCATED IN DOORWAYS AND MIDDLE OF HALLWAYS WILL NOT BE ACCEPTABLE.


C. IN AREAS WHERE CEILINGS ARE TO REMAIN, EACH TRADE SHALL BE RESPONSIBLE FOR ANY DAMAGE OR REPAIR NEEDED TO EXISTING CEILINGS AS A RESULT OF THEIR WORK.

D. EACH TRADE TO BE RESPONSIBLE FOR CUTTING AND PATCHING AS NECESSARY TO ALLOW FOR COMPLETION OF THEIR WORK. REFER TO ARCHITECTURAL PLANS FOR SELECTIVE

E. ORIGINAL PLANS ARE SHOWN (CLIPS FROM ORIGINAL PDF'S), CONTRACTOR TO VERIFY

F. REMOVE EXISTING ACT CEILING AS NECESSARY FOR PROPOSED WORK AND REINSTALL. G. SEE ARCHITECTURAL SET OF PLANS FOR FLOOR CUTTING BY G.C.

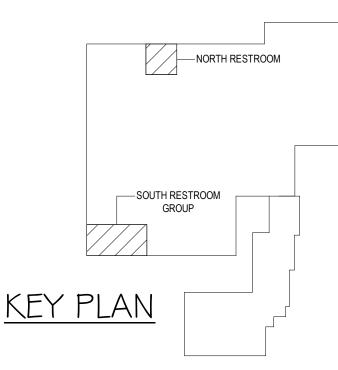

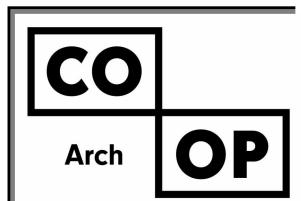

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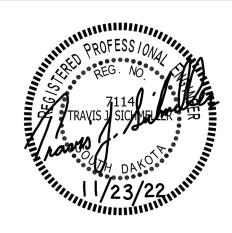
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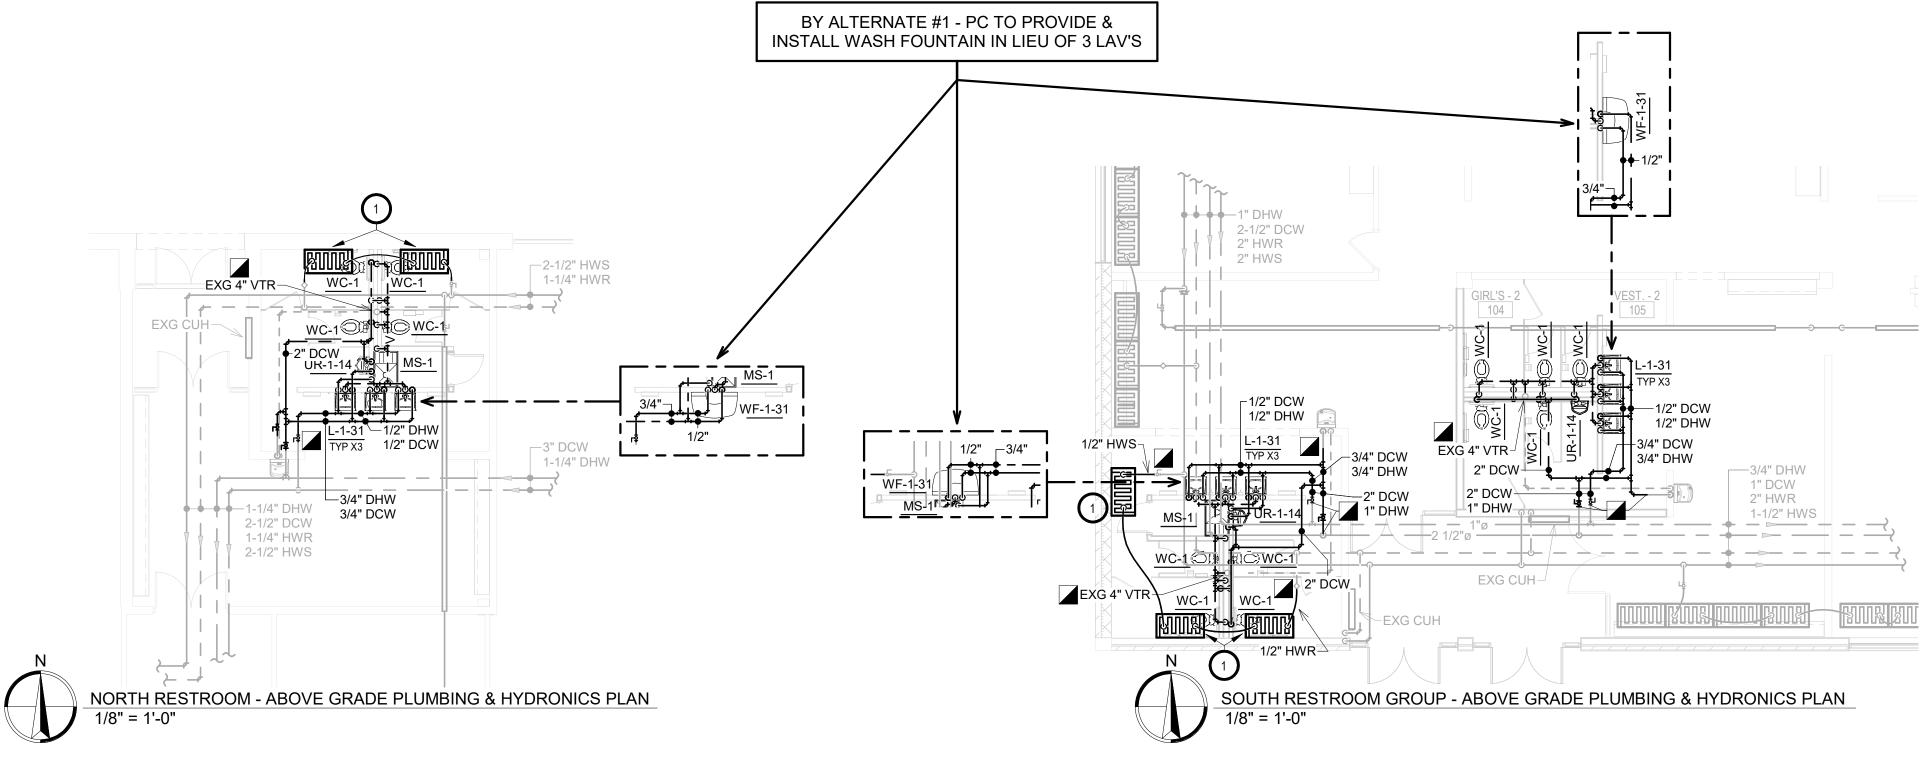
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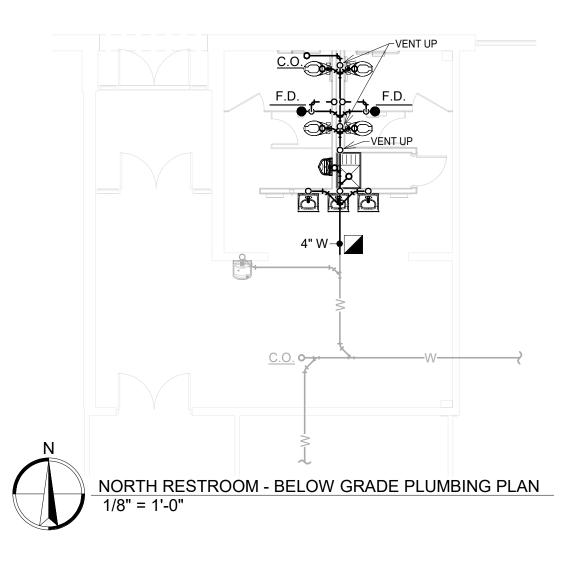
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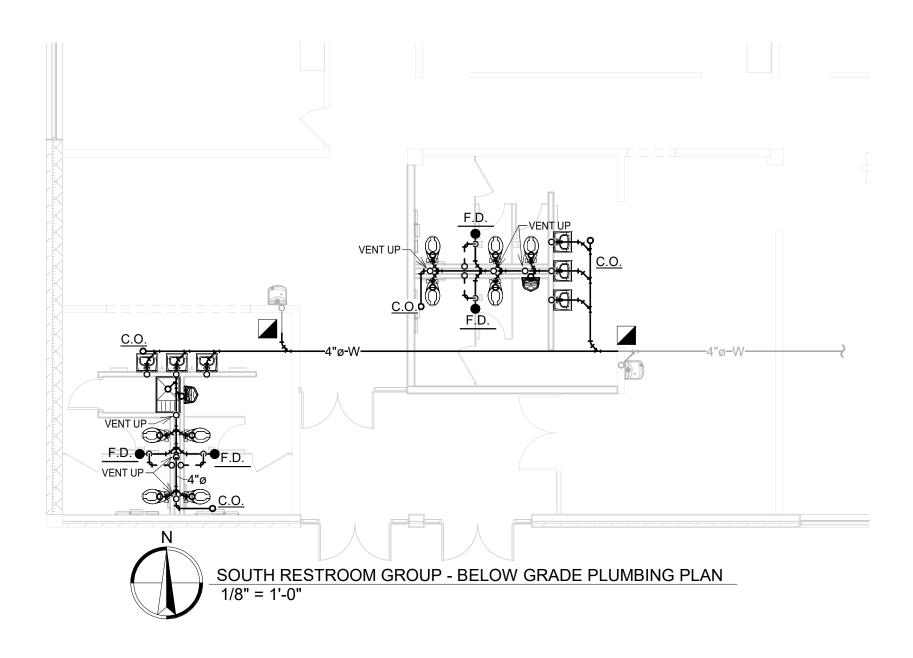
PROJECT: LINCOLN ELEMENTARY RESTROOM RENOVATIONS ABERDEEN SCHOOL DISTRICT ABERDEEN, SOUTH DAKOTA

SHEET TITLE: PLUMBING & HYDRONICS DEMOLITION PLAN

M200







GENERAL NOTES:

A. ALL WORK SHALL BE PERFORMED IN A CLEAN AND WORKMANLIKE MANNER.

B. THE MECHANICAL CONTRACTOR SHALL BE RESPONSIBLE FOR PATCHING ANY OPENINGS LEFT IN FLOORS, WALLS, AND CEILINGS THAT WERE CAUSED BY HIS/HER ACTIONS. PATCHING SHALL MATCH EXISTING SURFACE IN COLOR, TEXTURE AND QUALITY SO THAT PATCH IS INDISTINGUISHABLE FROM ORIGINAL SURFACE.

C. ALL PENETRATIONS THROUGH DRAFT STOPS AND OTHER FIRE-RATED PARTITIONS SHALL BE FIRE STOPPED AS PER SPECIFICATIONS AND LOCAL CODES.

D. ALL MECHANICAL WORK SHALL BE INSTALLED IN STRICT ACCORDANCE WITH ALL APPLICABLE LOCAL, STATE, NATIONAL PLUMBING REGULATIONS, AND THE AUTHORITY HAVING JURISDICTION.

E. THE MECHANICAL DRAWINGS SHOW GENERAL ARRANGEMENT ONLY. EXACT LOCATION SHALL AVOID INTERFERENCE WITH ELECTRICAL EQUIPMENT & REQUIRED ELECTRICAL CLEARANCES.

F. CONTRACTOR SHALL COORDINATE ALL PLUMBING WITH LIGHT FIXTURES, HVAC, FIRE SPRINKLER, AND STRUCTURAL TO ACCOMMODATE LIMITED CEILING SPACE.

G. FRESH AIR INTAKES TO BE MINIMUM 10' FROM ANY EXHAUST TERMINATION.

H. ALL FLOOR EQUIPMENT SHALL BE SET ON 4" HIGH CONCRETE BASES FURNISHED BY THIS CONTRACTOR.

I. CONTRACTOR SHALL VISIT THE SITE AND VERIFY ALL EXISTING CONDITIONS AND DIMENSIONS. NOTIFY THE A/E IMMEDIATELY OF ANY DISCREPANCIES.

J. COORDINATE NEW SERVICES WITH LOCAL UTILITIES.

1. PC TO REINSTALL EXISTING RADIANT HEAT CEILING

K. PLUMBING CONTRACTOR TO PROVIDE VENTING FOR ALL FLOOR DRAINS, TRENCH DRAINS, AND FLOOR SINKS AS SHOWN OR AS REQUIRED BY CODE.

ОР Arch

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SICHMELLER ENGINEERING


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REVISION SCHEDULE: REV. # REV. DSC. REV. DATE

PROJECT: LINCOLN ELEMENTARY RESTROOM RENOVATIONS ABERDEEN SCHOOL DISTRICT ABERDEEN, SOUTH DAKOTA

SHEET TITLE: **PROPOSED PLUMBING &** HYDRONICS PLAN

M300


SPECIAL NOTES

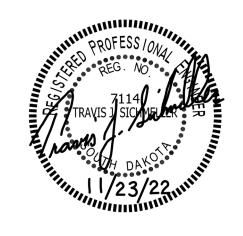O KEYNOTES

PANELS.

- A. ALL MECHANICAL SYSTEMS, EXCLUDING DROPS, TO BE INSTALLED AS HIGH AS POSSIBLE TO PROVIDE MAXIMUM CLEARANCES FOR OWNER.
- B. FLOOR DRAINS & SINK LOCATIONS SHALL BE INSTALLED IN LOCATIONS PROPER TO ACCEPT INDIRECT DRAIN PIPING FROM BOILERS, WATER HEATER, RELIEFS, ETC. (TRIP HAZARDS FROM PIPING WILL NOT BE ACCEPTABLE).
- C. ALL FLOOR CLEANOUTS TO BE LOCATED IN INCONSPICUOUS LOCATIONS. CLEANOUTS LOCATED IN DOORWAYS AND MIDDLE OF HALLWAYS WILL NOT BE ACCEPTABLE.

NORTH RESTROOM SOUTH RESTROOM GROUP KEY PLAN

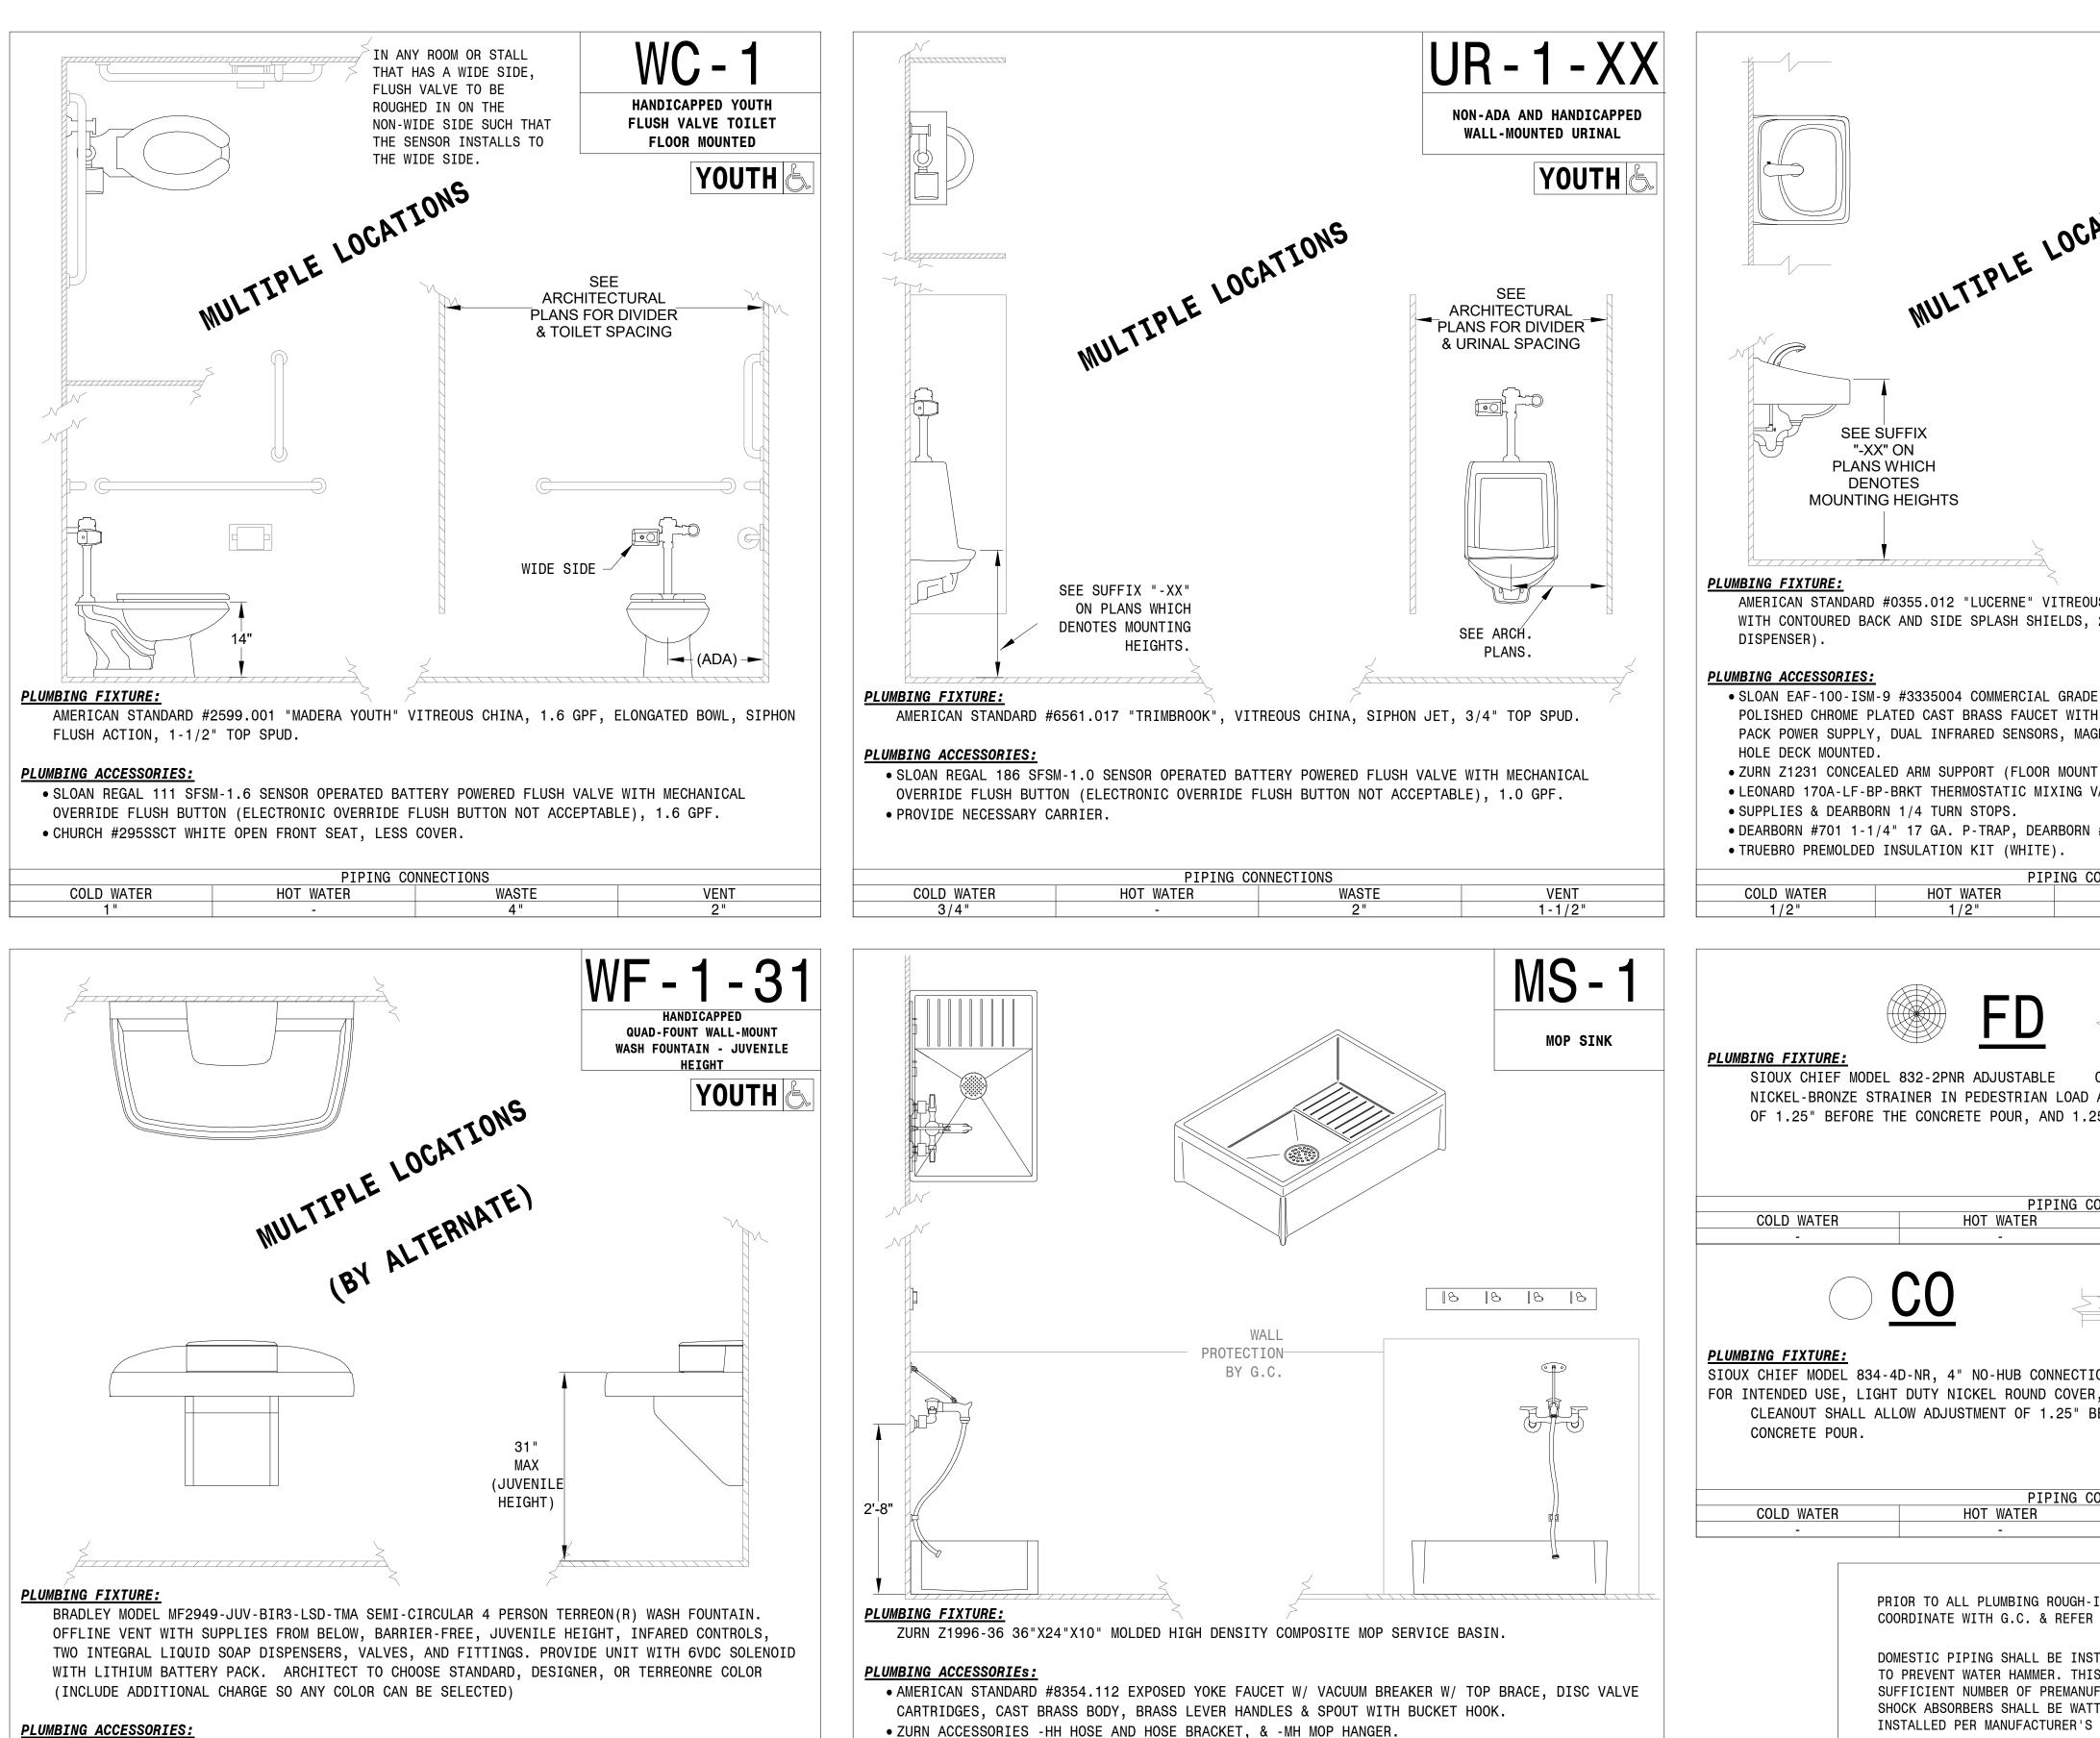



PLUMBING ACCESSORIES:


 ANCHORS & BOLTS • PROVIDE & INSTALL IN WALL CARRIER


PIPING CONNECTIONS					PIP	ING CONNECTIONS	
COLD WATER HOT WATE		VENT		COLD WATER	HOT WATER	WASTE	VENT
1/2 1/2	2"	1-1/2		3/4"	3/4"	3 "	1-1/2"

	- 1 - XX NON-ADA AND HANDICAPPED LLHUNG LAVATORY	Arch OP
JCATIONS	YOUTH	1108 S. Main St. 102 Aberdeen, SD 57401 Phone: 605-725-4852
	DVE DECK TEMP USTMENT VALVE	601 Kansas City St. 7 Rapid City, SD 57701 Phone: 605-716-3652 440 E. 8th St 221 Sioux Falls, SD 57103 Phone: 605-334-9999 co-oparch.com
REOUS CHINA, FRONT OVERFLOW, SELF-DR DS, 2 FAUCET HOLES (1 CENTERED, 1 OF RADE, ADA COMPLIANT, ELECTRONIC, SEN NITH & ABOVE-DECK SIDE MIXER, WITH MAGNETIC SOLENOID VALVE, 1.5 GPM AE DUNT CARRIER). NG VALVE WITH COLD WATER BY-PASS & MO DRN #760 OFFSET GRID STRAINER.	AINING DECK AREA FSET FOR SOAP SOR-ACTIVATED, LITHIUM BATTERY RATOR, SINGLE	<section-header><text><text><text><text></text></text></text></text></section-header>
	VENT - 1/2"	
ON-GRADE FLOOR DRAIN. LIGHT DU DAD AREAS ONLY. FLOOR DRAIN SHALL / 1.25" AFTER THE CONCRETE POUR.		SE PROJECT NO: 221000774
G CONNECTIONS WASTE 2" CTION. OVER, IN PEDESTRIAN LOAD AREAS ONLY. 5" BEFORE THE CONCRETE POUR, AND 1.2		ISSUE: 11-23-22 CONSTRUCTION DOCUMENTS REVISION SCHEDULE: REV. # REV. DSC. REV. DATE
G CONNECTIONS WASTE SEE PLAN GH-INS FOR ALL PLUMBING FIXTURES	VENT	PROJECT: LINCOLN ELEMENTARY RESTROOM RENOVATIONS ABERDEEN SCHOOL DISTRICT ABERDEEN, SOUTH DAKOTA
FER TO ARCHITECTURAL ELEVATIONS. INSTALLED WITH PROPER SAFEGUARDS THIS WILL BE DONE BY INSTALLING A WANUFACTURED SHOCK ABSORBERS. WATTS OR EQUAL. EXACT MODEL TO BE R'S INSTALLATION INSTRUCTIONS.		SHEET TITLE: PLUMBING FIXTURE SCHEDULE
		M400

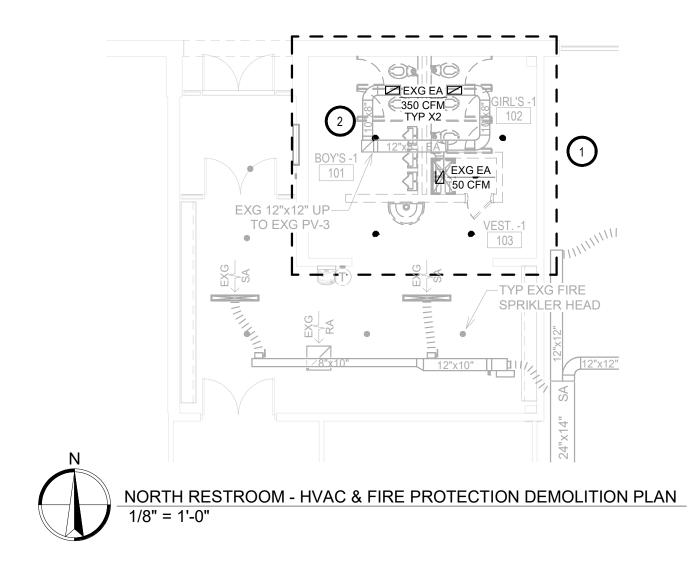

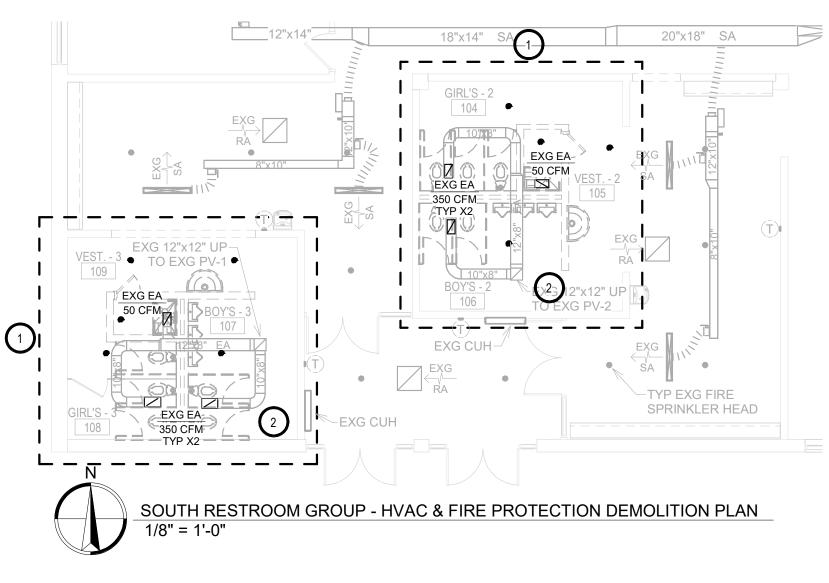


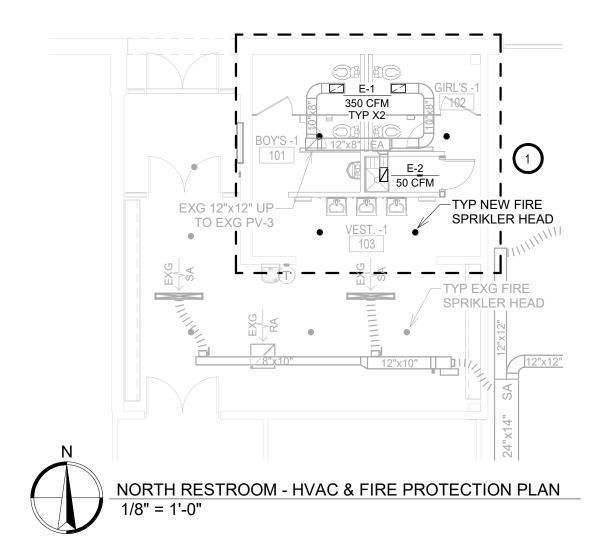


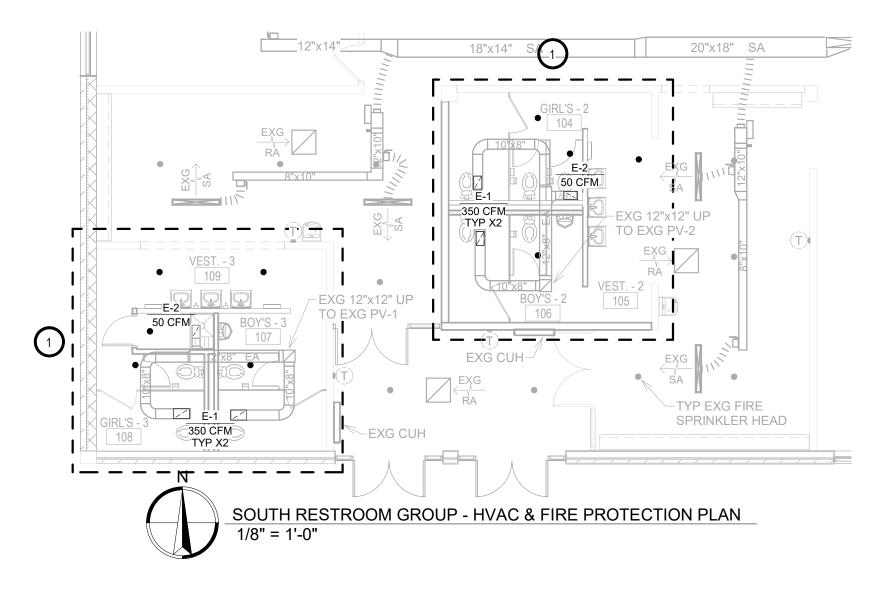



GRILLE - REGISTER - DIFFUSER SCHEDULE											
UIP. NO.	MANUFACTURER & MODEL	NOMINAL SIZE	THROAT SIZE	MAX CFM	MAX APD	THROW	MAX NC	FRAME	FINISH	MATERIAL	NOTES
E-1	PRICE 630	16x8	14x8	350	0.09"	-	19	SURFACE MOUNT	WHITE	ALUMINUM	1,2,3
E-2	PRICE 630	10x6	8x6	50	0.01"	-	10	SURFACE MOUNT	WHITE	ALUMINUM	1,2,3
NOTES:	 M.C. SHALL COORDINATE PROVIDE WITH OPPOSED 45° DEFLECTION BLADES 	BLADE BALANCING I		ON PRIOR TO FU	RNISHING MATERIA	L. M.C. SHALL	ALSO COORDINA	TE EXACT LOCATION	OF EQUIPMENT.		

	CO Arch OP
	1108 S. Main St. 102 Aberdeen, SD 57401 Phone: 605-725-4852 601 Kansas City St. 7 Rapid City, SD 57701 Phone: 605-716-3652 440 E. 8th St 221 Sioux Falls, SD 57103 Phone: 605-334-9999
	SICHMELLER ENGINEERING
O KEYNOTES	Mechanical & Electrical Engineering 801 Railroad Ave. SE Aberdeen, SD 57401 Phone: 605-225-4344 www.siceng.biz
 AREA WITHIN DASHED BOLD OUTLINE - SPRINKLER CONTRACTOR TO PROVIDE & INSTALL NEW FIRE SPRINKLER HEAD & ASSOCIATED SPRINKLER PIPING AS NECESSARY. SPRINKLER CONTRACTOR TO CENTER WITHIN NEW 2X2 ACT. PROPOSED CEILING TO BE INSTALLED AT THE SAME HEIGHT AS EXISTING. SEE SPRINKLER HEAD DETAIL. VC TO REMOVE EXISTING REGISTERS TO ACCOMODATE 	
REMODEL. SEE PROPOSED (THIS SHEET).	SE PROJECT NO: 221000774
	ISSUE: 11-23-22 CONSTRUCTION DOCUMENTS REVISION SCHEDULE: REV. # REV. DSC. REV. DATE
NORTH RESTROOM	PROJECT: LINCOLN ELEMENTARY RESTROOM RENOVATIONS ABERDEEN SCHOOL DISTRICT ABERDEEN, SOUTH DAKOTA
KEY PLAN	SHEET TITLE: HVAC & FIRE PROTECTION PLAN
	M500

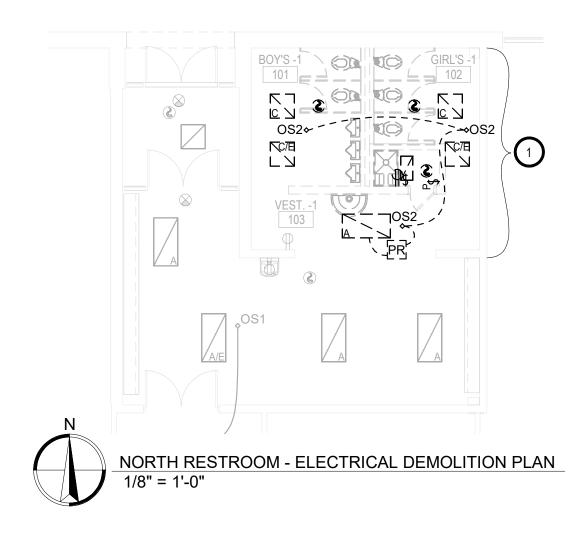

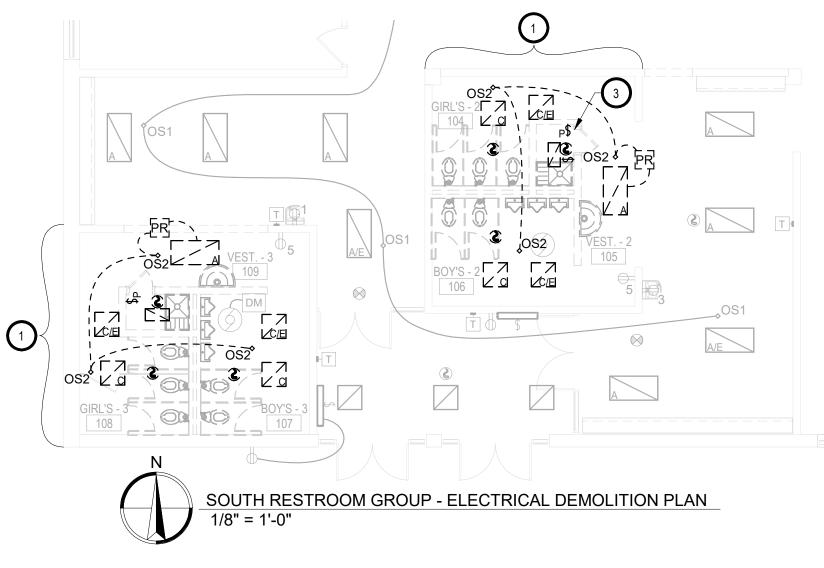

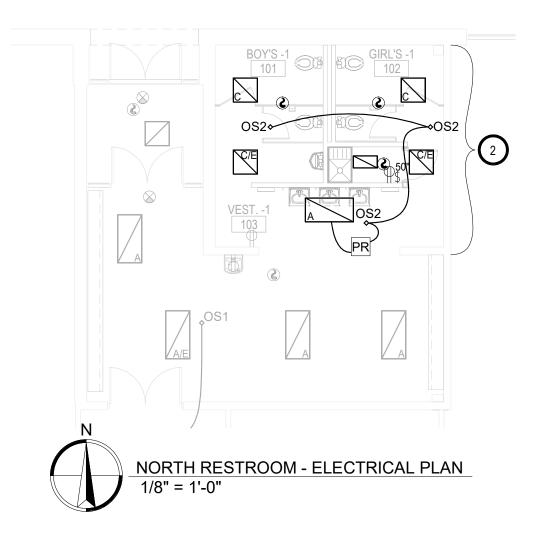

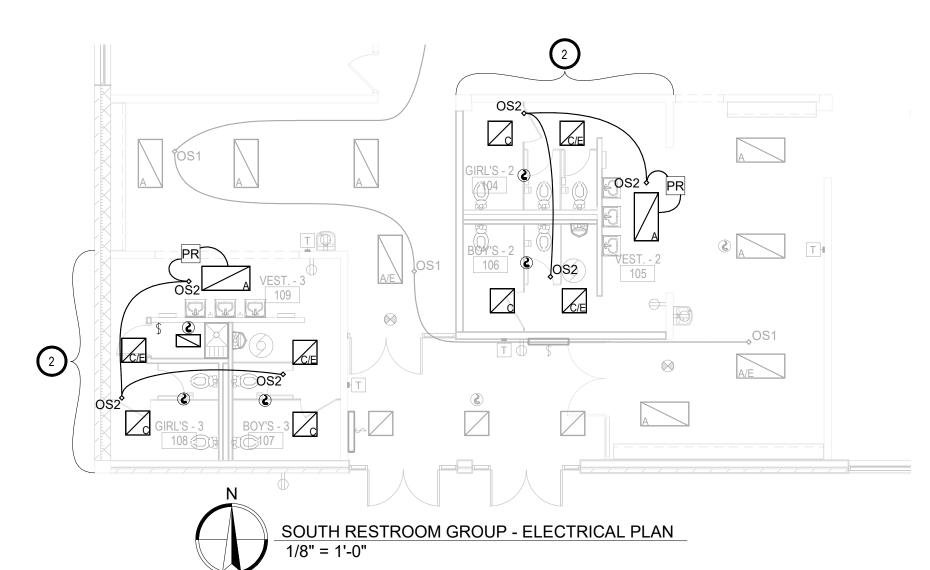

ELECTRICAL GENERAL NOTES:

A. CONTRACTOR SHALL VISIT THE SITE AND VERIFY ALL EXISTING CONDITIONS AND DIMENSIONS. NOTIFY THE ENGINEER IMMEDIATELY OF ANY DISCREPANCIES, INCLUDING ANY NECESSARY DEMOLITION. B. REMOVE EQUIPMENT IN THE AREAS SHOWN ON THE PLAN, DISCONNECT SERVICES AND REMOVE TO A POINT OUT OF THE WAY OF THE GENERAL DEMOLITION. MARK ON THE PLAN TO CLEARLY SHOW WHERE THESE SERVICES ARE STOPPED. DEMOLITION WORK SHALL BE COORDINATED WITH THE OWNER. SHOULD QUESTIONS ARISE REGARDING THE REMOVAL OF EQUIPMENT, CONFER WITH THE OWNER BEFORE SUCH EQUIPMENT IS DEMOLISHED. MATERIALS REMOVED BY DEMOLITION SHALL REMAIN THE PROPERTY OF THE OWNER UNLESS OTHERWISE SPECIFICALLY NOTED. MATERIAL THE OWNER DOES NOT WISH TO RETAIN SHALL BE REMOVED AND DISPOSED OF PROPERLY BY THE CONTRACTOR. C. EQUIPMENT SHOWN ON DRAWINGS AS EXISTING IS BASED ON EXISTING PLANS AND LIMITED FIELD INVESTIGATION. THE FIELD SURVEY WAS CONDUCTED TO VERIFY, AS MUCH AS POSSIBLE, THE ACCURACY OF THE LOCATIONS SHOWN. THE CONTRACTOR SHALL VERIFY THE ACCURACY OF THE "EXISTING CONDITIONS" AS SHOWN ON THE DRAWINGS AS THE DEMOLITION WORK PROGRESSES. PERFORM MODIFICATIONS AND ADDITIONS AS NECESSARY TO CORRECT FOR THESE HIDDEN CONDITIONS AND ALLOW FOR THE COMPLETION OF THE NEW WORK. D. THE EXISTING BUILDING WILL BE IN USE DURING THIS CONSTRUCTION. SCHEDULE AND CARRY OUT THE WORK IN SUCH A MANNER AS TO CAUSE THE OWNER A MINIMUM OF INCONVENIENCE DUE TO SERVICE INTERRUPTIONS. TEMPORARY SERVICES SHALL BE INSTALLED IF ONE PHASE OF CONSTRUCTION DISRUPTS SERVICE TO ANOTHER AREA OF THE BUILDING OR IF EQUIPMENT HAS TO BE RELOCATED TO ALLOW CONSTRUCTION TO PROGRESS. SERVICE INTERRUPTIONS SHALL BE CONFINED TO THE SMALLEST AREA POSSIBLE AT ANY ONE TIME AND INTERRUPTIONS SHALL BE SCHEDULED WITH THE OWNER'S SITE REPRESENTATIVE. AFTER SERVICE HAS BEEN RESTORED FOLLOWING AN INTERRUPTION, INSPECT AREAS AFFECTED BY THE INTERRUPTION AND BE RESPONSIBLE FOR RETURNING AUTOMATICALLY CONTROLLED EQUIPMENT TO THE SAME OPERATING CONDITION, WHICH EXISTED PRIOR TO THE INTERRUPTION. E. PROVIDE PENETRATIONS TO THE BUILDING STRUCTURE AS REQUIRED FOR INSTALLATION. WHERE EXISTING OR TEMPORARY SYSTEMS ARE BEING DEMOLISHED, WHICH LEAVE OPENINGS IN THE EXISTING BUILDING STRUCTURE, THE BUILDING STRUCTURE

SHALL BE PATCHED TO MATCH THE EXISTING CONSTRUCTION AND MAINTAIN THE EXISTING BUILDING FIRE RATINGS. ALL PENETRATIONS THROUGH DRAFT STOPS AND OTHER FIRE-RATED PARTITIONS SHALL BE FIRE STOPPED AS PER SPECIFICATIONS AND LOCAL CODES.


F. ALL WORK SHALL BE INSTALLED IN STRICT ACCORDANCE WITH ALL APPLICABLE LOCAL, STATE, NATIONAL PLUMBING REGULATIONS, AND THE AUTHORITY HAVING JURISDICTION. G. THE CONTRACTOR IS RESPONSIBLE FOR THE TESTING & CLEANING OF EACH RESPECTIVE SYSTEM IN ACCORDANCE WITH APPLICABLE STATE & LOCAL CODES. TESTS SHALL BE


PERFORMED IN THE PRESENCE OF THE AUTHORITY HAVING JURISDICTION. WRITTEN NOTIFICATION OF TEST, DATE, AND RESULTS SHALL BE FURNISHED TO THE ENGINEER BEFORE CONCEALING OR COVERING THE INSTALLATION. TESTS SHALL BE REPEATED UNTIL EACH SYSTEM IS PROVEN ACCEPTABLE.

1. WHERE CEILINGS ARE TO BE REMOVED & REPLACED BY THE GENERAL CONTRACTOR, ELECTRICAL CONTRACTOR TO DISCONNECT AS NEEDED/TEMPORARILY SUSPEND ALL ELECTRICAL SYSTEM DEVICES. PROVIDE PROTECTION FROM CONSTRUCTION/DUST AS NECESSARY, SPECIAL CARE SHOULD BE TAKEN WITH EXISTING LIGHT FIXTURES. FIXTURES WERE PART OF A RECENT LIGHTING UPGRADE. ALL DAMAGES ARE RESPONCIBILITY OF ELECTRICAL CONTRACTOR.

2. ELECTRICAL CONTRACTOR TO REINSTALL ALL ELECTRICAL SYSTEMS TO ACCOMODATE NEW ACT CEILINGS.

3. JANITOR'S CLOSET: PROVIDE REMOVAL OF LIGHT FIXTURE, SWITCH AND FIRE ALARM SMOKE DETECTOR. TURN DEVICES OVER TO OWNER.

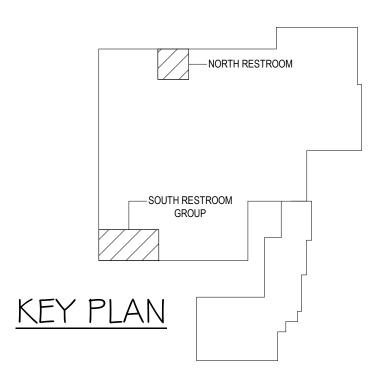

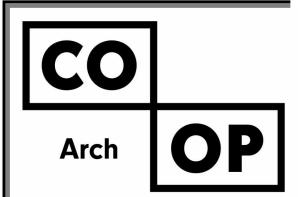

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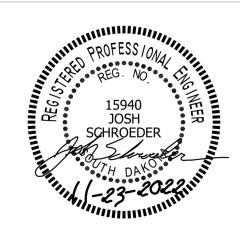
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SE PROJECT NO:

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ISSUE:

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PROJECT: LINCOLN ELEMENTARY RESTROOM RENOVATIONS ABERDEEN SCHOOL DISTRICT ABERDEEN, SOUTH DAKOTA

SHEET TITLE: ELECTRICAL PLAN

E200